DOUGLASVILLE-DOUGLAS COUNTY WATER AND SEWER AUTHORITY DOUGLAS COUNTY, GEORGIA STEWART MILL ROAD SANITARY SEWER REPLACEMENT PROJECT

100% SUBMITTAL

DDCWSA PROJECT NO. 22B4413-02



GENERAL

BRYANT K. ROGERS
REGISTRATION No. 31735

CIVIL

DAMD S. EHRHARDT
REGISTRATION No. 17321

ARCHITECTURAL

NOT APPLICABLE

FIRE PROTECTION

NOT APPLICABLE

STRUCTURAL

FREDERICK P. POWELL
REGISTRATION No. 31118

MECHANICAL

DAVID S. EHRHARDT
REGISTRATION No. 31118

NOT APPLICABLE

INSTRUMENTATION

NOT APPLICABLE

I, ALAN BOWLING (GSWCC LEVEL II CERTIFICATION NO. 432), HEREBY CERTIFY THAT I, OR MY AUTHORIZED AGENT HAVE VISITED THE SITE PRIOR TO CREATION OF THE EROSION, SEDIMENTATION AND POLLUTION CONTROL PLAN AND HAVE VERIFIED THE PRESENCE OR LACK THEREOF OF ALL STATE WATERS ON, OR ADJACENT TO, THE SITE.

ENGINEER, DDCWSA

ALAN BOWLING

RECOMMENDED FOR APPROVAL

DEPUTY DIRECTOR OF ENVIRONMENTAL SERVICES

6/26/201

DOUGLASVILLE-DOUGLAS COUNTY WATER AND SEWER AUTHORITY

GILBERT B. SHEAROUSE - EXECUTIVE DIRECTOR

BOARD OF DIRECTORS DAVID BOATRIGHT E. JOHN CITIZEN JEFF NOLES KERRY RIGDON SUBMITTED FOR APPROVAL RECOMMENDED FOR APPROVAL PROJECT ENGINEER ROCHELLE ROBINSON S. LAYNE SMITH TOM WORTHAN RECOMMENDED FOR APPROVAL

MAY 2019

Hazen

5775 Peachtree Dunwoody Road, Suite D-520
Atlanta, GA 30342
(404) 459-6363
PROJECT ENGINEER OF RECORD: DAVID S. EHRHARDT, P.E.



LOCATION MAP

- 1. EXISTING UTILITIES WERE LOCATED USING THE BEST AVAILABLE INFORMATION. IT SHALL BE THE CONTRACTOR'S RESPONSIBILITY TO FIELD-VERIFY EXISTING UTILITY LOCATIONS PRIOR TO CONSTRUCTION. ALL UNDERGROUND UTILITIES DISTURBED OR DAMAGED BY CONSTRUCTION ACTIVITIES SHALL BE RESTORED AND RETURNED TO ORIGINAL CONDITION AND UTILITY OWNER'S SPECIFICATIONS AT NO ADDITIONAL COST. CONTRACTOR SHALL NOT DISTURB THE CONTINUOUS AND PROPER OPERATION OF ALL EXISTING UTILITIES LOCATED ON OR ADJACENT TO THE PROJECT SITE AND WITHIN THE CONSTRUCTION LIMITS OF THIS
- 2. THE CONTRACTOR SHALL FAMILIARIZE HIMSELF WITH, AND SHALL AT ALL TIMES STRICTLY CONFORM TO, THE REGULATIONS OF THE "OSHA GENERAL INDUSTRY OCCUPATIONAL SAFETY AND HEALTH STANDARDS, AND OSHA SAFETY AND HEALTH REGULATIONS FOR CONSTRUCTION", AND OF APPLICABLE STATE AND LOCAL STANDARDS AND REGULATIONS.
- 3 THE CONTRACTOR SHALL FAMILIARIZE HIMSELF WITH, AND SHALL AT ALL TIMES STRICTLY CONFORM TO, ALL APPLICABLE REGULATIONS OF SUBPART "P" ENTITLED, "EXCAVATIONS, TRENCHING, AND SHORING" OF OSHA SAFETY AND HEALTH REGULATIONS FOR CONSTRUCTION "GENERAL CONSTRUCTION SAFETY ORDERS" AND THE OWNER'S SITE RULES AND REGULATIONS.
- 4. ALL DISTURBED AREAS SHALL BE GRASSED, SODDED, OR LANDSCAPED AS SPECIFIED UPON COMPLETION OF GRADING ACTIVITIES. ALL TEMPORARY SEEDING SHALL BE DONE IN ACCORDANCE WITH THE MANUAL FOR EROSION AND SEDIMENT CONTROL IN GEORGIA.
- 5. IN ACCORDANCE WITH STATE LAW, CONTRACTOR SHALL CALL THE UTILITIES PROTECTION CENTER OF GA AT 1-800-282-7411 AT LEAST THREE WORKING DAYS PRIOR TO CONSTRUCTION FOR LOCATION OF UNDERGROUND UTILITIES. PRIOR TO THE START OF CONSTRUCTION, CONTRACTOR SHALL POTHOLE AT HIS OWN RISK TO DETERMINE THE LOCATIONS OF UNDERGROUND UTILITIES AS NEEDED WITHIN THE PROJECT AREA. CONTRACTOR SHALL BE RESPONSIBLE FOR ALL COSTS ASSOCIATED WITH THESE ACTIVITIES.
- 6. ALL CONSTRUCTION SHALL BE IN ACCORDANCE WITH THE STANDARDS AND SPECIFICATIONS OF DOUGLAS COUNTY, THE LOCAL MUNICIPALITY, AND/OR THE STATE HIGHWAY DEPARTMENT, AND APPLICABLE OSHA REGULATIONS, AS APPLICABLE.
- 7. THE CONTRACTOR SHALL NOTIFY THE DOUGLASVILLE-DOUGLAS COUNTY WATER & SEWER AUTHORITY (770) 949-7617 AT LEAST 24 HOURS PRIOR TO BEGINNING CONSTRUCTION. THERE SHALL BE NO CHANGES IN DRAWINGS WITHOUT WRITTEN APPROVAL BY THE DOUGLASVILLE-DOUGLAS COUNTY WATER AND SEWER AUTHORITY.
- 8. CONTRACTOR'S ACTIVITIES SHALL BE LIMITED TO THOSE AREAS INDICATED ON DRAWINGS FOR ACCESS, STAGING, AND UTILITY CONSTRUCTION.
- 9. CONSTRUCTION SIGNS FOR WORK WITHIN AND ADJACENT TO PUBLIC ROADS, HIGHWAYS, AND ALLEYS SHALL BE IN ACCORDANCE WITH GDOT STANDARDS.
- THE ENGINEER SHALL NOT BE RESPONSIBLE FOR THE CONTRACTOR'S MEANS, METHODS, TECHNIQUES, SEQUENCES OR PROCEDURES OF CONSTRUCTION OR THE SAFETY PRECAUTIONS AND PROGRAMS INCIDENT THERETO, AND THE ENGINEER WILL NOT BE RESPONSIBLE FOR THE CONTRACTOR'S FAILURE TO PERFORM OR FURNISH THE WORK IN ACCORDANCE WITH THE CONTRACT DOCUMENTS. THE ENGINEER WILL NOT BE RESPONSIBLE FOR ACTS OR OMISSIONS OF THE CONTRACTOR OR OF ANY SUBCONTRACTOR, ANY SUPPLIER, ANY PERSON OR ORGANIZATION PERFORMING OR FURNISHING ANY OF THE WORK.
- 11. UTILITY LOCATIONS ARE FROM FIELD OBSERVATION AND/OR DOCUMENTATION FURNISHED BY THE OWNER AND/OR THE OWNER'S REPRESENTATIVES. NEITHER ACCURACY NOR COMPLETENESS OF THE UTILITIES ARE GUARANTEED BY TATE ENGINEERING & SURVEYING, INC. OR HAZEN AND SAWYER.
- 12. CONTRACTOR SHALL SUBMIT DETOUR PLAN FOR APPROVAL BY DDCWSA AND COORDINATE WITH 911 SERVICE
- 13. CONTRACTOR SHALL PROVIDE IN ACCORDANCE WITH THE M.U.T.C.D (LATEST EDITION), ALL SIGNS, BARRICADES, ET. FOR THE DURATION OF THE PROJECT.
- 14. ENVIRONMENTAL ISSUES: WETLANDS, BUFFERS & SO FORTH WILL BE ADDRESSED BY THE DDCWSA AND/OR THEIR CONSULTANTS.
- 15. ORIGINAL SERVEY INFORMATION PROVIDED BY TATE ENGINEERING & SURVEYING, INC.
- 16. FOR SUBSURFACE SOIL INFORMATION SEE SUBSURFACE EXPLORATION AND GEOTECHNICAL ENGINEERING EVALUATION FOR STEWART MILL OUTFALL SEWER - OCTOBER 17, 2017 BY GEOHYDRO ENGINEERS.
- 17. 24 HOUR CONTACT: HERMAN BRYANT 678-839-9605
- 18. PRIOR TO BEGINNING CONSTRUCTION, CONTRACTOR SHALL SURVEY THE EXISTING MH-1 TO MH-17 RIMS AND INVERTS. THE SURVEY SHALL BE PREFORMED BY A REGISTERED LAND SURVEYOR IN THE STATE OF GEORGIA. ELEVATIONS SHALL BE SUBMITTED IN TABULAR FORM TO THE ENGINEER.

PROJECT DATA:

PROJECT NAME:

STEWART MILL ROAD SANITARY SEWER REPLACEMENT PROJECT

D. EHRHARDT

2. PROJECT LOCATION:

3. PROJECT ADDRESS:

DOUGLAS COUNTY

STEWART MILL AND REYNOLDS ROADS, DOUGLASVILLE, GA 30135

4. PRESENT AND PROPOSED USE:

SANITARY SEWER

5. OWNER/DEVELOPER: DOUGLASVILLE-DOUGLAS COUNTY WATER AND SEWER AUTHORITY 8763 HOSPITAL DRIVE

HAZEN AND SAWYER, P.C.

6. ENGINEER:

5775 PEACHTREE DUNWOODY ROAD, SUITE D-520 ATLANTA, GEORGIA 30342 404-459-6363 - DAVID S. EHRHARDT, P.E

7. SURVEYOR:

TATE ENGINEERING & SURVEYING, INC. 6 MAYS STREET TALLAPOOSA, GA 30176 (P) 770-574-5100 (Q) (E) TESRTG@AOL.COM

DOUGLASVILLE, GEORGIA 30134

770 920-3819 - MIGUEL A. BACA, P.E.

TREE PRESERVATION/PROTECTION PLANTING NOTES:

- ALL LIMITS OF CONSTRUCTION AS INDICATED ON THE DRAWINGS SHALL BE CLEARLY IDENTIFIED BY TREE PROTECTION FENCE PRIOR TO COMMENCEMENT OF ANY LAND DISTURBANCE EXCEPT THOSE OPERATIONS NEEDED TO INSTALL EROSION CONTROL
- THE CONTRACTOR SHALL PROTECT ALL TREES AND VEGETATION ON THE SITE EXCEPT AS NOTED ON THE PLANS OR APPROVED BY DOUGLAS COUNTY ENGINEER OR INSPECTOR.
- ALL TREE PROTECTION MEASURES SHALL BE INSTALLED PRIOR TO CLEARING AND TRENCHING
- TREE PROTECTION FENCE SHALL BE INSTALLED ALONG THE OUTER EDGE OF AND COMPLETELY SURROUNDING THE CRITICAL ROOT ZONES OF ALL SPECIMEN TREES OR STANDS OF TREES, OR OTHERWISE DESIGNATED TREE PROTECTION ZONES PRIOR TO ANY LAND DISTURBANCE. SPECIMEN TREES AND TREE PROTECTION ZONES SHALL BE FLAGGED BY DOUGLAS COUNTY PRIOR TO NOTICE TO PROCEED.
- ALL TREE PROTECTION ZONES SHALL BE DESIGNATED WITH "TREE SAVE AREA" SIGNS.
- WHEN DIGGING NEAR TREES, THE CONTRACTOR SHALL PRUNE ALL EXPOSED ROOTS ONE (1) INCH IN DIAMETER AND LARGER ON THE SIDE OF THE TRENCH ADJACENT TO THE TREES. PRUNING SHALL CONSIST OF MAKING A CLEAN CUT FLUSH WITH THE SIDE OF THE TRENCH TO PROMOTE NEW ROOT GROWTH.
- PRUNING OF TREE LIMBS TO PROVIDE CLEARANCE FOR EQUIPMENT AND MATERIALS SHALL BE DONE ACCORDING TO STANDARD ARBORICULTURAL PRACTICE.
- ALL BUFFERS AND TREE SAVE AREAS ARE TO BE CLEARLY IDENTIFIED WITH TREE PROTECTIVE FENCING PRIOR TO COMMENCEMENT OF ANY LAND DISTURBANCE.
- THINNING IS ALLOWED AND MAY INCLUDE MANUAL REMOVAL OF NON-SPECIMEN TREES WITHIN THE CRITICAL ROOT ZONE OR DRIPLINE OF THE SPECIMEN TREE IN THE LANDSCAPE INSTALLATION PHASE OF DEVELOPMENT ONLY. THINNING INCLUDES MANUAL REMOVAL (NO MOTORIZED/WHEELED OR TRACK VEHICLES ALLOWED WITHIN THE CRITICAL ROOT ZONE OF 10. THE SPECIMEN TREE).
- 11. NON-VEGETATIVE MATERIAL TO BE REMOVED MANUALLY.

A COMMERCIAL APPLICATOR LICENSE AND A PESTICIDE CONTRACTOR LICENSE ARE REQUIRED BY THE CONTRACTOR IF THE USE OF HERBICIDES ARE NECESSARY FOR NOXIOUS PLANT MATERIAL REMOVAL.

EROSION, SEDIMENTATION AND POLLUTION CONTROL NOTES:

- 1. THESE EROSION AND SEDIMENT CONTROL MEASURES SHALL APPLY TO ALL FEATURES OF THE CONSTRUCTION SITE.
- 2. SILT BARRIERS TO BE PLACED AS SHOWN AND/OR AS DIRECTED BY THE PROJECT ENGINEER AND/OR THE COUNTY INSPECTOR.
- NO CLEARING, GRADING, TRENCHING, FILLING, OR OTHER LAND DISTURBING ACTIVITIES SHALL BE PERMITTED UNTIL APPROVED EROSION AND SEDIMENT CONTROL MEASURES HAVE BEEN INSTALLED, EXCEPT THOSE OPERATIONS NEEDED TO INSTALL SUCH MEASURES.
- 4. EROSION CONTROL MEASURES SHALL BE EMPLOYED DURING CONSTRUCTION TO MINIMIZE SITE GENERATED WATERBORNE SILT AND DEBRIS.
- 5. EROSION CONTROL MEASURES SHALL BE INSPECTED DAILY AND AFTER EACH RAIN AND REPAIRED BY GENERAL CONTRACTOR OR AN ASSIGNED SUBCONTRACTOR.
- 6. ALL EROSION AND SEDIMENT CONTROL MEASURES SHALL BE CONTINUOUSLY MAINTAINED BY THE CONTRACTOR DURING THE CONSTRUCTION PHASE OF THE PROJECT AND UNTIL PERMANENT STABILIZATION OF ALL DISTURBED AREAS ARE ACCOMPLISHED. TEMPORARY CONTROL MEASURES SHALL THEN BE REMOVED BY THE CONTRACTOR.
- 7. CONTRACTOR SHALL INSTALL, MAINTAIN, AND REMOVE ALL EROSION CONTROL AND SEDIMENT CONTROL MEASURES IN ACCORDANCE WITH THE CURRENT EDITION OF THE GEORGIA EROSION AND SEDIMENT CONTROL HANDBOOK.
- 8. CONTRACTOR SHALL KEEP STREETS AND SIDEWALKS FREE OF MUD AND DEBRIS.
- 9. FAILURE TO PROPERLY INSTALL AND MAINTAIN EROSION CONTROL MEASURES MAY RESULT IN CONSTRUCTION BEING HALTED TO PERMIT ALLOCATION OF RESOURCES REQUIRED TO CORRECT THE DEFICIENCIES. THIS MAY JEOPARDIZE THE CONTRACTOR MEETING THE PROJECT SCHEDULE WHICH COULD RESULT IN LIQUIDATED DAMAGES BEING ASSESSED. IT IS THE CONTRACTOR'S FULL RESPONSIBILITY TO USE AND MAINTAIN EROSION CONTROL MEASURES THAT ARE IN ACCORDANCE WITH THE GEORGIA EROSION AND SEDIMENT CONTROL REGULATIONS AND CORRECT DIFFERENCES IN A TIMELY MANNER.
- 10. CONTRACTOR SHALL BE EXPECTED TO INSTALL ADDITIONAL EROSION AND SEDIMENTATION CONTROL MEASURES AND PRACTICES IF DEEMED NECESSARY BY ON-SITE INSPECTION TO PREVENT OFF-SITE SEDIMENTATION.
- 11. CONTRACTOR SHALL PROVIDE TEMPORARY GRASSING ON DISTURBED AREAS THAT ARE NOT RESTORED AFTER TWO WEEKS. EXCLUDED FROM THIS ARE AREAS THE CONTRACTOR CONTINUALLY UTILIZES FOR ACCESS, STAGING, AND STORAGE.
- 12. DOUGLAS COUNTY LAND DISTURBANCE PERMIT MUST BE DISPLAYED ON SITE AT ALL TIMES DURING CONSTRUCTION AND IN PLAIN VIEW FROM THE ACCESS OR PLANT ROAD.
- 13. ON-SITE BURIAL/DISPOSAL OF CONSTRUCTION AND DEMOLITION (C&D) WASTE IS PROHIBITED BY GEORGIA LAW AND THE GWINNETT COUNTY SOLID WASTE DISPOSAL SERVICES ORDINANCE. CONSTRUCTION AND DEMOLITION WASTE (C&D) MEANS BUILDING MATERIALS FROM CONSTRUCTION AND DEMOLITION OPERATIONS WHICH INCLUDE, BUT ARE NOT LIMITED TO: ASBESTOS-CONTAINING WASTE, WOOD, BRICKS, METAL, CONCRETE, WALL BOARD, PAPER AND CARDBOARD.
- 14. A RESPONSE TO A NOTIFICATION OF NON-CONFORMANCE OR INADEQUATE MEASURES SHALL BE MADE WITHIN 6 HOURS AFTER RECEIVING SUCH NOTIFICATION.
- 15. EROSION CONTROL DEVICES SHALL BE MAINTAINED BY REMOVING ALL SILT BEFORE THEY BECOME 1/3 FULL.

CONSTRUCTION NOTES:

- 1. CONTRACTOR SHALL VERIFY LOCATIONS AND DEPTHS OF EXISTING UNDERGROUND UTILITIES AND STRUCTURES PRIOR TO COMMENCING CONSTRUCTION OPERATIONS. LOCATIONS AND DEPTHS OF EXISTING UTILITIES SHOWN ARE APPROXIMATE AND MAY NOT REFLECT THE ACTUAL FIELD CONDITIONS. CONTRACTOR SHALL BE RESPONSIBLE FOR FIELD VERIFYING EXACT LOCATION AND ELEVATION OF UTILITIES AND OTHER UNDERGROUND LINES USING "NO-CUTS" AND TEST PITS. CONFLICTS BETWEEN NEW AND EXISTING UTILITIES SHALL BE IMMEDIATELY BROUGHT TO ENGINEER'S ATTENTION.
- 2. CONTRACTOR SHALL PROVIDE EXCAVATION SUPPORT, AS REQUIRED, DURING CONSTRUCTION TO MAINTAIN THE INTEGRITY OF THE EXISTING UTILITIES, ROADS, AND STRUCTURES.
- 3. CONTRACTOR SHALL CONFINE HIS ACTIVITIES WITHIN PUBLIC PROPERTIES AND THE ROAD R/W. CONTRACTOR SHALL INSTALL BOTH TREE PROTECTION FENCE IN ACCORDANCE WITH STANDARD DETAIL 0249104R ON DRAWING C012 AND SPECIFICATION SECTION 02100 AND SILT FENCE IN ACCORDANCE WITH SPECIFICATION SECTION 02276 ALONG THE SOUTHEAST SIDE OF THE ENTIRE ROAD R/W AND AROUND THE TREES SHOWN ON THE DRAWINGS TO PREVENT CONTRACTOR ACCESS TO PRIVATE PROPERTIES AND TREES TO REMAIN IN PLACE.
- 4. DUCTILE IRON PIPE SHALL BE PRESSURE CLASS 350. ALL DUCTILE IRON PIPE AND FITTINGS PROVIDED SHALL BE LINED ON THE INTERIOR WITH PROTECTO 401
- 6. UPON COMPLETION OF ALL OR ANY PART OF A SANITARY SEWER LINE, THE CONTRACTOR SHALL TEST SAID SEWER FOR ACCEPTABILITY. MANHOLES SHALL BE VACUUM TESTED. ALL TESTS SHALL BE CONDUCTED IN THE PRESENCE OF THE OWNER'S SEWER CONSTRUCTION INSPECTOR IN ACCORDANCE WITH SPECIFICATION SECTION 15000.

DOUGLAS COUNTY DOT SPECIAL CONDITIONS

- APPROVAL COVERS WORK ON DOUGLAS COUNTY RIGHT-OF-WAY ONLY. ANY REQUIRED APPROVALS FROM OTHER GOVERNING AUTHORITIES ARE THE APPLICANT'S RESPONSIBILITY.
- DOUGLAS COUNTY ASSUMES NO RESPONSIBILITY OR LIABILITY FOR ANY WORK PERFORMED, AS A RESULT OF PERMIT APPROVAL, WHICH MAY ENCROACH ONTO PRIVATE PROPERTY. IT IS THE APPLICANT'S RESPONSIBILITY TO VERIFY THE RIGHT-OF-WAY AND DETERMINE THE LIMITS OF THE RIGHT-OF-WAY IN RELATION TO THE EXISTING ROADWAY PAVEMENT, PRIOR TO COMMENCEMENT OF WORK. REQUIRED PRIVATE EASEMENTS ARE THE APPLICANT'S RESPONSIBILITY. APPLICANT PROCEEDS AT APPLICANT'S OWN RISK.
- NO ROAD CUTS ARE AUTHORIZED UNDER THIS PERMIT APPROVAL UNLESS AGREED TO BY
- 4. NO INDIVIDUAL, PARTNERSHIP, CORPORATION OR OTHER ENTITY OF ANY KIND WHATSOEVER SHALL ENGAGE IN ANY EXCAVATION OR TRENCHING EXCEPT IN COMPLIANCE WITH THE PROVISIONS OF SECTION 1021 OF THE DOUGLAS COUNTY UNIFIED DEVELOPMENT CODE AND IN COMPLIANCE WITH ANY APPLICABLE LAWS OF THE STATE OF GEORGIA OR OF THE UNITED STATES OR THE OCCUPATIONAL SAFETY AND HEALTH ADMINISTRATION (OSHA), OR ANY OTHER STATE OR FEDERAL GOVERNMENTAL ENTITY OR DEPARTMENT RULES AND REGULATIONS APPLICABLE TO EXCAVATING AND TRENCHING.
- 5. NO EXCAVATING OR TRENCHING SHALL BE PERFORMED UNTIL A PERMIT FOR SAME HAS BEEN OBTAINED FROM THE DEVELOPMENT SERVICES DEPARTMENT.
- 6. ALL CUT & FILL AREAS SHALL NOT EXCEED A 2:1 HORIZONTAL: VERTICAL SLOPE. ALL FILL SHALL BE COMPACTED AND SHALL NOT CONTAIN ORGANIC DEBRIS, INCLUDING TREES, STUMPS, BRUSH, CONSTRUCTION WASTE OR SIMILAR MATERIAL.
- 7. ALL TRENCHES AND PITS THAT ARE OPEN OVER NIGHT MUST BE PLATED.
- 8. ALL TRAFFIC CONTROL DESIGN, DEVICES, SIGNS AND PROCEDURES MUST BE IN ACCORDANCE WITH THE LATEST EDITION OF THE MANUAL ON UNIFORM TRAFFIC CONTROL
- HARD SURFACE DRIVEWAYS TO BE BORED.
- 10. INGRESS & EGRESS TO ADJACENT PROPERTY OWNERS SHALL BE MAINTAINED @ ALL TIMES.
- 11. EXISTING DRIVEWAYS DISTURBED DURING CONSTRUCTION SHALL BE REPLACED OR REPAIRED IN LIKE KIND MATERIALS.
- 12. YARDS AND OTHER MAINTAINED AREAS WILL BE CLEARED OF CONSTRUCTION MATERIALS AND OTHER DEBRIS AND RETURNED TO ORIGINAL OR BETTER CONDITION.
- 13. ALL WORK ZONE ACTIVITIES SHALL BE PERFORMED FOLLOWING INDUSTRY STANDARD SAFETY RULES, REGULATIONS, GUIDELINES, TECHNIQUES, PROCEDURES, ETC. SO AS TO PROTECT AND PROVIDE THE SAFEST POSSIBLE ROADWAY WORK ZONE FOR THE TRAVELING
- 14. ALL DISTURBED SHOULDERS AND DITCHES SHALL BE RE-ESTABLISHED AND PERMANENTLY STABILIZED IN WIDTH, GRADE, SLOPE, ETC., EQUAL TO OR GREATER THAN THE ROADWAY CONDITIONS THAT EXISTED PRIOR TO COMMENCEMENT OF THE APPLICANT'S CONSTRUCTION ACTIVITIES.
- 15. SHOULDERS, DITCHES, AND SLOPES SHALL BE MAINTAINED IN A SAFE MANNER DURING APPLICANT'S CONSTRUCTION ACTIVITIES, (NO VERTICAL ROADWAY DROP-OFFS, NO EOUIPMENT PARKED IN ROADWAY CLEAR ZONE OR OTHER HAZARDOUS CONDITIONS).
- 16. DISTURBED AREAS SHALL BE PROGRESSIVELY RESTORED AS THE WORK ZONE MOVES. ALL RIGHT-OF-WAY RESTORATION SHALL BE ACCOMPLISHED ON A SCHEDULE ACCEPTABLE TO DOUGLAS COUNTY DOT.
- 17. LANE CLOSURES MAY BE IMPLEMENTED DURING NON-PEAK HOUR PERIODS ONLY. PEAK PERIODS ARE NORMALLY CONSIDERED TO BE 7:00 AM — 9:00 AM AND 3:00 PM TO 6:00 PM.
- 18. APPLICANT OR APPLICANT'S CONTRACTOR SHALL, AT THE DIRECTION OF THE DOUGLAS COUNTY DOT, IMMEDIATELY REMOVE ANY EXISTING LANE CLOSURE AND REOPEN ALL TRAFFIC LANES, IF A DOT REPRESENTATIVE DETERMINES EXISTING TRAFFIC CONDITIONS OR SAFETY ISSUES WARRANT SUCH ACTION.

- CONTRACTOR SHALL PERFORM ALL MEASURES NECESSARY TO ADEQUATELY PROTECT ALL EXISTING TREES ADJACENT TO THE WORK AS IS CONSISTENT WITH THE NATURE OF THE WORK.
- CERAMIC EPOXY.
- 5. BEDDING SEE DETAIL 0222102 ON SHEET D001.

EMERGENCY PHONE NUMBERS

AMBULANCE: 911 POLICE: 911 FIRE: 911

DOUGLASVILLE-DOUGLAS COUNTY WATER AND SEWER AUTHORITY: (770) 949-7617

HAZEN AND SAWYER, P.C.: (404) 459-6363

GAS: AUSTELLGAS SYSTEM: (770) 948-1841 X3272 ELECTRIC: GREYSTONE POWER CO.: (770) 370-2084 GEORGIA POWER CO.: (404) 506-4569 COMMUNICATIONS: AT&T: (404) 216-7772

COMCAST: (770) 559-6879 ZAYO FIBER SOLUTIONS: (678) 666-2493 UTILITIES PROTECTION CENTER OF GA: 1-800-282-7411



CALL 811 BEFORE YOU DIG!

CALL BEFORE YOU DIG!

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CLEARING PHASE

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GRADING PHASE

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FINAL PHASE

DETAILS

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NOTES

DESCRIPTION

COVER SHEET

NUMBER

G000

G001

G002

C001

C002

C003

C004

C005

C006

C007

C008

C009

C010

C011

S001

C012

C013

C014

C015

C016

C017

C018

C019

C020

C021

S001

STRUCTURAL

STANDARD DETAILS

CIVIL

GENERAL

DATE: HAZEN NO .:

DRAWING

NUMBER:

B. MOSS J. JORDAN DRAWN BY: D. EHRHARDT CHECKED BY: IF THIS BAR DOES NOT MEASURE 1" THEN DRAWING IS NOT TO FULL SCALE DATE BY **ISSUED FOR**

ENGINEER:

DESIGNED BY:

100% SUBMITTAL



Hazen HAZEN AND SAWYER **5775 PEACHTREE DUNWOODY ROAD,** SUITE D-520 ATLANTA, GA 30342

STEWART MILL ROAD SANITARY SEWER

REPLACEMENT PROJECT

DOUGLASVILLE-DOUGLAS COUNTY

WATER AND SEWER AUTHORITY



GENERAL GENERAL NOTES AND INDEX OF DRAWINGS

MAY 2019

31247-010

G001

1.800.282.7411

IRON

INCH

INS

INT

INV

JCT

LTG

LVR

LWL

MECH

MET

MFR

MG

MGD

MH

MIN

MLDG

MON

OHE

OPER

ORIG

OVHD

INCLUDED

INFLUENT

INTERIOR

JUNCTION

JOINT

INVERT

INSULATION

JUNCTION BOX

LENGTH/ANGLE

POUND/LINE BACK

LABORATORY

LAMINATED

LINEAR FEET

LIVE LOAD

LIGHT POLE

LOW POINT

LIGHTING

LOUVER

LIGHT

LONG RADIUS

MAINTENANCE

MATERIAL

MAXIMUM

MECHANICAL

MANUFACTURER

MILLION GALLONS

MISCELLANEOUS

MECHANICAL JOINT

MASONRY OPENING

MODIFY/MODIFIED

STABILIZED EARTH

MILLION GALLONS PER DAY

MEMBRANE

MANHOLE

MINIMUM

MOLDING

MONUMENT

MECHANICALLY

MOTOR

MOUNTED

MOUNTING

MULTIPLE

NORTH

NEAR FACE

NOMINAL

NATURAL GAS

NOT TO SCALE

ON CENTER

OPERATOR

OPPOSITE

ORIGINAL

OPEN TRUSS

OVERHEAD

OUTSIDE FACE

NOT IN CONTRACT

NON POTABLE WATER

OUTSIDE DIAMETER

OVER HEAD ELECTRIC

NOT APPLICABLE

METAL

MANUFACTURER

LOW WATER LEVEL

INSIDE DIAMETER

INSIDE FACE

PARALLEL

PCV

PSI

PV

PVC

RCP

RECIR

RECP

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RED

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REINF

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SUB

SUP

SUR

RD

PLAT BOOK

PERFORATED

POWER POLE

PARTITION

PAVEMENT

QUANTITY

RADIUS/RISER

REBAR WITH CAP

ROAD/ROOF DRAIN

RECIRCULATION

RECEPTACLE

RECTANGULAR

REINFORCING

REDUCER

REFERENCE

REGISTER

REMOVE

REVISE

ROUND

REQUIRED

RESTRAINED

RESTRAINED JOINT

ROUGH OPENING

RIGHT OF WAY

SOUTH/SLOPE

SURVEY BASELINE

STORM/SITE DRAIN

SANITARY

SCHEDULE

SERVICE

SHEET

SIMILAR

SQUARE

STREET

STATION

STANDARD

STORAGE

STIRRUP

STRUCTURAL

STRUCTURAL

SUBSTITUTE

SUPERINTENDENT

STEEL

SUPPLY

SURFACE

SWITCH

SUSPENDED

SWITCHBOARD

SYMMETRICAL

SIDE WATER DEPTH

SQUARE FEET

SQUARE INCH

STEEL JOIST

SPECIFICATION

SANITARY SEWER

STAINLESS STEEL

REVOLUTIONS PER MINUTE

REMOTE TERMINAL UNIT

POTABLE WATER

PLUG VALVE

PREFABRICATED

PUMPING STATION

PERPENDICULAR

POINT OF CURVE/PIECE

POLYETHYLENE LINING

POINT OF INTERSECTION

PRESSURE RELIEF VALVE

POUNDS PER SQUARE FOOT

POUNDS PER SQUARE INCH

RETURN ACTIVATED SLUDGE

REINFORCED CONCRETE PIPE

POINT OF TANGENT/POINT

POLYVINYL CHLORIDE

PROPERTY LINE/PLATE

POINT OF COMPOUND CURVE

POUNDS PER CUBIC FOOT

PRESSURE CONTROL VALVE

TREAD

TANGENT

TOP OF CURB

TECHNICAL

TELEPHONE

TEMPERATURE

THERMOSTAT

TOP OF DECK

TOP OF SLAB

TOP OF WALL

TOLERANCE

TYPICAL

TRANSFORMER

UNDERGROUND

UNIT HEATER

UNFINISHED

UNKNOWN

VACUUM

VELOCITY

VERTICAL

VENT PIPE

WEST/WIDTH

WIDE FLANGE

WALL HYDRANT

WATER LEVEL

WATER LINE

WATERPROOF

WATERSTOP

WEIGHT

YARD

YEAR

WEATHERSTRIP

WATERTIGHT

WATER VALVE

WELDED WIRE FABRIC

WITHOUT

WROUGHT IRON

WINDOW OPENING

WATER PROOFING

WALL PENETRATING TYPE

WATER SURFACE ELEVATION

VOLUME

TOP OF FOOTING

TOP OF MASONRY/MANHOLE

TWISTED PAIR SHIELDED

UNLESS NOTED OTHERWISE

VENTILATING/VENTILATION

WASTE ACTIVATED SLUDGE

VENT THROUGH ROOF

THICK

THROUGH

TOP AND BOTTOM

TONGUE AND GROOVE

TOTAL DYNAMIC HEAD

TEMPORARY BENCH MARK

T&B

TAN

TBM

TECH

THERMO

TEL

THK

THRU

TOD

TOF

TOM

TOS

TOW

TOL

TPS

TYP

UH

UNFIN

UNO

VEL

VENT

VERT

VTR

W/O

WPT

WSE

WWF

TRANS

ROCK

STEEL

INSULATION

GRATING

WATER SURFACE

CHECKERED PLATE

_	
	STREAM RESTORATION AND EROSION
	STREAM RESTORATION AND ERUSION
	CONTROLLECEND
	CONTROL LEGEND

I.E. INVERT ELEVATION

EA .. EQUALITY

EX EASEMENT EX EDGE OF WATER EX GRADE (PROFILE) EX PROPERTY LINE EX TOPO MAJOR EX TOPO MINOR TEMP ROAD AT CREEK **DIVERSION STONES**

FB

FILTER BAG PROP GRADE (PROFILE) PROP TOPO MAJOR PROP TOPO MINOR

IRW STONE

SILT FENCE

TEMPORARY PUMP AROUND

	BRICK	WOOD BLOCKING
	SYMBOLS	
	DECIDUOUS (TREE)	
	CONIFEROUS (TREE)	
***	LIGHT POLE (LP)	TREELINE
6)	POWER POLE WITH LIGHT	FIRE HYDRANT (FH)
Ø	POWER POLE (PP)	WATER VALVE (WV)
(M)	UTILITY MANHOLE (UM)	WATER METER (WM)
0	SPOTLIGHT	AIR CONDITIONER (AC)
Ğ	GAS METER (GM)	ELECTRIC METER (EM)
H	GAS VALVE (GV)	
団	TELEPHONE PEDESTAL	ELECTRIC UTILITY
COM	COMMUNICATION BOX	SIGN
0	BOLLARD (BO)	MAIL BOX
\bowtie	GATE VALVE	
	BUTTERFLY VALVE	WALL PENETRATION
	PLUG VALVE	MECHANICAL COUPLING
	<u> </u>	WELDED JOINT
	SWING CHECK VALVE	FLANGED JOINT
	GLOBE VALVE	MECHANICAL, PUSH ON OR RESTRAINED JOINT
	PINCH VALVE	
	DIAPHRAGM VALVE	
	BALL VALVE	FLUSHING CONNECTION
	BALL CHECK VALVE	HOSE BIBB
	HARNESSED FLANGED ADAPTER ⊞	QUICK DISCONNECT
	HARNESSED SLEEVE TYPE COUPLING	YARD HYDRANT
		FIRE HYDRANT
	HARNESSED FLEXIBLE COUPLING	SOIL BORING
	SECTION AND DETAIL	L KEYING
		· · · · · · · · · · · · · · · · · · ·

DRAWINGS ARE CROSS REFERENCED IN THE FOLLOWING METHOD: (A) A SECTION CUT ON DRAWING A3 IS IDENTIFIED AS FOLLOWS:

(B) THE SECTION SHOWN ON DRAWING A6 IS IDENTIFIED AS FOLLOWS:

DETAILS ARE CROSS REFERENCED IN A SIMILAR MANNER, EXCEPT DETAILS

STANDARD DETAILS ARE REFERENCED BY A UNIQUE SEVEN DIGIT NUMBER

AND ARE SHOWN ON THE CONTRACT DRAWINGS BY ONE OF TWO METHODS:

STANDARD DETAILS ARE COMPILED IN APPROXIMATE NUMERICAL ORDER IN

REFERENCED ITEM

ARE IDENTIFIED BY A SQUARE WITH A NUMBER IN THE UPPER HALF.

SEE 1509203 REFERENCED ITEM

THE BACK OF THE CONTRACT DRAWINGS ON THE D* DRAWINGS.

DRAWING WHERE SECTION IS SHOWN

DRAWING FROM WHERE SECTION WAS TAKEN

SECTION LETTER

				PROJECT ENGINEER:	D. EHRHARD
7				DESIGNED BY:	B. MOSS
				DRAWN BY:	J. JORDAN
•			- 6	CHECKED BY:	D. EHRHARD
				IF THIS BAR DOES NOT MEASURE 1" THEN DRAWII	NG 0 1/2" 1
REV	ISSUED FOR	DATE	BY	IS NOT TO FULL SCALE	

ANCHOR BOLT

AREA DRAIN

ADDITIONAL

ADJUSTABLE

AGGREGATE

ALUMINUM

ALTERNATE

ASPHALT

BORING

APPROXIMATE

ARCHITECTURAL

BORE AND JACK

BUTTERFLY VALVE

BITUMINOUS

BENCH MARK

BACK OF CURB

BACK PRESSURE VALVE

BASELINE

BUILDING

BEARING

BRICK

BRONZE

CABINET

CEMENT

CUBIC FEET

CAST IRON PIPE

CENTER LINE

CHLORINE

CAULKING

CLEANOUT

COLUMN

CONCRETE

COMMUNICATIONS

CONSTRUCTION

CONTINUOUS

CONTRACTOR

CORPORATION

CERAMIC TILE

CHECK VALVE

COLD WATER

DETONATOR ARRESTOR

CUBIC YARD

DEED BOOK

DIAMETER

DIAGONAL

DIMENSION

DISCHARGE

DISTRIBUTION

DOUBLE JOIST

DEAD LOAD

DOWN

DOZEN

DOOR

DOWEL

DRAWING

DRAWINGS

DIRECT CURRENT

DUCTILE IRON PIPE

CONTROL JOINT

COURSE

COPPER

CONCRETE PLANK

CATCH BASIN

CENTER TO CENTER

CONSTRUCTION EASEMENT

CUBIC FEET PER MINUTE

CAST IRON/CUBIC INCHES

CORRUGATED METAL PIPE

U.S. ARMY CORPS OF ENGINEERS

CHLORINATED POLYVINYL CHLORIDE GR

BALL VALVE

BLOCK

BOTTOM OF FITTING ELEVATION

AIR RELEASE VALVE

ADDL

ADJ

AFF

ALT

ARV

BFV

BLK

BOC

BOT

BRK

BRZ BT

CAB

CB

CE

CEM

CF

CI

CIP

 CL_2

CLR

CMP

COE

COL

COMM

CONC

CONST

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CONTR

CORP

CORR

CP

CPVC

CRS

CTJ

CV

DIA

DIAG

DIM

DIP

DIST

DOZ

DWG

DWL

DISCH

CLKG

BITUM

ASPH

APPROX

AGGR

ASBESTOS CEMENT

ALTERNATING CURRENT or

ABOVE FINISHED FLOOR

ALLOWANCE/ALLOWABLE

EAST/EASEMENT

EXIST IRON PIPE

EDGE OF GRAVEL

EDGE OF PAVEMENT

ELECTRIC/ELECTRICAL

ECCENTRIC

EACH FACE

EFFLUENT

ELEVATION

ENGINEER

ENTRANCE

EQUIPMENT

EACH WAY

EXISTING

EXCAVATE

EXHAUST

EXTERIOR

EXPANSION

FABRICATE

FLOOR DRAIN

FOUNDATION

FINISH FLOOR

FIRE HYDRANT

FLASHING/FLOOR

FINISH

FIXTURE

FLEXIBLE

FLANGE

FLUORESCENT

FORCE MAIN

FIREPROOF

FLAME ARRESTOR

FRAME AND COVER

FRAME AND GRATE

FIRE EXTINGUISHER

FEDERAL EMERGENCY

MANAGEMENT AGENCY

FLEXIBLE CONNECTION

FIBERGLASS REINFORCED

GRANULAR ACTIVATED CARBON

GENERAL CONTRACTOR

GALVANIZED IRON

GALLONS PER MINUTE

GROUND SURFACE ELEVATION

HIGH-DENSITY POLYETHYLENE

HEATING, VENTILATION AND

AIR CONDITIONING

HIGH WATER LEVEL

POLYESTER LAMINATE

FINAL SETTLING TANK

FURRING/FURRED

GAS/GAS LINE

GAUGE

GALLON

GALVANIZED

GENERATOR

GATE VALVE

GUY WIRE

HOSE BIBB

HARDWARE

HEXAGONAL

HORIZONTAL

HORSEPOWER

HIGH POINT

HOT WATER

HIGHWAY

HYDRAULIC

HEATER

HOLLOW METAL

FIBER OPTIC CABLE

FLUSHING CONNECTION

ECC

EL OR ELEV

ENGR

EOP

FLUOR

100% SUBMITTAL



Hazen **HAZEN AND SAWYER**

5775 PEACHTREE DUNWOODY ROAD,

SUITE D-520

ATLANTA, GA 30342

DOUGLASVILLE-DOUGLAS COUNTY WATER AND SEWER AUTHORITY


STEWART MILL ROAD SANITARY SEWER REPLACEMENT PROJECT


W	/655		
6	Œ		
3	September 1	SEWER BUTTO	
A	6	1	5

GENERAL ABBREVITIONS, LEGEND & SYMBOLS

1509203

DATE:	MAY 2019
HAZEN NO.:	31247-010
CONTRACT NO.	:22B4413-02
DRAWING NUMBER:	
	G002

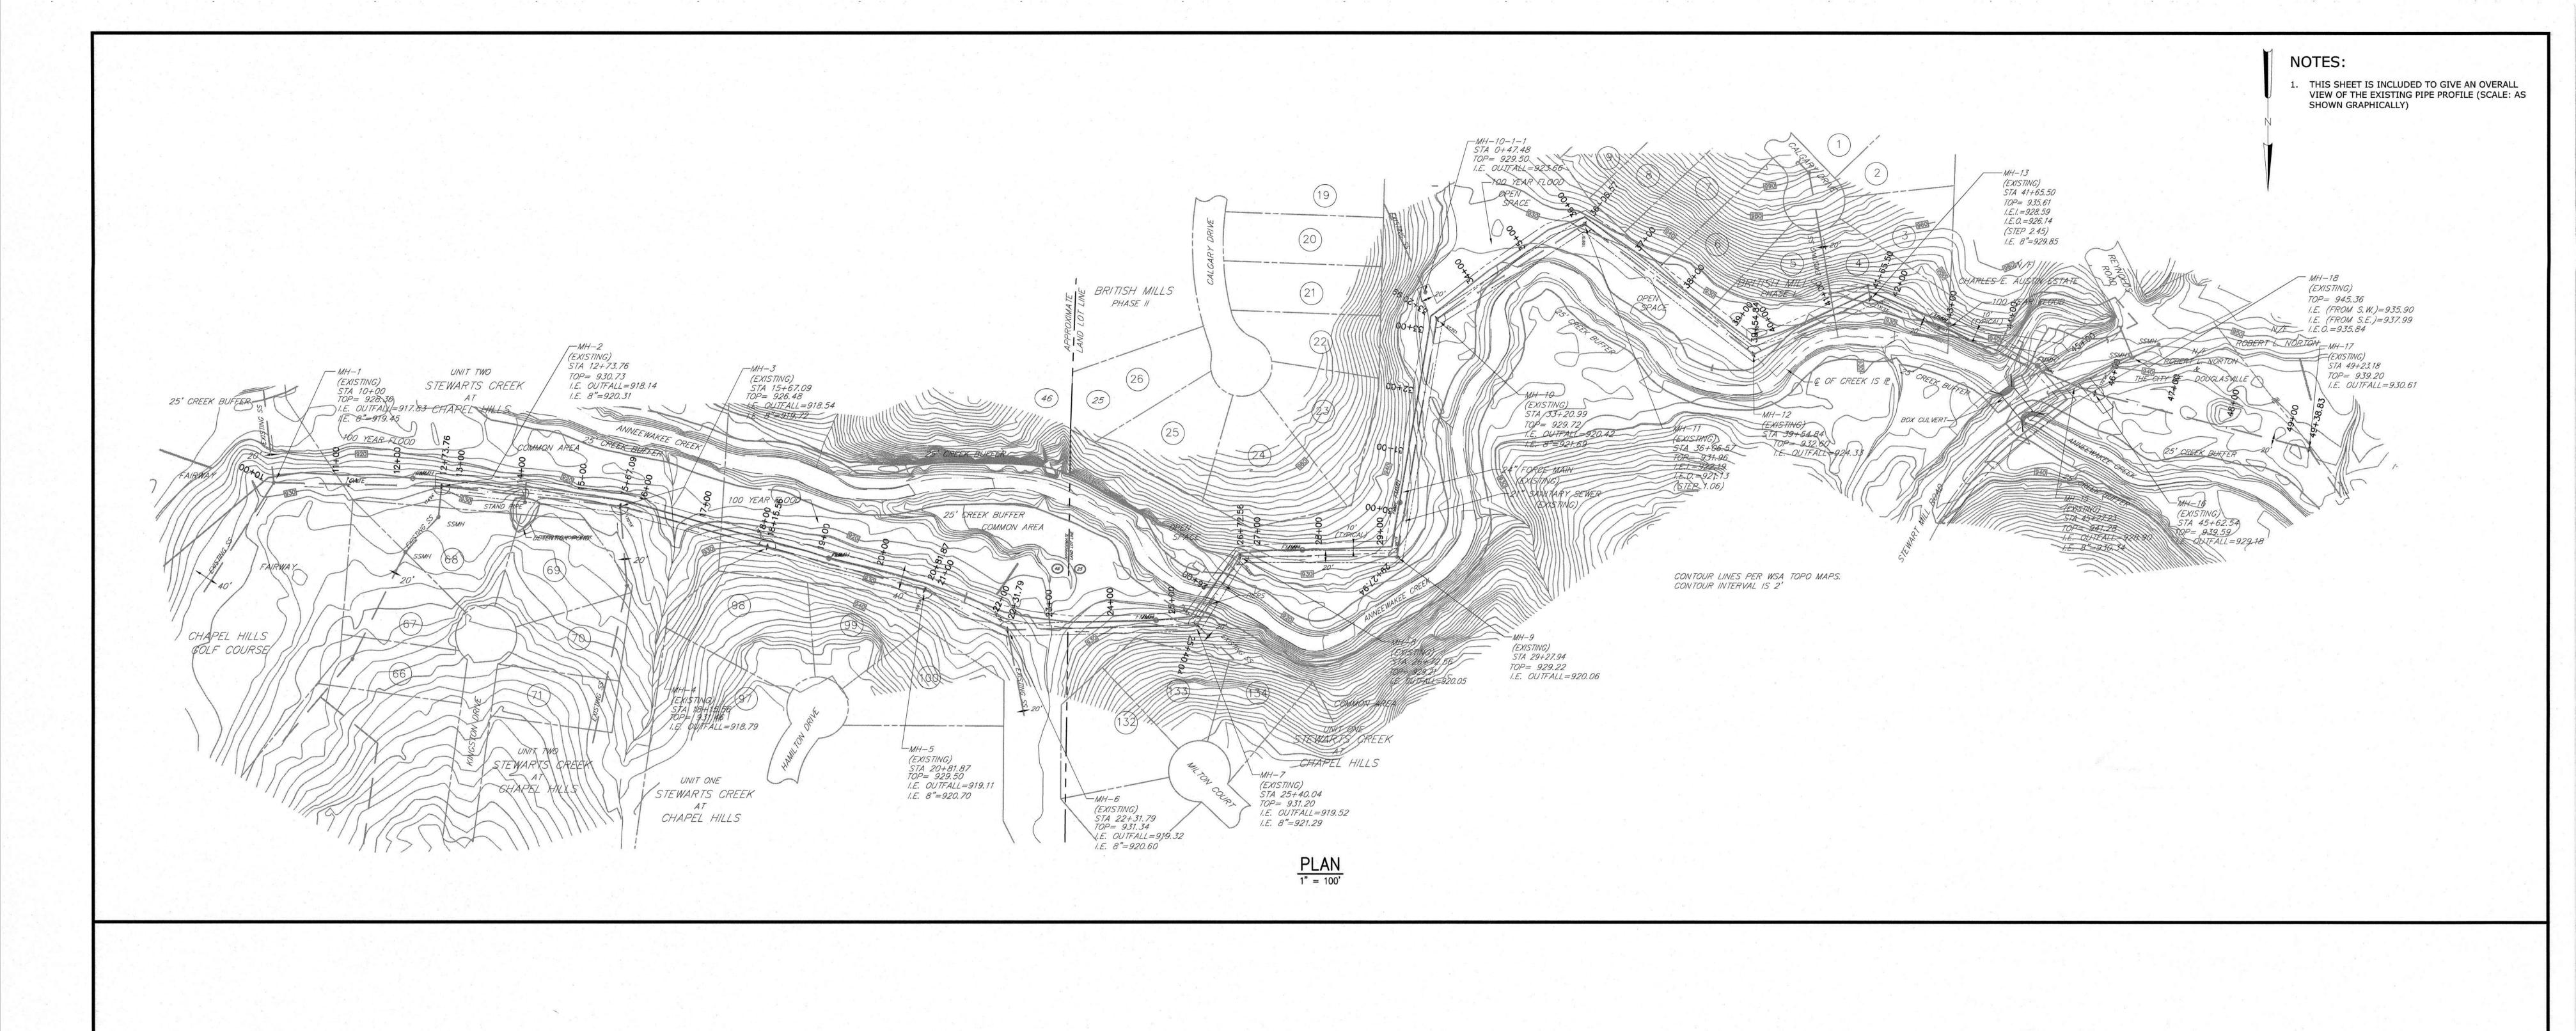


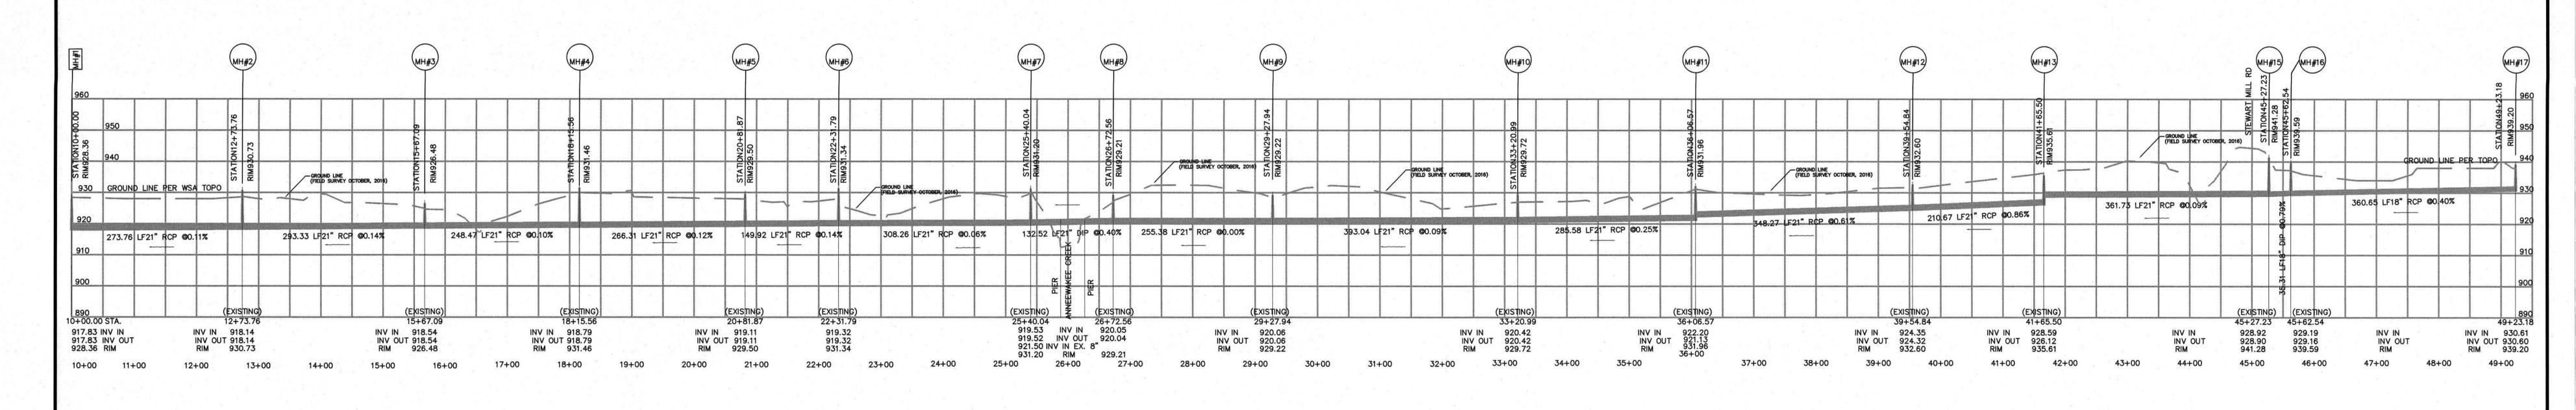

EXISTING PIPE PROFILE

1" = 100' HORIZONTAL

1" = 20' VERTICAL

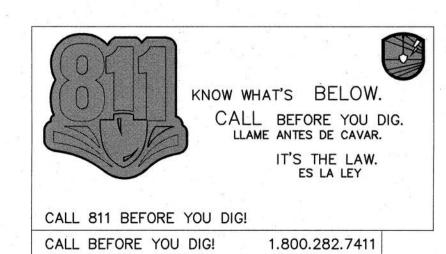

				PROJECT ENGINEER: D. EHRHARD
				DESIGNED BY: B. MOS
				DRAWN BY: J. JORDA
				CHECKED BY: D. EHRHARD
			2	IF THIS BAR DOES NOT MEASURE 1" THEN DRAWING 0 1/2"
REV	ISSUED FOR	DATE	BY	IS NOT TO FULL SCALE

MO 177524

MO 177524

PROFESSIONAL

CAGINEER

SELIRITE

100% SUBMITTAL

HAZEN AND SAWYER
5775 PEACHTREE DUNWOODY ROAD,
SUITE D-520
ATLANTA, GA 30342


DOUGLASVILLE-DOUGLAS COUNTY WATER AND SEWER AUTHORITY


STEWART MILL ROAD SANITARY SEWER
REPLACEMENT PROJECT




OUTFALL SEWER
CIVIL
EXISTING OVERALL PLAN & PROFILE

+		
	DATE:	MAY 2019
	HAZEN NO.:	31247-010
	CONTRACT NO.	:22B4413-02
	DRAWING NUMBER:	x 1

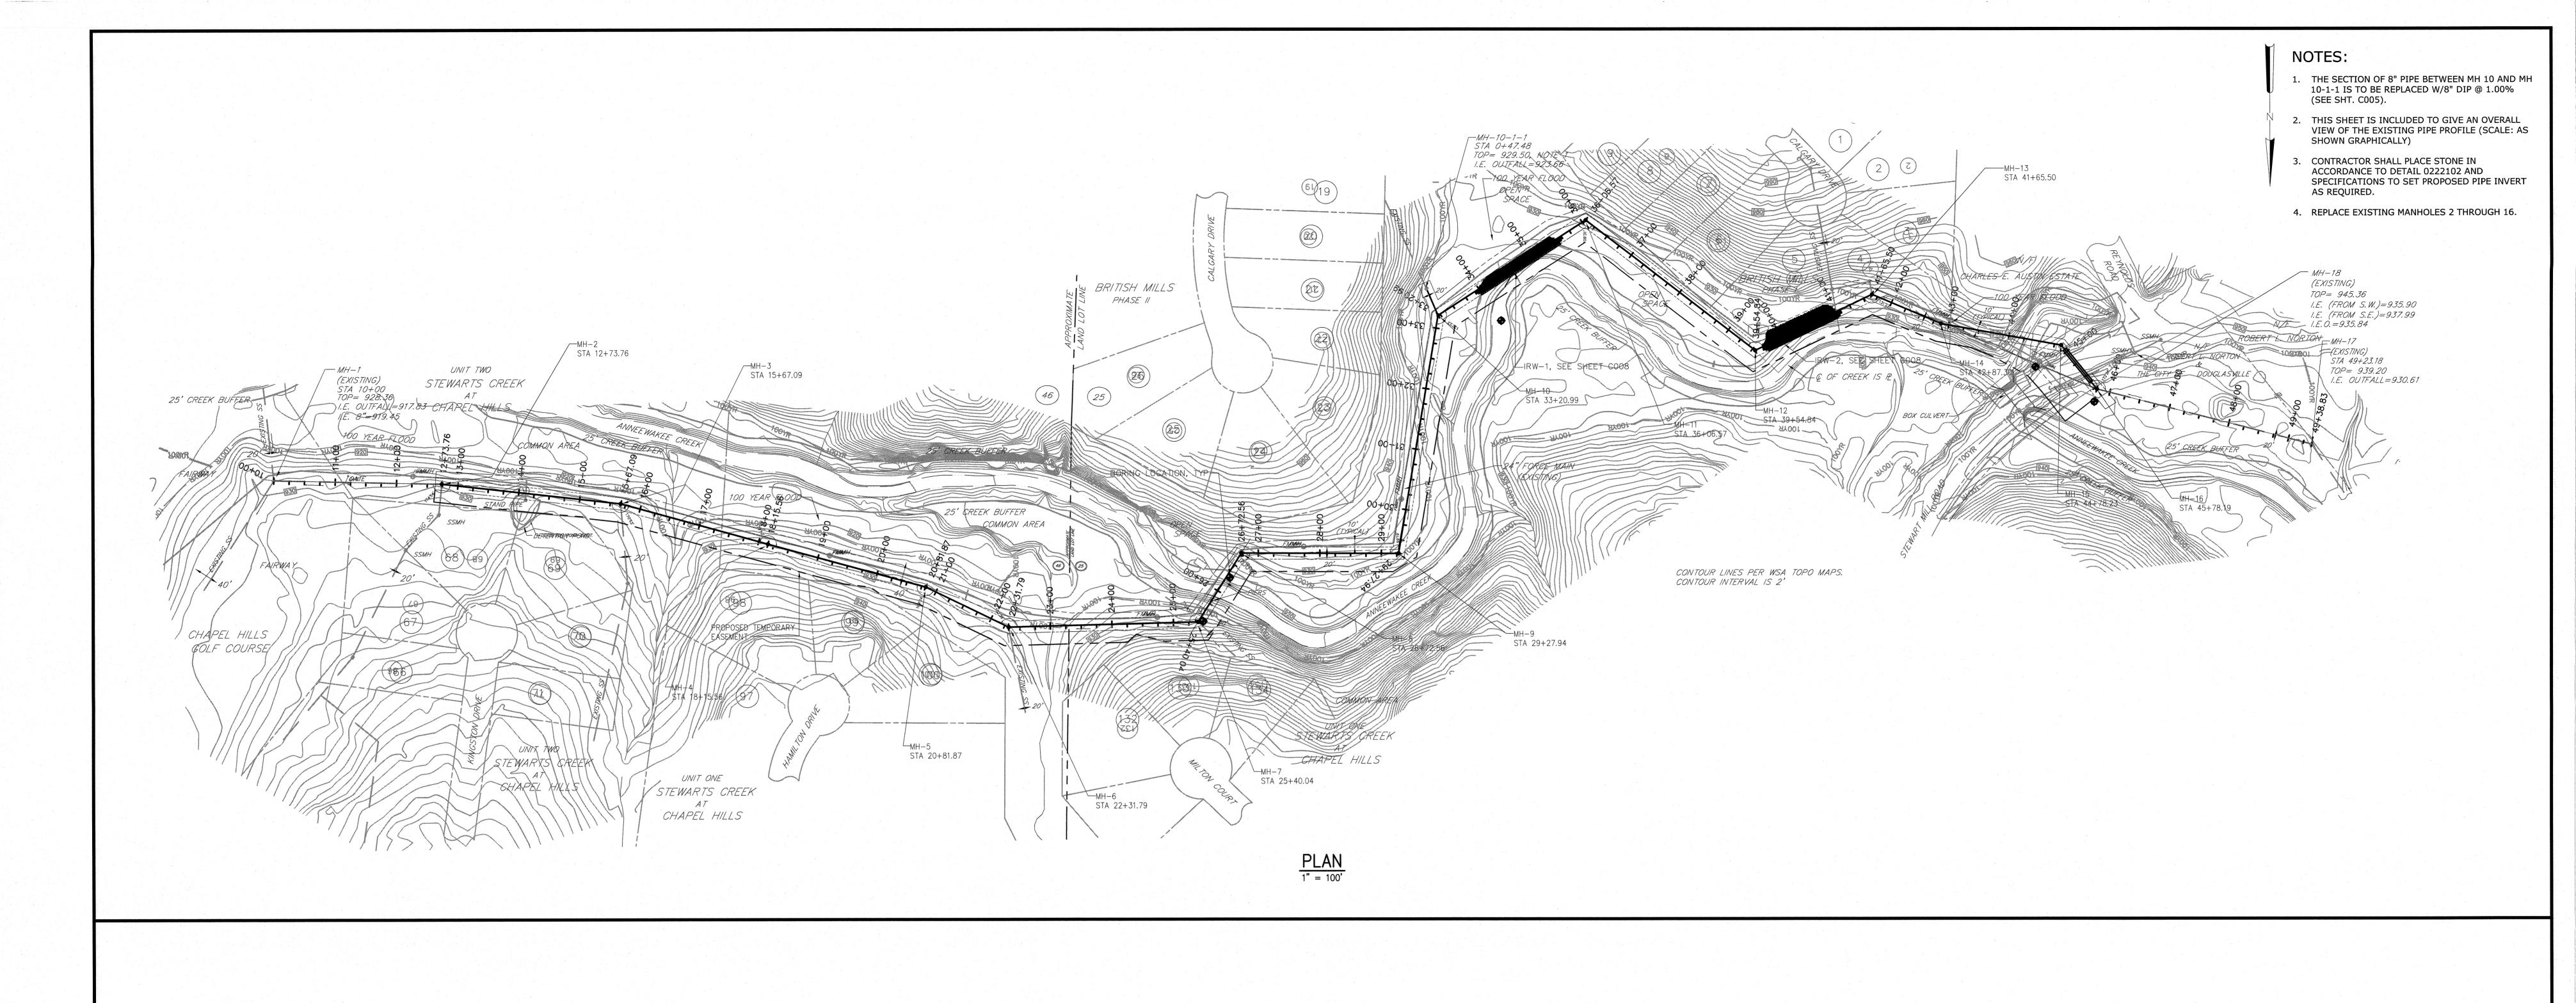

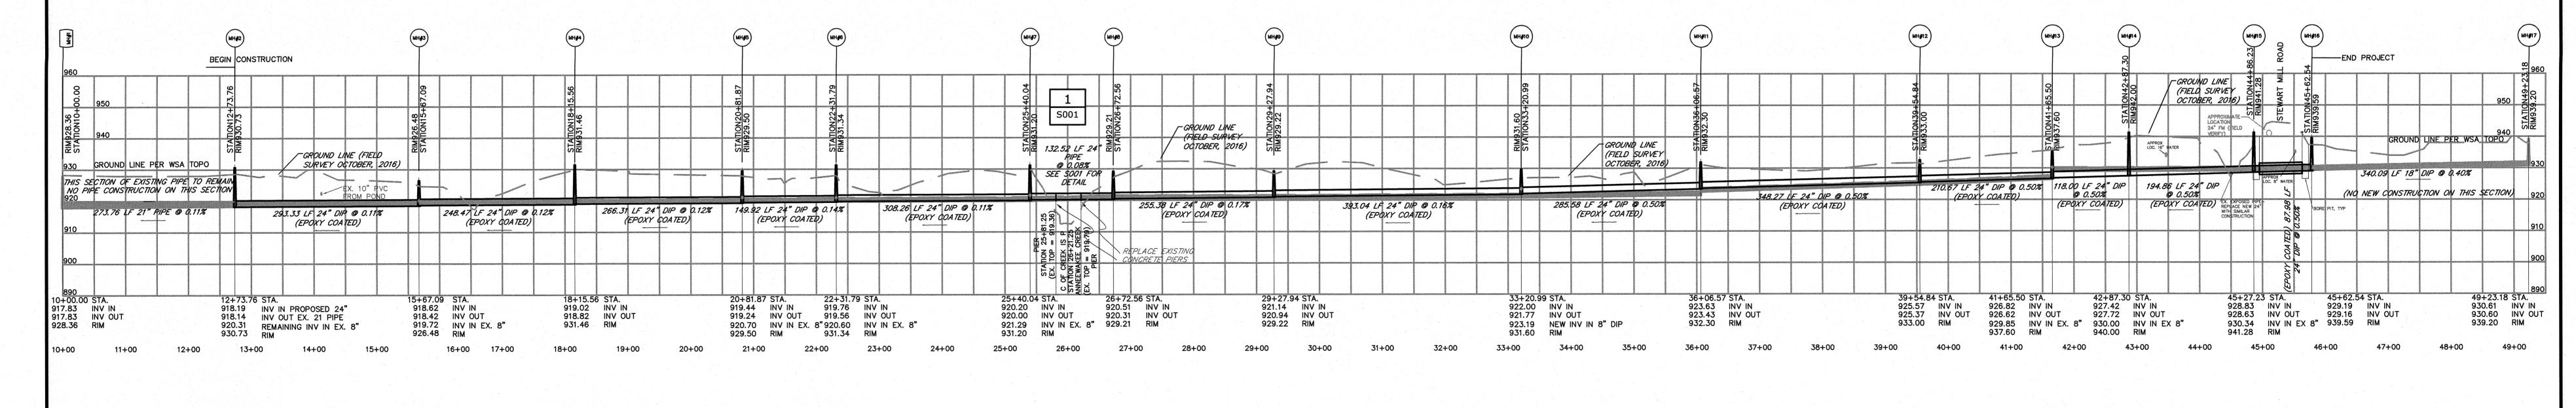

PROFILE 1" = 100' HORIZONTAL 1" = 20' VERTICAL

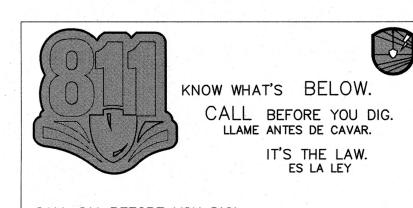

CALL 811 BEFORE YOU DIG! CALL BEFORE YOU DIG!

1.800.282.7411

PROJECT ENGINEER: D. EHRHARDT B. MOSS **DESIGNED BY:** J. JORDAN DRAWN BY: D. EHRHARDT CHECKED BY: IF THIS BAR DOES NOT MEASURE 1" THEN DRAWING IS NOT TO FULL SCALE 0 1/2" 1"

ISSUED FOR

100% SUBMITTAL

Hazen HAZEN AND SAWYER
5775 PEACHTREE DUNWOODY ROAD, SUITE D-520 ATLANTA, GA 30342


DOUGLASVILLE-DOUGLAS COUNTY WATER AND SEWER AUTHORITY

STEWART MILL ROAD SANITARY SEWER REPLACEMENT PROJECT



OUTFALL SEWER CIVIL PROPOSED OVERALL PLAN & PROFILE AND BORING LOCATIONS

MAY 2019 31247-010 CONTRACT NO.: 22B4413-02 DRAWING NUMBER:

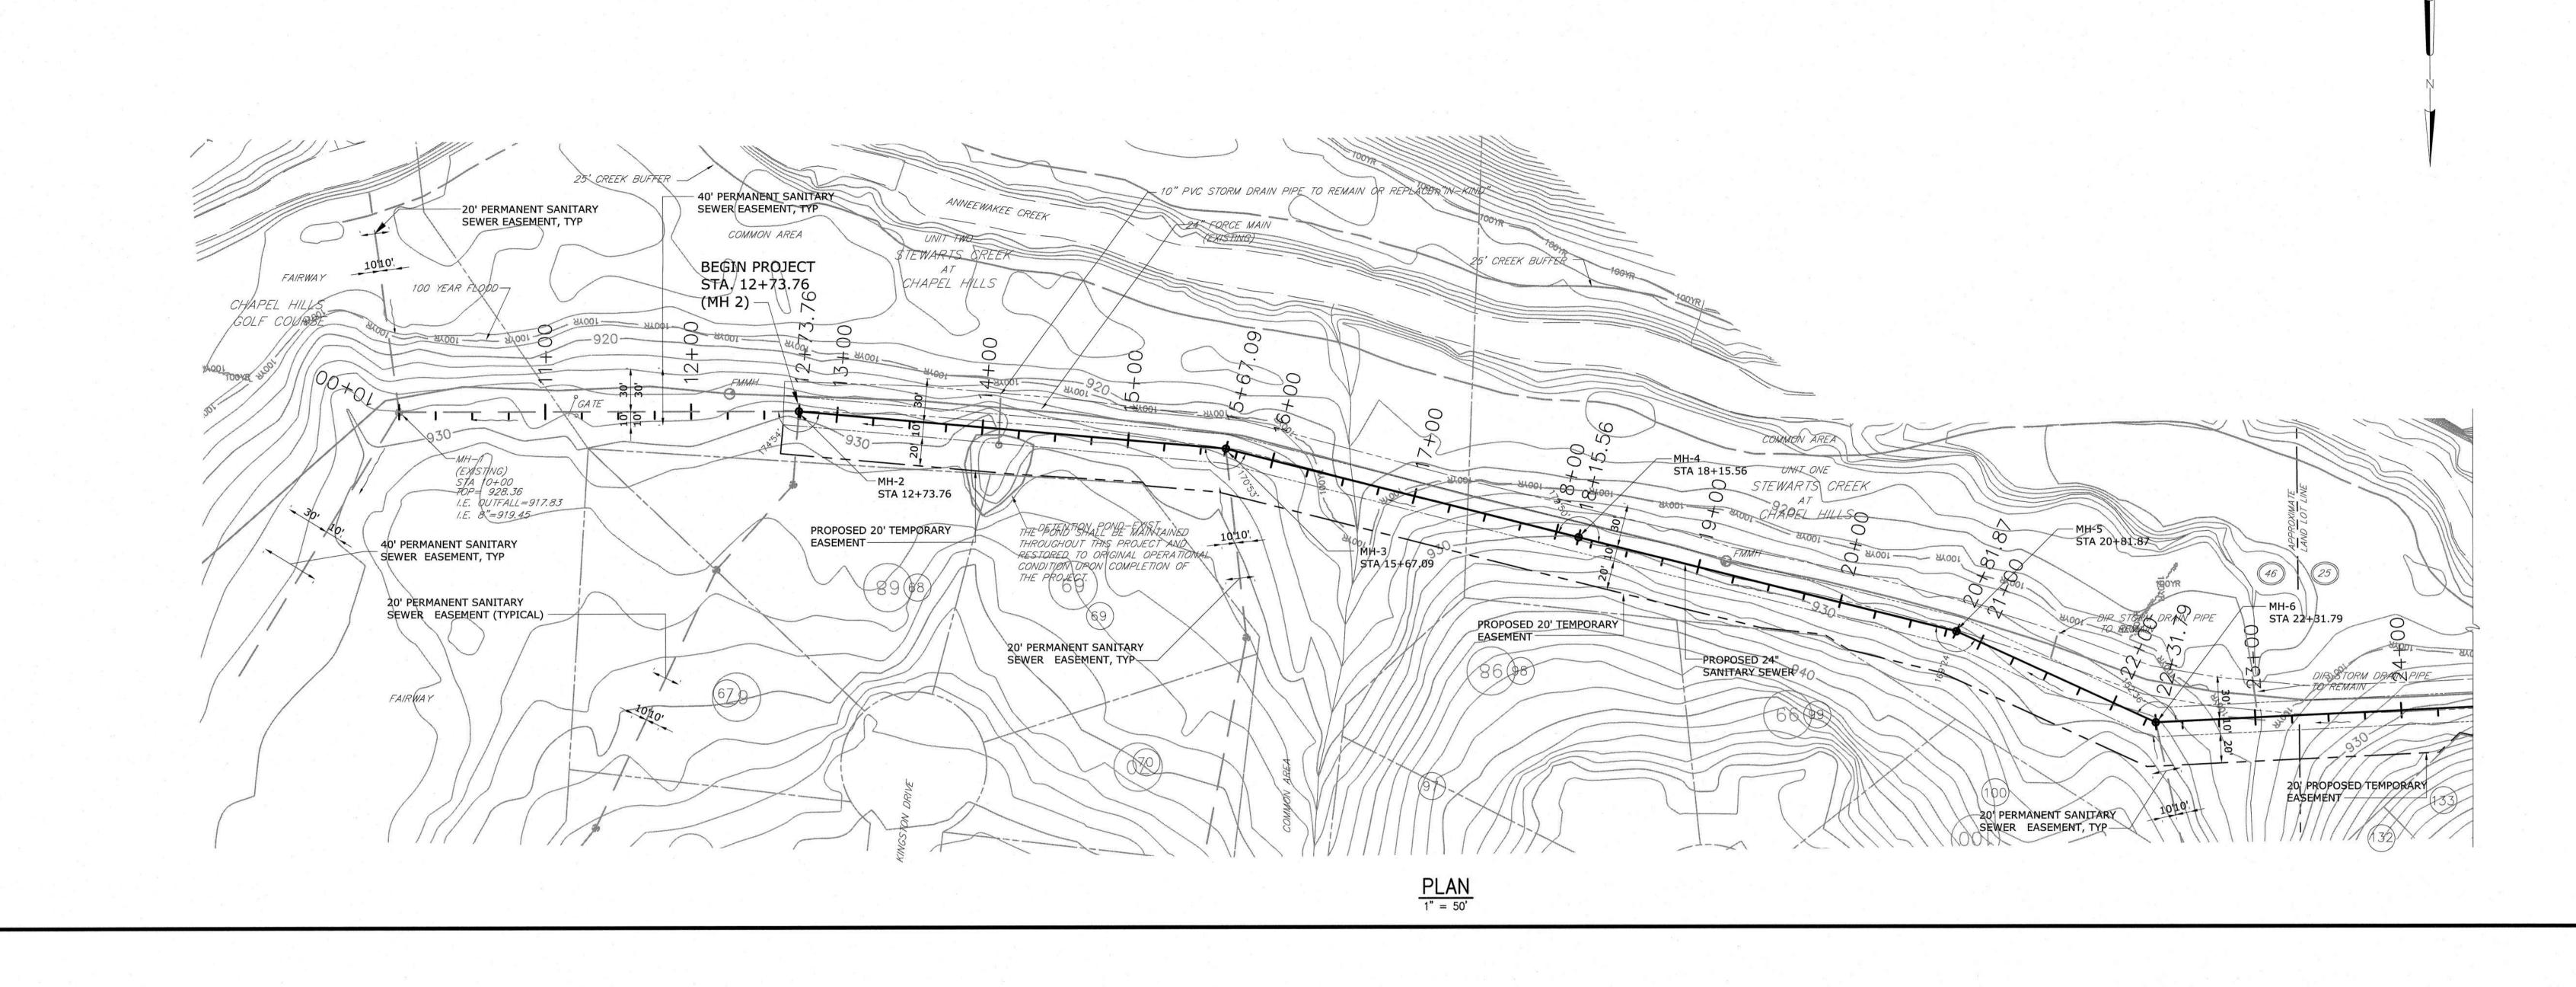

1. THE CONTRACTOR SHALL BE RESPONSIBLE FOR PROTECTION OF THE 24" FORCE MAIN THROUGHOUT THE LENGTH OF THE PROJECT AND

ANY PENALTIES IMPOSED DUE TO DAMAGE TO FM BY CONTRACTOR DURING THE PROJECT. 2. LOCATION OF EXISTING 24" FM IS BASED ON DRAWINGS FROM FILES OF DDCWSA AND FIELD

LOCATE OF AIR RELIEF VALVE MANHOLES. COORDINATION SHOULD NOT RELY ON THE FM LOCATIONS INDICATED ON PLANS. 3. CONTRACTOR SHALL ACCURATELY LOCATE AND FLAG FORCE MAIN LOCATION AT BEGINNING OF

IMMEDIATELY REPLACE. 4. ALL CONSTRUCTION, INGRESS-EGRESS AND STAGING AREAS SHALL BE WITHIN EXISTING WSA EASEMENTS. PRIOR TO ANY CONSTRUCTION ACTIVITY, THE CONTRACTOR SHALL COORDINATE ALL POINTS OF ENTRY WITH THE WSA INSPECTOR. ONCE POINTS OF ENTRY HAVE BEEN ESTABLISHED, THE CONTRACTOR SHALL STAKE ALL EASEMENTS REQUIRED TO COMPLETE THE

CONSTRUCTION. IF FLAGGING IS DISTURBED

DURING CONSTRUCTION, CONTRACTOR SHALL


PROPOSED MH TOP ELEVATIONS ARE APPROXIMATE. FINAL ADJUSTED GRADE SHALL BE DETERMINED BY BY FINISH GRADE AND TYPE SURFACE (PAVEMENT OR LANDSCAPE) OR AS

6. ALL EROSION AND SEDIMENTATION CONTROLS SHALL BE INSTALLED AT THE BEGINNING OF CONSTRUCTION.

DIRECTED BY THE WSA INSPECTOR.

CONTRACTOR SHALL PLACE STONE IN ACCORDANCE TO DETAIL 0222102 AND SPECIFICATIONS TO SET PROPOSED PIPE INVERT AS REQUIRED.

8. REPLACE EXISTING MANHOLES 2 THROUGH 16.

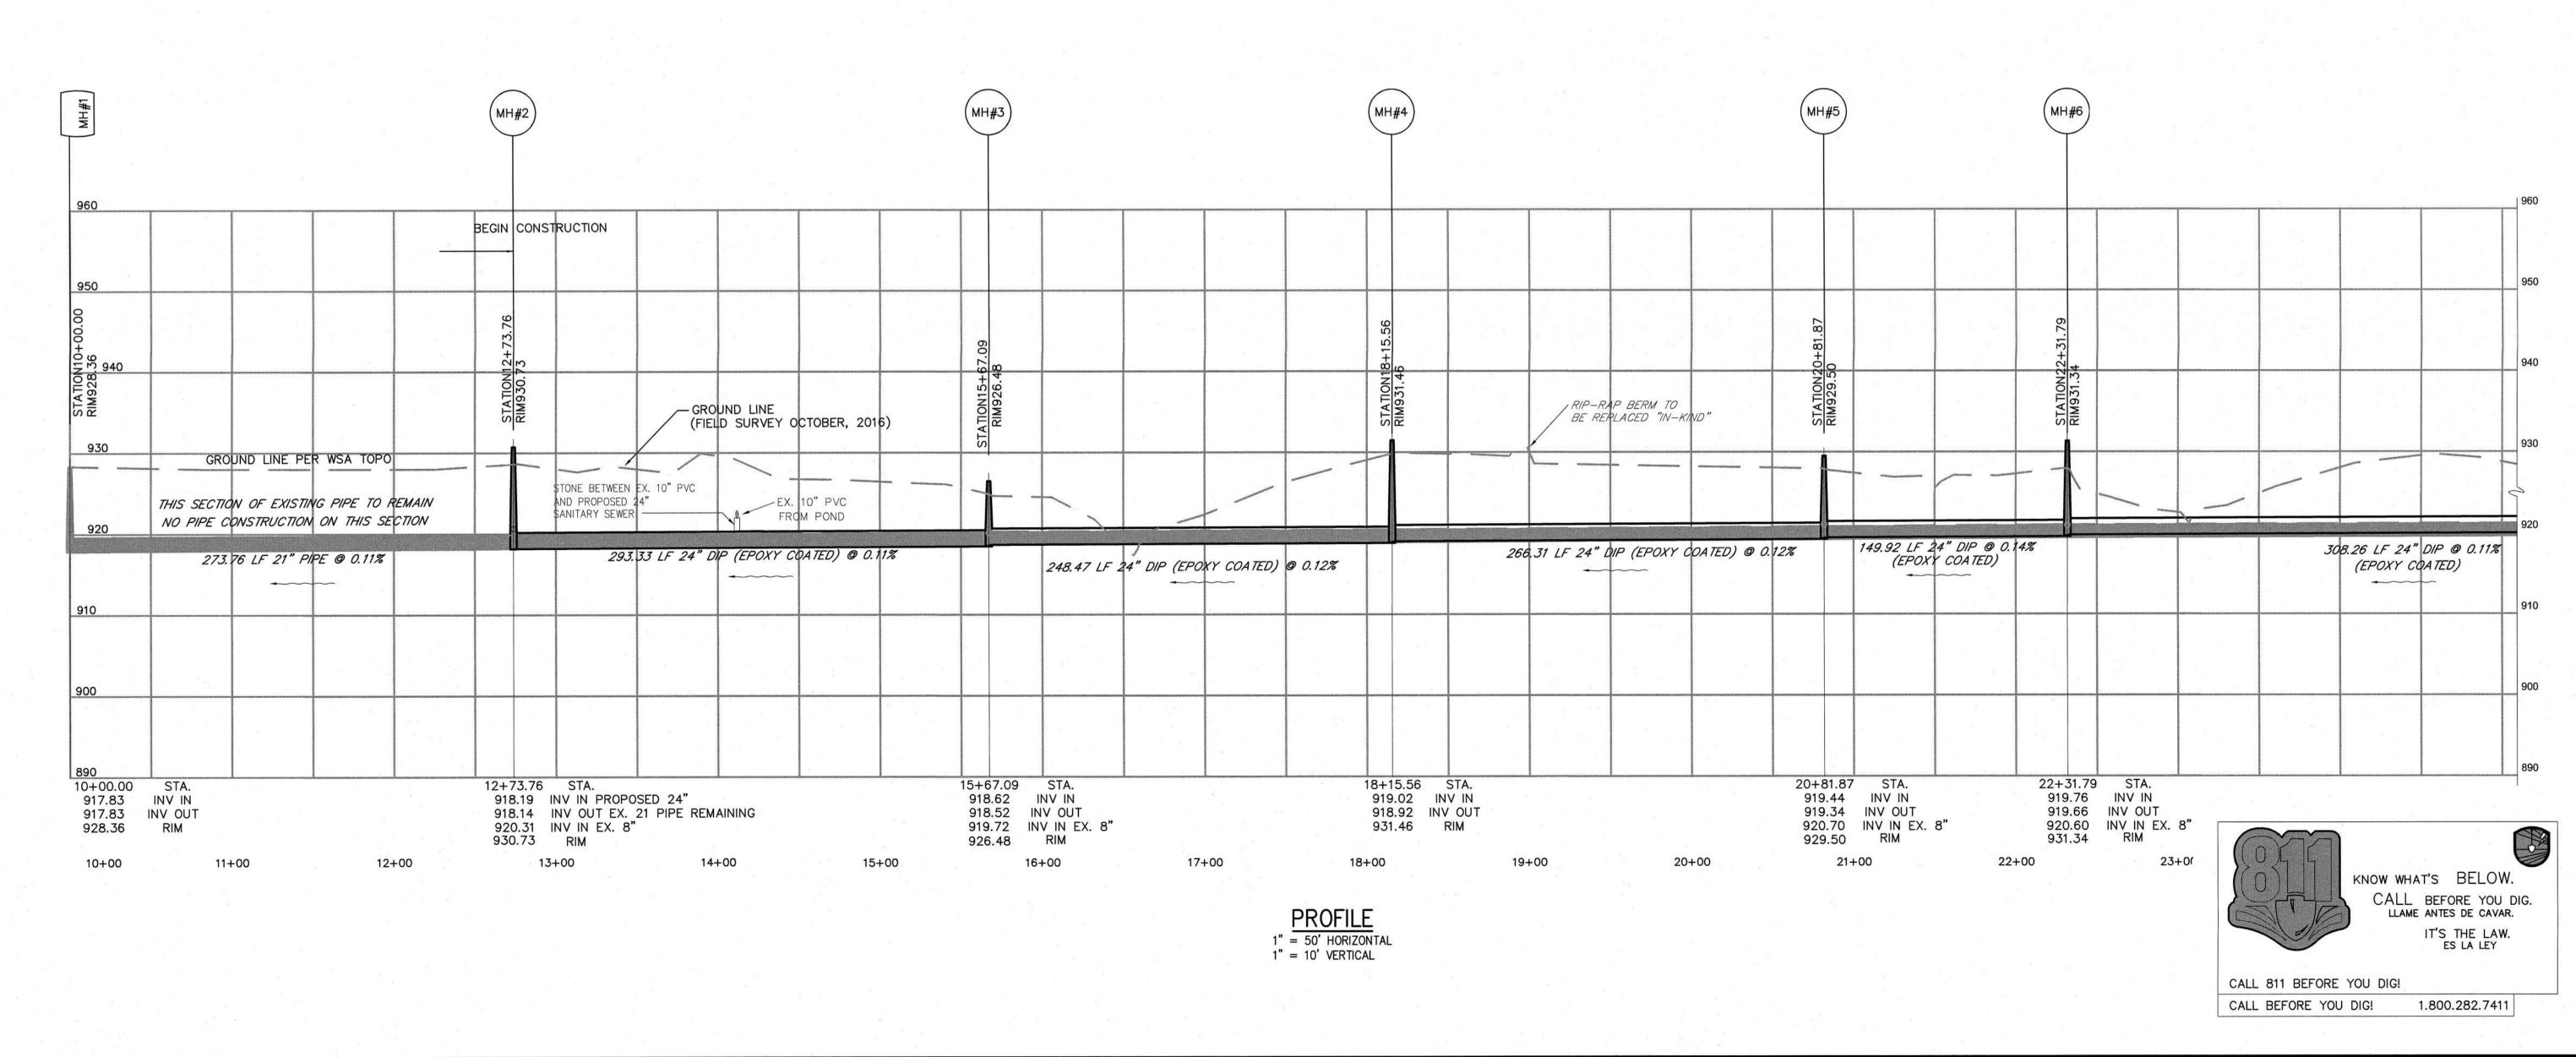

PROJECT ENGINEER: D. EHRHARDT B. MOSS DESIGNED BY: J. JORDAN DRAWN BY: D. EHRHARDT CHECKED BY: IF THIS BAR DOES NOT
MEASURE 1" THEN DRAWING
IS NOT TO FULL SCALE

ISSUED FOR



100% SUBMITTAL

Hazen HAZEN AND SAWYER
5775 PEACHTREE DUNWOODY ROAD, SUITE D-520 ATLANTA, GA 30342

DOUGLASVILLE-DOUGLAS COUNTY WATER AND SEWER AUTHORITY


STEWART MILL ROAD SANITARY SEWER REPLACEMENT PROJECT



OUTFALL SEWER PLAN & PROFILE STA 10+00 TO STA 24+00

MAY 2019 31247-010 HAZEN NO.: CONTRACT NO.: 22B4413-02

DRAWING NUMBER:

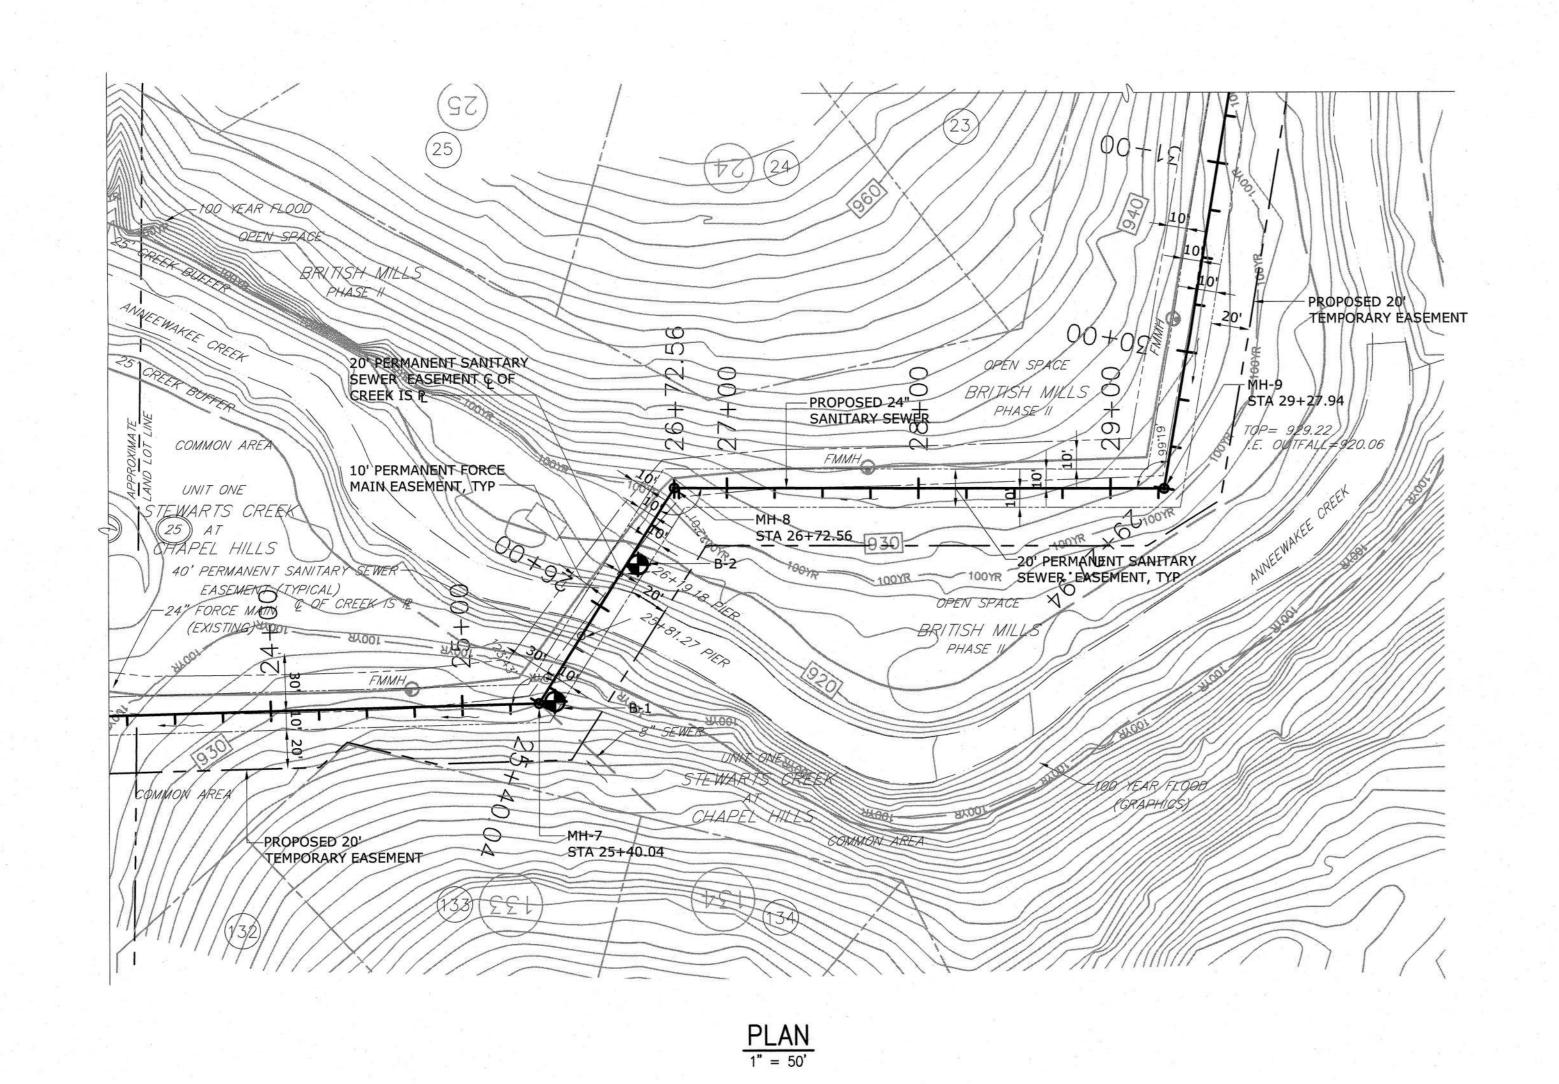

NOTES:

1. THE CONTRACTOR SHALL BE RESPONSIBLE FOR PROTECTION OF THE 24" FORCE MAIN THROUGHOUT THE LENGTH OF THE PROJECT AND ANY PENALTIES IMPOSED DUE TO DAMAGE TO FM

BY CONTRACTOR DURING THE PROJECT.

2. LOCATION OF EXISTING 24" FM IS BASED ON DRAWINGS FROM FILES OF DDCWSA AND FIELD LOCATE OF AIR RELIEF VALVE MANHOLES. COORDINATION SHOULD NOT RELY ON THE FM

LOCATIONS INDICATED ON PLANS.

3. CONTRACTOR SHALL ACCURATELY LOCATE AND FLAG FORCE MAIN LOCATION AT BEGINNING OF CONSTRUCTION. IF FLAGGING IS DISTURBED DURING CONSTRUCTION, CONTRACTOR SHALL IMMEDIATELY REPLACE.


4. ALL CONSTRUCTION, INGRESS-EGRESS AND STAGING AREAS SHALL BE WITHIN EXISTING WSA EASEMENTS. PRIOR TO ANY CONSTRUCTION ACTIVITY, THE CONTRACTOR SHALL COORDINATE ALL POINTS OF ENTRY WITH THE WSA INSPECTOR. ONCE POINTS OF ENTRY HAVE BEEN ESTABLISHED, THE CONTRACTOR SHALL STAKE ALL EASEMENTS REQUIRED TO COMPLETE THE PROJECT.


5. PROPOSED MH TOP ELEVATIONS ARE APPROXIMATE. FINAL ADJUSTED GRADE SHALL BE DETERMINED BY BY FINISH GRADE AND TYPE SURFACE (PAVEMENT OR LANDSCAPE) OR AS DIRECTED BY THE WSA INSPECTOR.

 ALL EROSION AND SEDIMENTATION CONTROLS SHALL BE INSTALLED AT THE BEGINNING OF CONSTRUCTION.

 CONTRACTOR SHALL PLACE STONE IN ACCORDANCE TO DETAIL 0222102 AND SPECIFICATIONS TO SET PROPOSED PIPE INVERT AS REQUIRED.

8. REPLACE EXISTING MANHOLES 2 THROUGH 16.

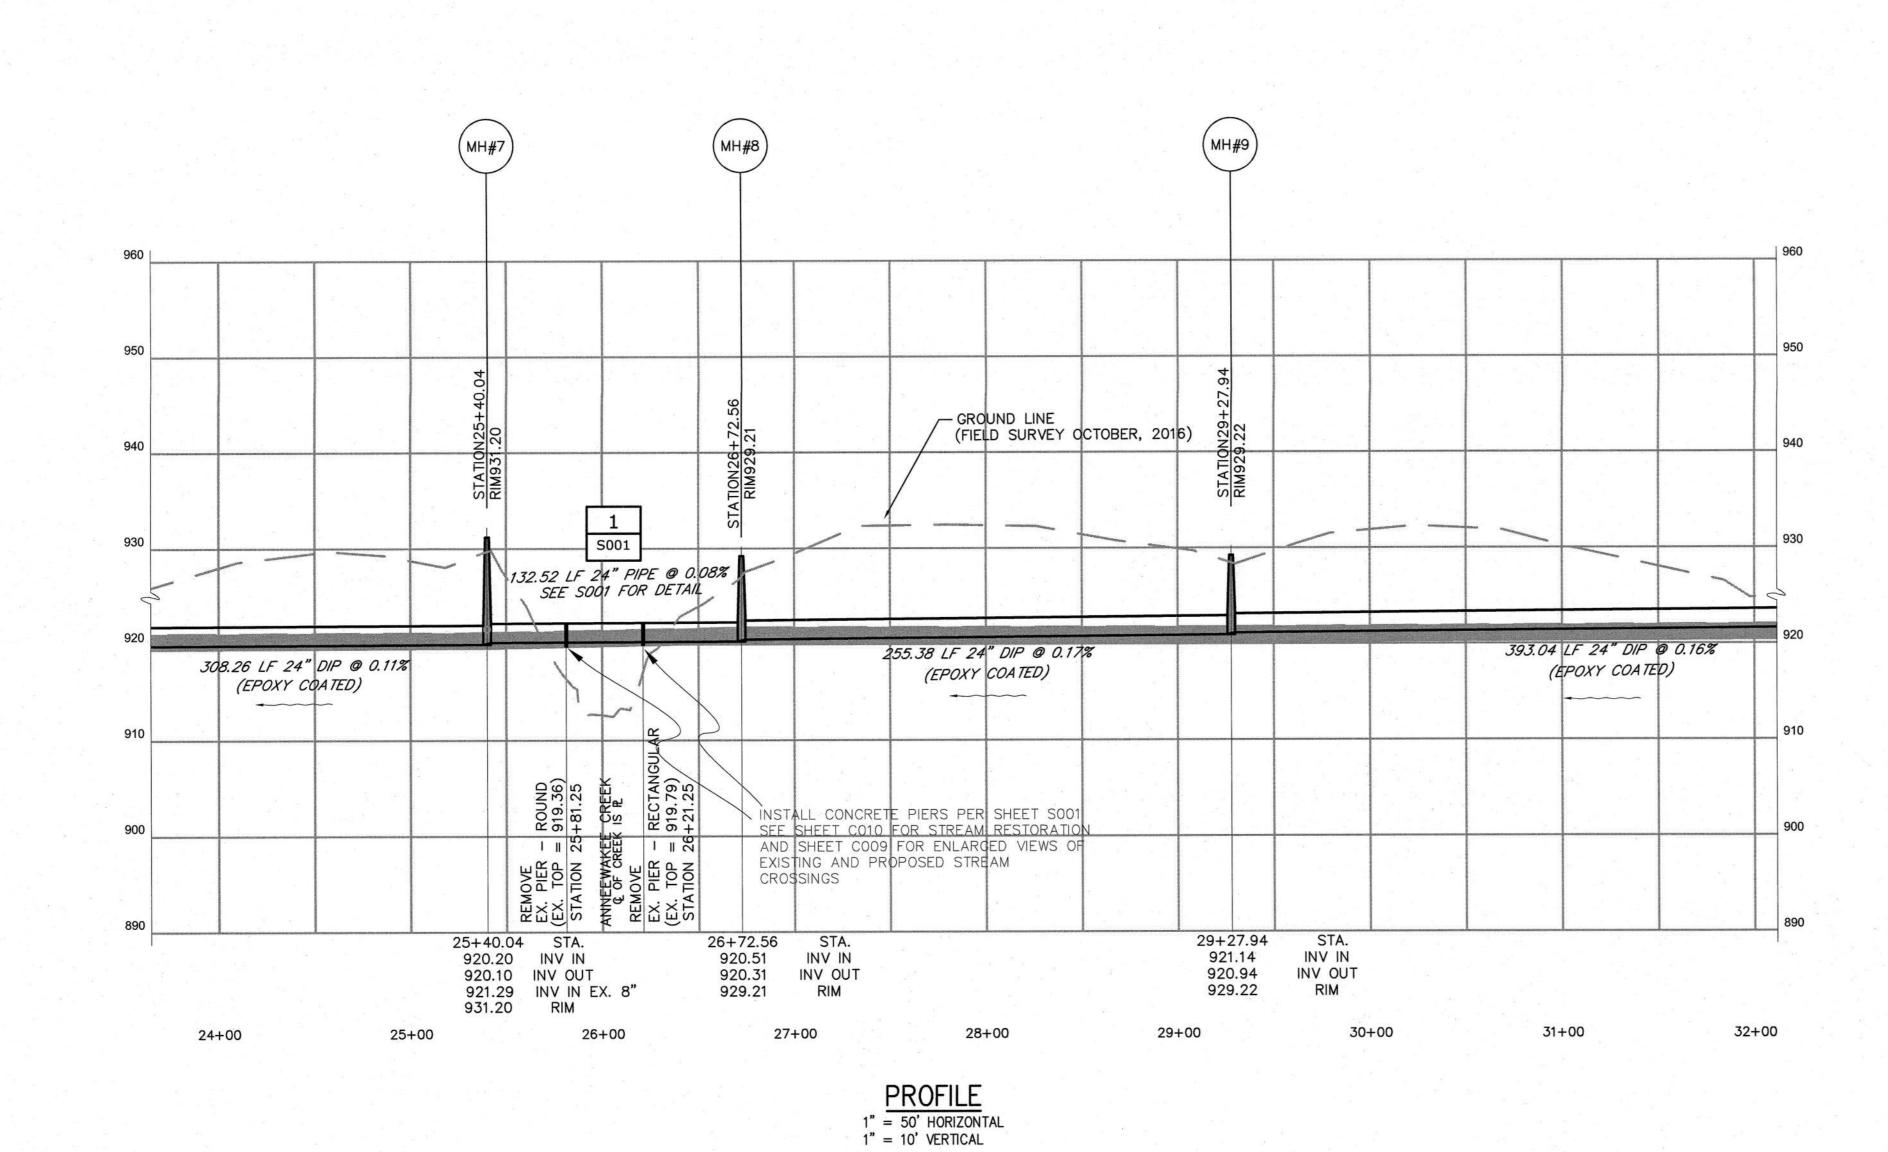

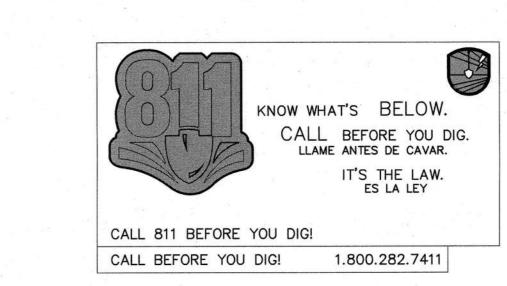

				PROJECT ENGINEER:	D. EHRHARDT
				DESIGNED BY:	B. MOSS
				DRAWN BY:	J. JORDAN
				CHECKED BY:	D. EHEHARDT
			***	IF THIS BAR DOES NOT MEASURE 1" THEN DRAWING	0 1/2" 1"
REV	ISSUED FOR	DATE	BY	IS NOT TO FULL SCALE	



100% SUBMITTAL

HAZEN AND SAWYER
5775 PEACHTREE DUNWOODY ROAD,
SUITE D-520
ATLANTA, GA 30342

DOUGLASVILLE-DOUGLAS COUNTY WATER AND SEWER AUTHORITY

STEWART MILL ROAD SANITARY SEWER
REPLACEMENT PROJECT



OUTFALL SEWER
CIVIL
PLAN & PROFILE STA
24+00 TO STA 31+00


DATE: MAY 2019


HAZEN NO.: 31247-010

CONTRACT NO.: 22B4413-02

DRAWING NUMBER:



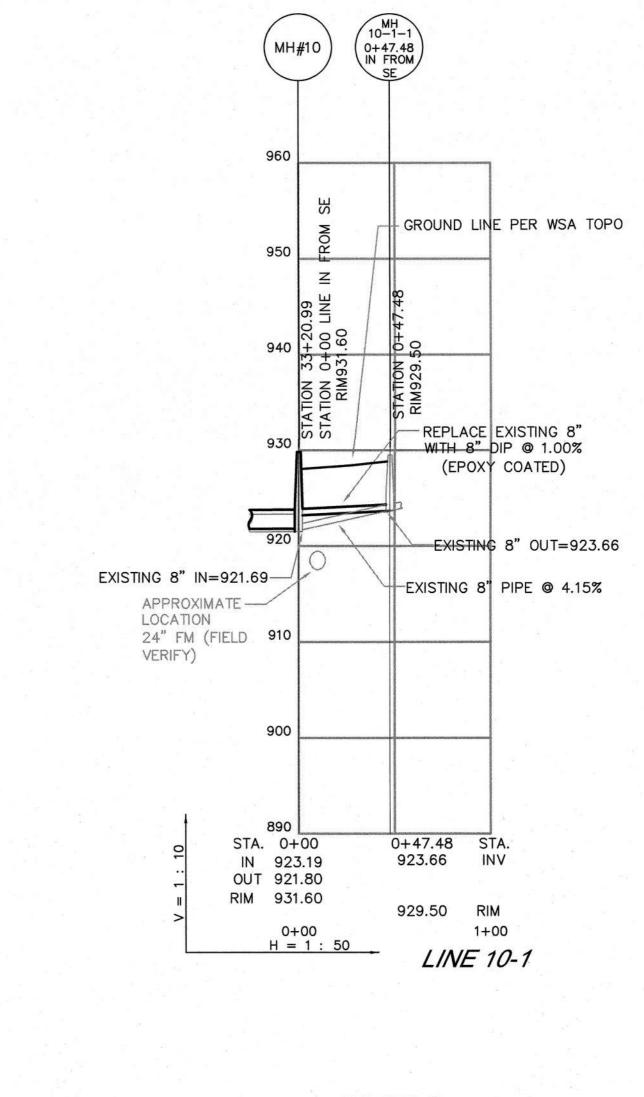

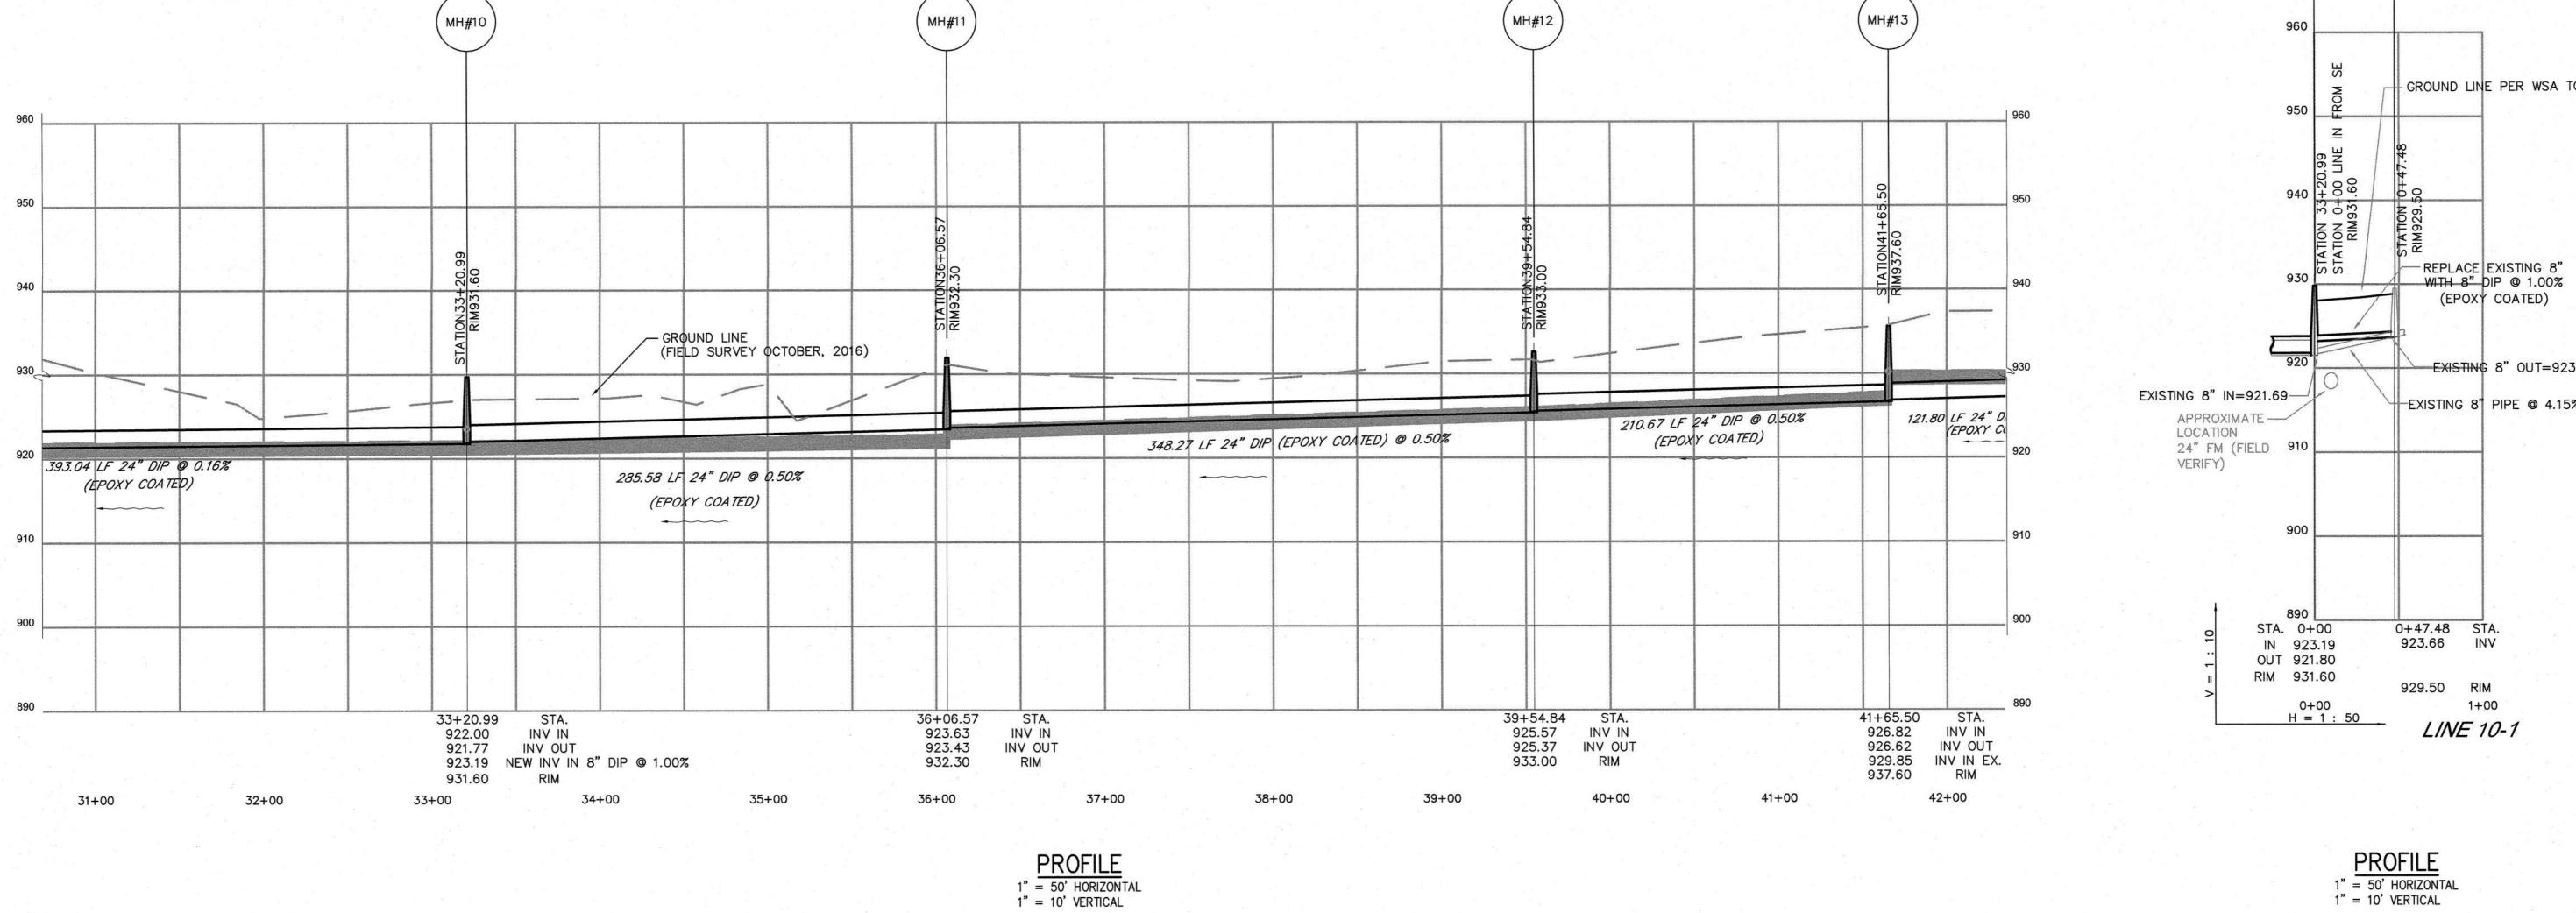

PROJECT ENGINEER: D. EHRHARDT B. MOSS DESIGNED BY: J. JORDAN DRAWN BY: D. EHRHARDT CHECKED BY: IF THIS BAR DOES NOT MEASURE 1" THEN DRAWING IS NOT TO FULL SCALE 0 1/2" 1"

ISSUED FOR

100% SUBMITTAL

Hazen HAZEN AND SAWYER
5775 PEACHTREE DUNWOODY ROAD, SUITE D-520 ATLANTA, GA 30342


DOUGLASVILLE-DOUGLAS COUNTY WATER AND SEWER AUTHORITY

STEWART MILL ROAD SANITARY SEWER REPLACEMENT PROJECT



OUTFALL SEWER CIVIL PLAN & PROFILE STA 31+00 TO STA 42+00


MAY 2019 31247-010 HAZEN NO .: CONTRACT NO.: 22B4413-02 DRAWING NUMBER:

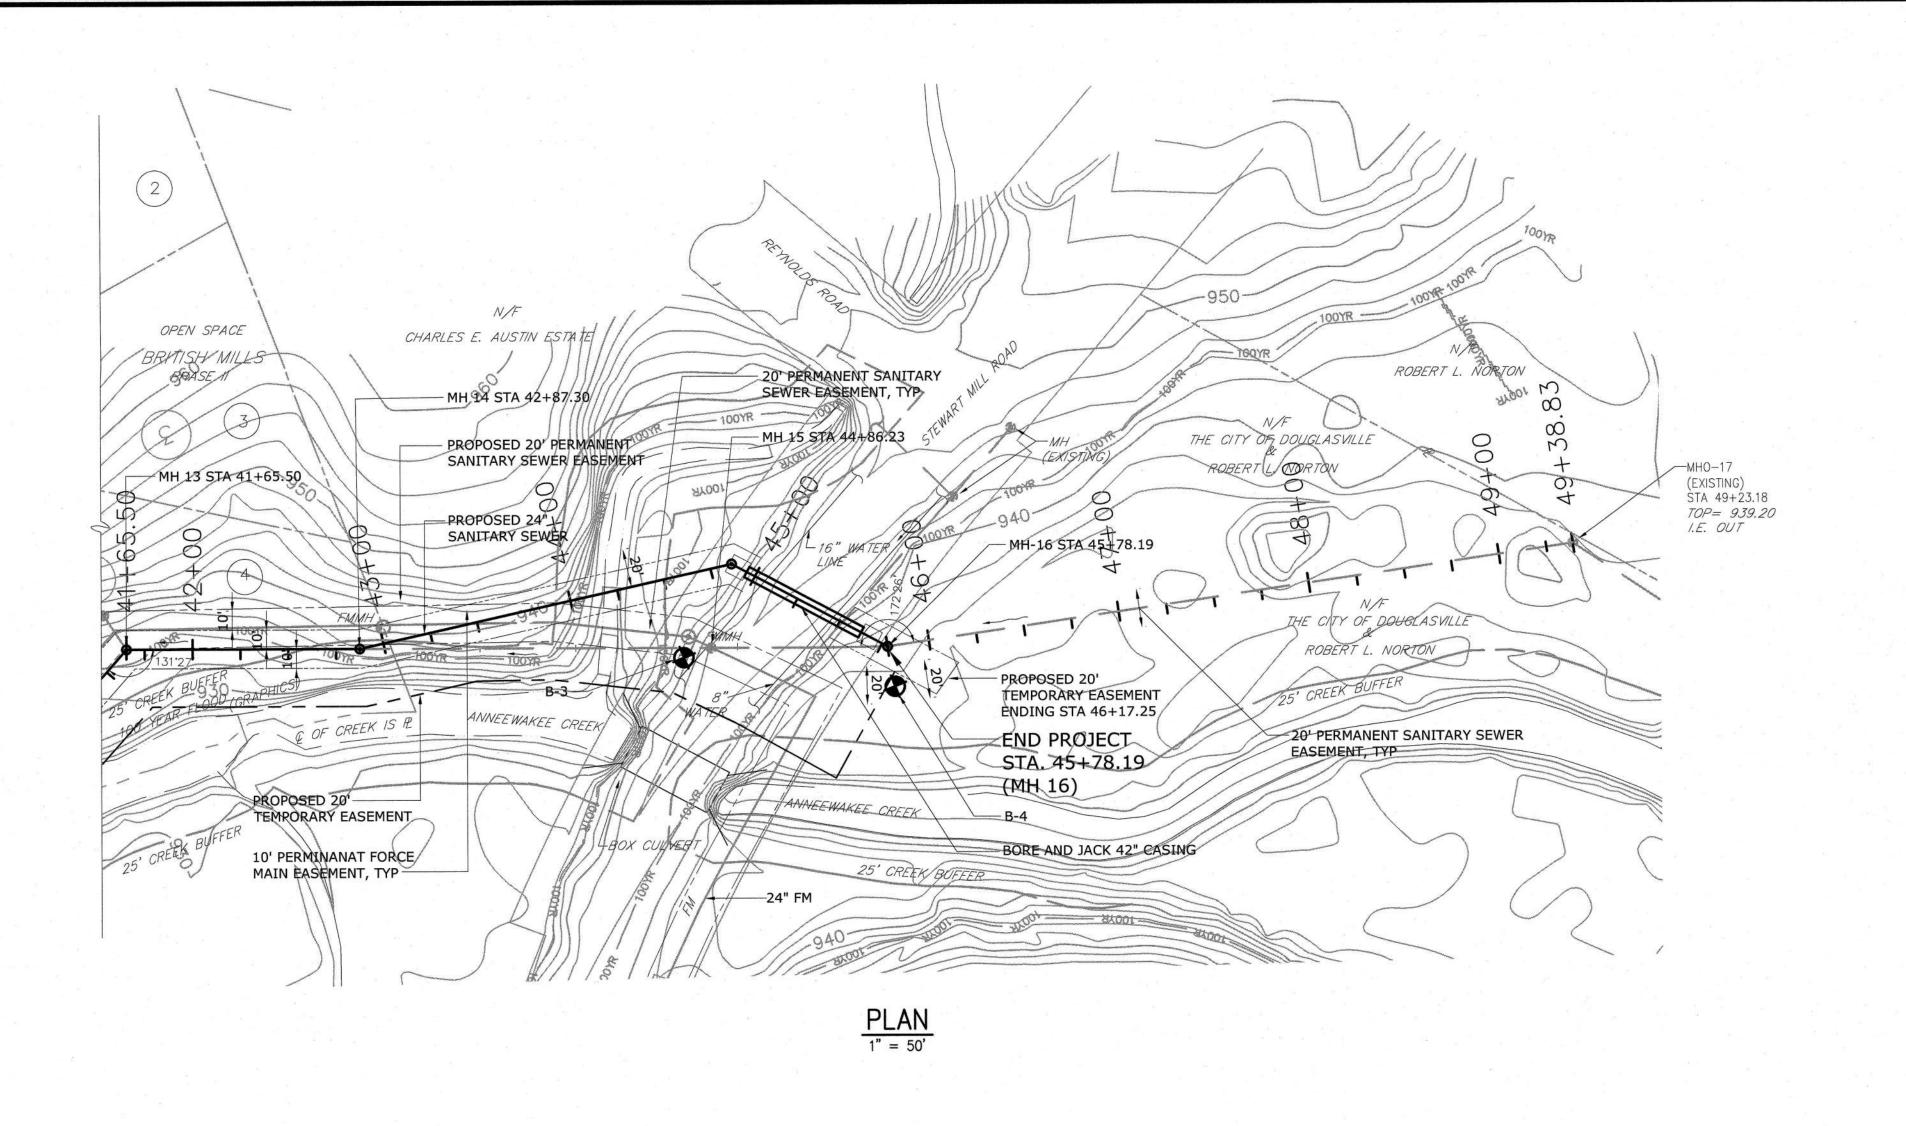


- THE CONTRACTOR SHALL BE RESPONSIBLE FOR PROTECTION OF THE 24" FORCE MAIN THROUGHOUT THE LENGTH OF THE PROJECT AND ANY PENALTIES IMPOSED DUE TO DAMAGE TO FM
- BY CONTRACTOR DURING THE PROJECT. LOCATION OF EXISTING 24" FM IS BASED ON DRAWINGS FROM FILES OF DDCWSA AND FIELD LOCATE OF AIR RELIEF VALVE MANHOLES. COORDINATION SHOULD NOT RELY ON THE FM

LOCATIONS INDICATED ON PLANS.

- 3. CONTRACTOR SHALL ACCURATELY LOCATE AND FLAG FORCE MAIN LOCATION AT BEGINNING OF CONSTRUCTION. IF FLAGGING IS DISTURBED DURING CONSTRUCTION, CONTRACTOR SHALL IMMEDIATELY REPLACE.
- 4. ALL CONSTRUCTION, INGRESS-EGRESS AND STAGING AREAS SHALL BE WITHIN EXISTING WSA EASEMENTS. PRIOR TO ANY CONSTRUCTION ACTIVITY, THE CONTRACTOR SHALL COORDINATE ALL POINTS OF ENTRY WITH THE WSA INSPECTOR. ONCE POINTS OF ENTRY HAVE BEEN ESTABLISHED, THE CONTRACTOR SHALL STAKE ALL EASEMENTS REQUIRED TO COMPLETE THE PROJECT.
- 5. PROPOSED MH TOP ELEVATIONS ARE APPROXIMATE. FINAL ADJUSTED GRADE SHALL BE DETERMINED BY BY FINISH GRADE AND TYPE SURFACE (PAVEMENT OR LANDSCAPE) OR AS DIRECTED BY THE WSA INSPECTOR.
- 6. ALL EROSION AND SEDIMENTATION CONTROLS SHALL BE INSTALLED AT THE BEGINNING OF CONSTRUCTION.
- CONTRACTOR SHALL PLACE STONE IN ACCORDANCE TO DETAIL 0222102 AND SPECIFICATIONS TO SET PROPOSED PIPE INVERT AS REQUIRED.
- 8. REPLACE EXISTING MANHOLES 2 THROUGH 16.

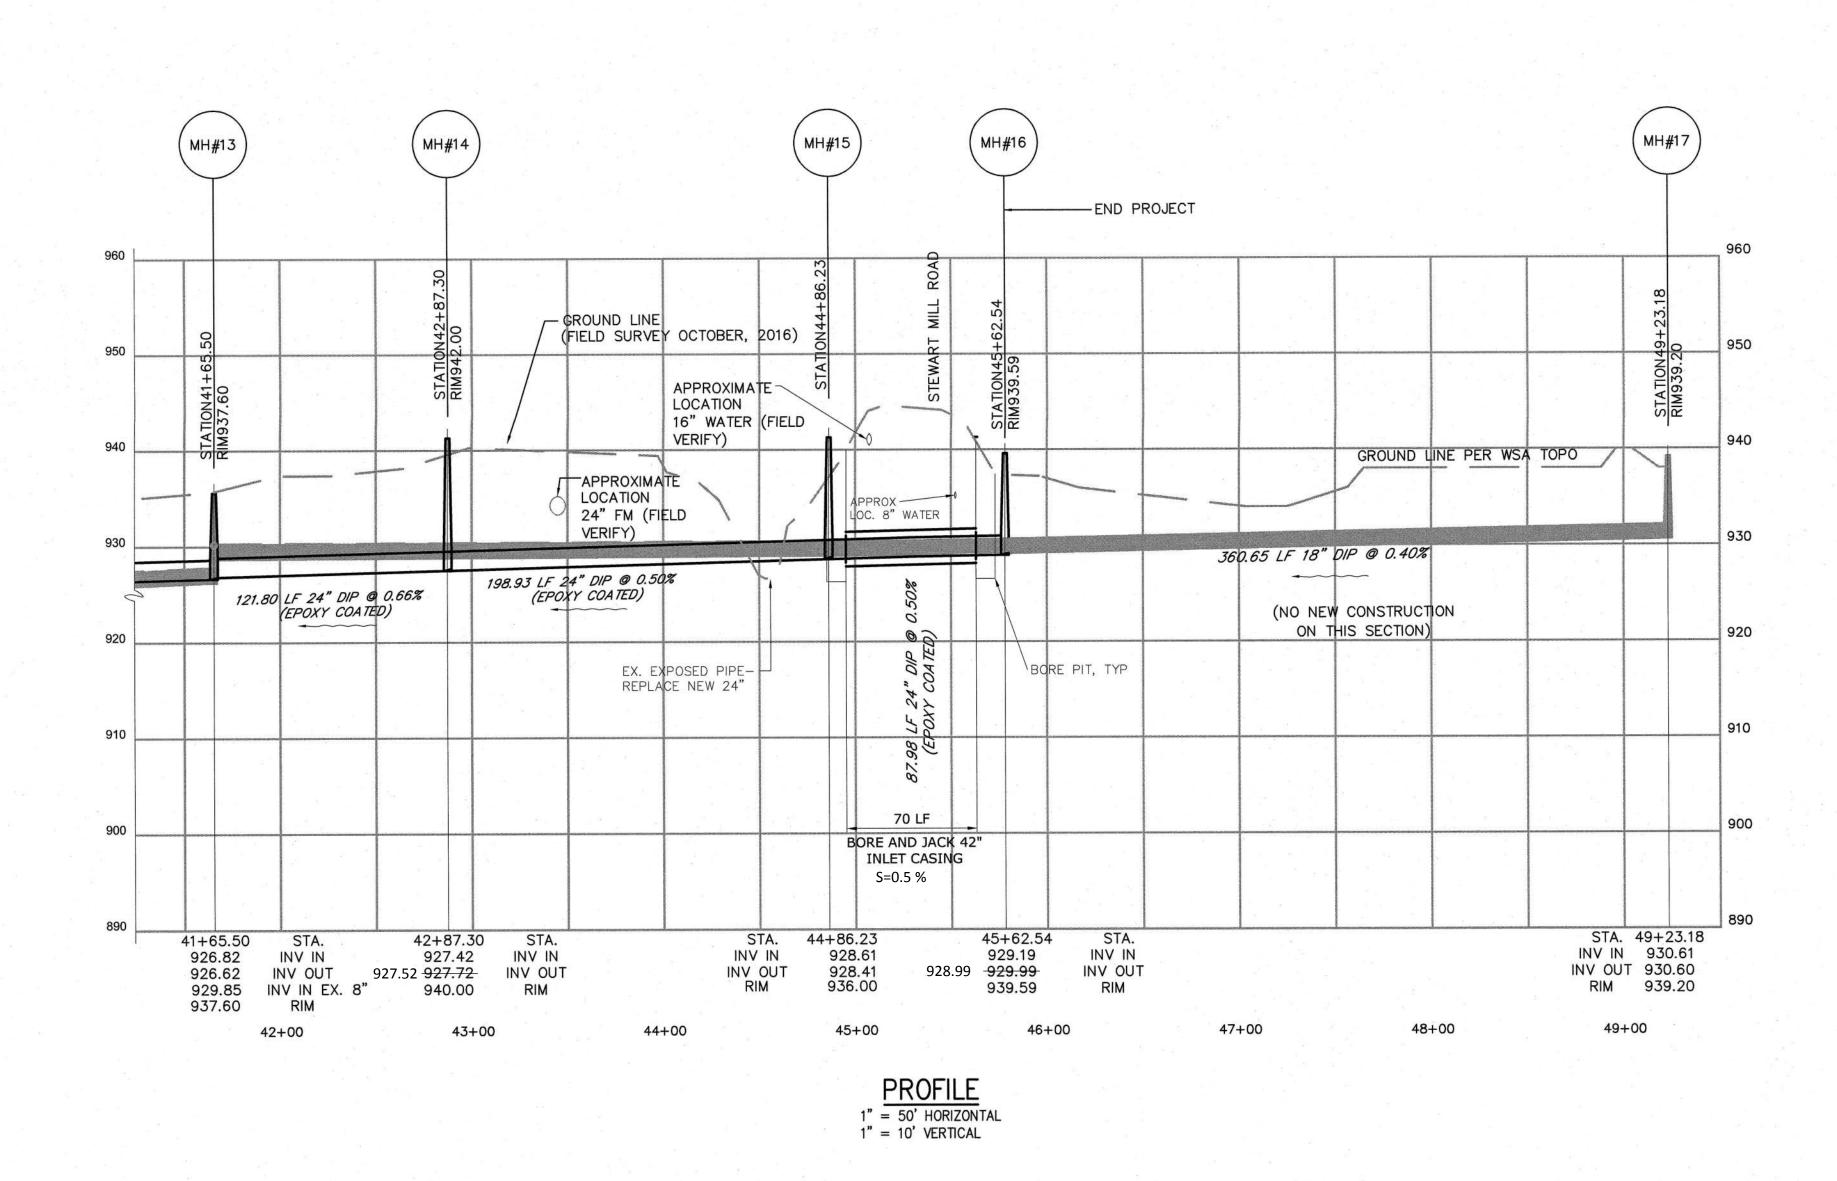

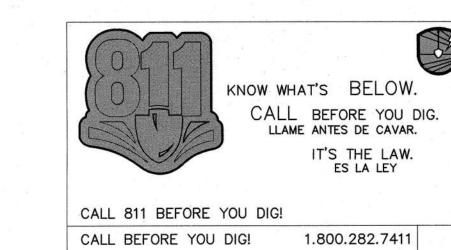

			1	The state of the s	1000000
				PROJECT ENGINEER:	D. EHRHARDT
				DESIGNED BY:	B. MOSS
				DRAWN BY:	J. JORDAN
	*			CHECKED BY:	D. EHRHARDT
				IF THIS BAR DOES NOT MEASURE 1" THEN DRAW!	ING 0 1/2" 1"
REV	ISSUED FOR	DATE	BY	IS NOT TO FULL SCALE	



100% SUBMITTAL

Hazen HAZEN AND SAWYER 5775 PEACHTREE DUNWOODY ROAD, SUITE D-520 ATLANTA, GA 30342


DOUGLASVILLE-DOUGLAS COUNTY WATER AND SEWER AUTHORITY


STEWART MILL ROAD SANITARY SEWER REPLACEMENT PROJECT



OUTFALL SEWER CIVIL PLAN & PROFILE STA 42+00 TO STA 49+23.18

MAY 2019 31247-010 HAZEN NO.: CONTRACT NO.: 22B4413-02 DRAWING NUMBER:

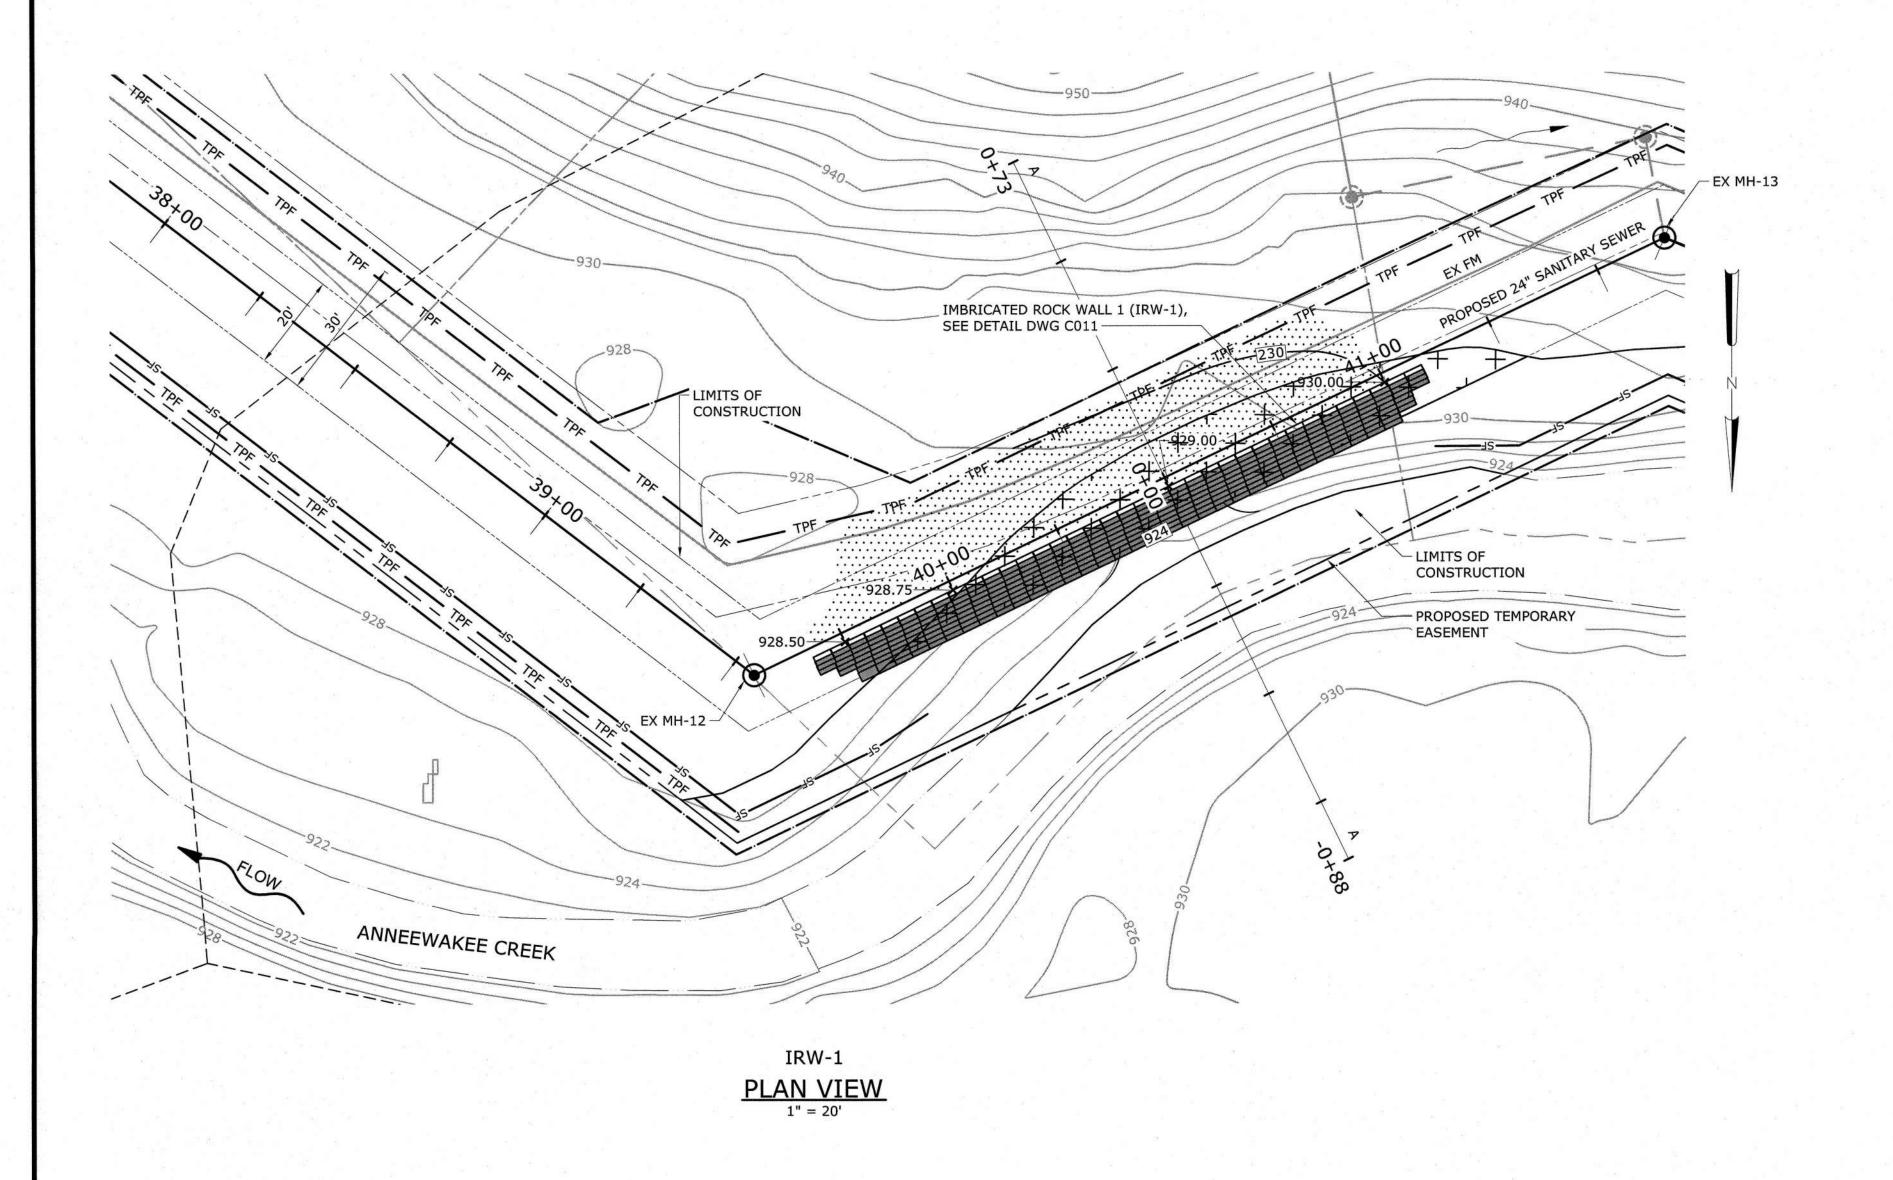


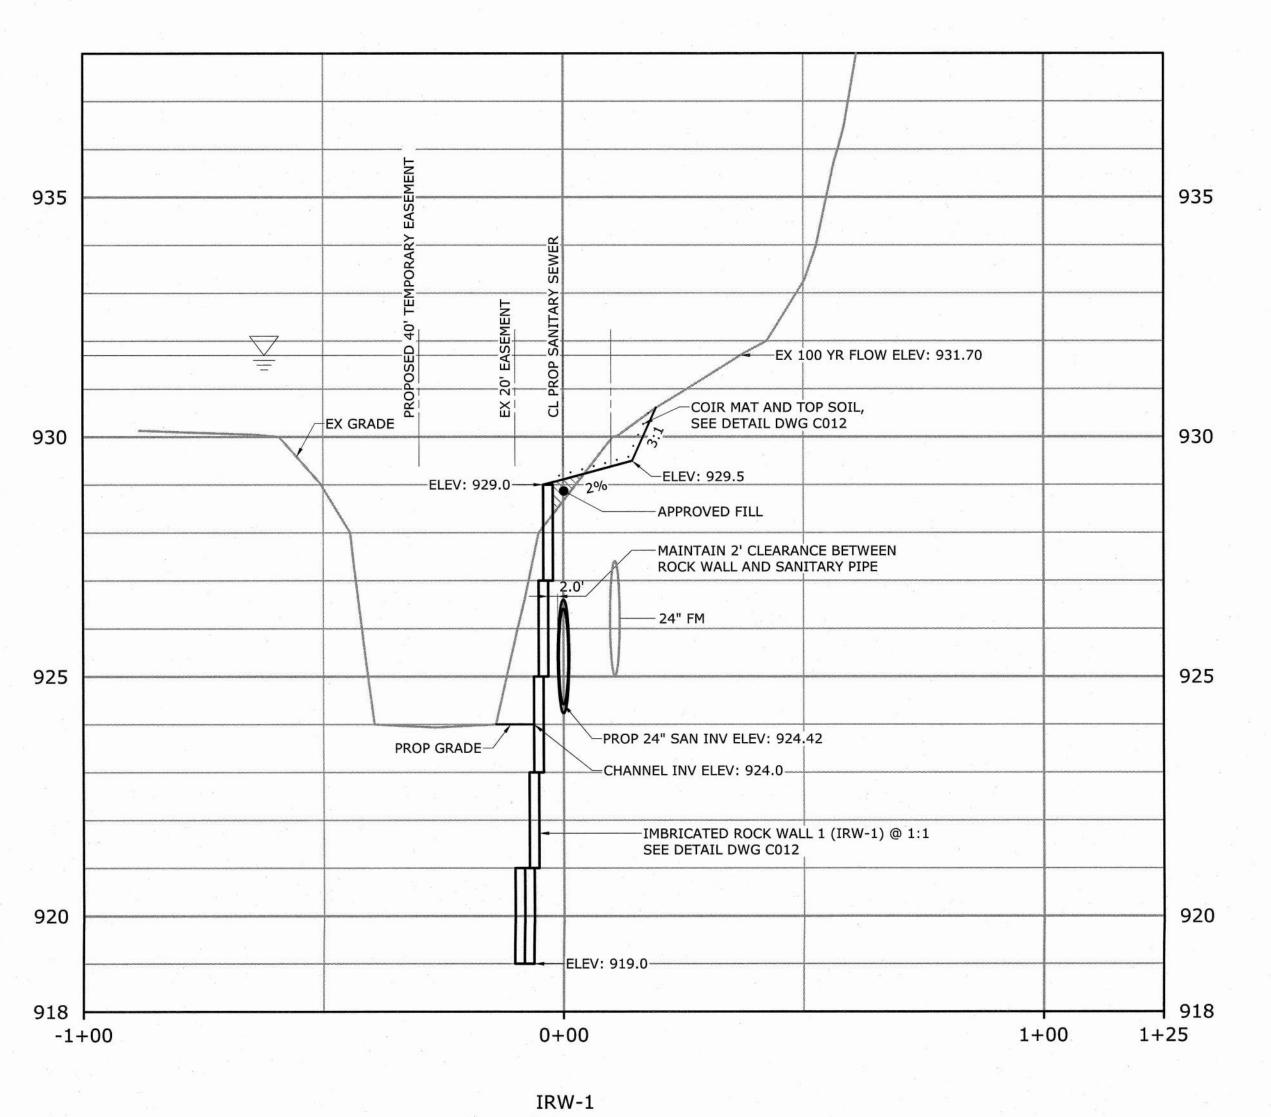

SECTION A-A
STA 40+50

LOOKING DOWNSTREAM

SECTION VIEW
HORZ: 1" = 20' - VERT: 1" = 2'

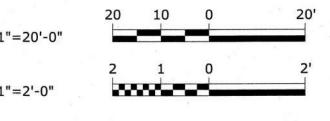

NOTES:

 CONTRACTOR TO SEED COIR MAT/TOP SOIL AREAS WITH A COMBINATION OF TEMPORARY GRASS (Ds2 AND STRAW, SEE SHEET CO21), AND PERMANENT RIPARIAN SEED MIX. THE PERMANENT MIX IS TO BE ERNST MIX ERNMX-501 (GEORGIA BLUE RIDGE

MANUFACTURE'S SPECIFICATIONS. ALL REMAINING

RIPARIAN MIX) OR EQUAL, 20#/AC PER

DISTURBED AREAS SHALL BE PERMANENTLY SEEDED WITH Ds3 MIX PER SHEET C021.

 STREAM DETAIL AND EROSION, SEDIMENTATION AND POLLUTION CONTROL PLANS TO SAFELY PROTECT COVER AND SLOPES ADJACENT TO IRW

 THE CONTRACTOR SHALL BE RESPONSIBLE FOR PROTECTION OF THE 24" FORCE MAIN

BY CONTRACTOR DURING THE PROJECT.

LOCATIONS INDICATED ON PLANS.

IMMEDIATELY REPLACE.

 LOCATION OF EXISTING 24" FM IS BASED ON DRAWINGS FROM FILES OF DDCWSA AND FIELD LOCATE OF AIR RELIEF VALVE MANHOLES. COORDINATION SHOULD NOT RELY ON THE FM

 CONTRACTOR SHALL ACCURATELY LOCATE AND FLAG FORCE MAIN LOCATION AT BEGINNING OF CONSTRUCTION. IF FLAGGING IS DISTURBED DURING CONSTRUCTION, CONTRACTOR SHALL

THROUGHOUT THE LENGTH OF THE PROJECT AND ANY PENALTIES IMPOSED DUE TO DAMAGE TO FM

PROJECT
ENGINEER:

D. EHRHARDT

DESIGNED BY:

T. SCHUELER

DRAWN BY:

S. KANE

CHECKED BY:

D. EHRHARDT

IF THIS BAR DOES NOT
MEASURE 1" THEN DRAWING
IS NOT TO FULL SCALE

ON TO FULL SCALE



100% SUBMITTAL

HAZEN AND SAWYER
5775 PEACHTREE DUNWOODY ROAD,
SUITE D-520
ATLANTA, GA 30342


DOUGLASVILLE-DOUGLAS COUNTY WATER AND SEWER AUTHORITY

STEWART MILL ROAD SANITARY SEWER
REPLACEMENT PROJECT




OUTFALL SEWER
CIVIL
STREAM RESTORATION DESIGN - IRW-1
PLAN & PROFILE

120	DATE:	MAY 201
	HAZEN NO.:	31247-01
	CONTRACT NO.	:22B4413-0
	DRAWING NUMBER:	

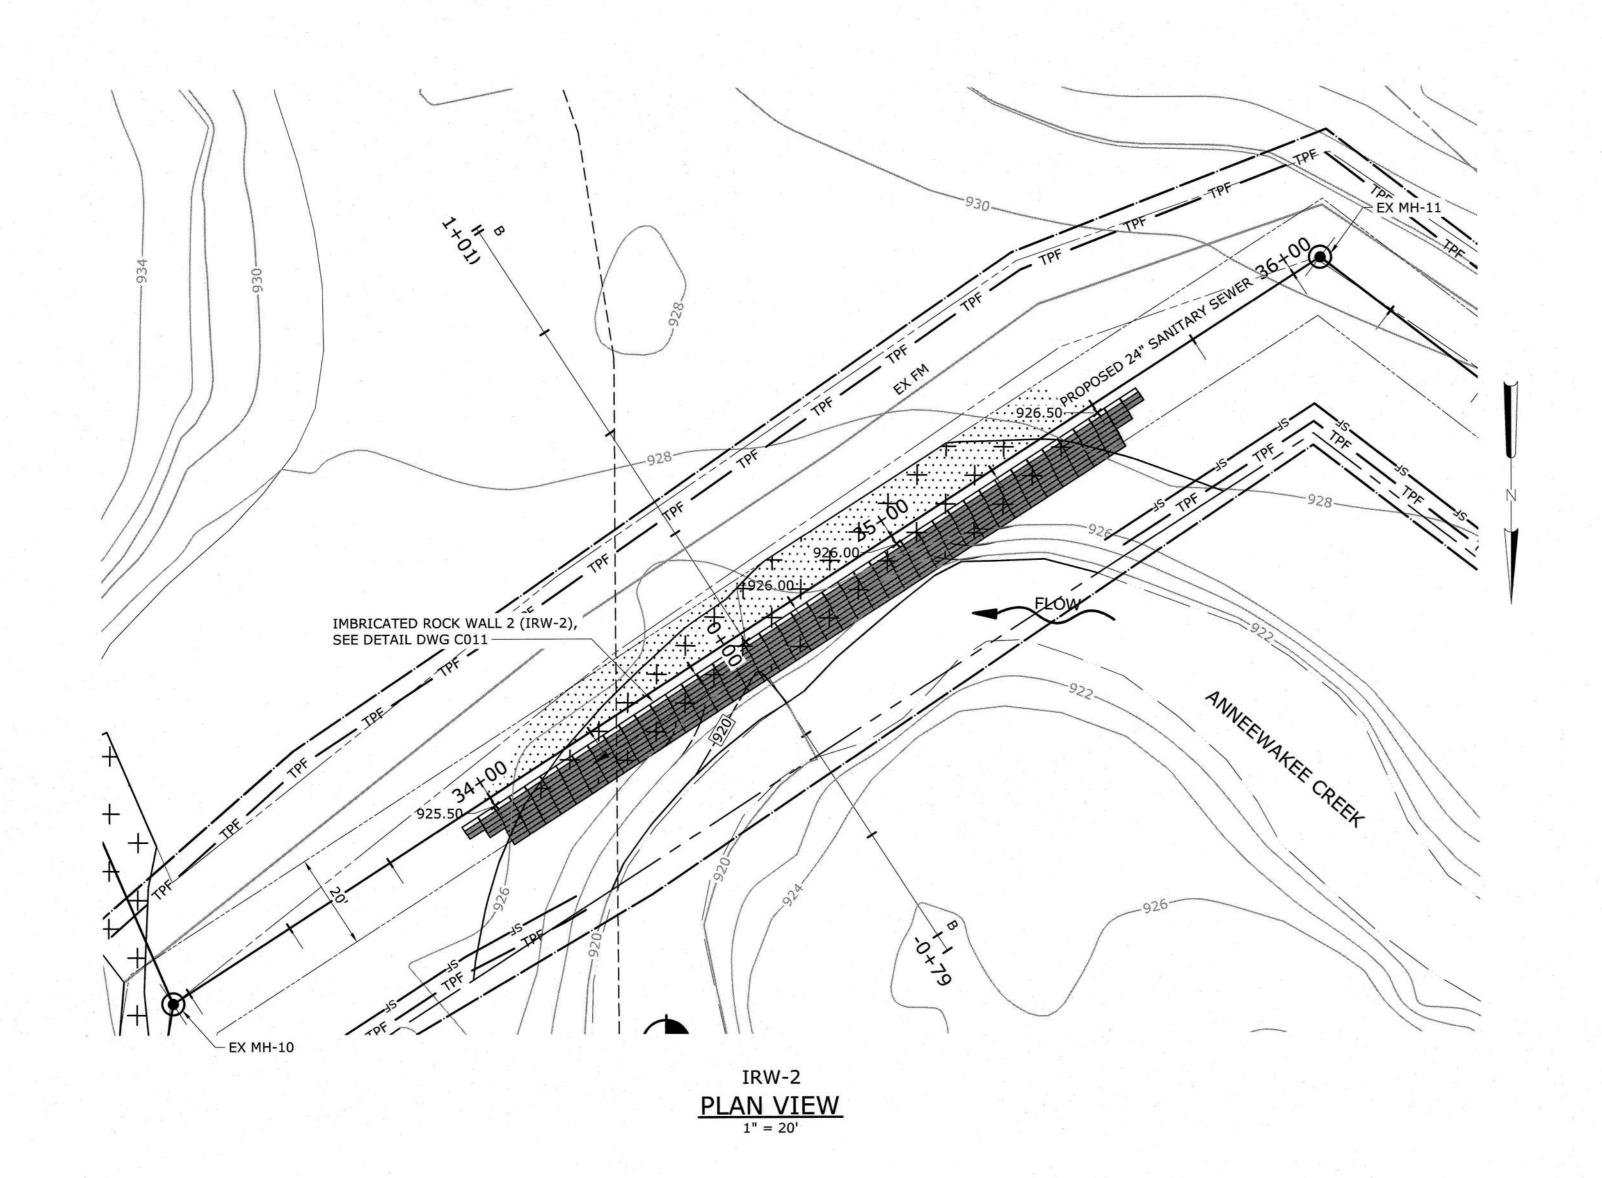

NOTES:

- 1. CONTRACTOR TO SEED COIR MAT/TOP SOIL AREAS WITH A COMBINATION OF TEMPORARY GRASS (Ds2 AND STRAW, SEE SHEET CO21), AND PERMANENT RIPARIAN SEED MIX. THE PERMANENT MIX IS TO BE ERNST MIX ERNMX-501 (GEORGIA BLUE RIDGE RIPARIAN MIX) OR EQUAL, 20#/AC PER MANUFACTURE'S SPECIFICATIONS. ALL REMAINING DISTURBED AREAS SHALL BE PERMANENTLY SEEDED WITH Ds3 MIX PER SHEET CO21.
- 2. STREAM DETAIL AND EROSION, SEDIMENTATION AND POLLUTION CONTROL PLANS TO SAFELY PROTECT COVER AND SLOPES ADJACENT TO IRW
- 3. THE CONTRACTOR SHALL BE RESPONSIBLE FOR PROTECTION OF THE 24" FORCE MAIN THROUGHOUT THE LENGTH OF THE PROJECT AND ANY PENALTIES IMPOSED DUE TO DAMAGE TO FM BY CONTRACTOR DURING THE PROJECT.
- 4. LOCATION OF EXISTING 24" FM IS BASED ON DRAWINGS FROM FILES OF DDCWSA AND FIELD LOCATE OF AIR RELIEF VALVE MANHOLES. COORDINATION SHOULD NOT RELY ON THE FM LOCATIONS INDICATED ON PLANS.
- CONTRACTOR SHALL ACCURATELY LOCATE AND FLAG FORCE MAIN LOCATION AT BEGINNING OF CONSTRUCTION. IF FLAGGING IS DISTURBED DURING CONSTRUCTION, CONTRACTOR SHALL IMMEDIATELY REPLACE.

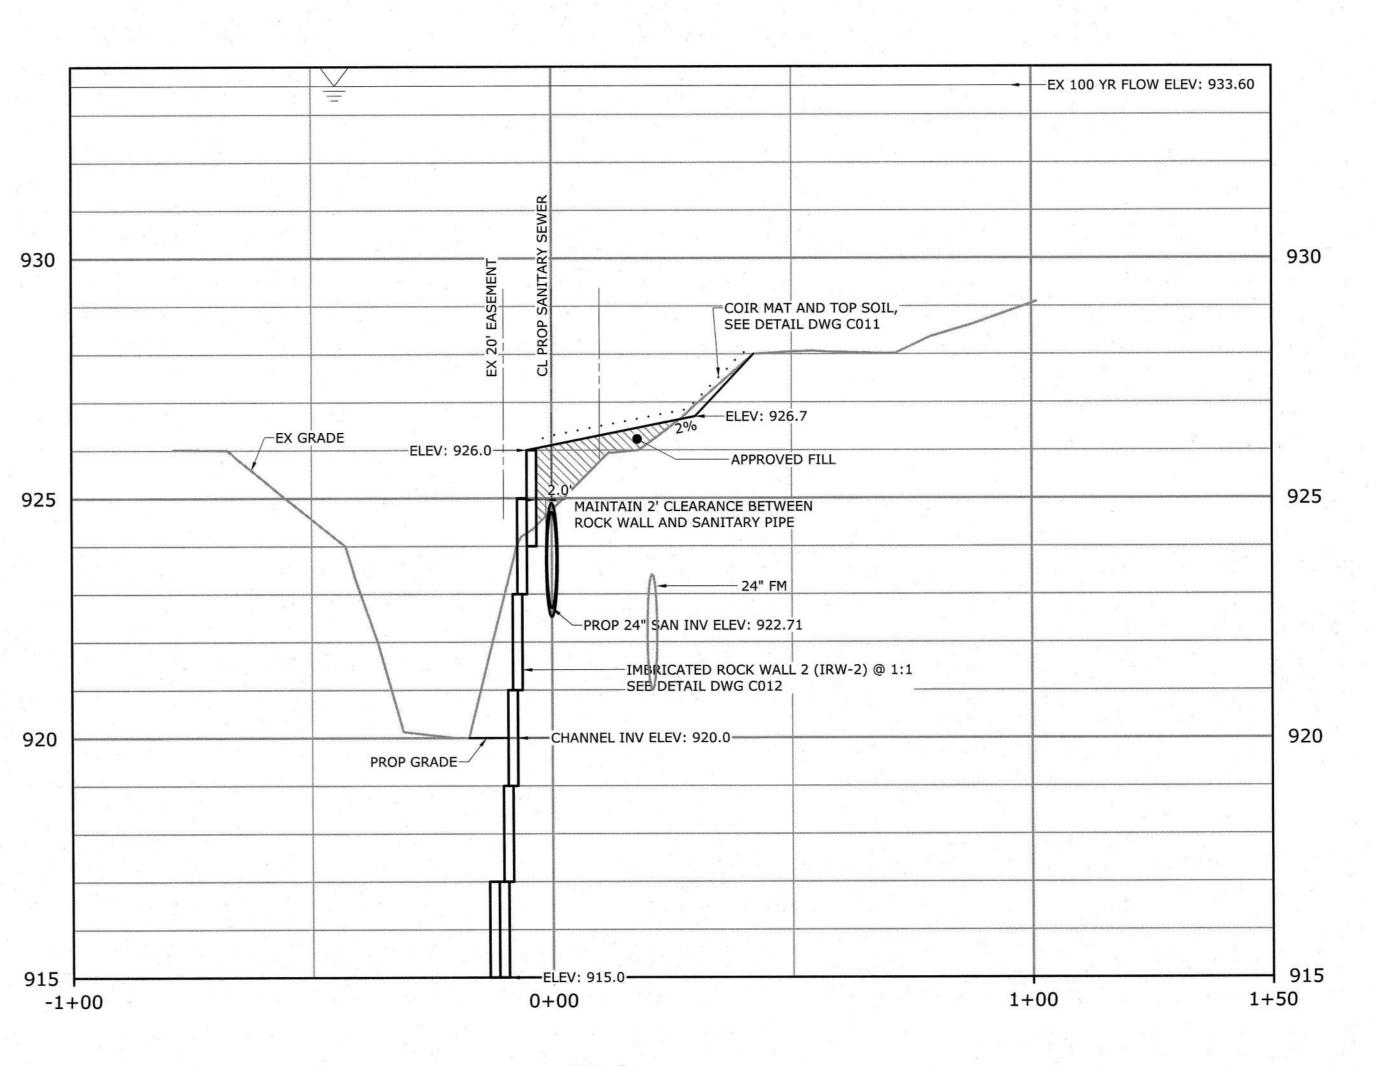

IRW-2 SECTION B-B STA 34+47

LOOKING DOWNSTREAM

SECTION VIEW
HORZ: 1" = 20' - VERT: 1" = 2'

C					
				PROJECT ENGINEER:	D. EHRHARDT
				DESIGNED BY:	T. SCHUELER
				DRAWN BY:	S. KANE
				CHECKED BY:	D. EHRHARDT
				IF THIS BAR DOES NOT MEASURE 1" THEN DRAWING	0 1/2" 1'
REV	ISSUED FOR	DATE	BY	IS NOT TO FULL SCALE	



100% SUBMITTAL




DOUGLASVILLE-DOUGLAS COUNTY WATER AND SEWER AUTHORITY


STEWART MILL ROAD SANITARY SEWER
REPLACEMENT PROJECT




OUTFALL SEWER
CIVIL
STREAM RESTORATION DESIGN - IRW-2
PLAN & PROFILE

DATE:	MAY 2019
HAZEN NO.:	31247-010
CONTRACT NO.	:22B4413-02
DRAWING NUMBER:	

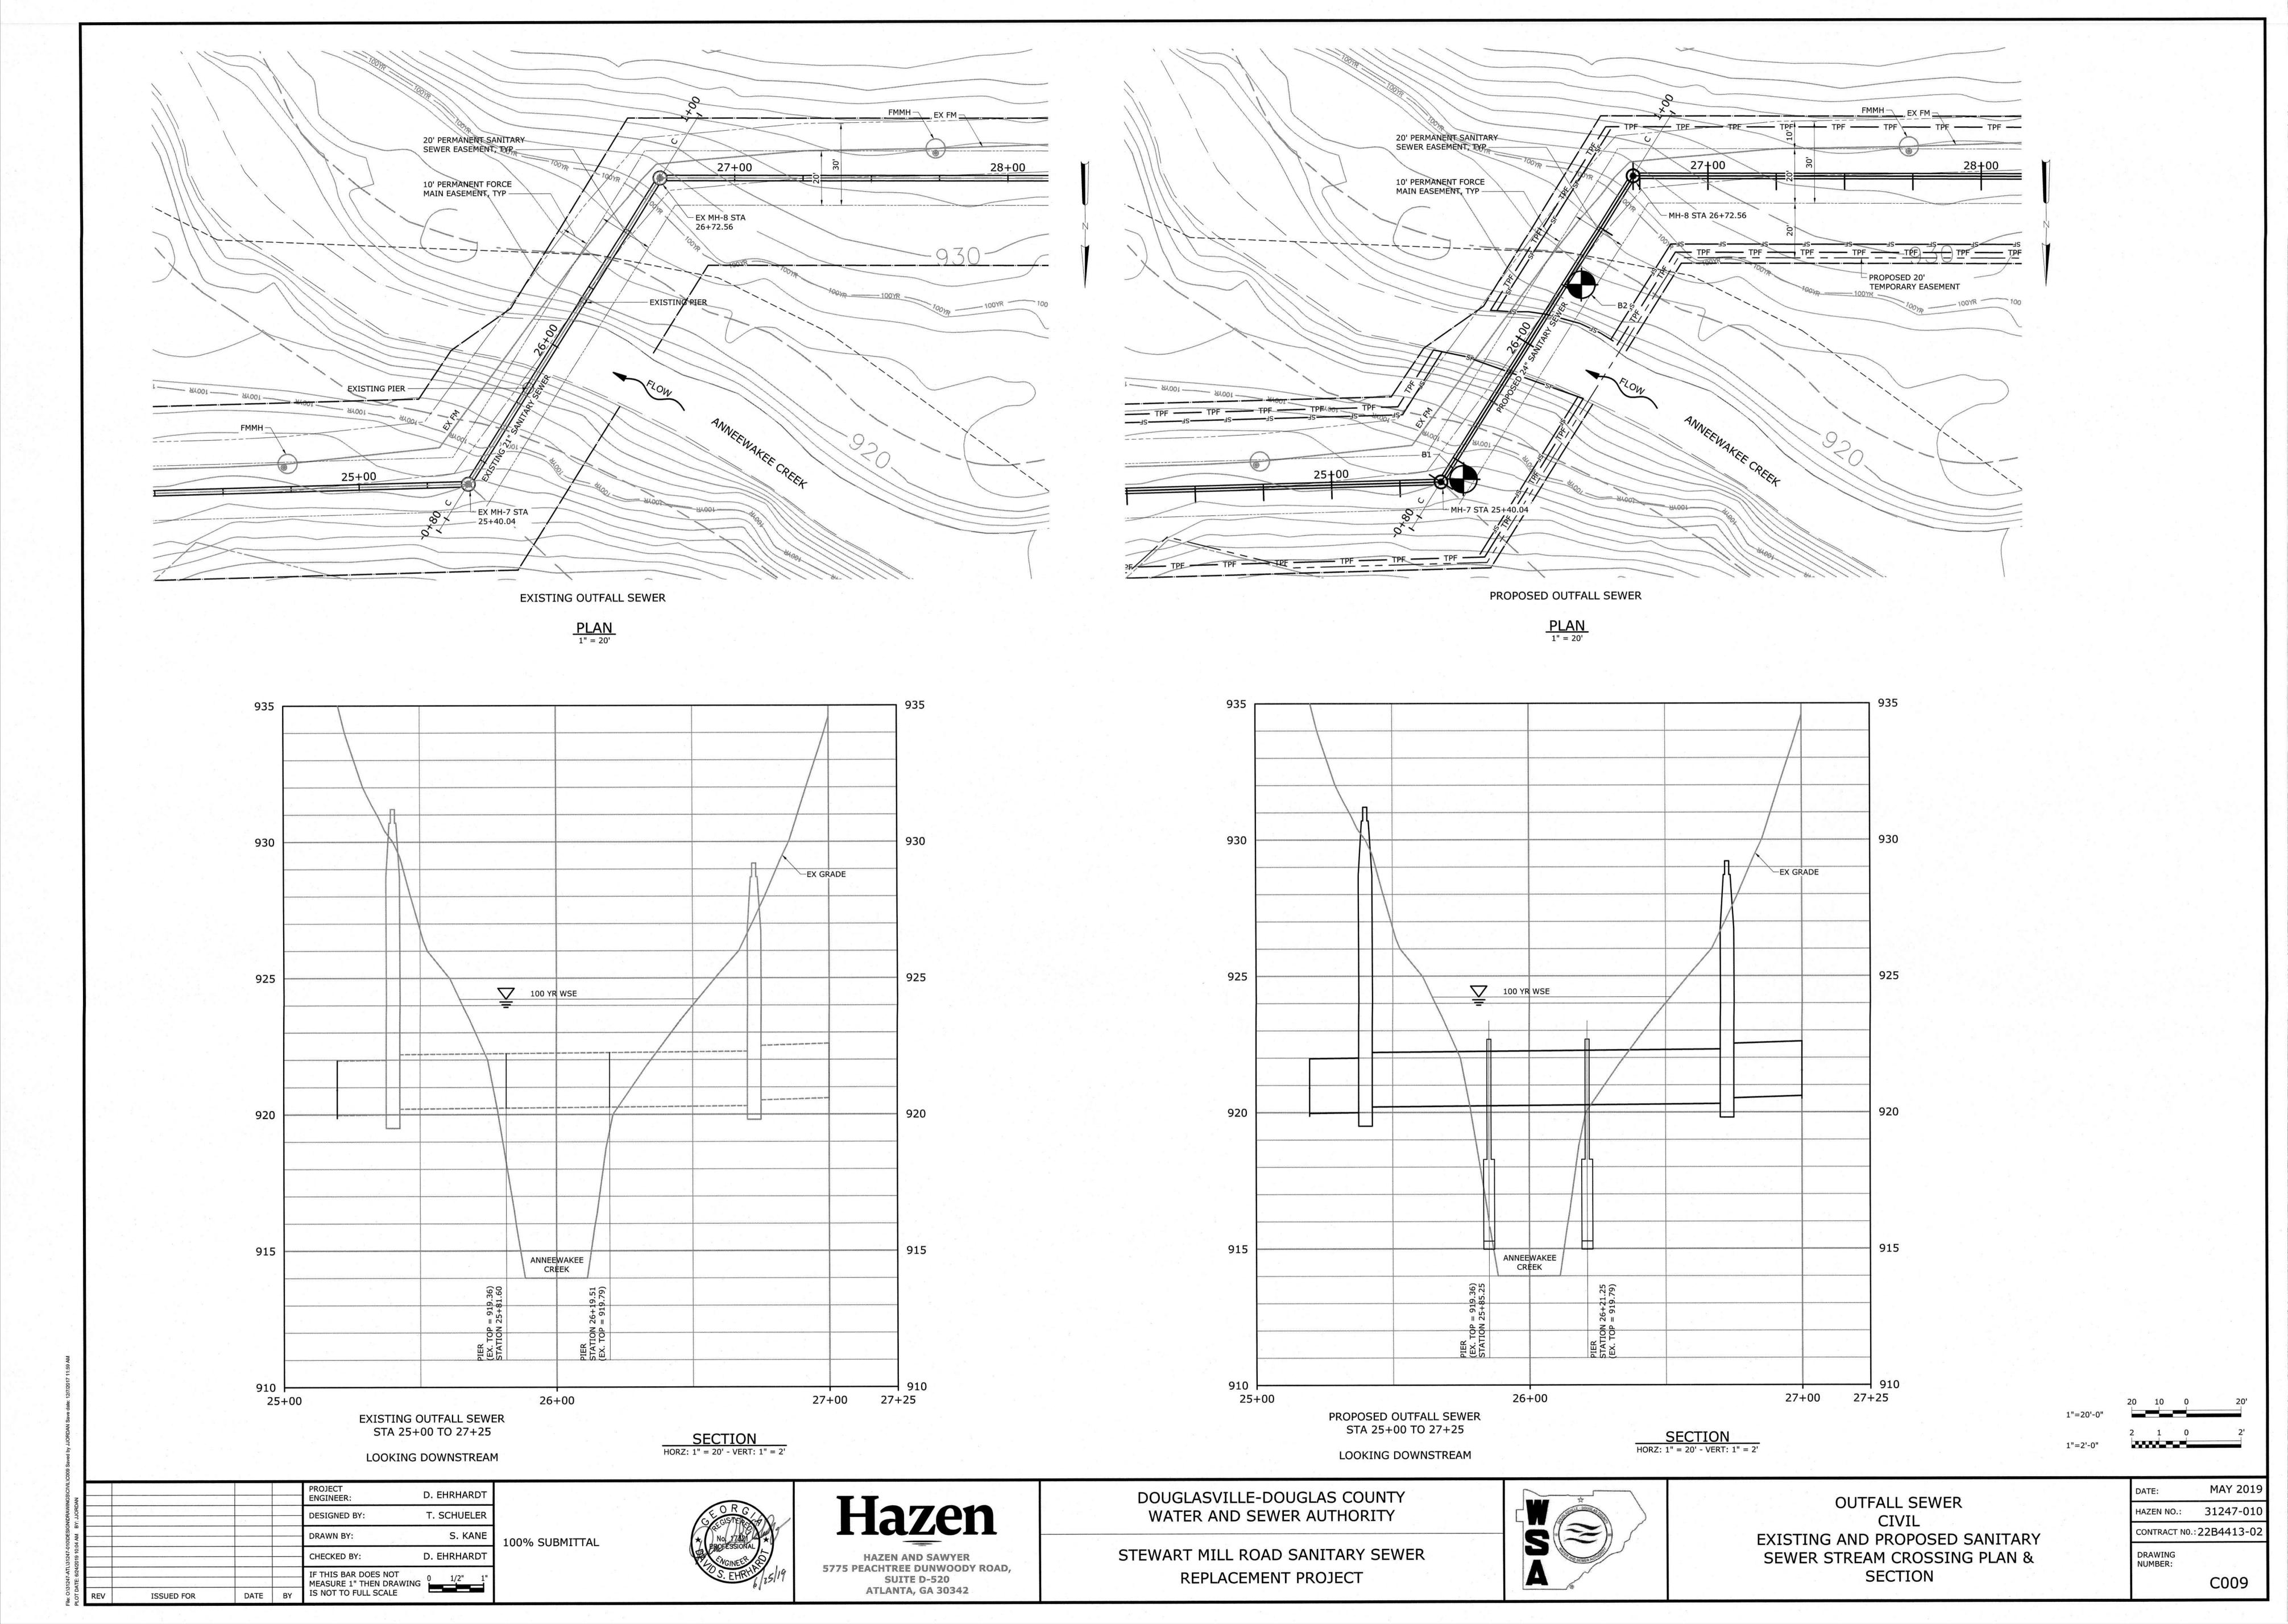

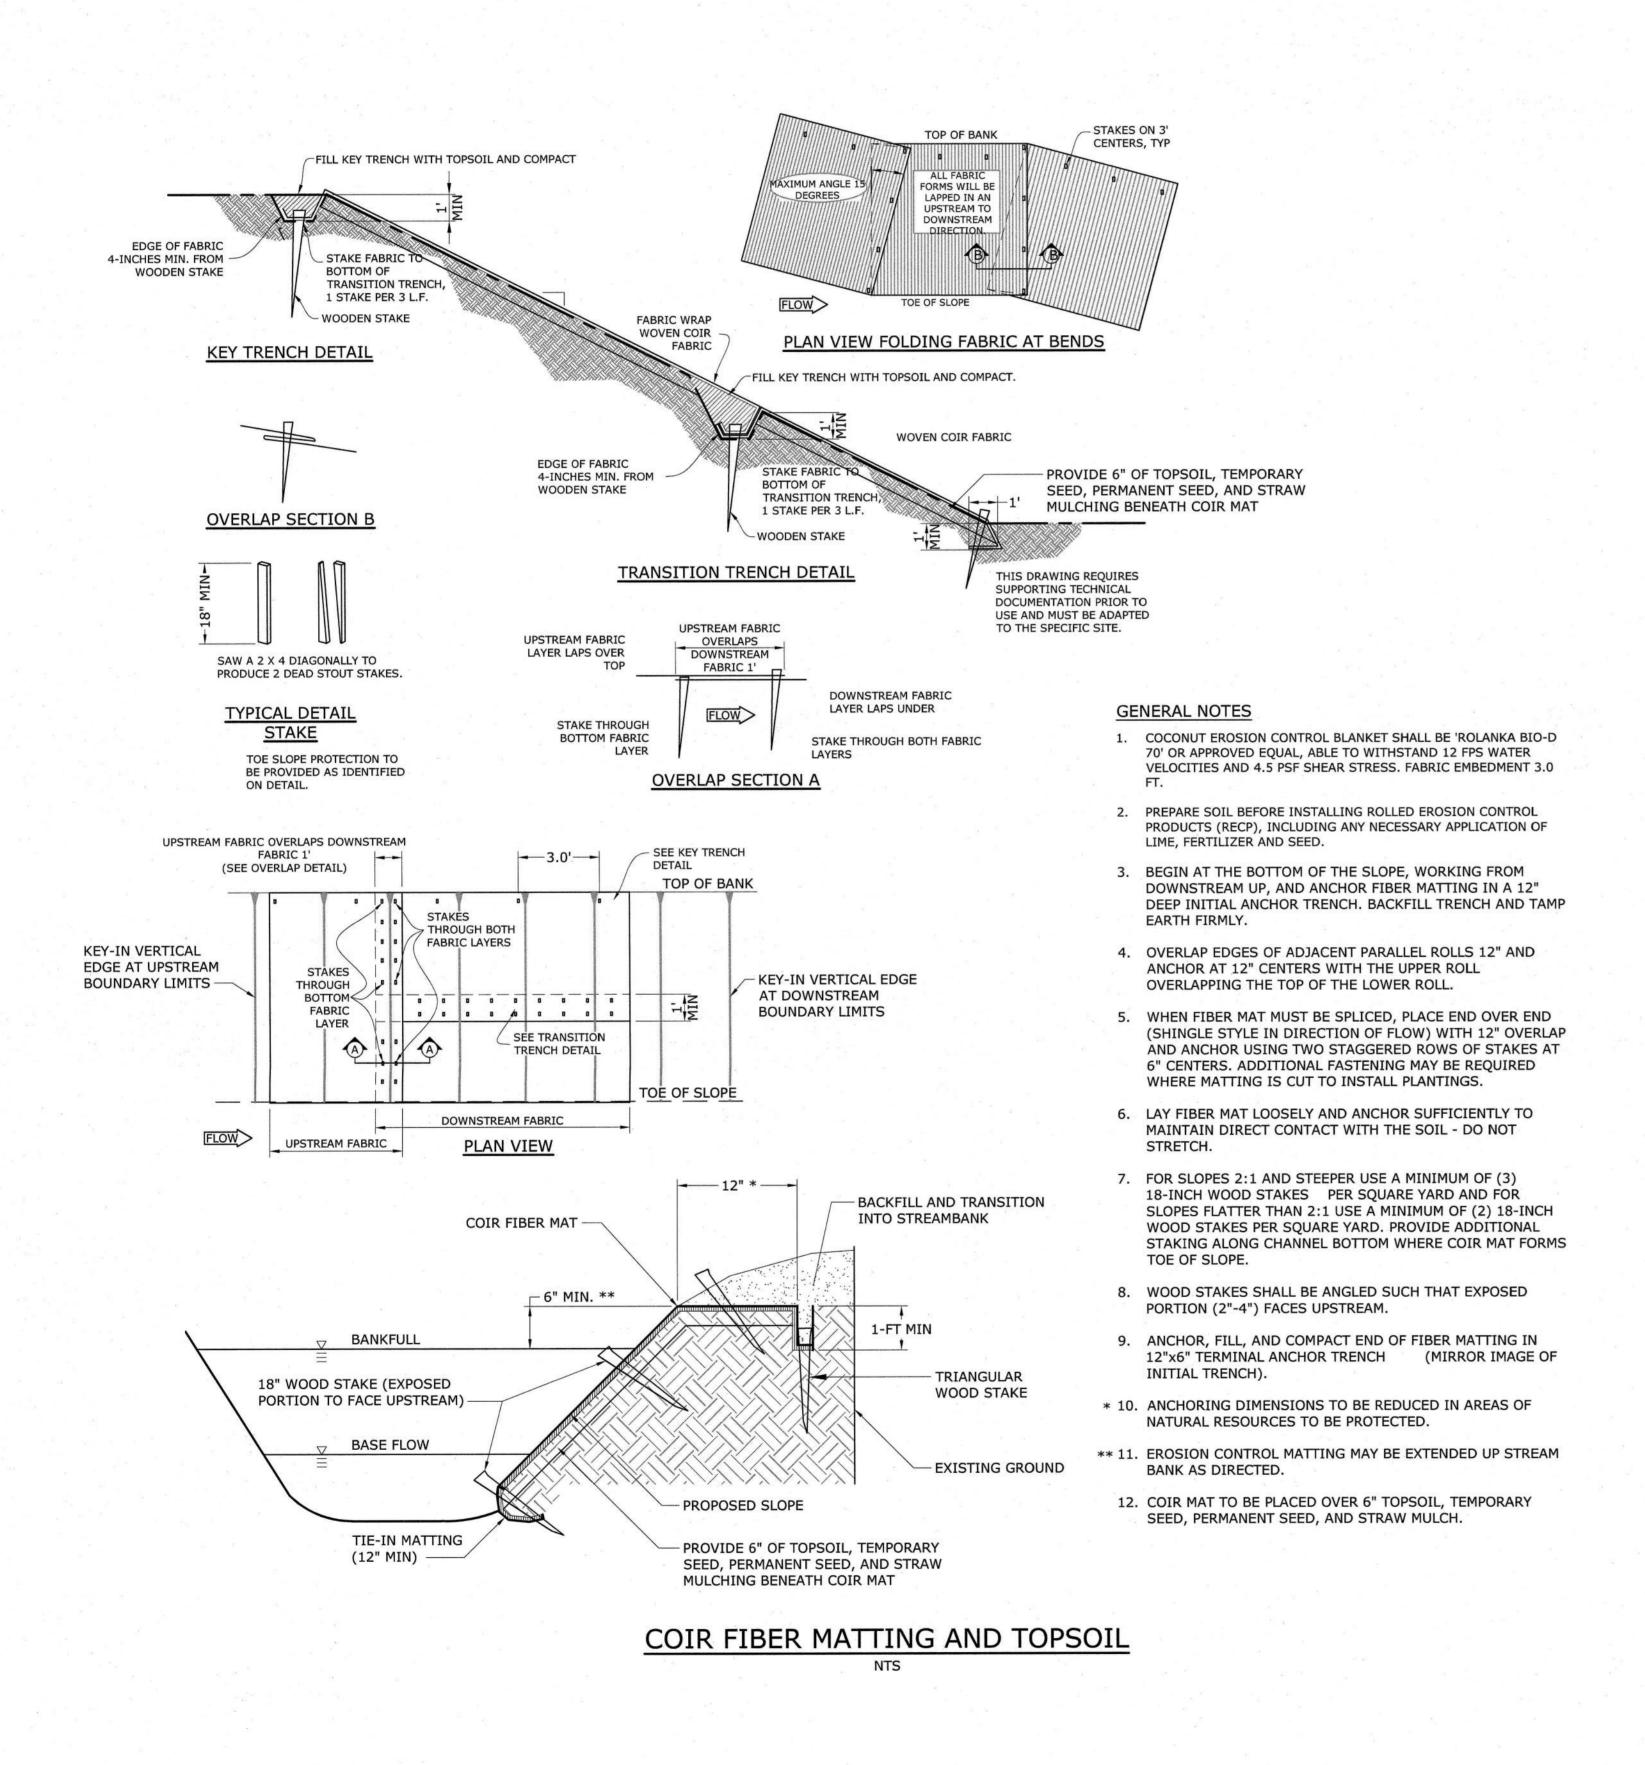

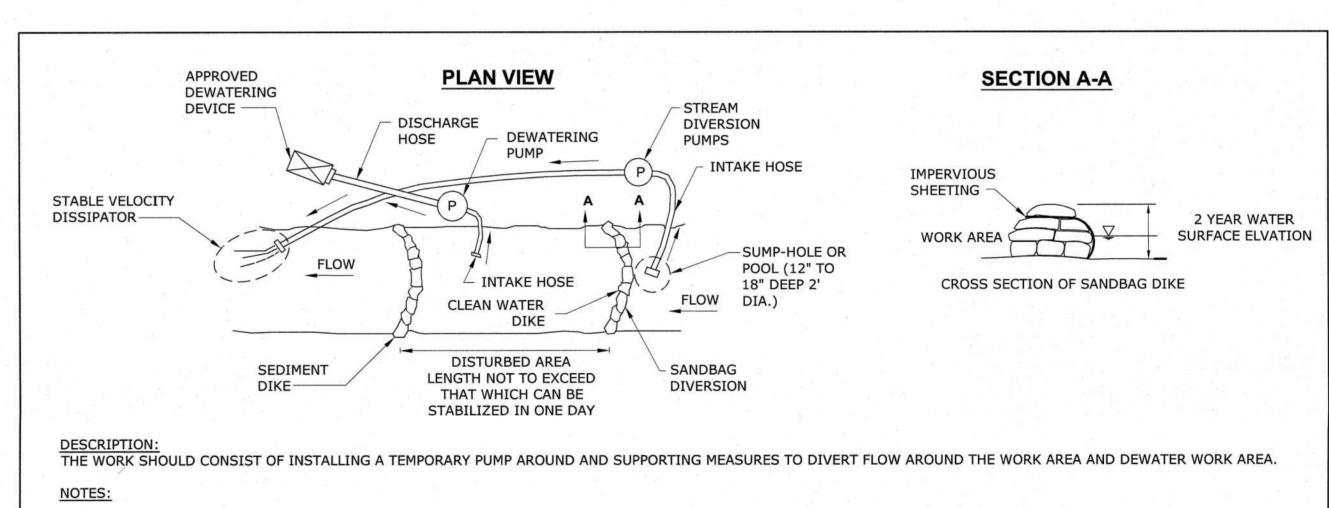

1. THE CONTRACTOR SHOULD STAY WITHIN THE LIMITS OF THE DISTURBANCE AS SHOWN ON THE PLANS AND MINIMIZE DISTURBANCE WITHIN THE WORK AREA WHENEVER

- 2. THE CONTRACTOR SHOULD ONLY BEGIN WORK IN AN AREA WHICH CAN BE COMPLETED BY THE END OF THE DAY. AT THE END OF EACH WORK DAY, THE WORK AREA MUST BE STABILIZED AND THE PUMP AROUND REMOVED.
- 3. SANDBAG DIKES SHOULD BE SITUATED AT THE ENDS OF THE WORK AREA AS SHOWN ON THE PLANS, AND CLEAN STREAM FLOW SHOULD BE PUMPED AROUND THE WORK AREA. THE PUMP SHOULD DISCHARGE ONTO A STABLE VELOCITY DISSIPATER MADE OF RIPRAP OR SANDBAGS.
- 4. WATER FROM THE WORK AREA SHOULD BE PUMPED TO A SEDIMENT FILTERING MEASURE SUCH AS A DEWATERING BASIN, SEDIMENT BAG, OR OTHER APPROVED SOURCE. THE MEASURE SHOULD BE LOCATED SUCH THAT THE WATER DRAINS DOWNSTREAM OF THE WORK AREA.
- FOR STREAMWORK REPAIR PROJECTS LONGER THAN 400 LINEAR FEET, MULTIPLE WORK AREAS SHALL BE ESTABLISHED IN SUCCESION. ONCE AN AREA IS COMPLETED AND STABILIZED, THE CLEAN WATER DIKE SHOULD BE REMOVED. AFTER THE FIRST SEDIMENT FLUSH, A NEW CLEAN WATER DIKE WOULD BE ESTABLISHED FROM THE OLD SEDIMENT
- DIKE. FINALLY, UPON ESTABLISHMENT OF A NEW SEDIMENT DIKE BELOW THE OLD ONE, THE OLD SEDIMENT DIKE SHOULD BE REMOVED. 6. A PUMP AROUND MUST BE INSTALLED ON ANY TRIBUTARY OR STORM DRAIN OUTFALL WHICH CONTRIBUTES BASEFLOW TO THE WORK AREA. THIS SHOULD BE ACCOMPLISHED
- BY LOCATING A SANDBAG DIKE AT THE DOWNSTREAM END OF THE TRIBUTARY OR STORM DRAIN OUTFALL AND PUMPING THE STREAM FLOW AROUND THE WORK AREA. THIS WATER SHOULD DISCHARGE ONTO THE SAME VELOCITY DISSIPATER USED FOR THE MAIN STEM PUMP AROUND.

PUMP AROUND DETAIL

			2 -		
				PROJECT ENGINEER:	D. EHRHARDT
				DESIGNED BY:	T. SCHUELER
				DRAWN BY:	S. KANE
				CHECKED BY:	D. EHRHARDT
				IF THIS BAR DOES NOT MEASURE 1" THEN DRAWIN	o 1/2" 1"
REV	ISSUED FOR	DATE	BY	IS NOT TO FULL SCALE	


100% SUBMITTAL

Hazen HAZEN AND SAWYER
5775 PEACHTREE DUNWOODY ROAD,

SUITE D-520 ATLANTA, GA 30342


DOUGLASVILLE-DOUGLAS COUNTY WATER AND SEWER AUTHORITY

STEWART MILL ROAD SANITARY SEWER REPLACEMENT PROJECT

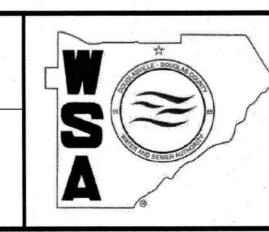


OUTFALL SEWER CIVIL STREAM RESTORATION **DETAILS**


MAY 2019 31247-010 HAZEN NO.: CONTRACT NO.: 22B4413-02 DRAWING NUMBER:

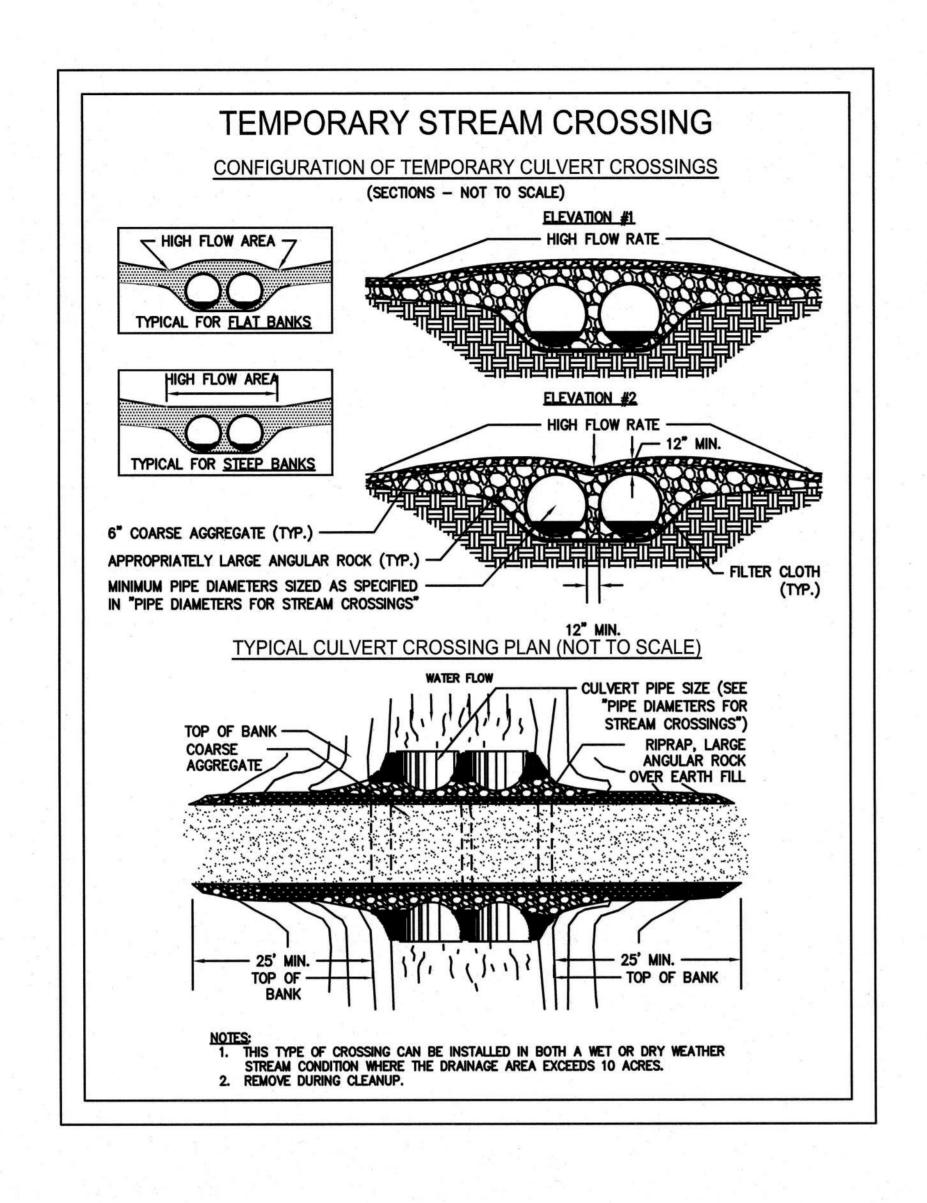

ROCK SIZING CHART FOR STREAM REVETMENTS ON ANNEEWAKEE CREEK - DOUGLAS COUNTY, GA										
TYPE OF REVETMENT	AREA USED	SUBCOMPONENT	PURPOSE	MATERIAL	D50 (INCHES)	NSA ¹ Type	Filter Stone	NOTES	DETAIL REFERENCE	GRADING TOLERANCE
IMPRICATED		WALL STONE	BANK PROTECTION	BOULDERS	24	R-7+	FS-3	FLAT, STACKABLE		1.0' +/- HOR; 0.2' +/- VERT
IMBRICATED	MC	FOOTER ROCK	GRADE CONTROL	BOULDERS	30	R-7+	FS-3	FLAT, STACKABLE	SEE IRW DETAIL	
RIPRAP WALL	MS	BEDDING SUPPORT	GRADE CONTROL	STONE	NA			FS-3 (2.5 inch stone)	SLL IRW DLIAIL	
(IRW)		CHINKING STONE	BANK PROTECTION	RIP RAP	6	R-4				NA
	¹ NATIONAL STONE ASSOCIATION									

NOTE: D50 DIMENSION SHALL BE THE INTERMEDIATE AXIS (NOT THE SMALLEST AXIS)

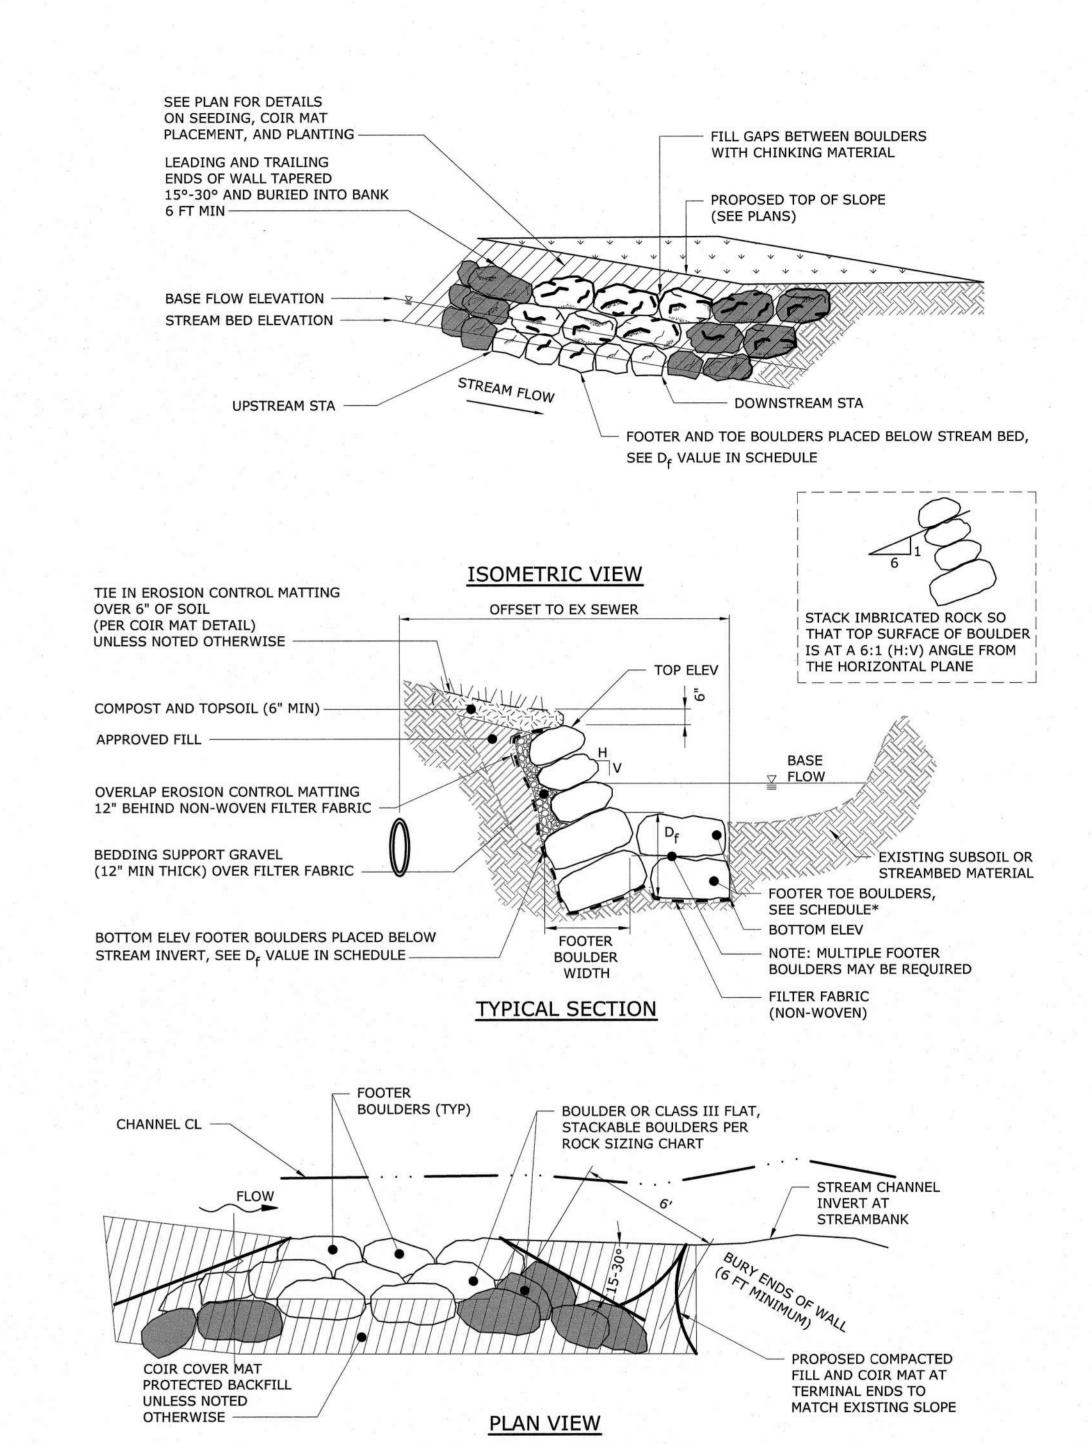

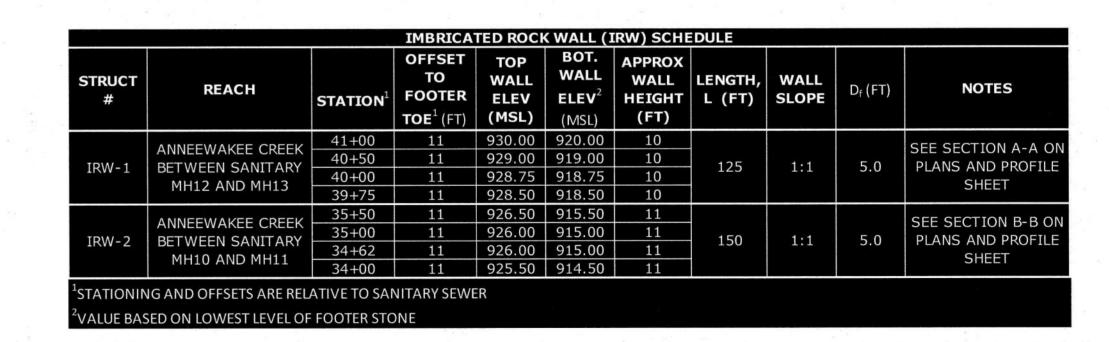

IMBRICATED ROCK WALL (IRW) DETAIL

				PROJECT ENGINEER:	D. EHRHARDT
		0		DESIGNED BY:	T. SCHUELER
				DRAWN BY:	S. KANE
				CHECKED BY:	D. EHRHARDT
	0 0			IF THIS BAR DOES NOT MEASURE 1" THEN DRAW	VING 0 1/2" 1"
REV	ISSUED FOR	DATE	BY	IS NOT TO FULL SCALE	



100% SUBMITTAL

HAZEN AND SAWYER
5775 PEACHTREE DUNWOODY ROAD,
SUITE D-520
ATLANTA, GA 30342

DOUGLASVILLE-DOUGLAS COUNTY WATER AND SEWER AUTHORITY

STEWART MILL ROAD SANITARY SEWER REPLACEMENT PROJECT



OUTFALL SEWER
CIVIL
STREAM RESTORATION
DETAILS FOR IRW-1 & 2

DATE: MAY 2019

HAZEN NO.: 31247-010

CONTRACT NO.: 22B4413-02

DRAWING NUMBER:

C011

SECONDARY PERMITTEES

NOTE: THIS MASTER LIST TO BE COMPLETED AND SIGNED AND KEPT IN THE "ON-SITE" CONSTRUCTION TRAILER.

SECONDARY PERMITTEES SIGN WHEN RECEIVING PLANS. ALL SECONDARY PERMITTEES MUST SUBMIT SECONDARY NOI AT LEAST 14 DAYS PRIOR TO BEGINNING CONSTRUCTION

NAME COMPANY	PHONE FAX		
ADDRESS GSWCC LEVEL 1A CERTIFICATION NO	1	SIGNATURE	
		SIGNATURE	
NAME COMPANY	PHONE FAX		
ADDRESS GSWCC LEVEL 1A CERTIFICATION NO			
		SIGNATURE	
NAME	PHONE		
COMPANY ADDRESS	FAX		
GSWCC LEVEL 1A CERTIFICATION NO		SIGNATURE	
NAME COMPANY ADDRESS	PHONE FAX		
GSWCC LEVEL 1A CERTIFICATION NO		SIGNATURE	
		O1011111	

DESIGN	PROFESSIONAL	7-DAY	VISIT	CERTIFICATION

DATE OF INSPECTION
I CERTIFY THE SITE WAS IN COMPLIANCE WITH THE ES&PC PLAN ON THE DATE OF INSPECTION.
GSWCC LEVEL II DESIGN PROFESSIONAL NAME, SIGNATURE, AND CERTIFICATION
INSPECTION REVEALED THE FOLLOWING DISCREPANCIES FROM THE ES&PC PLAN.

THESE DEFICIENCIES MUST BE ADDRESSED IMMEDIATELY AND A RE-INSPECTION SCHEDULED. WORK SHALL NOT PROCEED ON THE SITE UNTIL DESIGN PROFESSIONAL CERTIFICATION IS OBTAINED.


DESIGN PROFESSIONAL'S CERTIFICATION

(1) I CERTIFY THAT THE PERMITTEE'S EROSION, SEDIMENTATION, AND POLLUTION CONTROL PLAN PROVIDES FOR AN APPROPRIATE AND COMPREHENSIVE SYSTEM OF BEST MANAGEMENT PRACTICES REQUIRED BY THE GEORGIA WATER QUALITY CONTROL ACT AND THE DOCUMENT "MANUAL FOR EROSION AND SEDIMENT CONTROL IN GEORGIA" (MANUAL) PUBLISHED BY THE STATE SOIL AND WATER CONSERVATION COMMISSION AS OF JANUARY 1 OF THE YEAR IN WHICH THE LAND-DISTURBING ACTIVITY WAS PERMITTED, PROVIDES FOR THE SAMPLING OF THE RECEIVING WATER(S) OR THE SAMPLING OF THE STORMWATER OUTFALLS, AND THAT THE DESIGNED SYSTEM OF BEST MANAGEMENT PRACTICES AND SAMPLING METHODS IS EXPECTED TO MEET THE REQUIREMENTS CONTAINED IN THE GENERAL NPDES PERMIT NO. GAR100002.

(2) I CERTIFY UNDER PENALTY OF LAW THAT THIS PLAN WAS PREPARED AFTER A SITE VISIT TO THE LOCATIONS DESCRIBED HEREIN BY MYSELF OR MY AUTHORIZED AGENT, UNDER MY DIRECT SUPERVISION.

(3) I CERTIFY UNDER PENALTY OF LAW THAT THIS DOCUMENT AND ALL ATTACHMENTS WERE PREPARED UNDER MY DIRECTION OR SUPERVISION IN ACCORDANCE WITH A SYSTEM DESIGNED TO ASSURE THAT QUALIFIED PERSONNEL PROPERLY GATHER AND EVALUATE THE INFORMATION SUBMITTED. BASED ON MY INQUIRY OF THE PERSON OR PERSONS WHO MANAGE THE SYSTEM, OR THOSE PERSONS DIRECTLY RESPONSIBLE FOR GATHERING THE INFORMATION, THE INFORMATION SUBMITTED IS, TO THE BEST OF MY KNOWLEDGE AND BELIEF, TRUE, ACCURATE, AND COMPLETE. I AM AWARE THAT THERE ARE SIGNIFICANT PENALITIES FOR SUBMITTING FALSE INFORMATION, INCLUDING THE POSSIBILITY OF FINE AND IMPRISONMENT FOR KNOWING VIOLATIONS.

(4) I CERTIFY THAT THE PERMITTEE'S EROSION, SEDIMENTATION AND POLLUTION CONTROL PLAN PROVIDES FOR THE MONITORING OF: (A) ALL PERENNIAL AND INTERMITTENT STREAMS AND OTHER WATER BODIES SHOWN ON THE USGS TOPOGRAPHIC MAP AND ALL OTHER FIELD VERIFIED PERENNIAL AND INTERMITTENT STEAMS AND OTHER WATER BODIES, OR (B) WHERE ANY SUCH SPECIFIC IDENTIFIED PERENNIAL OR INTERMITTENT STREAM AND OTHER WATER BODY IS NOT PROPOSED TO BE SAMPLED, I HAVE DETERMINED IN MY PROFESSIONAL JUDGMENT, UTILIZING THE FACTORS REQUIRED IN THE GENERAL NPDES PERMIT NO. GAR 100002, THAT THE INCREASE IN THE TURBIDITY OF EACH SPECIFIC IDENTIFIED SAMPLED RECEIVING WATER WILL BE REPRESENTATIVE OF THE INCREASE IN THE TURBIDITY OF A SPECIFIC IDENTIFIED UN-SAMPLED RECEIVING WATER.

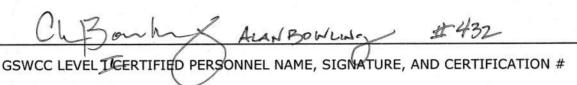

PRIMARY PERMITTEE CERTIFICATION

(1) I CERTIFY THAT THE RECEIVING WATER(S) OR THE OUTFALL(S) OR A COMBINATION OF RECEIVING WATER(S) AND OUTFALL(S) SHALL BE MONITORED IN ACCORDANCE WITH THE EROSION, SEDIMENTATION, AND POLLUTION CONTROL PLAN.

(2) I CERTIFY THAT THE EROSION, SEDIMENTATION, AND POLLUTION CONTROL PLAN HAS BEEN PREPARED IN ACCORDANCE WITH PART IV OF THE GENERAL NPDES PERMIT GAR100002. THE PLAN SHALL BE IMPLEMENTED, AND THAT SUCH PLAN SHALL PROVIDE FOR COMPLIANCE WITH THIS PERMIT.

(3) I CERTIFY UNDER PENALTY OF LAW THAT THIS DOCUMENT AND ALL ATTACHMENTS WERE PREPARED UNDER MY DIRECTION OR SUPERVISION IN ACCORDANCE WITH A SYSTEM DESIGNED TO ASSURE THAT OUALIFIED PERSONNEL PROPERLY GATHER AND EVALUATE THE INFORMATION SUBMITTED. BASED ON MY INOUIRY OF THE PERSON OR PERSONS WHO MANAGE THE SYSTEM, OR THOSE PERSONS DIRECTLY RESPONSIBLE FOR GATHERING THE INFORMATION, THE INFORMATION SUBMITTED IS, TO THE BEST OF MY KNOWLEDGE AND BELIEF, TRUE, ACCURATE, AND COMPLETE. I AM AWARE THAT THERE ARE SIGNIFICANT PENALITIES FOR SUBMITTING FALSE INFORMATION, INCLUDING THE POSSIBILITY OF FINE AND IMPRISONMENT FOR KNOWING VIOLATIONS.

(4) I CERTIFY THAT THE PERMITTEE'S EROSION, SEDIMENTATION, AND POLLUTION CONTROL PLAN PROVIDES FOR AN APPROPRIATE AND COMPREHENSIVE SYSTEM OF BEST MANAGEMENT PRACTICES REQUIRED BY THE GEORGIA WATER QUALITY CONTROL ACT AND THE DOCUMENT "MANUAL FOR EROSION AND SEDIMENT CONTROL IN GEORGIA" (MANUAL) PUBLISHED BY THE STATE SOIL AND WATER CONSERVATION COMMISSION AS OF JANUARY 1 OF THE YEAR IN WHICH THE LAND-DISTURBING ACTIVITY WAS PERMITTED, PROVIDES FOR THE SAMPLING OF THE RECEIVING WATER(S) OR THE SAMPLING OF THE STORMWATER OUTFALLS, AND THAT THE DESIGNED SYSTEM OF BEST MANAGEMENT PRACTICES AND SAMPLING METHODS IS EXPECTED TO MEET THE REQUIREMENTS CONTAINED IN THE GENERAL NPDES PERMIT NO. GAR100002.

(5) I CERTIFY THAT THE APPLICABLE PORTIONS OF THE EROSION CONTROL PLANS SHALL BE PROVIDED TO EACH SECONDARY PERMITTEE PRIOR TO THE SECONDARY PERMITTEE CONDUCTING ANY CONSTRUCTION ACTIVITY.

(6) THE PRIMARY PERMITTEE MUST RETAIN THE DESIGN PROFESSIONAL WHO PREPARED THE PLAN, OR AN ALTERNATIVE PROFESSIONAL APPROVED BY EPD IN WRITING, TO INSPECT THE INSTALLATION OF THE INITIAL SEDIMENT STORAGE REQUIREMENTS AND PERIMETER CONTROL BMPS WITHIN (7) DAYS AFTER INSTALLATION. ALTERNATIVELY, FOR LINEAR INFRASTRUCTURE PROJECTS, THE PRIMARY PERMITTEE MUST RETAIN THE DESIGN PROFESSIONAL WHO PREPARED THE PLAN, OR ALTERNATIVE DESIGN PROFESSIONAL APPROVED BY EPD IN WRITING TO INSPECT (A) THE INSTALLATION OF SEDIMENT STORAGE REQUIREMENTS AND PERIMETER CONTROL BMPS FOR THE "INITIAL SEGMENT" OF THE LINEAR INFRASTRUCTURE PROJECT AND (B) ALL SEDIMENT BASINS WITHIN THE ENTIRE LINEAR INFRASTRUCTURE PROJECT WITHIN (7) DAYS AFTER THE INSTALLATION. FOR THE PURPOSES OF THE SPECIFIC REQUIREMENTS IN PART IV.A.5., THE DISTURBED ACREAGE OF THE "INITIAL SEGMENT" OF A LINEAR INFRASTRUCTURE PROJECT MUST BE EQUAL TO OR GREATER THAN 10% OF THE TOTAL ESTIMATED DISTURBED ACREAGE FOR THE LINEAR INFRASTRUCTURE PROJECT BUT NOT LESS THAN ONE(1) ACRE. THE DESIGN PROFESSIONAL SHALL DETERMINE IF THESE BMPS HAVE BEEN INSTALLED AND ARE BEING MAINTAINED AS DESIGNED. THE DESIGN PROFESSIONAL SHALL REPORT THE RESULTS OF THE INSPECTION TO THE PRIMARY PERMITTEE WITHIN (7) DAYS AND THE PERMITTEE MUST CORRECT ALL DEFICIENCIES WITHIN (2) BUSINESS DAYS OF RECEIPT OF THE INSPECTION REPORT FROM THE DESIGN PROFESSIONAL UNLESS WEATHER RELATED SITE CONDITIONS ARE SUCH THAT ADDITIONAL TIME IS REQUIRED.

GSWCC LEVEL I CERTIFIED PERSONNEL NAME, SIGNATURE, AND CERTIFICATION #

REQUIRED NOTES

- 1. NON-EXEMPT ACTIVITIES SHALL NOT BE CONDUCTED WITHIN THE 25 OR 50-FOOT UNDISTURBED STREAM BUFFERS AS MEASURED FROM THE POINT OF WRESTED VEGETATION WITHOUT FIRST ACQUIRING THE NECESSARY VARIANCES AND PERMITS.
- 2. AMMENDMENTS / REVISIONS TO THE ES&PC PLAN WHICH HAVE A SIGNIFICANT EFFECT ON BMPs WITH A HYDRAULIC COMPONENT MUST BE CERTIFIED BY THE DESIGN PROFESSIONAL. 2.1. THE PRIMARY, SECONDARY OR TERTIARY PERMITTEES, AS APPLICABLE, SHALL AMEND THEIR PLANS WHENEVER THERE IS A CHANGE IN DESIGN, CONSTRUCTION, OPERATION, OR MAINTENANCE, WHICH HAS A SIGNIFICANT EFFECT ON BMPS WITH A HYDRAULIC COMPONENT.
- 2.2. ALL REVISIONS OR AMENDMENTS SHALL BE SUBMITTED TO THE LOCAL ISSUING AUTHORITY FOR REVIEW.
- 3. WASTE MATERIALS SHALL NOT BE DISCHARGED TO WATERS OF THE STATE, EXCEPT AS AUTHORIZED BY A SECTION 404 PERMIT.
- 3.1. INCLUDING BUT NOT LIMITED TO WASTE BUILDING MATERIALS, CONSTRUCTION AND DEMOLITION DEBRIS, CONCRETE WASHOUT OR EXCAVATED SEDIMENT
- 4. THE ESCAPE OF SEDIMENT FROM THE SITE SHALL BE PREVENTED BY THE INSTALLATION OF EROSION AND SEDIMENT CONTROL MEASURES AND PRACTICES PRIOR TO LAND DISTURBING

5. EROSION CONTROL MEASURES WILL BE MAINTAINED AT ALL TIMES. IF FULL IMPLEMENTATION OF

- THE APPROVED PLAN DOES NOT PROVIDE FOR EFFECTIVE EROSION CONTROL, ADDITIONAL EROSION AND SEDIMENT CONTROL MEASURES SHALL BE IMPLEMENTED TO CONTROL OR TREAT THE SEDIMENT SOURCE.
- ANY DISTURBED AREA LEFT EXPOSED FOR A PERIOD GREATER THAN 14 DAYS SHALL BE STABILIZED WITH MULCH OR TEMPORARY SEEDING.

NON-STORMWATER DISCHARGES

ALL NON-STORMWATER DISCHARGES SHALL BE ROUTED THROUGH ONSITE BMPS AND THE STORMWATER MANAGEMENT SYSTEM WHERE POSSIBLE. THESE DISCHARGES INCLUDE FLUSHING OF WATER AND FIRE LINES, IRRIGATION WATER, GROUNDWATER, DEWATERING OF PITS OR DEPRESSIONS WITHIN THE CONSTRUCTION SITE, AND RINSE-OFF WATER CONTAINING NON-TOXIC MATERIALS.

WASTE MATERIALS

ALL WASTE MATERIALS SHALL BE COLLECTED AND STORED IN A SECURELY-LIDDED METAL DUMPSTER. THE DUMPSTER SHALL MEET ALL SOLID WASTE MANAGEMENT REGULATIONS. ALL TRASH AND CONSTRUCTION DEBRIS FROM THE SITE SHALL BE DEPOSITED IN THE DUMPSTER. THE DUMPSTER SHALL BE EMPTIED A MINIMUM OF ONCE PER WEEK OR MORE OFTEN IF NECESSARY, AND TRASH SHALL BE HAULED AS REQUIRED BY LOCAL REGULATIONS. NO CONSTRUCTION WASTE SHALL BE BURIED

HAZARDOUS WASTES

ALL HAZARDOUS WASTE MATERIALS SHALL BE DISPOSED OF IN THE MANNER SPECIFIED BY LOCAL, STATE, AND/OR FEDERAL REGULATIONS AND BY THE MANUFACTURER OF SUCH PRODUCTS. THE CONTRACTOR'S SUPERINTENDENT, WHO SHALL ALSO BE RESPONSIBLE FOR ENSURING THAT THESE PRACTICES ARE FOLLOWED. SHALL INSTRUCT SITE PERSONNEL IN THESE PRACTICES. MATERIAL SAFETY DATA SHEETS (MSDS'S) FOR EACH SUBSTANCE WITH HAZARDOUS PROPERTIES THAT IS USED ONSITE SHALL BE OBTAINED AND USED FOR THE PROPER MANAGEMENT OF POTENTIAL WASTES THAT MAY RESULT FROM THESE PRODUCTS. A MSDS SHALL BE POSTED IN THE IMMEDIATE AREA WHERE SUCH PRODUCT IS STORED AND/OR USED, AND ANOTHER COPY OF EACH MSDS SHALL BE MAINTAINED IN THE ES&PC PLAN FILE AT THE ONSITE CONSTRUCTION TRAILER OFFICE. EACH EMPLOYEE WHO MUST HANDLE A SUBSTANCE WITH HAZARDOUS PROPERTIES SHALL BE INSTRUCTED ON THE USE OF MSDS SHEETS AND THE SPECIFIC INFORMATION IN THE APPLICABLE MSDS FOR THE PRODUCT HE/SHE IS USING, PARTICULARLY REGARDING SPILL CONTROL TECHNIQUES.

THE CONTRACTOR SHALL IMPLEMENT THE SPILL PREVENTION CONTROL AND COUNTERMEASURES (SPCC) PLAN FOUND WITHIN THIS ES&PC PLAN AND SHALL TRAIN ALL PERSONNEL IN THE PROPER CLEANUP AND HANDLING OF SPILLED MATERIALS. NO SPILLED HAZARDOUS MATERIALS OR HAZARDOUS WASTES SHALL BE ALLOWED TO COME IN CONTACT WITH STORMWATER DISCHARGES. IF SUCH CONTACT OCCURS, THE STORMWATER DISCHARGES SHALL BE CONTAINED ONSITE UNTIL APPROPRIATE MEASURES IN COMPLIANCE WITH STATE AND FEDERAL REGULATIONS ARE TAKEN TO DISPOSE OF SUCH CONTAMINATED STORMWATER. IT SHALL BE THE RESPONSIBILITY OF THE CONTRACTOR'S SUPERINTENDENT TO PROPERLY TRAIN ALL PERSONNEL IN THE USE OF THE SPCC PLAN.

SANITARY WASTES

A MINIMUM OF ONE (1) PORTABLE SANITARY UNIT SHALL BE PROVIDED FOR EVERY TEN (10) WORKERS ONSITE. ALL SANITARY WASTE SHALL BE COLLECTED FROM THE PORTABLE UNIT(S) A MINIMUM OF ONE (1) TIME PER WEEK BY A LICENSED PORTABLE FACILITY PROVIDER IN COMPLETE COMPLIANCE WITH LOCAL AND STATE REGULATIONS.

ALL SANITARY WASTE UNITS SHALL BE LOCATED IN AN AREA WHERE THE LIKELIHOOD OF THE UNIT CONTRIBUTING TO STORMWATER DISCHARGE IS NEGLIGIBLE. ADDITIONAL CONTAINMENT BMP'S MUST BE IMPLEMENTED, SUCH AS GRAVEL BAGS OR SPECIALLY-DESIGNED PLASTIC SKID CONTAINERS AROUND THE BASE, IF NECESSARY TO PREVENT WASTES FROM CONTRIBUTING TO STORMWATER DISCHARGES. THE LOCATION OF SANITARY WASTE UNITS MUST BE IDENTIFIED ON THE EROSION, SEDIMENTATION AND POLLUTION CONTROL PLAN, DRAWING NUMBERS C7 THROUGH C9, BY THE CONTRACTOR ONCE THE LOCATIONS HAVE BEEN DETERMINED.

SANITARY SEWER SHALL BE PROVIDED BY MUNICIPAL AUTHORITY AT THE COMPLETION OF THE PROJECT.

OFFSITE VEHICLE TRACKING

STABILIZED CONSTRUCTION EXITS HAVE BEEN PROVIDED TO HELP REDUCE VEHICLE TRACKING OF SEDIMENT. SEE DRAWING NUMBER C015 FOR CONSTRUCTION EXIT LOCATIONS AND DRAWING NUMBER C021 FOR CONSTRUCTION EXIT DETAIL. THE PAVED STREETS ADJACENT TO EACH CONSTRUCTION EXIT SHALL BE INSPECTED DAILY FOR TRACKING OF MUD, DIRT, OR ROCKS. DUMP TRUCKS HAULING MATERIAL FROM THE CONSTRUCTION SITE SHALL BE COVERED WITH A TARPAULIN.

NPDS APPENDIX NOTES

- 1. ITEM H: MAXIMUM IMPERVIOUS AREA a. TOTAL AREA: 3.60 ACRES
- b. MAXIMUM IMPERVIOUS AREA: 50% OF TOTAL PLANNED SITE
- c. MAXIMUM IMPERVIOUS AREA: 3.6 ACRES X 50% = 1.8 ACRES d.IMPERVIOUS AREA: < 0.1 ACRES
- e. IMPERVIOUS AREA: <15% (EST. 3%)
- 2. ITEM H: TOTAL DISTURBANCE AREA AT ANY ONE TIME: a. TOTAL AREA: 3.60 ACRES b. MAX DISTURBED AREA AT ANY ONE TIME: 25 ACRES OR 50% OR TOTAL
- PLANNED SITE (50% X 3.6 ACRES = 1.8 ACRES) c. MAX DISTURBED AREA AT ANY ONE TIME: 1.8 ACRES
- d. TOTAL DISTURBED AREA: 2.16 ACRES e. SITE TO BE STABILIZED AS PORTIONS OF PROJECT ARE COMPLETED. NO MORE
- THAN 1.8 ACRES DISTURBED AREA AT ONE TIME.

3. ITEM Q: INSPECTIONS

a. CERTIFIED PERSONNEL FOR PRIMARY PERMITTEES SHALL CONDUCT INSPECTIONS AT LEAST ONCE EVERY FOURTEEN (14) CALENDAR DAYS AND WITHIN 24 HOURS OF THE END OF THE STORM THAT IS 0.5 INCHES RAINFALL OR GREATER IN ACCORDANCE WITH SECTION IV.D.4.A.(3)(A) - (C) OF THIS

4. ITEM T: TOTAL PLANNED SITE DISTURBANCE: a. TOTAL AREA: 3.60 ACRES b. IMPERVIOUS AREA: < 0.1 ACRES c. IMPERVIOUS AREA: <15% (EST. 3%)

INVENTORY FOR POLLUTION PREVENTION PLAN

THE FOLLOWING MATERIALS ARE EXPECTED TO BE ONSITE DURING CONSTRUCTION: CONCRETE PRODUCTS, ASPHALT, PETROLEUM-BASED FUELS AND LUBRICANTS FOR EQUIPMENT, TAR, METAL BUILDING MATERIALS, LUMBER, SHEET ROCK, FLOOR COVERINGS, ELECTRICAL WIRE AND FIXTURES, PAINTS/STAINS/COATINGS/FINISHING TREATMENTS, PAINT/CLEANING SOLVENTS, ADDITIVES FOR SOIL STABILIZATION, PESTICIDES, FERTILIZERS, HERBICIDES, CRUSHED STONE, PLASTIC PIPES, AND METAL PIPES.

SPILL PREVENTION

PRACTICES SUCH AS GOOD HOUSEKEEPING, PROPER HANDLING OF HAZARDOUS PRODUCTS, AND PROPER SPILL CONTROL PRACTICES SHALL BE FOLLOWED TO REDUCE THE RISK OF SPILLS AND THEIR SUBSEQUENT DISCHARGE INTO STORMWATER RUNOFF.

GOOD HOUSEKEEPING

- QUANTITIES OF PRODUCTS STORED ONSITE SHALL BE LIMITED TO THE AMOUNT NEEDED FOR THE PROJECT.
- PRODUCTS AND MATERIALS SHALL BE STORED IN A NEAT, ORDERLY MANNER IN APPROPRIATE CONTAINERS PROTECTED FROM RAINFALL, WHERE POSSIBLE.
- LABELS LEGIBLE AND VISIBLE. PRODUCT MIXING, DISPOSAL, AND DISPOSAL OF PRODUCT CONTAINERS SHALL BE

PRODUCTS SHALL BE KEPT IN THEIR ORIGINAL CONTAINERS WITH MANUFACTURER'S

ACCORDING TO THE MANUFACTURER'S RECOMMENDATIONS. THE CONTRACTOR SHALL INSPECT SUCH MATERIALS TO ENSURE PROPER USE,

PRODUCT SPECIFIC PRACTICES

STORAGE, AND DISPOSAL.

PETROLEUM-BASED PRODUCTS: CONTAINERS FOR PRODUCTS SUCH AS FUELS, LUBRICANTS. AND TARS SHALL BE INSPECTED DAILY FOR LEAKS AND SPILLS. THIS INCLUDES DAILY INSPECTIONS OF ONSITE VEHICLES/MACHINERY AND REGULAR PREVENTATIVE MAINTENANCE OF SUCH EQUIPMENT. EQUIPMENT MAINTENANCE AREAS SHALL BE LOCATED AWAY FROM STATE WATERS, NATURAL DRAINS, AND STORMWATER DRAINAGE INLETS. IN ADDITION, TEMPORARY FUELING TANKS SHALL HAVE A SECONDARY CONTAINMENT LINER TO PREVENT/MINIMIZE SITE CONTAMINATION. DISCHARGE OF OILS, FUELS, AND LUBRICANTS IS PROHIBITED. PROPER DISPOSAL METHODS SHALL INCLUDE COLLECTION IN A SUITABLE CONTAINER AND DISPOSAL AS REQUIRED BY LOCAL AND STATE REGULATIONS.

PAINTS/FINISHES/SOLVENTS/ETC.: ALL PRODUCTS SHALL BE STORED IN TIGHTLY-SEALED ORIGINAL CONTAINERS WHEN NOT IN USE. EXCESS PRODUCT SHALL NOT BE DISCHARGED INTO THE STORMWATER COLLECTION SYSTEM. EXCESS PRODUCT, MATERIALS USED WITH THESE PRODUCTS, AND PRODUCT CONTAINERS SHALL BE DISPOSED OF ACCORDING TO MANUFACTURER'S SPECIFICATIONS AND RECOMMENDATIONS.

CONCRETE TRUCK WASHING: NO CONCRETE TRUCKS SHALL BE ALLOWED TO WASH OUT OR DISCHARGE SURPLUS CONCRETE OR DRUM WASHWATER ONSITE.

FERTILIZER/HERBICIDES: THESE PRODUCTS SHALL BE APPLIED AT RATES THAT DO NOT EXCEED THE MANUFACTURER'S SPECIFICATIONS, THE GUIDELINES SET FORTH IN THE CROP ESTABLISHMENT, OR THE RATES IN THE GSWCC MANUAL FOR EROSION AND SEDIMENT CONTROL IN GEORGIA. ANY STORAGE OF THESE MATERIALS SHALL BE UNDER A ROOF IN SEALED CONTAINERS.

BUILDING MATERIALS: NO BUILDING OR CONSTRUCTION MATERIALS SHALL BE BURIED OR DISPOSED OF ONSITE. ALL SUCH MATERIAL SHALL BE DISPOSED OF IN PROPER WASTE DISPOSAL PROCEDURES.

SPILL CLEANUP AND CONTROL PRACTICES

- LOCAL, STATE, AND MANUFACTURER'S RECOMMENDED METHODS FOR SPILL CLEANUP SHALL BE CLEARLY POSTED AND PROCEDURES SHALL BE MADE AVAILABLE TO SITE
- MATERIAL AND EQUIPMENT NECESSARY FOR SPILL CLEANUP SHALL BE KEPT IN THE MATERIAL STORAGE AREA(S). TYPICAL MATERIALS AND EQUIPMENT INCLUDES, BUT IS NOT LIMITED TO, BROOMS, DUSTPANS, MOPS, RAGS, GLOVES, GOGGLES, CAT LITTER, SAND, SAWDUST, AND PROPERLY-LABELED PLASTIC AND METAL WASTE CONTAINERS.
- SPILL PREVENTION PRACTICES AND PROCEDURES SHALL BE REVIEWED AFTER A SPILL AND ADJUSTED AS NECESSARY TO PREVENT FUTURE SPILLS.
- ALL SPILLS SHALL BE CLEANED UP IMMEDIATELY UPON DISCOVERY. ALL SPILLS SHALL BE REPORTED AS REQUIRED BY LOCAL, STATE, AND FEDERAL REGULATIONS. FOR SPILLS THAT IMPACT SURFACE WATER (LEAVE A SHEEN ON SURFACE WATER), THE
- NATIONAL RESPONSE CENTER (NRC) MUST BE CONTACTED WITHIN 24 HOURS AT 1-800-426-2675. FOR SPILLS OF AN UNKNOWN AMOUNT, THE NATIONAL RESPONSE CENTER (NRC) MUST
- BE CONTACTED WITHIN 24 HOURS AT 1-800-426-2675.
- FOR SPILLS GREATER THAN 25 GALLONS AND NO SURFACE WATER IMPACTS, THE
- GEORGIA EPD MUST BE CONTACTED WITHIN 24 HOURS. FOR SPILLS LESS THAN 25 GALLONS AND NO SURFACE WATER IMPACTS, THE SPILL
- SHALL BE CLEANED UP AND LOCAL AGENCIES MUST BE CONTACTED AS REQUIRED. IF MORE THAN 1,320 GALLONS OF PETROLEUM IS STORED ONSITE (THIS INCLUDES

CAPACITIES OF EQUIPMENT) OR IF ANY ONE PIECE OF EQUIPMENT HAS A CAPACITY GREATER THAN 660 GALLONS, THE CONTRACTOR SHALL SUBMIT A REVISED SPILL PREVENTION CONTAINMENT AND COUNTERMEASURES PLAN TO THE LICENSED PROFESSIONAL WHO PREPARED THIS PLAN FOR THEIR REVIEW AND APPROVAL.

ADDITIONAL BMP'S INCLUDE THE FOLLOWING:

- A LARGE SIGN AT LEAST 4' x 8 IN SIZE MUST BE ON SITE ON THE ACTUAL DAY OF CONSTRUCTION VISIBLE FROM A PUBLIC ROADWAY IDENTIFYING THE CONSTRUCTION SITE, THE PERMITTEE(S), AND THE CONTACT PERSON(S) AND TELEPHONE NUMBER(S) UNTIL A NOT HAS BEEN ISSUED.
- . USE MULCH FILTER BERMS, IN ADDITION TO A SILT FENCE, ON THE SITE PERIMETER WHEREVER CONSTRUCTION STORMWATER (INCLUDING SHEET FLOW) MAY BE DISCHARGED. MULCH FILTER BERMS CANNOT BE PLACED IN WATERWAYS OR AREAS OF CONCENTRATED
 - 3. SOIL TESTS MUST BE CONDUCTED TO IDENTIFY AND IMPLEMENT SITE-SPECIFIC FERTILIZER
 - 4. CONDUCT TURBIDITY SAMPLING AFTER EVERY RAIN EVENT OF 0.5 INCH OR GREATER WITHIN ANY 24 HOUR PERIOD, RECOGNIZING THE EXCEPTIONS SPECIFIED IN PART IV.D.6.D. OF THE NPDES PERMITS.

EACH EROSION AND SEDIMENT CONTROL AND STORM WATER MANAGEMENT DEVICE WILL BE INSPECTED IN ACCORDANCE WITH THIS ESPCP, CONTRACT DOCUMENTS AND CONSTRUCTION PLANS. ALL INSPECTIONS REQUIRED BY THIS ESPCP SHALL BE CONDUCTED BY QUALIFIED PERSONNEL, AS DEFINED BY THE PERMIT. FOR THIS PROJECT THE CONTRACTOR IS OBLIGATED BY AGREEMENT WITH THE OWNER, TO PROVIDE QUALIFIED PERSONNEL FOR ALL INSPECTIONS.

REOUIREMENTS FOR INSPECTION AND MAINTENANCE INCLUDE, BUT ARE NOT LIMITED TO, THE FOLLOWING:

1. EACH DAY WHEN ANY TYPE OF CONSTRUCTION ACTIVITY HAS TAKEN PLACE AT A PRIMARY PERMITTEE'S SITE, CERTIFIED PERSONNEL PROVIDED BY THE PRIMARY PERMITTEE SHALL INSPECT (A) ALL AREAS AT THE PRIMARY PERMITTEE'S SITE WHERE PETROLEUM PRODUCTS ARE STORED, USED, OR HANDLED FOR SPILLS AND LEAKS FROM VEHICLES AND EQUIPMENT; (B) ALL LOCATIONS AT THE PRIMARY PERMITTEE'S SITE WHERE VEHICLES ENTER OR EXIT THE SITE FOR EVIDENCE OF OFF-SITE SEDIMENT TRACKING; AND (C) MEASURE RAINFALL ONCE EACH 24-HOUR PERIOD AT THE SITE. THESE INSPECTIONS MUST BE CONDUCTED UNTIL A NOTICE OF TERMINATION IS SUBMITTED.


2. THE DESIGN PROFESSIONAL WHO PREPARES THE ES & PC PLAN IS TO INSPECT THE INSTALLATION OF BMP'S WITHIN 7 DAYS AFTER INITIAL CONSTRUCTION ACTIVITY

- 3. CERTIFIED PERSONNEL (PROVIDED BY THE PRIMARY PERMITTEE) SHALL INSPECT THE FOLLOWING AT LEAST ONCE EVERY FOURTEEN (14) CALENDAR DAYS AND WITHIN 24 HOURS OF THE END OF A STORM THAT IS 0.5 INCH OR GREATER (UNLESS SUCH STORM ENDS AFTER 5:00 PM ON ANY FRIDAY OR ON ANY NONWORKING SATURDAY, NONWORKING SUNDAY, OR ANY NONWORKING FEDERAL HOLIDAY IN WHICH CASE THE INSPECTION SHALL BE COMPLETED BY THE END OF THE NEXT BUSINESS DAY AND/OR WORKING DAY, WHICHEVER OCCURS FIRST): (A) DISTURBED AREAS OF THE PRIMARY PERMITTEE'S CONSTRUCTION SITE THAT HAVE NOT UNDERGONE FINAL STABILIZATION; (B) AREAS USED BY THE PRIMARY PERMITTEE FOR STORAGE OF MATERIALS THAT ARE EXPOSED TO PRECIPITATION THAT HAVE NOT UNDERGONE FINAL STABILIZATION; AND (C) STRUCTURAL CONTROL MEASURES. EROSION AND SEDIMENT CONTROL MEASURES IDENTIFIED IN THE PLAN APPLICABLE TO THE PRIMARY PERMITTEE'S SITE SHALL BE OBSERVED TO ENSURE THAT THEY ARE OPERATING CORRECTLY, WHERE DISCHARGE LOCATIONS OR POINTS ARE ACCESSIBLE, THEY SHALL BE INSPECTED TO ASCERTAIN WHETHER EROSION CONTROL MEASURES ARE EFFECTIVE IN PREVENTING SIGNIFICANT IMPACTS TO RECEIVING WATER(S). FOR AREAS OF A SITE THAT HAVE UNDERGONE FINAL STABILIZATION, THE PERMITTEE MUST COMPLY WITH PART IV.D.4.a.(3). THESE INSPECTIONS MUST BE CONDUCTED UNTIL A NOTICE OF TERMINATION IS SUBMITTED.
- 4. CERTIFIED PERSONNEL (PROVIDED BY THE PRIMARY PERMITTEE) SHALL INSPECT AT LEAST ONCE PER MONTH DURING THE TERM OF THIS PERMIT (I.E., UNTIL A NOTICE OF TERMINATION IS RECEIVED BY THE EPD) THE AREAS OF THE SITE THAT HAVE UNDERGONE FINAL STABILIZATION. THESE AREAS SHALL BE INSPECTED FOR EVIDENCE OF, OR THE POTENTIAL FOR, POLLUTANTS ENTERING THE DRAINAGE SYSTEM AND THE RECEIVING WATER(S). EROSION AND SEDIMENT CONTROL MEASURES IDENTIFIED IN THE PLAN SHALL BE OBSERVED TO ENSURE THAT THEY ARE OPERATING CORRECTLY. WHERE DISCHARGE LOCATIONS OR POINTS ARE ACCESSIBLE, THEY SHALL BE INSPECTED TO ASCERTAIN WHETHER EROSION CONTROL MEASURES ARE EFFECTIVE IN PREVENTING SIGNIFICANT IMPACTS TO RECEIVING WATER(S).
- 5. BASED ON THE RESULTS OF EACH INSPECTION, THE SITE DESCRIPTION AND THE POLLUTION PREVENTION AND CONTROL MEASURES IDENTIFIED IN THE EROSION, SEDIMENTATION AND POLLUTION CONTROL PLAN, THE PLAN SHALL BE REVISED AS APPROPRIATE NOT LATER THAN SEVEN (7) CALENDAR DAYS FOLLOWING EACH INSPECTION. IMPLEMENTATION OF SUCH CHANGES SHALL BE MADE AS SOON AS PRACTICAL BUT IN NO CASE LATER THAN SEVEN (7) CALENDAR DAYS FOLLOWING EACH INSPECTION.
- 6. A REPORT OF EACH INSPECTION THAT INCLUDES NAME(S) OF PERSONNEL MAKING EACH INSPECTION, THE DATE(S) OF EACH INSPECTION, MAJOR OBSERVATIONS RELATING TO THE IMPLEMENTATION OF THE EROSION, SEDIMENTATION AND POLLUTION CONTROL PLAN, AND ACTIONS TAKEN IN ACCORDANCE WITH PART IV.D.4.a.(4). OF THE PERMIT SHALL BE MADE AND RETAINED AT THE SITE OR BE READILY AVAILABLE AT A DESIGNATED ALTERNATE LOCATION UNTIL THE ENTIRE SITE OR THAT PORTION OF A CONSTRUCTION PROJECT THAT HAS BEEN PHASED HAS UNDERGONE FINAL STABILIZATION AND A NOTICE OF TERMINATION IS SUBMITTED TO EPD. SUCH REPORTS SHALL IDENTIFY ANY INCIDENTS OF NON-COMPLIANCE. WHERE THE REPORT DOES NOT IDENTIFY ANY INCIDENTS OF NON-COMPLIANCE, THE REPORT SHALL CONTAIN A CERTIFICATION THAT THE CONSTRUCTION SITE IS IN COMPLIANCE WITH THE EROSION, SEDIMENTATION AND POLLUTION CONTROL PLAN AND THIS PERMIT. THE REPORT SHALL BE SIGNED IN ACCORDANCE WITH PART V.G. OF THIS PERMIT.

MAINTENANCE

THE CONTRACTOR WILL IMPLEMENT ROUTINE MAINTENANCE PROCEDURES, SUCH AS REMOVING SILT AT SILT BARRIERS WHEN THE ACCUMULATION REACHES FIFTY PERCENT OF CAPACITY, TO ENSURE THAT THE BMPS WILL FUNCTION AS INTENDED THROUGHOUT THE DURATION OF THE PROJECT. WITHIN 48 HOURS FOLLOWING EACH INSPECTION, ANY REQUIRED MAINTENANCE MUST BE COMPLETED. MAINTENANCE OF EACH EROSION AND SEDIMENT CONTROL DEVICE WILL BE PERFORMED THROUGHOUT THE CONSTRUCTION PERIOD AND UNTIL FINAL STABILIZATION IS ACHIEVED.

TOTAL DISTURBED AREA = 4.79 ACRES

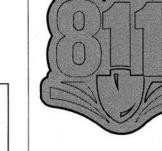

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DATE:

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31247-010 HAZEN NO .: CONTRACT NO.: 22B4413-02 DRAWING NUMBER:

MAY 2019

C012

STEWART MILL ROAD SANITARY SEWER REPLACEMENT PROJECT

DOUGLASVILLE-DOUGLAS COUNTY

WATER AND SEWER AUTHORITY

 \approx

Georgia Soil and Water Conservation Commission

Expires: <u>02/01/2020</u>

Level II Certified Design Professional

GSWCC

Certification Number:

EROSION SEDIMENTATION PLAN CIVIL NOTES

24-HOUR CONTACT

NAME: MIGUEL A. BACA, P.E

PHONE: (770) 920-3819

Hazen B. MOSS **DESIGNED BY:** S. KANE DRAWN BY 100% SUBMITTAL D. EHRHARDT CHECKED BY: HAZEN AND SAWYER IF THIS BAR DOES NOT SUITE D-520 MEASURE 1" THEN DRAWING ATLANTA, GA 30342 S NOT TO FULL SCALE DATE ISSUED FOR

D. EHRHARD

ENGINEER:

5775 PEACHTREE DUNWOODY ROAD,

AND POLLUTION CONTROL

OWNER/PRIMARY PERMITTER

8763 HOSPITAL DRIVE

PH. (770) 920-3819 MBACA@DDCWSA.COM

DOUGLASVILLE, GA 30134

DOUGLASVILLE-DOUGLAS COUNTY WATER AND SEWER AUTHORITY

THE PERMIT REQUIRES THE MONITORING OF NEPHELOMETRIC TURBIDITY IN RECEIVING WATER(S) OR OUTFALLS IN ACCORDANCE WITH

RECEIVING WATER SAMPLES AND STORM WATER DISCHARGE SAMPLES WILL BE COLLECTED BY GRAB SAMPLES AND THE ANALYSIS OF THESE SAMPLES MUST BE CONDUCTED IN ACCORDANCE WITH METHODOLOGY AND TEST PROCEDURES SPECIFIED BY THE PERMIT. THE FREQUENCY OF SAMPLING WILL BE AS DESCRIBED IN THE FOLLOWING SECTION. SAMPLING AND ANALYSIS OF THE RECEIVING WATER(S) OR OUTFALLS BEYOND THE MINIMUM FREQUENCY STATED BELOW WILL BE REPORTED TO THE EPD.

- SAMPLE CONTAINERS WILL BE LABELED BEFORE COLLECTING SAMPLES.
- SAMPLES WILL BE WELL MIXED BEFORE TRANSFERRING TO A SECONDARY CONTAINER.
- 3. CLEAN GLASS OR PLASTIC JARS WITH LARGE MOUTHS WILL BE USED TO COLLECT SAMPLES. THE JARS SHOULD BE CLEANED THOROUGHLY TO AVOID CONTAMINATION.
- 4. MANUAL, AUTOMATIC OR RINSING STAGE SAMPLING MAY BE UTILIZED. SAMPLES REQUIRED BY THE PERMIT SHOULD BE ANALYZED IMMEDIATELY, BUT IN NO CASE LATER THAN 48 HOURS AFTER COLLECTION. HOWEVER, SAMPLES FROM AUTOMATIC SAMPLERS MUST BE COLLECTED NO LATER THAN THE NEXT BUSINESS DAY AFTER THEIR ACCUMULATION, UNLESS FLOW THROUGH AUTOMATED ANALYSIS IS UTILIZED. DILUTION OF SAMPLES IS NOT REQUIRED. SAMPLES MAY BE ANALYZED DIRECTLY WITH A PROPERLY CALIBRATED TURBIDIMETER. SAMPLES ARE NOT REQUIRED TO BE COOLED.
- 5. SAMPLING AND ANALYSIS OF THE RECEIVING WATER(S) OR OUTFALL BEYOND THE MINIMUM FREQUENCY STATED IN THE PERMIT MUST BE REPORTED TO EPD.

SAMPLING POINTS

THE CONTRACTOR WILL SAMPLE UNNAMED TRIBUTARIES AND CREEKS AT THE LOCATIONS LISTED BELOW. THE PLAN SHEETS WITHIN THESE CONSTRUCTION PLANS SHOW THE LOCATION OF ALL PERENNIAL AND INTERMITTENT STREAMS AND OTHER WATER BODIES INTO WHICH STORM WATER IS DISCHARGED, AND THE SAMPLING LOCATIONS FOR EACH REPRESENTATIVE STORM WATER OUTFALL.

 SAMPLE LOCATIONS 1 THROUGH 4 - AT THE CENTERLINE OF ANNAEEWAKEE CREEK AND AT THE CENTERLINE OF UNNAMED TRIBUTARY TO ANNAEEWAKEE CREEK

UPSTREAM:	1: LATITUDE: 33°42'48.04"N	LONGITUDE: 84°44'26.01"W	(NEAR HEADWALL)
	2: LATITUDE: 33°42'46.51"N	LONGITUDE: 84°44'26.17"W	(NEAR CONFLUENCE)
DOWNSTREAM:	3: LATITUDE: 33°42'46.77"N	LONGITUDE: 84°44'15.87"W	(NEAR SANDBAG DIVERSION)
	4: LATITUDE: 33°42'50.66"N	LONGITUDE: 84°44'09.06"W	(DOWNSTREAM OF TEMP

IT SHOULD BE NOTED THAT ALL OF THE ABOVE SAMPLING LOCATIONS MAY NOT BE ACTIVE AT ALL TIMES DURING CONSTRUCTION OF THE PROJECT. A SAMPLING LOCATION WILL BE ACTIVE FROM THE TIME CONSTRUCTION ACTIVITY STARTS IN THE WATERSHED THAT FEEDS THE SAMPLING LOCATION UNTIL FINAL STABILIZATION IS ACHIEVED IN THAT WATERSHED. THE TIMING OF THE CONSTRUCTION ACTIVITY WITHIN A WATERSHED DEPENDS ON CONSTRUCTION STAGING. HOWEVER, CONSTRUCTION STAGING HAS NOT YET BEEN DETERMINED THE CONTRACTOR MAY STAGE THE CONSTRUCTION SO THAT 1) CONSTRUCTION BEGINS AT ONE END OF THE PROJECT AND PROGRESSES SYSTEMATICALLY TO THE OTHER END; 2) CONSTRUCTION BEGINS AT BOTH ENDS OF THE PROJECT AND PROGRESSES TO A COMMON MEETING POINT; OR 3) MULTIPLE CREWS BEGIN CONSTRUCTION AT DIFFERENT SECTIONS OF THE PROJECT AND EVENTUALLY LINK UP WITH EACH OTHER.

STREAM CROSSING)

 SAMPLING WILL BEGIN AT THE DESIGNATED REPRESENTATIVE RECEIVING WATER(S) AT THE DOWNSTREAM LOCATION. THIS SAMPLE WILL BE TAKEN AT THE DISCHARGE FARTHEST DOWNSTREAM AT THE SITE BUT UPSTREAM OF ANY OTHER STORM WATER DISCHARGE NOT ASSOCIATED WITH THE PROJECT. FOR LARGE STREAMS WHERE VARIATIONS IN COLOR ARE VISIBLE, SEVERAL DOWNSTREAM SAMPLES FROM ACROSS THE RECEIVING WATER(S) MAY BE TAKEN AND THE ARITHMETIC AVERAGE OF THE TURBIDITY OF THESE SAMPLES MAY BE USED FOR THE DOWNSTREAM VALUE.

- UPSTREAM SAMPLES WILL BE TAKEN AFTER DOWNSTREAM SAMPLES HAVE BEEN ACQUIRED. THE UPSTREAM SAMPLE WILL BE TAKEN AT THE DISCHARGE FARTHEST UPSTREAM AT THE SITE BUT DOWNSTREAM OF ANY OTHER STORM WATER DISCHARGES NOT ASSOCIATED WITH THE PROJECT. WHERE APPROPRIATE, SEVERAL UPSTREAM SAMPLES FROM ACROSS THE RECEIVING WATER(S) MAY BE TAKEN AND THE ARITHMETIC AVERAGE OF THE TURBIDITY OF THESE SAMPLES MAY BE USED FOR THE UPSTREAM VALUE. THE SAMPLES WILL BE TAKEN FROM THE HORIZONTAL AND VERTICAL CENTER OF THE RECEIVING WATER(S) OR THE STORM WATER
- OUTFALL CHANNEL(S). CARE WILL BE TAKEN TO AVOID STIRRING THE BOTTOM SEDIMENTS IN THE RECEIVING WATER(S) OR IN THE OUTFALL STORM WATER
- THE SAMPLING CONTAINER WILL BE HELD SO THAT THE OPENING FACES UPSTREAM.
- THE SAMPLES WILL BE KEPT FREE OF FLOATING DEBRIS.
- ONCE THE SAMPLE JAR OR BOTTLE IS FULL AND CAPPED, IT WILL BE TRANSPORTED TO THE LOCATION WHERE THE TURBIDITY TESTING WILL BE CONDUCTED. ALL TURBIDITY TESTS WILL BE CONDUCTED IMMEDIATELY, BUT NO LATER THAN 48 HOURS AFTER THE TIME THE SAMPLE WAS OBTAINED.

THE CONTRACTOR MUST SAMPLE IN ACCORDANCE WITH THIS ES&PCP AT LEAST ONCE FOR EACH RAINFALL EVENT DESCRIBED BELOW:

- a. FOR EACH AREA OF THE SITE THAT DISCHARGES TO A RECEIVING STREAM, THE FIRST RAIN EVENT THAT REACHES OR EXCEEDS 0.5 INCH AND ALLOWS FOR MONITORING DURING NORMAL BUSINESS HOURS* (MONDAY THROUGH FRIDAY, 8:00 AM TO 5:00 PM AND SATURDAY 8:00 AM TO 5:00 PM, EXCLUDING ALL NONWORKING FEDERAL HOLIDAYS, WHEN CONSTRUCTION ACTIVITY IS BEING CONDUCTED BY THE PRIMARY PERMITTEE) THAT OCCURS AFTER ALL CLEARING AND GRUBBING OPERATIONS HAVE BEEN COMPLETED IN THE DRAINAGE AREA OF THE LOCATION SELECTED AS THE REPRESENTATIVE SAMPLING LOCATION;
- b. IN ADDITION TO ITEM A) ABOVE, FOR EACH AREA OF THE SITE THAT DISCHARGES TO A RECEIVING STREAM, THE FIRST RAIN EVENT THAT REACHES OR EXCEEDS 0.5 INCH AND ALLOWS FOR MONITORING DURING NORMAL BUSINESS HOURS* THAT OCCURS EITHER 90 DAYS AFTER THE FIRST SAMPLING EVENT OR AFTER ALL MASS GRADING OPERATIONS HAVE BEEN COMPLETED IN THE DRAINAGE AREA OF THE LOCATION SELECTED AS THE REPRESENTATIVE SAMPLING LOCATION, WHICHEVER COMES FIRST;
- AT THE TIME OF SAMPLING PERFORMED PURSUANT TO ITEMS A) AND B) ABOVE, IF BMPS ARE FOUND TO BE PROPERLY DESIGNED, INSTALLED, AND MAINTAINED, NO FURTHER ACTION IS REQUIRED. IF BMPS IN ANY AREA OF THE SITE THAT DISCHARGES TO A RECEIVING STREAM ARE NOT PROPERLY DESIGNED, INSTALLED, AND MAINTAINED, CORRECTIVE ACTION SHALL BE DEFINED AND IMPLEMENTED WITHIN TWO BUSINESS DAYS, AND TURBIDITY SAMPLES SHALL BE TAKEN FROM DISCHARGES FROM THAT AREA OF THE SITE FOR EACH SUBSEQUENT RAIN EVENT THAT REACHES OR EXCEEDS 0.5 INCH DURING NORMAL BUSINESS HOURS* UNTIL THE SELECTED TURBIDITY STANDARD IS ATTAINED, OR UNTIL POST-STORM EVENT INSPECTIONS DETERMINE THAT BMPS ARE
- PROPERLY DESIGNED, INSTALLED, AND MAINTAINED. d. EXISTING CONSTRUCTION ACTIVITIES, i.e., THOSE THAT ARE OCCURRING ON OR BEFORE THE EFFECTIVE DATE OF THIS PERMIT THAT HAVE MET THE SAMPLING REQUIRED BY (a) ABOVE SHALL SAMPLE IN ACCORDANCE WITH (b). THOSE EXISTING CONSTRUCTION ACTIVITIES THAT HAVE MET THE SAMPLING REQUIRED BY(b) ABOVE SHALL NOT BE REQUIRED TO CONDUCT

ADDITIONAL SAMPLING OTHER THAN AS REQUIRED BY (c) ABOVE. *NOTE THAT THE CONTRACTOR MAY CHOOSE TO MEET THE REQUIREMENTS OF A) AND B) ABOVE BY COLLECTING TURBIDITY SAMPLES FROM ANY RAIN EVENT THAT REACHES OR EXCEEDS 0.5 INCH AND ALLOWS FOR MONITORING AT ANY TIME OF THE DAY OR WEEK.

MEASUREMENT OF RAINFALL DATA WILL BE RECORDED DAILY (ONCE DURING EACH 24-HOUR PERIOD) AT THE DOWNSTREAM MONITORING POINT FOR EACH ACTIVE CONSTRUCTION STAGE IN WHICH STREAM MONITORING IS UTILIZED AND NEAR THE CENTER OF EACH ACTIVE CONSTRUCTION STAGE IN WHICH OUTFALL MONITORING IS UTILIZED. THE CONTRACTOR WILL ESTABLISH A RAIN GAUGE ON EACH ACTIVE CONSTRUCTION STAGE FOR THIS PURPOSE. FURTHERMORE, THE CONTRACTOR WILL COLLECT AND RECORD THE RAINFALL DATA ON THE DAILY RAINFALL MONITORING DATA FORM.

THE CONTRACTOR WILL EMPLOY QUALIFIED PERSONNEL WHO SHALL GATHER SAMPLES OF STORM WATER AS OUTLINED IN THE PERMIT PART IV, D.5 AND AS FURTHER DEFINED IN THIS ESPCP. THE CONTRACTOR WILL HAVE THE TURBIDITY OF EACH SAMPLE TESTED BY A

QUAILIFIED TESTING LABORATORY.

ALL TURBIDITY TESTS WILL BE CONDUCTED IN ACCORDANCE WITH 40 CFR PART 136 (UNLESS OTHER TEST PROCEDURES HAVE BEEN APPROVED); THE GUIDANCE DOCUMENT TITLED "NPDES STORM WATER SAMPLING GUIDANCE DOCUMENT, EPA 833-B-92-001 AND GUIDANCE DOCUMENTS THAT MAY BE PREPARED BY THE EPD.

NTU LIMIT RATIONAL

THE CONTRACTOR SHALL SAMPLE THE RECEIVING STREAM BOTH UPSTREAM OF THE PROJECT AREA AND DOWNSTREAM OF THE PROJECT AREA. THE TOTAL INCREASE IN TURBIDITY FROM SAMPLE LOCATIONS UPSTREAM AND DOWNSTREAM OF THE CONSTRUCTION SITE SHALL NOT EXCEED 25 NTU.

(SIDE NOTE: THE VALUE OF NTU CHANGES WITH TYPE OF RIVER AND WHAT KIND OF STREAM IT IS. FOR THIS PROJECT IT IS 25, BUT MAY NOT BE FOR OTHERS)

THE CONTRACTOR SHALL SUBMIT A SUMMARY OF THE MONITORING RESULTS TO THE APPROPRIATE DISTRICT OFFICE OF THE EPD ACCORDING TO THE LIST IN APPENDIX A OF THE PERMIT BY THE FIFTEENTH DAY OF THE MONTH FOLLOWING THE REPORTING PERIOD. REPORTING PERIODS ARE MONTHS DURING WHICH SAMPLES ARE TAKEN IN ACCORDANCE WITH THE PERMIT. SAMPLING RESULTS SHALL BE IN A CLEARLY LEGIBLE FORMAT. UPON WRITTEN NOTIFICATION, THE EPD MAY REQUIRE THE CONTRACTOR TO SUBMIT THE SAMPLING RESULTS ON A MORE FREQUENT BASIS. SAMPLING AND ANALYSIS OF ANY STORM WATER DISCHARGE(S) OR THE RECEIVING WATER(S) BEYOND THE MINIMUM FREQUENCY STATED IN THIS PERMIT MUST BE REPORTED IN A SIMILAR MANNER TO THE EPD. THE SAMPLING REPORTS MUST BE SIGNED IN ACCORDANCE WITH PART V.G OF THE PERMIT. SAMPLING REPORTS MUST BE SUBMITTED TO THE EPD UNTIL SUCH TIME AS A NOTICE OF TERMINATION IS SUBMITTED IN ACCORDANCE WITH PART VI OF THE PERMIT.

IN ADDITION TO OTHER RECORD-KEEPING REQUIREMENTS, THE MONITORING INFORMATION SHALL INCLUDE:

- THE DATE, EXACT PLACE, AND TIME OF SAMPLING OR MEASUREMENTS;
- THE NAME(S) OF THE INDIVIDUAL(S) WHO PERFORMED THE SAMPLING AND MEASUREMENTS;
- THE DATE(S) ANALYSES WERE PERFORMED; d. THE TIME(S) ANALYSES WERE INITIATED;
- e. THE NAME(S) OF THE INDIVIDUAL(S) WHO PERFORMED THE ANALYSES;
- REFERENCES AND WRITTEN PROCEDURES, WHEN AVAILABLE, FOR THE ANALYTICAL TECHNIQUES OR METHODS USED;
- THE RESULTS OF SUCH ANALYSES, INCLUDING THE BENCH SHEETS, INSTRUMENT READOUTS, COMPUTER DISKS OR TAPES, ETC., USED TO DETERMINE THESE RESULTS; AND
- h. RESULTS THAT EXCEED 1,000 NTU SHALL BE REPORTED AS "EXCEEDS 1,000 NTU."

THE CONTRACTOR MUST RETAIN COPIES OF ALL MONITORING RESULTS AND SHALL PROVIDE THE OWNER WITH COPIES OF ALL MONITORING RESULTS.

ALL WRITTEN CORRESPONDENCE REQUIRED BY THE PERMIT SHALL BE SUBMITTED BY RETURN RECEIPT CERTIFIED MAIL (OR SIMILAR SERVICE) TO THE APPROPRIATE DISTRICT OFFICE OF THE EPD ACCORDING TO THE SCHEDULE IN APPENDIX A OF THE PERMIT. COPIES OF THE DATA SENT TO GEORGIA EPD, INCLUDING THE RETURN RECEIPTS, WILL BE PROVIDED TO THE OWNER AND THE ENGINEER

THE PRIMARY PERMITTEE SHALL RETAIN THE FOLLOWING RECORDS AT THE CONSTRUCTION SITE OR THE RECORDS SHALL BE READILY AVAILABLE AT A DESIGNATED ALTERNATE LOCATION FROM COMMENCEMENT OF CONSTRUCTION UNTIL SUCH TIME AS A NOTICE OF TERMINATION IS SUBMITTED IN ACCORDANCE WITH PART VI:

- a. A COPY OF ALL NOTICES OF INTENT SUBMITTED TO EPD;
- b. A COPY OF THE EROSION, SEDIMENTATION AND POLLUTION CONTROL PLAN REQUIRED BY
- c. THE DESIGN PROFESSIONAL'S REPORT OF THE RESULTS OF THE INSPECTION CONDUCTED IN ACCORDANCE WITH PART IV.A.5. OF THIS PERMIT;
- d. A COPY OF ALL MONITORING INFORMATION, RESULTS, AND REPORTS REQUIRED BY THIS
- e. A COPY OF ALL INSPECTION REPORTS GENERATED IN ACCORDANCE WITH PART IV.D.4.a. OF
- f. A COPY OF ALL VIOLATION SUMMARIES AND VIOLATION SUMMARY REPORTS GENERATED IN
- ACCORDANCE WITH PART III.D.2. OF THIS PERMIT; AND
- g. DAILY RAINFALL INFORMATION COLLECTED IN ACCORDANCE WITH PART IV.D.4.a.(1)(c) OF

COPIES OF ALL NOTICES OF INTENT, NOTICES OF TERMINATION, REPORTS, PLANS, MONITORING REPORTS, MONITORING INFORMATION, INCLUDING ALL CALIBRATION AND MAINTENANCE RECORDS AND ALL ORIGINAL STRIP CHART RECORDINGS FOR CONTINUOUS MONITORING INSTRUMENTATION, EROSION, SEDIMENTATION AND POLLUTION CONTROL PLANS, RECORDS OF ALL DATA USED TO COMPLETE THE NOTICE OF INTENT TO BE COVERED BY THIS PERMIT AND ALL OTHER RECORDS REQUIRED BY THIS PERMIT SHALL BE RETAINED BY THE PERMITTEE WHO EITHER PRODUCED OR USED IT FOR A PERIOD OF AT LEAST THREE YEARS FROM THE DATE THAT THE NOT IS SUBMITTED IN ACCORDANCE WITH PART VI OF THIS PERMIT. THESE RECORDS MUST BE MAINTAINED AT THE PERMITTEE'S PRIMARY PLACE OF BUSINESS OR AT A DESIGNATED ALTERNATIVE LOCATION ONCE THE CONSTRUCTION ACTIVITY HAS CEASED AT THE PERMITTED SITE. THIS PERIOD MAY BE EXTENDED BY REQUEST OF THE EPD AT ANY TIME UPON WRITTEN NOTIFICATION TO THE PERMITTEE.

Georgia Soil and Water Conservation Commission GSWCC Alan E Bowling Level II Certified Design Professional Expires: <u>02/01/2020</u> Issued: 08/10/2008

OWNER/PRIMARY PERMITTEE: DOUGLASVILLE-DOUGLAS COUNTY WATER AND SEWER AUTHORITY 8763 HOSPITAL DRIVE DOUGLASVILLE, GA 30134 PH. (770) 920-3819 MBACA@DDCWSA.COM

24-HOUR CONTACT NAME: MIGUEL A. BACA, P.E. PHONE: (770) 920-3819

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CALL BEFORE YOU DIG! 1.800.282.7411 DATE:

PROJECT D. EHRHARDT **ENGINEER: DESIGNED BY:** B. MOSS J. JORDAN DRAWN BY: D. EHRHARD CHECKED BY: IF THIS BAR DOES NOT MEASURE 1" THEN DRAWING 0 1/2"

ISSUED FOR

IS NOT TO FULL SCALE

100% SUBMITTAL

Hazen **HAZEN AND SAWYER 5775 PEACHTREE DUNWOODY ROAD,** SUITE D-520 ATLANTA, GA 30342

DOUGLASVILLE-DOUGLAS COUNTY WATER AND SEWER AUTHORITY

STEWART MILL ROAD SANITARY SEWER REPLACEMENT PROJECT





EROSION SEDIMENTATION AND POLLUTION CONTROL **PLAN CIVIL NOTES**

MAY 2019 31247-010 HAZEN NO .: CONTRACT NO .: 22B4413-02 DRAWING NUMBER: C013

CALL BEFORE YOU DIG.
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IT'S THE LAW ES LA LEY



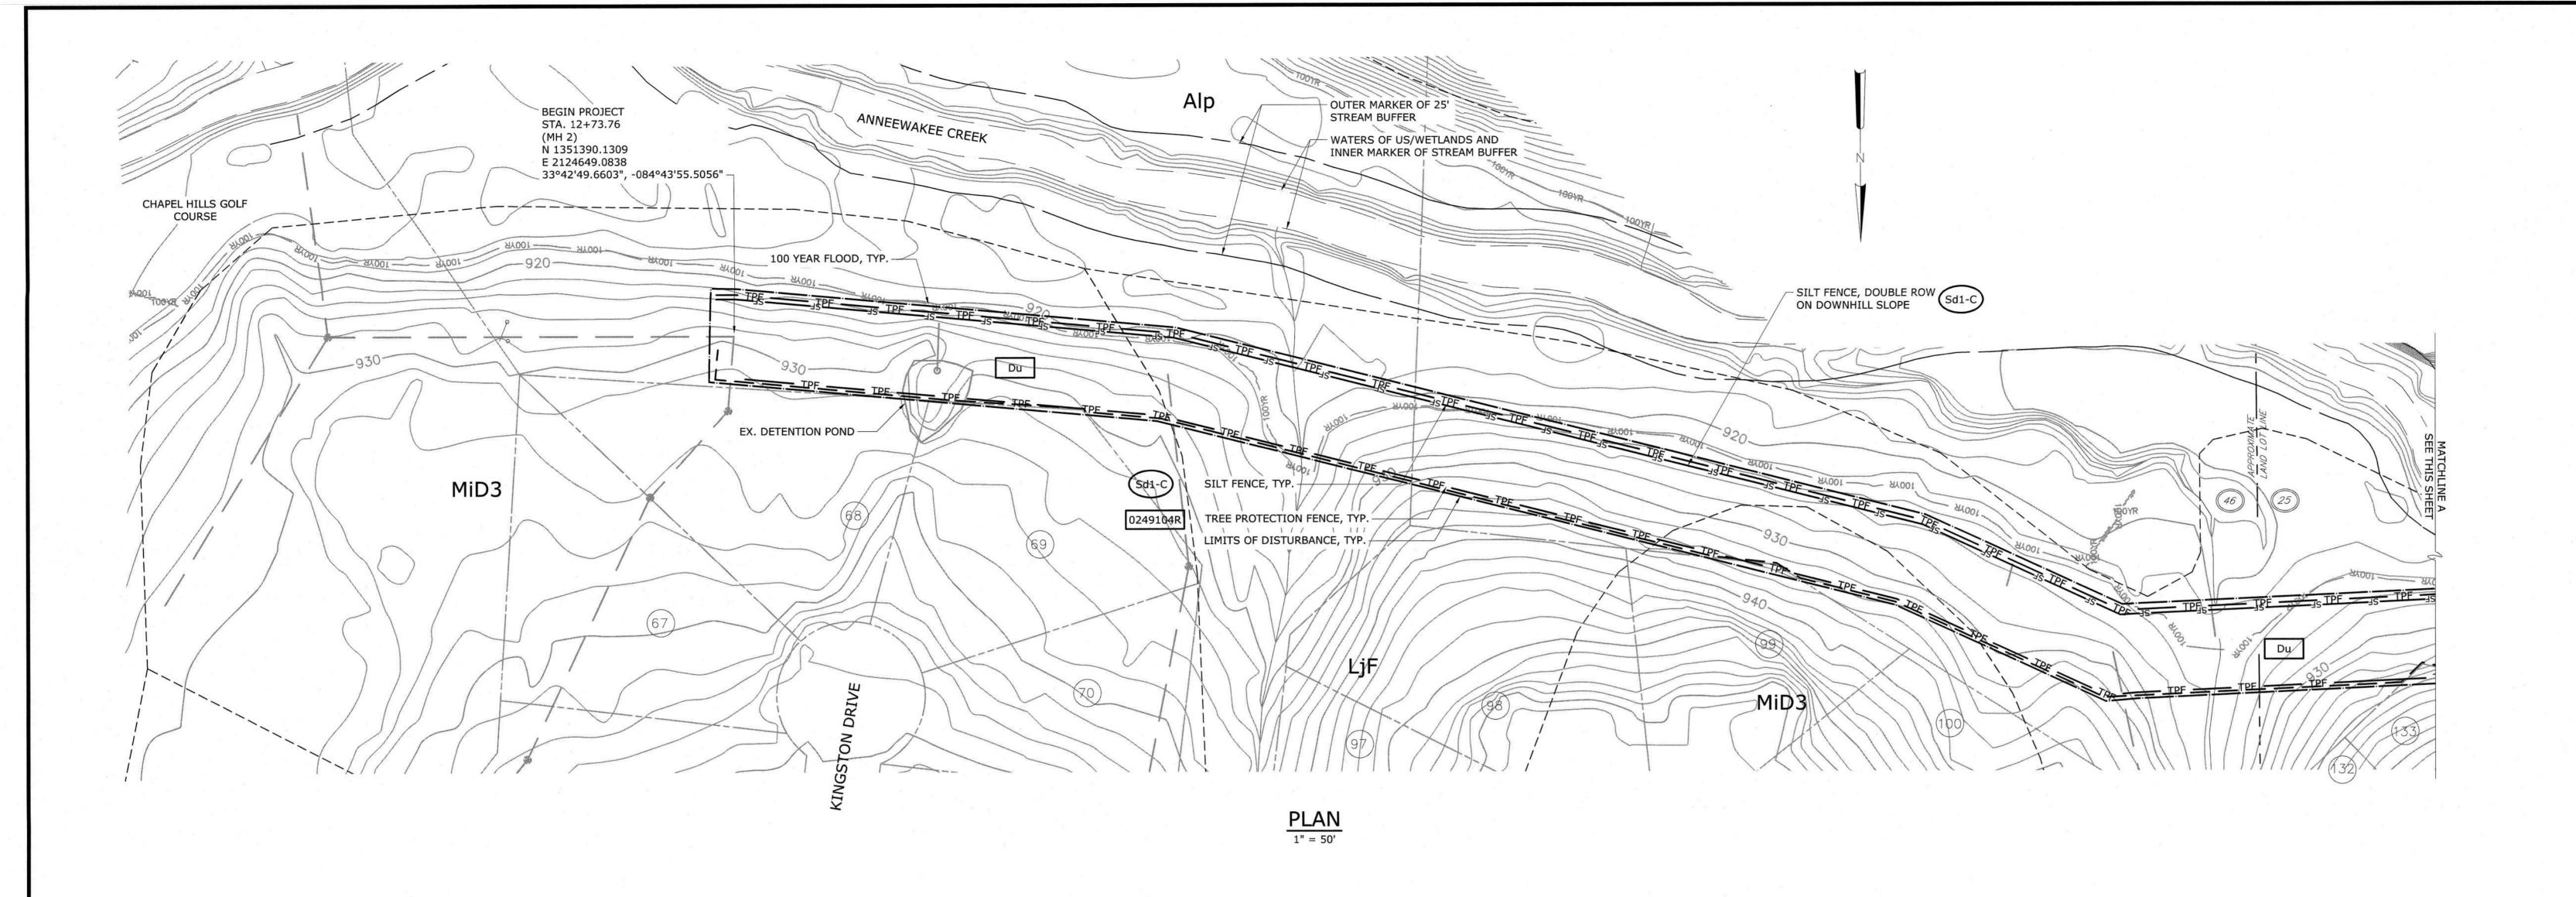

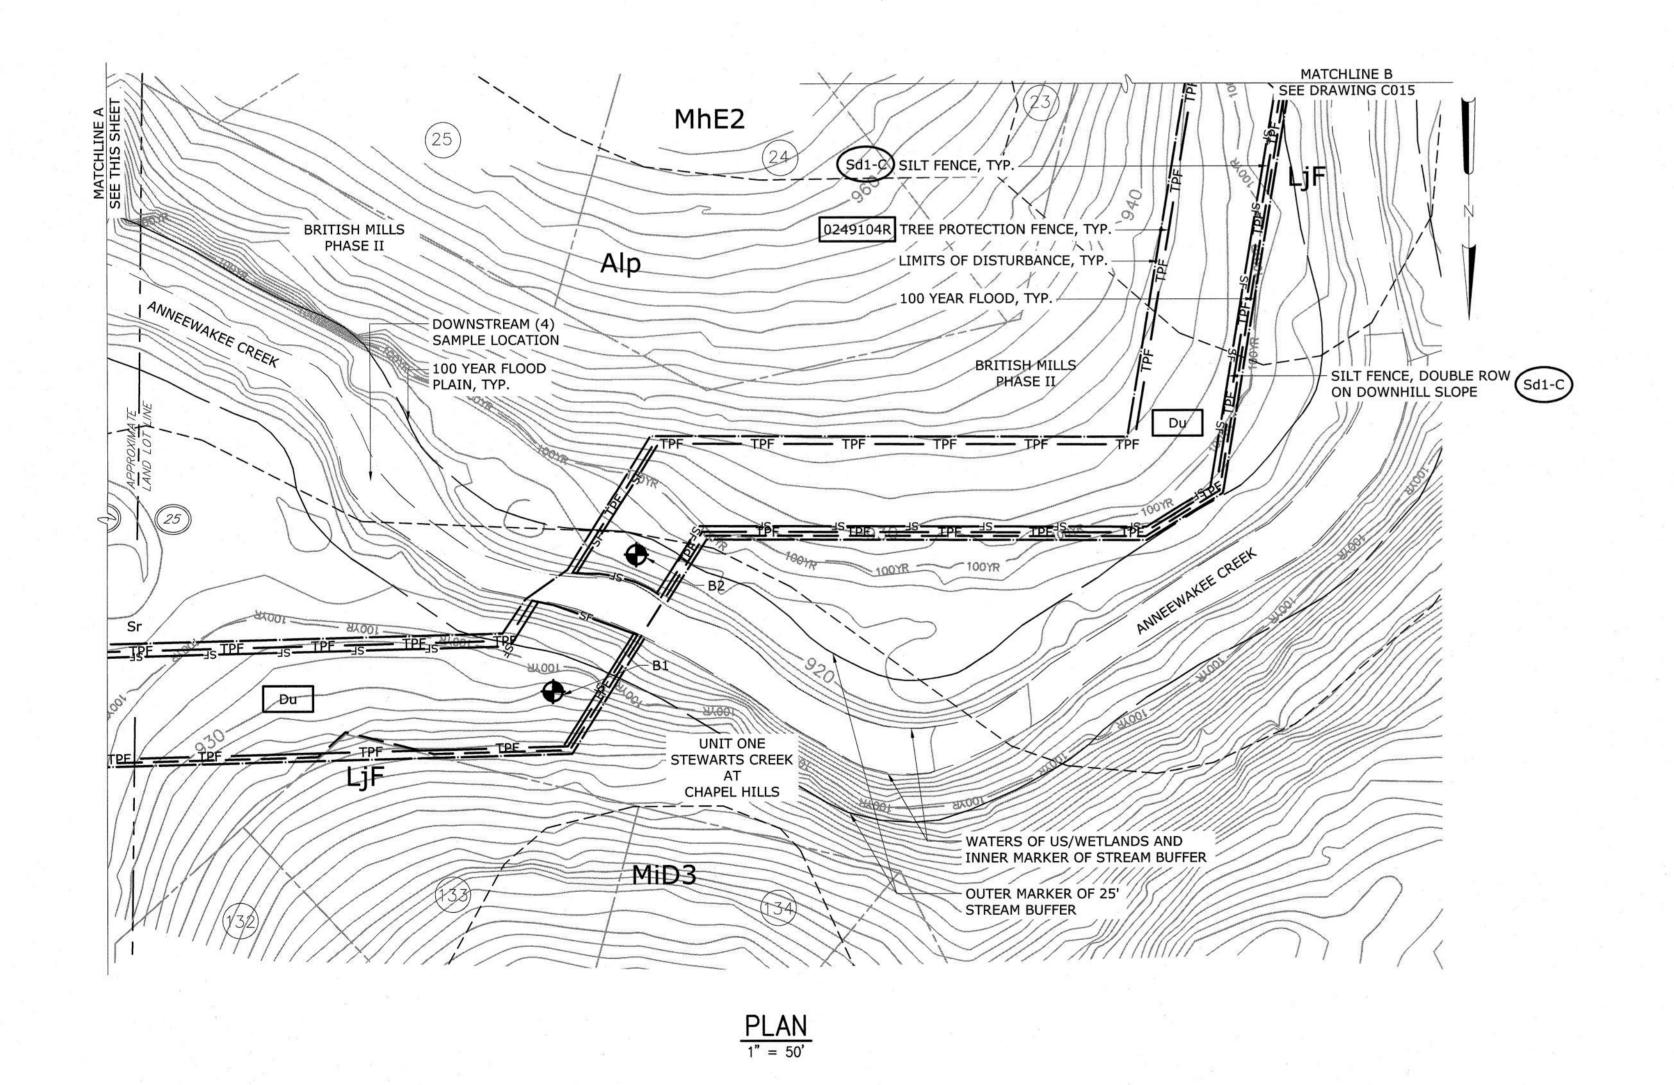100% SUBMITTAL



(6)	SOIL SERIES AND	DEFINITIONS	
Alp	ALLUVIAL LAND		SOMEWHAT POORLY DRAINED
LjF	LOUSIA FINE SANDY LOAM	25-40% SLOPES	
MiD3	MADISON GRAVELLY SANDY CLAY LOAM	10-15% SLOPES	SEVERELY ERODED

SILT FENCE STORAGE CALCULATIONS:
TOTAL SILT FENCE TO BE INSTALLED = 3,210 LF
16.75 CY OF STORAGE PER 100 LF OF SILT FENCE
(3,210LF / 100 LF) * 16.75 CY = 537.668 CY OF STORAGE
TOTAL DISTURBED AREA = 4.79 ACRES x 67 CY/AC
TOTAL STORAGE REQUIRED = 320.93 CY
TOTAL STORAGE PROVIDED = 537.68 CY, SITE COMPLIES WITE GEORGIA EROSION CONTROL CRITERIA.

ACTIVITY				
ACTIVITY	Q 1	Q 2	Q 3	Q 4
INSTALL CONSTRUCTION EXIT, SILT FENCE, & TREE PROTECTION FENCE	х			6
PRELIMINARY SITEWORK	X			
INSTALL GRADING PHASE EROSION MEASURES	X			
FACILITY CONSTRUCTION		X	X	
TEMPORARY GRASSING		X	X	
CURB/GUTTER & PAVEMENT			Х	X
FINE GRADING			X	X
FINAL GRASSING				X
REMOVE TEMPORARY EROSION MEASURES & TREE PROTECTION FENCE				х

APPROXIMATE LIMITS OF DISTURBANCE

---- APPROXIMATE LINE OF SOILS SERIES DELINEATION

SILT FENCE, TYPE "C", SINGLE ROW

WATERS OF THE US/WETLANDS

TPF TREE PROTECTION FENCE

LINETYPE KEY:

Georgia Soil and Water Conservation Commission

Alan E Bowling
Level II Certified Design Professional

Certification Number: 000000432 Expires: 02/01/2020 Issued: 08/10/2008

OWNER/PRIMARY PERMITTEE:
DOUGLASVILLE-DOUGLAS COUNTY
WATER AND SEWER AUTHORITY
8763 HOSPITAL DRIVE
DOUGLASVILLE, GA 30134
PH. (770) 920-3819
MBACA@DDCWSA.COM

24-HOUR CONTACT

NAME: MIGUEL A. BACA, P.E.

NAME: MIGUEL A. BACA, P.E PHONE: (770) 920-3819 KNOW WHAT'S BELOW.

CALL BEFORE YOU DIG.
LLAME ANTES DE CAVAR.

IT'S THE LAW.
ES LA LEY

TOTAL DISTURBED AREA = 4.79 ACRES

NO WASTE SHALL BE DISPOSED OF INTO STORMWATER

2. THE ESCAPE OF SEDIMENT FROM THE SITE SHALL BE

TO, OR CONCURRENT WITH, LAND DISTURBING

PREVENTED BY THE INSTALLATION OF EROSION AND

3. EROSION CONTROL MEASURES SHALL BE MAINTAINED AT ALL TIMES. IF FULL IMPLEMENTATION OF THE APPROVED

PLAN DOES NOT PROVIDE FOR EFFECTIVE EROSION

TEMPORARY VEGETATION OR MULCH IF LAND-DISTURBING ACTIVITIES CEASE FOR MORE THAN 14 CALENDAR DAYS.

CONTROL, ADDITIONAL EROSION AND SEDIMENT CONTROL MEASURES SHALL BE IMPLEMENTED TO

CONTROL OR TREAT THE SEDIMENT SOURCE.

4. DISTURBED AREAS SHALL BE STABILIZED WITH

5. ALL ENVIRONMENTAL BUFFERS SHALL BE CLEARLY DELINEATED IN THE FIELD BEFORE CLEARING AND

6. THE SOURCES OF INFORMATION FOR THE FLOODPLAIN

NEAREST THE PROJECT SITE ARE FEMA FIRM PANELS 153 FOR DOUGLAS COUNTY, GEORGIA AND INCORPORATED AREAS, MAP NUMBER 13097C0153C EFFECTIVE 8/18/2009

 STATE WATERS EXIST WITHIN 200 FEET OF THE LIMITS OF CONSTRUCTION ON THE PROJECT SITE. ANNEEWAKEE CREEK IS LOCATED TO THE ALONG THE PROJECT SITE, AND ITS 100-YEAR FLOODPLAIN IS LOCATED WITHIN THE

9. SEDIMENT STORAGE MAINTENANCE INDICATORS MUST BE

INSTALLED IN SEDIMENT STORAGE STRUCTURES,

10. CONCENTRATED FLOW AREAS AND ALL SLOPES STEEPER THAN 2.5:1 WITH A HEIGHT OF TEN FEET OR GREATER SHALL BE STABILIZED WITH THE APPROPRIATE EROSION

CONSTRUCTION ON THE PROJECT SITE ARE 0.06 AC.

CONTRACTOR TO PROVIDE INLET PROTECTION (Sd2-Bg)
 ON ALL STORM INLETS WITHIN LIMITS OF DISTURBANCE

13. THE DESIGN PROFESSIONAL WHO PREPARED THE ES&PC PLAN IS TO INSPECT THE INSTALLATION OF THE INITIAL

CONTROL BMPS, AND SEDIMENT BASINS IN ACCORDANCE WITH PART IV.A.5. WITHIN 7 DAYS AFTER INSTALLATION.

JURISDICTIONAL DETERMINATION LINE WITHOUT FIRST ACQUIRING THE NECESSARY VARIANCES AND PERMITS.

HAVE SIGNIFICANT EFFECT ON BMPS WITH A HYDRAULIC

WATERS OF THE STATE, EXCEPT AS AUTHORIZED BY A

GREATER THAN 14 DAYS SHALL BE STABILIZED WITH

15. AMENDMENTS/REVISIONS TO THE ES&PC PLAN WHICH

COMPONENT MUST BE CERTIFIED BY THE DESIGN

16. WASTE MATERIALS SHALL NOT BE DISCHARGED TO

17. ANY DISTURBED AREA LEFT EXPOSED FOR A PERIOD

SEDIMENT STORAGE REQUIREMENTS, PERIMETER

14. NON-EXEMPT ACTIVITIES SHALL NOT BE CONDUCTED WITHIN THE 25 OR 50-FOOT UNDISTURBED STREAM BUFFERS AS MEASURED FROM THE POINT OF WRESTED VEGETATION OR WITHIN 25-FEET OF THE COASTAL MARSHLAND BUFFER AS MEASURED FROM THE

OR WITHIN CLOSE PROXIMITY OF CONSTRUCTION

11. TOTAL WETLAND ACRES WITHIN THE LIMITS OF

SEDIMENT CONTROL MEASURES AND PRACTICES PRIOR

INLETS OR WATERS OF THE STATE.

ACTIVITIES.

GRUBBING BEGINS.

LIMITS OF THE PROJECT SITE.

INDICATING THE 1/3 FULL VOLUME.

CONTROL MATTING OR BLANKET.

ACTIVITIES.

PROFESSIONAL.

SECTION 404 PERMIT.

MULCH OR TEMPORARY SEEDING.

8. TOTAL PROJECT ACRES 4.79 AC.

CALL 811 BEFORE YOU DIG!

CALL BEFORE YOU DIG! 1.800.282.7411

PROJECT
ENGINEER:

DESIGNED BY:

DESIGNED BY:

DRAWN BY:

J. JORDAN

CHECKED BY:

D. EHRHARDT

IF THIS BAR DOES NOT
MEASURE 1" THEN DRAWING
IS NOT TO FULL SCALE

O 1/2" 1"



HAZEN AND SAWYER
5775 PEACHTREE DUNWOODY ROAD,
SUITE D-520

ATLANTA, GA 30342

DOUGLASVILLE-DOUGLAS COUNTY WATER AND SEWER AUTHORITY

STEWART MILL ROAD SANITARY SEWER
REPLACEMENT PROJECT



EROSION SEDIMENTATION AND POLLUTION

CONTROL PLAN

CIVIL


CLEARING PHASE

DATE: MAY 2019

HAZEN NO.: 31247-010


CONTRACT NO.: 22B4413-02

DRAWING NUMBER:

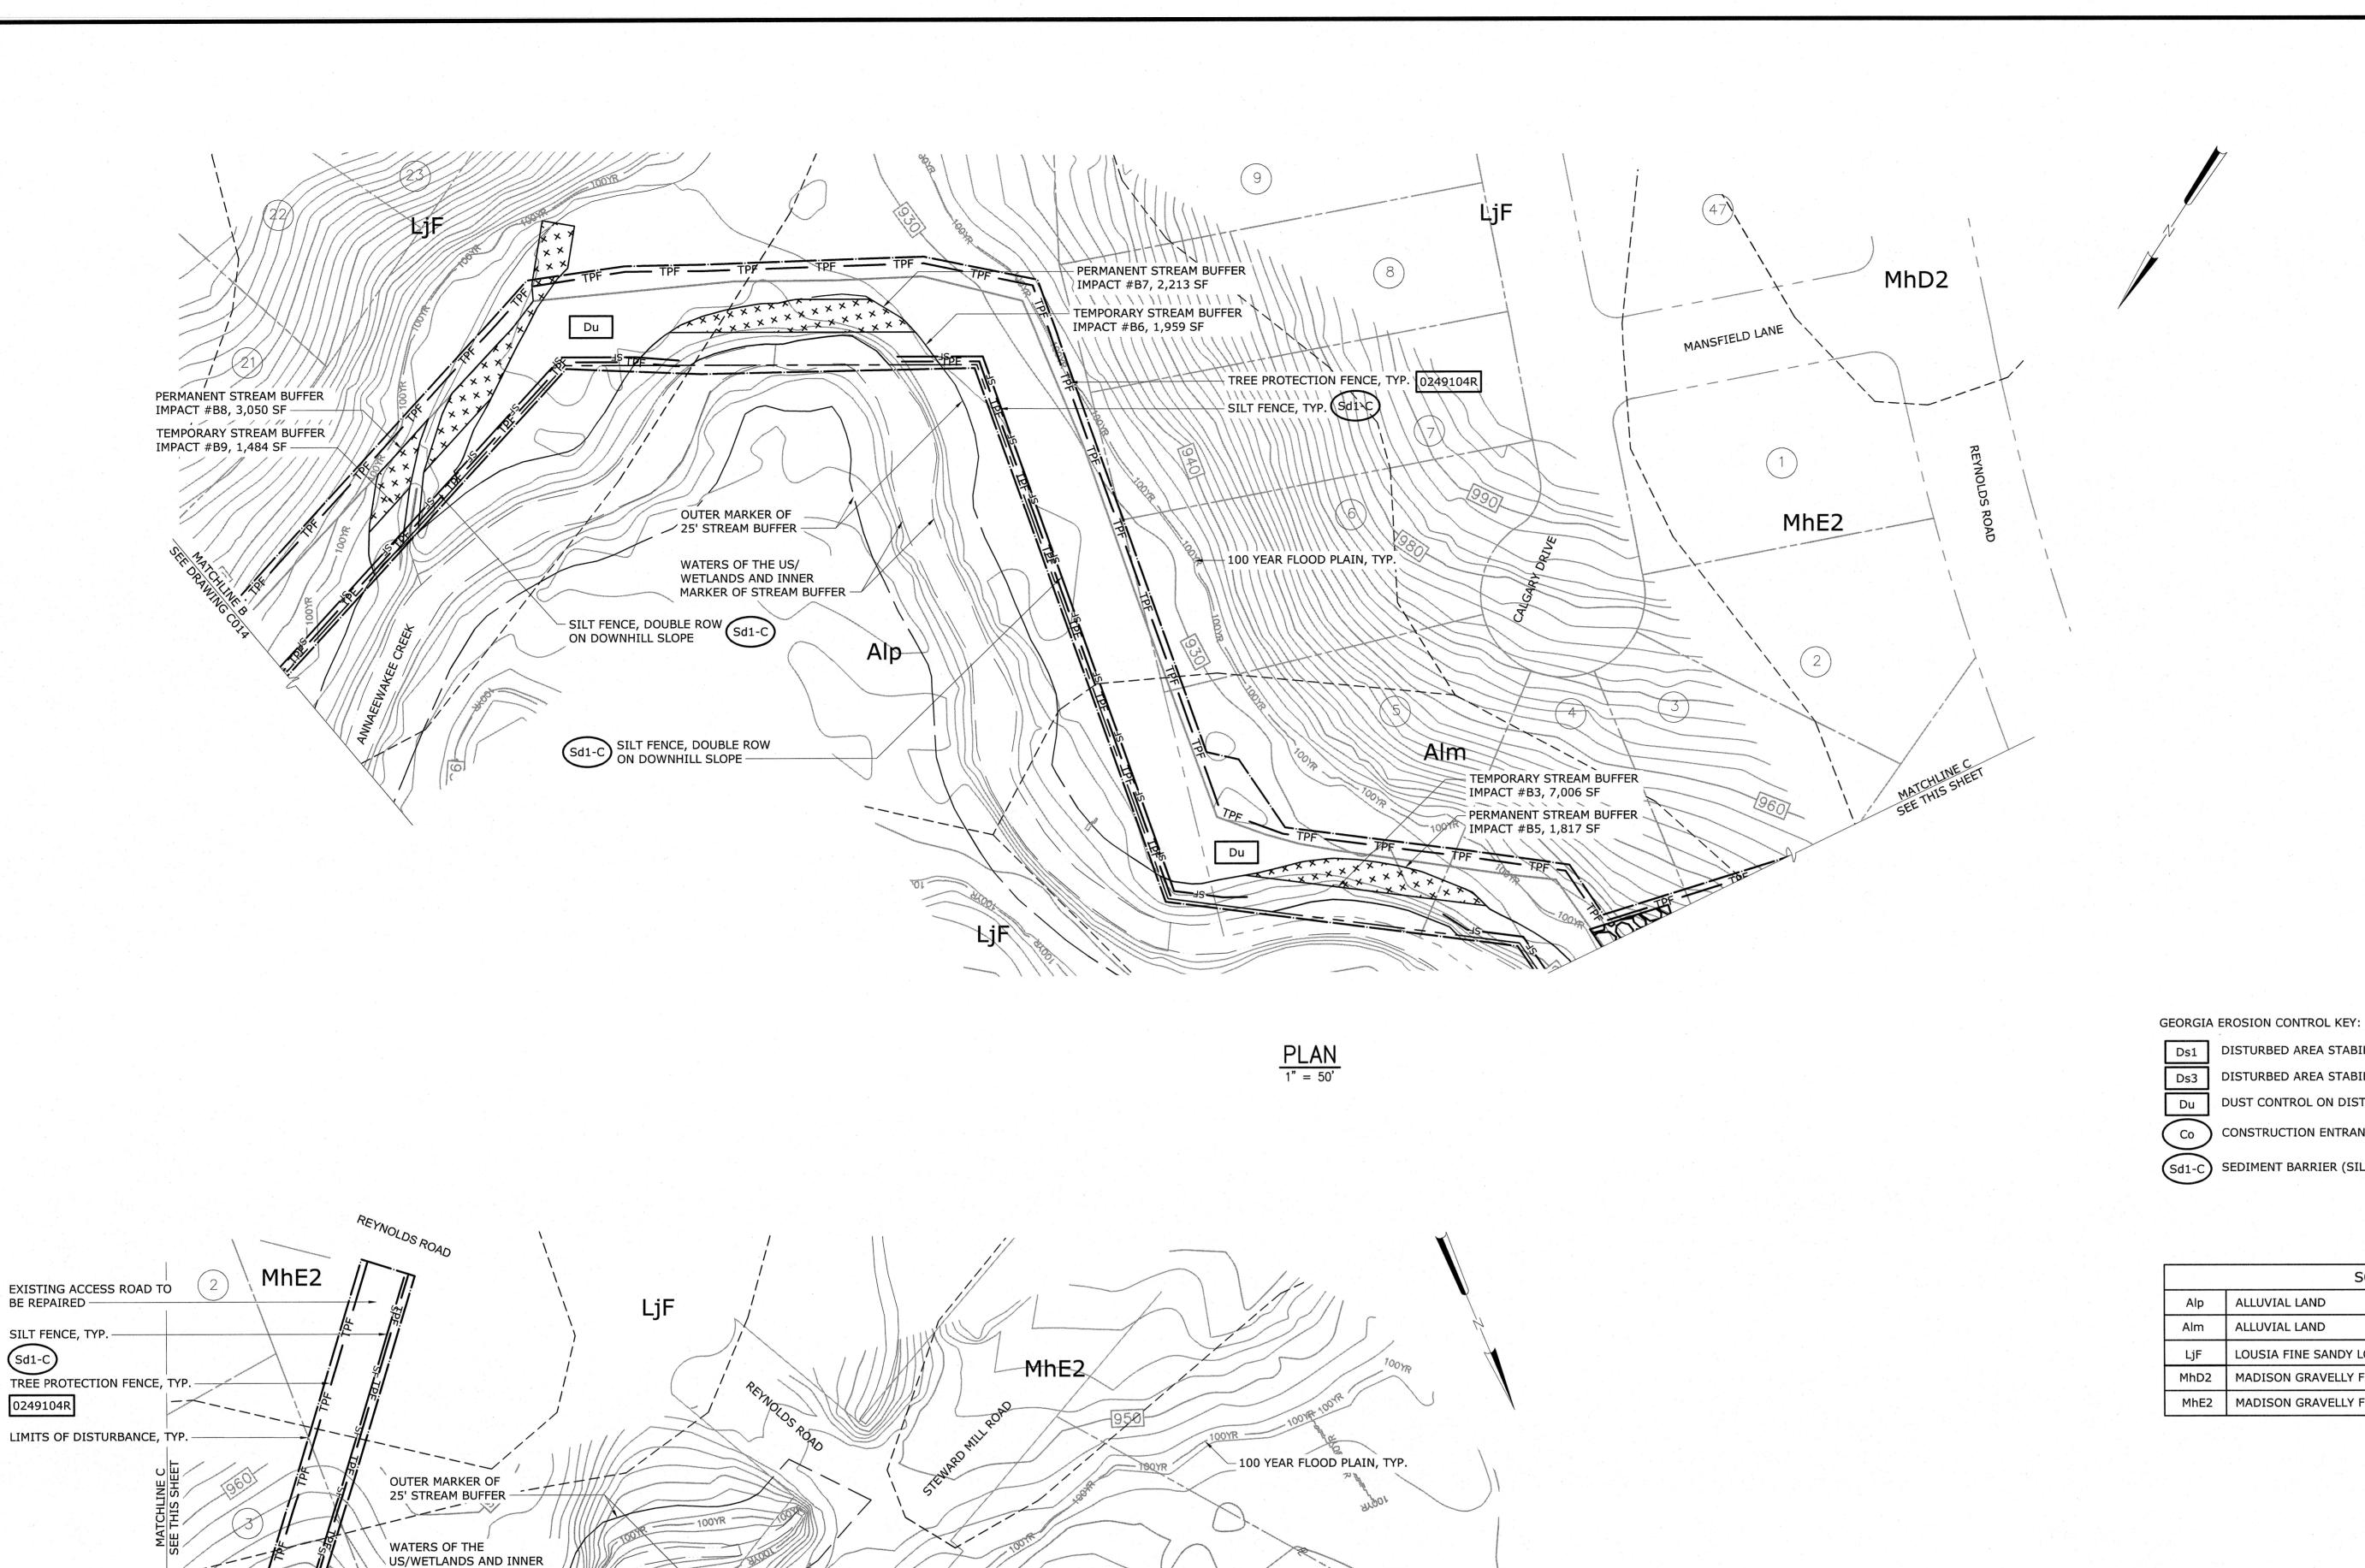

NOTES:

- 1. THE DESIGN PROFESSIONAL WHO PREPARED THE ES&PC PLAN IS TO INSPECT THE INSTALLATION OF THE INITIAL SEDIMENT STORAGE REQUIREMENTS, PERIMETER CONTROL BMPS, AND SEDIMENT BASINS IN ACCORDANCE WITH PART IV.A.5. WITHIN 7 DAYS AFTER INSTALLATION.
- 2. NON-EXEMPT ACTIVITIES SHALL NOT BE CONDUCTED WITHIN THE 25 OR 50-FOOT UNDISTURBED STREAM BUFFERS AS MEASURED FROM THE POINT OF WRESTED VEGETATION OR WITHIN 25-FEET OF THE COASTAL MARSHLAND BUFFER AS MEASURED FROM THE JURISDICTIONAL DETERMINATION LINE WITHOUT FIRST ACQUIRING THE NECESSARY VARIANCES AND PERMITS.
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- 5. ANY DISTURBED AREA LEFT EXPOSED FOR A PERIOD GREATER THAN 14 DAYS SHALL BE STABILIZED WITH MULCH OR TEMPORARY SEEDING.

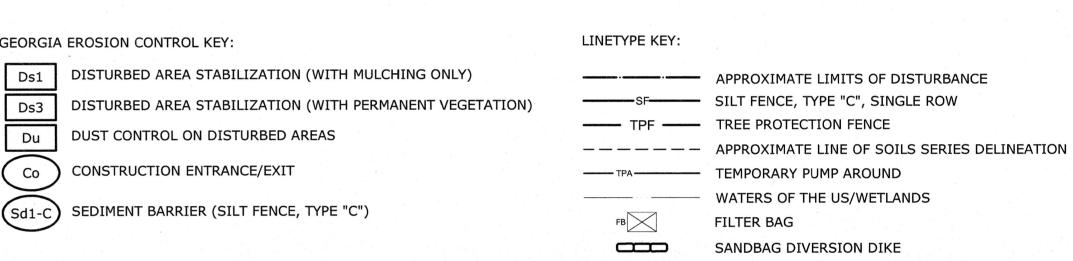

SOIL SERIES AND DEFINITIONS							
Alp	ALLUVIAL LAND		SOMEWHAT POORLY DRAINED				
Alm	ALLUVIAL LAND	: :: : : : : : : : : : : : : : : : :	MODERATELY WELL DRAINED				
LjF	LOUSIA FINE SANDY LOAM	25-40% SLOPES					
MhD2	MADISON GRAVELLY FINE SANDY LOAM	10-15% SLOPES	MODERATELY ERODED				
MhE2	MADISON GRAVELLY FINE SANDY LOAM	15-25% SLOPES	ERODED				

TOTAL DISTURBED AREA = 4.79 ACRES



KNOW WHAT'S BELOW.

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CALL 811 BEFORE YOU DIG!

Georgia Soil and Water Conservation Commission GSWCC Alan E Bowling
Level II Certified Design Professional Certification Number: <u>000000432</u> Issued: <u>08/10/2008</u> Expires: 02/01/2020

OWNER/PRIMARY PERMITTEE: DOUGLASVILLE-DOUGLAS COUNTY WATER AND SEWER AUTHORITY 8763 HOSPITAL DRIVE DOUGLASVILLE, GA 30134 PH. (770) 920-3819 MBACA@DDCWSA.COM

24-HOUR CONTACT NAME: MIGUEL A. BACA, P.E. PHONE: (770) 920-3819

CALL BEFORE YOU DIG! 1.800.282.7411

Q .	,					
IIO: 0:\31247-ATL\31247-010\DESIGN\DRAWINGS\CIVIL\O LOT DATE: 6/24/2019 10:10 AM BY: JJORDAN					PROJECT ENGINEER:	D. EHRHARDT
GN/DRAWING BY: JJORDAN					DESIGNED BY:	B. MOSS
7-010\DESIG 10:10 AM B					DRAWN BY:	J. JORDAN
\31247-01 2019 10:1					CHECKED BY:	D. EHRHARDT
:\31247-ATL\3124 DATE: 6/24/2019					IF THIS BAR DOES NOT MEASURE 1" THEN DRAWING	0 1/2" 1"
ile: 0:\3 LOT D#	REV	ISSUED FOR	DATE	BY	IS NOT TO FULL SCALE	

CONSTRUCTION ENTRANCE N 1351028.2144

33°42'45.9490", -084°44'23.8396"


PERMANENT STREAM BUFFER
IMPACT #B4, 975 SF

TEMPORARY STREAM BUFFER IMPACT #B3, 7,006 SF —

SILT FENCE, DOUBLE ROW ON DOWNHILL SLOPE

E 2122253.6589

MARKER OF STREAM BUFFER

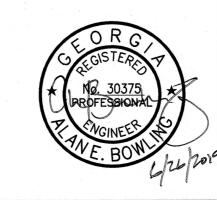

100% SUBMITTAL

STA. 45=62.54

N 1351208.6900 E 2121957.6769

____33°42'47.7183", -084°44'27.3554"

Hazen **HAZEN AND SAWYER** 5775 PEACHTREE DUNWOODY ROAD, SUITE D-520 ATLANTA, GA 30342

ANNEEWAKEE CREEK

25' CREEK BUFFER


DOUGLASVILLE-DOUGLAS COUNTY WATER AND SEWER AUTHORITY


STEWART MILL ROAD SANITARY SEWER REPLACEMENT PROJECT

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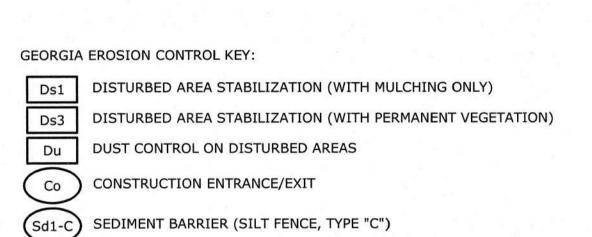
EROSION SEDIMENTATION AND POLLUTION CONTROL PLAN **CIVIL CLEARING PHASE**

MAY 2019 DATE: 31247-010 HAZEN NO.: CONTRACT NO.: 22B4413-02 DRAWING NUMBER: C015



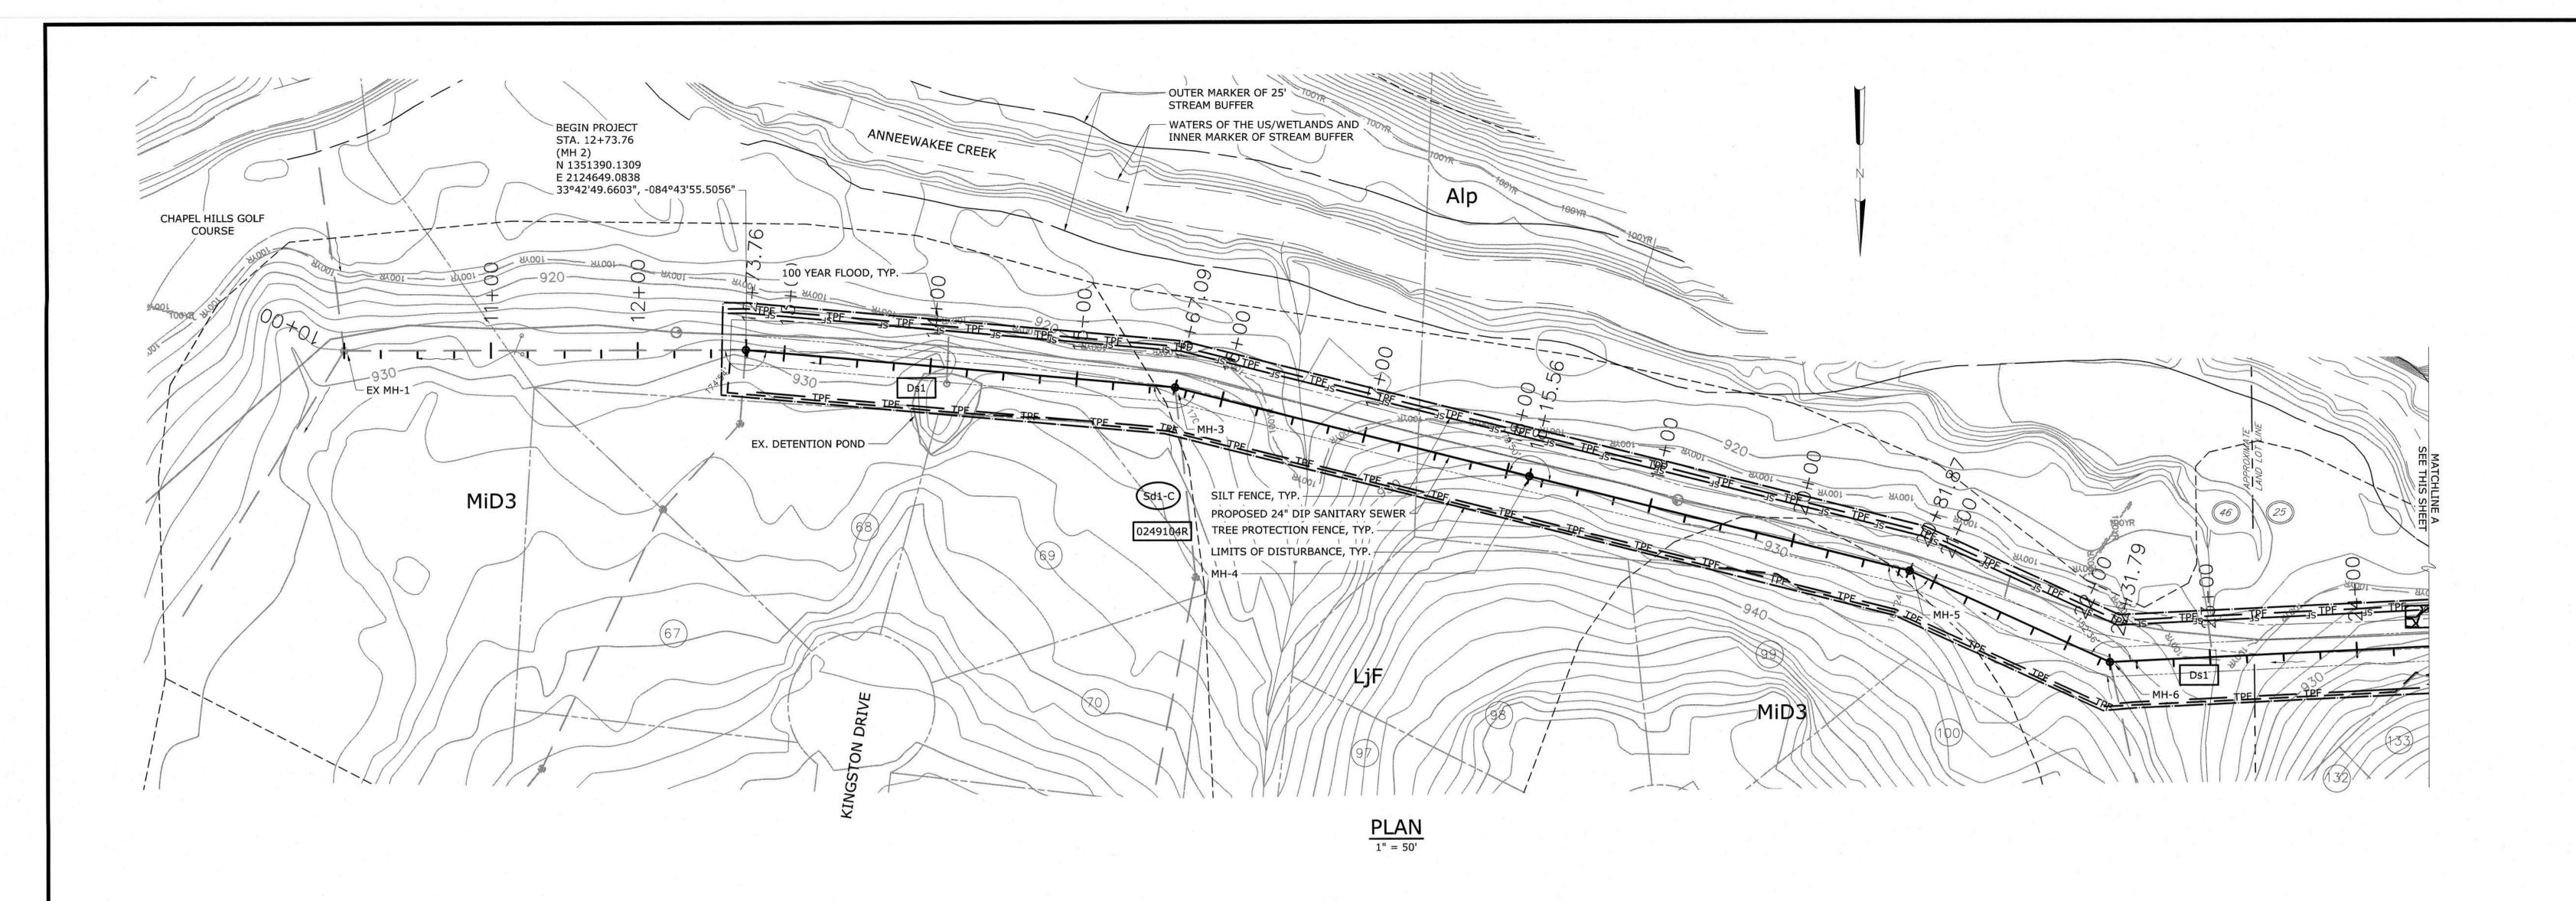

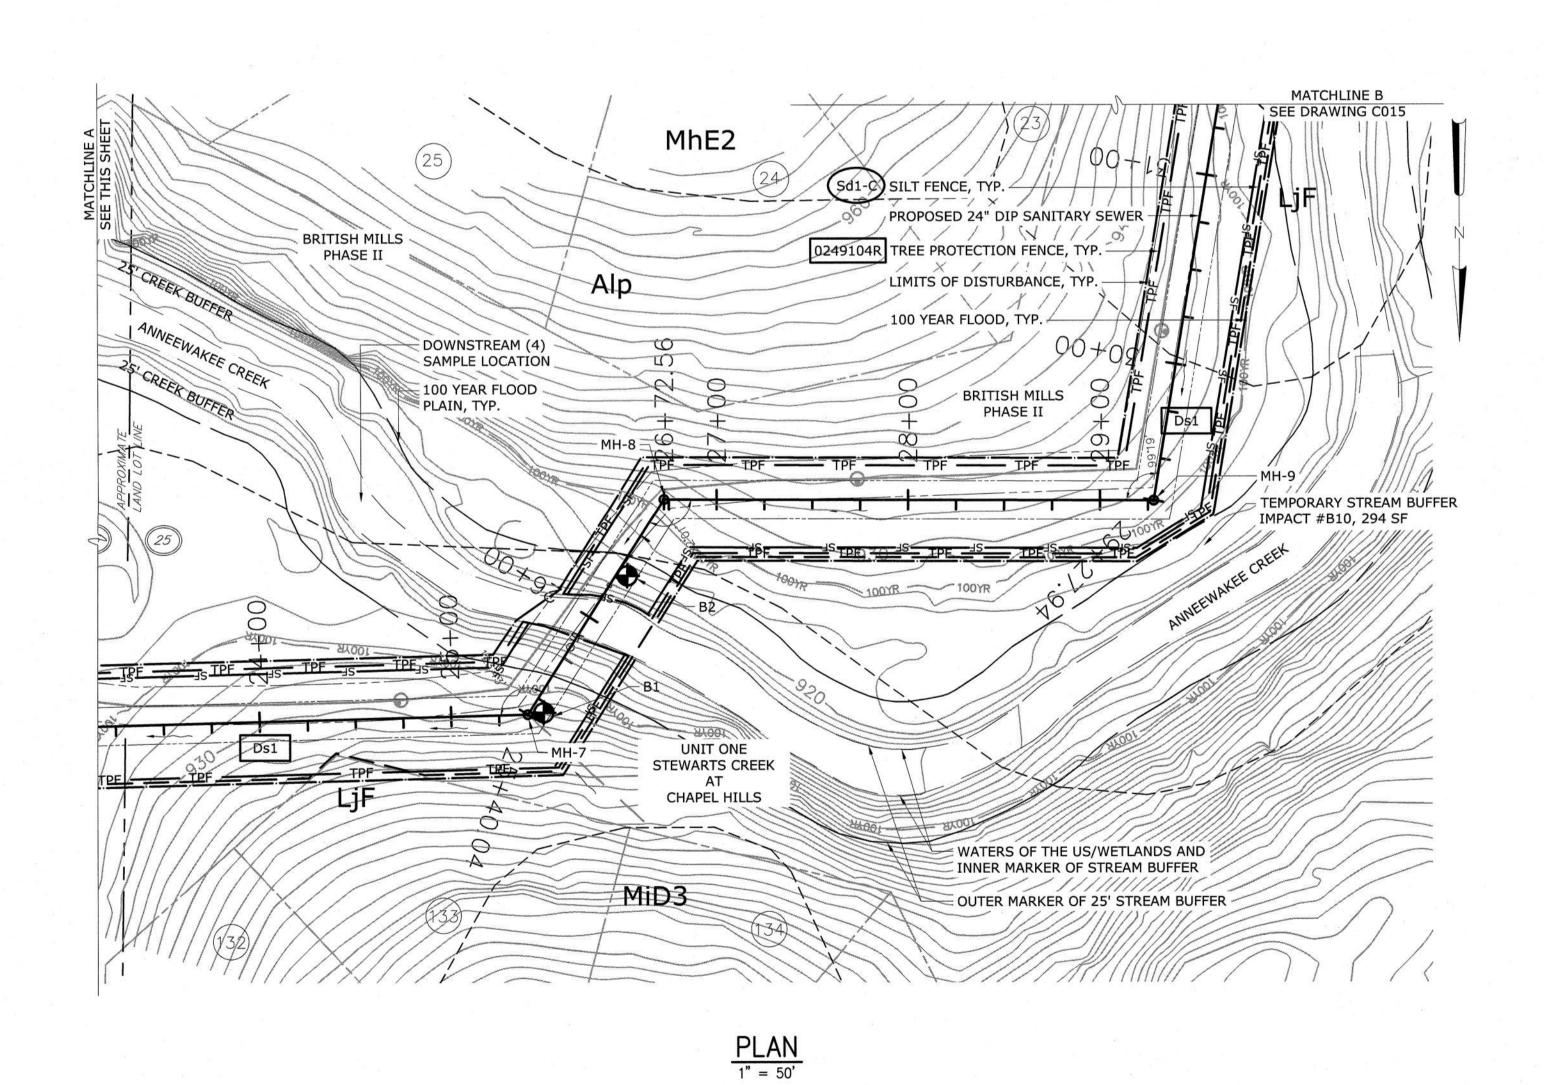100% SUBMITTAL



LINETYPE KEY: APPROXIMATE LIMITS OF DISTURBANCE SILT FENCE, TYPE "C", SINGLE ROW TPF TREE PROTECTION FENCE ---- APPROXIMATE LINE OF SOILS SERIES DELINEATION WATERS OF THE US/WETLANDS

Georgia Soil and Water Conservation Commission GSWCC Alan E Bowling
Level II Certified Design Professional Certification Number: 000000432 Issued: 08/10/2008 Expires: 02/01/2020

OWNER/PRIMARY PERMITTEE: DOUGLASVILLE-DOUGLAS COUNTY WATER AND SEWER AUTHORITY 8763 HOSPITAL DRIVE DOUGLASVILLE, GA 30134 PH. (770) 920-3819 MBACA@DDCWSA.COM

24-HOUR CONTACT NAME: MIGUEL A. BACA, P.E.

PHONE: (770) 920-3819

KNOW WHAT'S BELOW.


CALL BEFORE YOU DIG.

LLAME ANTES DE CAVAR.

IT'S THE LAW. ES LA LEY CALL 811 BEFORE YOU DIG! CALL BEFORE YOU DIG! 1.800.282.7411

TOTAL DISTURBED AREA = 4.79 ACRES


PROJECT ENGINEER: D. EHRHARDT B. MOSS DESIGNED BY: J. JORDAN DRAWN BY: CHECKED BY: D. EHRHARDT IF THIS BAR DOES NOT MEASURE 1" THEN DRAWING IS NOT TO FULL SCALE 0 1/2" 1" ISSUED FOR

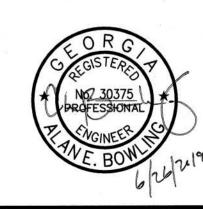

Hazen HAZEN AND SAWYER 5775 PEACHTREE DUNWOODY ROAD, SUITE D-520 ATLANTA, GA 30342


DOUGLASVILLE-DOUGLAS COUNTY WATER AND SEWER AUTHORITY

STEWART MILL ROAD SANITARY SEWER REPLACEMENT PROJECT

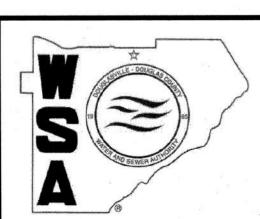

EROSION SEDIMENTATION AND POLLUTION CONTROL PLAN **CIVIL GRADING PHASE**

DATE:	MAY 2019
HAZEN NO.:	31247-010
CONTRACT NO.	:22B4413-02
DRAWING NUMBER:	
9 5	C016

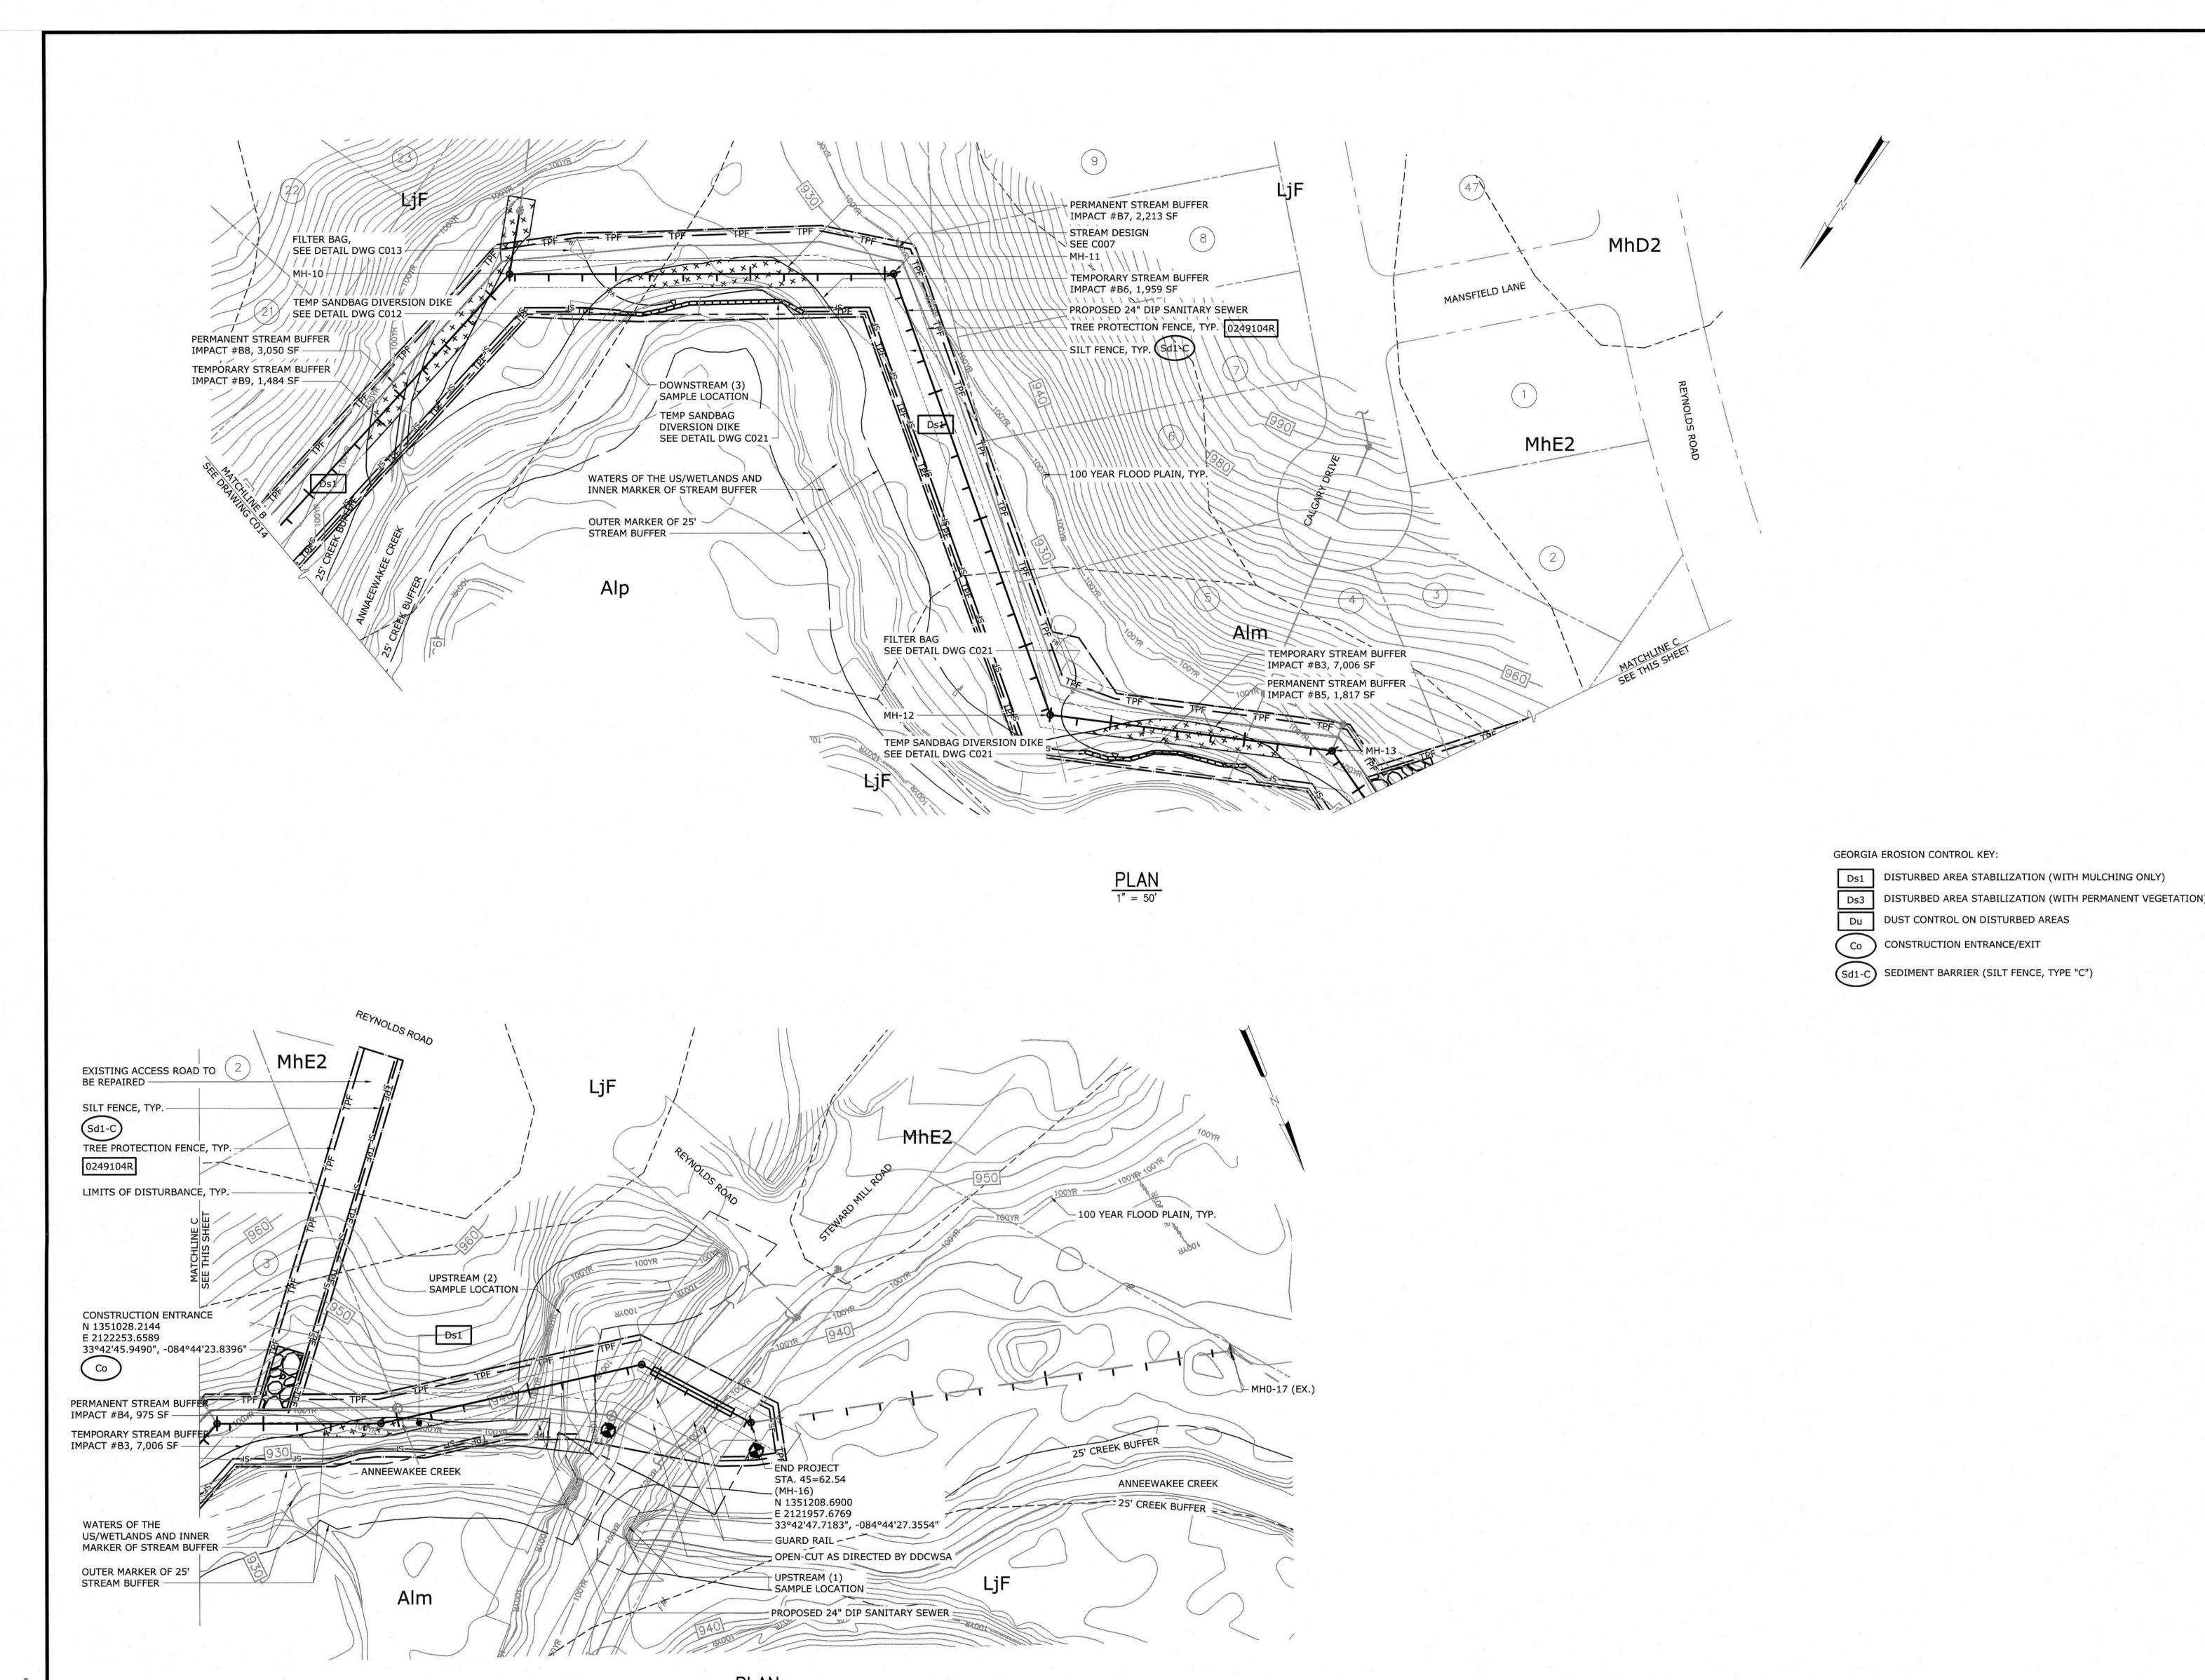

NOTES:

- 1. THE DESIGN PROFESSIONAL WHO PREPARED THE ES&PC PLAN IS TO INSPECT THE INSTALLATION OF THE INITIAL SEDIMENT STORAGE REQUIREMENTS, PERIMETER CONTROL BMPS, AND SEDIMENT BASINS IN ACCORDANCE WITH PART IV.A.5. WITHIN 7 DAYS AFTER INSTALLATION.
- 2. NON-EXEMPT ACTIVITIES SHALL NOT BE CONDUCTED WITHIN THE 25 OR 50-FOOT UNDISTURBED STREAM BUFFERS AS MEASURED FROM THE POINT OF WRESTED VEGETATION OR WITHIN 25-FEET OF THE COASTAL MARSHLAND BUFFER AS MEASURED FROM THE JURISDICTIONAL DETERMINATION LINE WITHOUT FIRST ACQUIRING THE NECESSARY VARIANCES AND PERMITS.
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- 4. WASTE MATERIALS SHALL NOT BE DISCHARGED TO WATERS OF THE STATE, EXCEPT AS AUTHORIZED BY A SECTION 404 PERMIT.
- 5. ANY DISTURBED AREA LEFT EXPOSED FOR A PERIOD GREATER THAN 14 DAYS SHALL BE STABILIZED WITH MULCH OR TEMPORARY SEEDING.

CALL BEFORE YOU DIG. LLAME ANTES DE CAVAR. IT'S THE LAW. ES LA LEY

CALL 811 BEFORE YOU DIG!

GSWCC Georgia Soil and Water Conservation Commission Alan E Bowling
Level II Certified Design Professional Certification Number: <u>000000432</u> Issued: <u>08/10/2008</u> Expires: 02/01/2020

OWNER/PRIMARY PERMITTEE: DOUGLASVILLE-DOUGLAS COUNTY WATER AND SEWER AUTHORITY 8763 HOSPITAL DRIVE DOUGLASVILLE, GA 30134 PH. (770) 920-3819 MBACA@DDCWSA.COM

24-HOUR CONTACT NAME: MIGUEL A. BACA, P.E.

LINETYPE KEY:

APPROXIMATE LIMITS OF DISTURBANCE

---- APPROXIMATE LINE OF SOILS SERIES DELINEATION

WATERS OF THE US/WETLANDS

SANDBAG DIVERSION DIKE

SILT FENCE, TYPE "C", SINGLE ROW

TPF TREE PROTECTION FENCE

TEMPORARY PUMP AROUND

PHONE: (770) 920-3819

CALL BEFORE YOU DIG! 1.800.282.7411

TOTAL DISTURBED AREA = 4.79 ACRES

PROJECT ENGINEER: D. EHRHARDT B. MOSS **DESIGNED BY:** J. JORDAN DRAWN BY: 100% SUBMITTAL D. EHRHARDT CHECKED BY: IF THIS BAR DOES NOT MEASURE 1" THEN DRAWING 0 1/2" 1" IS NOT TO FULL SCALE ISSUED FOR DATE



Hazen **HAZEN AND SAWYER 5775 PEACHTREE DUNWOODY ROAD,** SUITE D-520

ATLANTA, GA 30342


DOUGLASVILLE-DOUGLAS COUNTY WATER AND SEWER AUTHORITY


STEWART MILL ROAD SANITARY SEWER REPLACEMENT PROJECT

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A				

EROSION SEDIMENTATION AND POLLUTION
CONTROL PLAN
CIVIL
GRADING PHASE

MAY 2019 DATE: 31247-010 HAZEN NO .: CONTRACT NO.: 22B4413-02 DRAWING NUMBER: C017

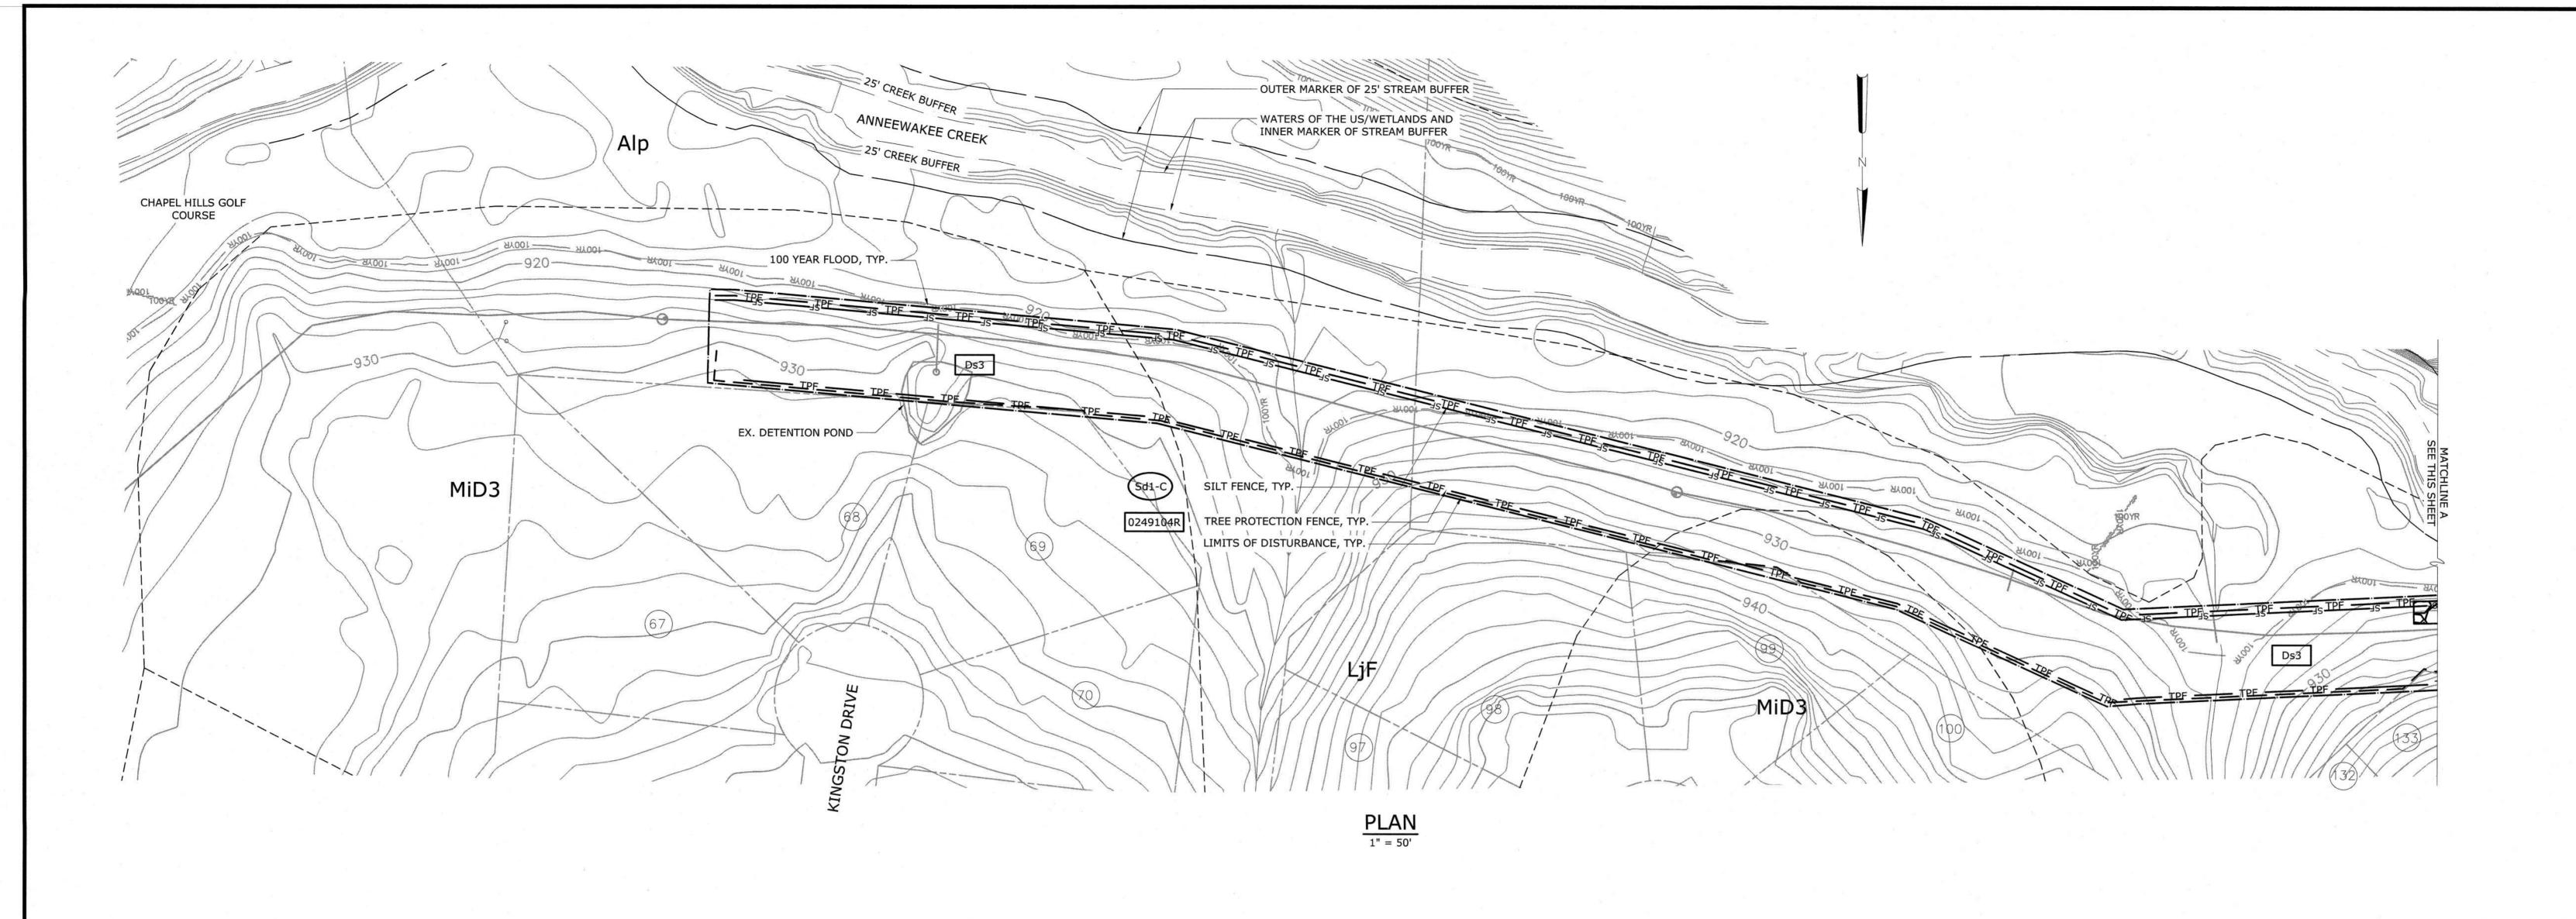

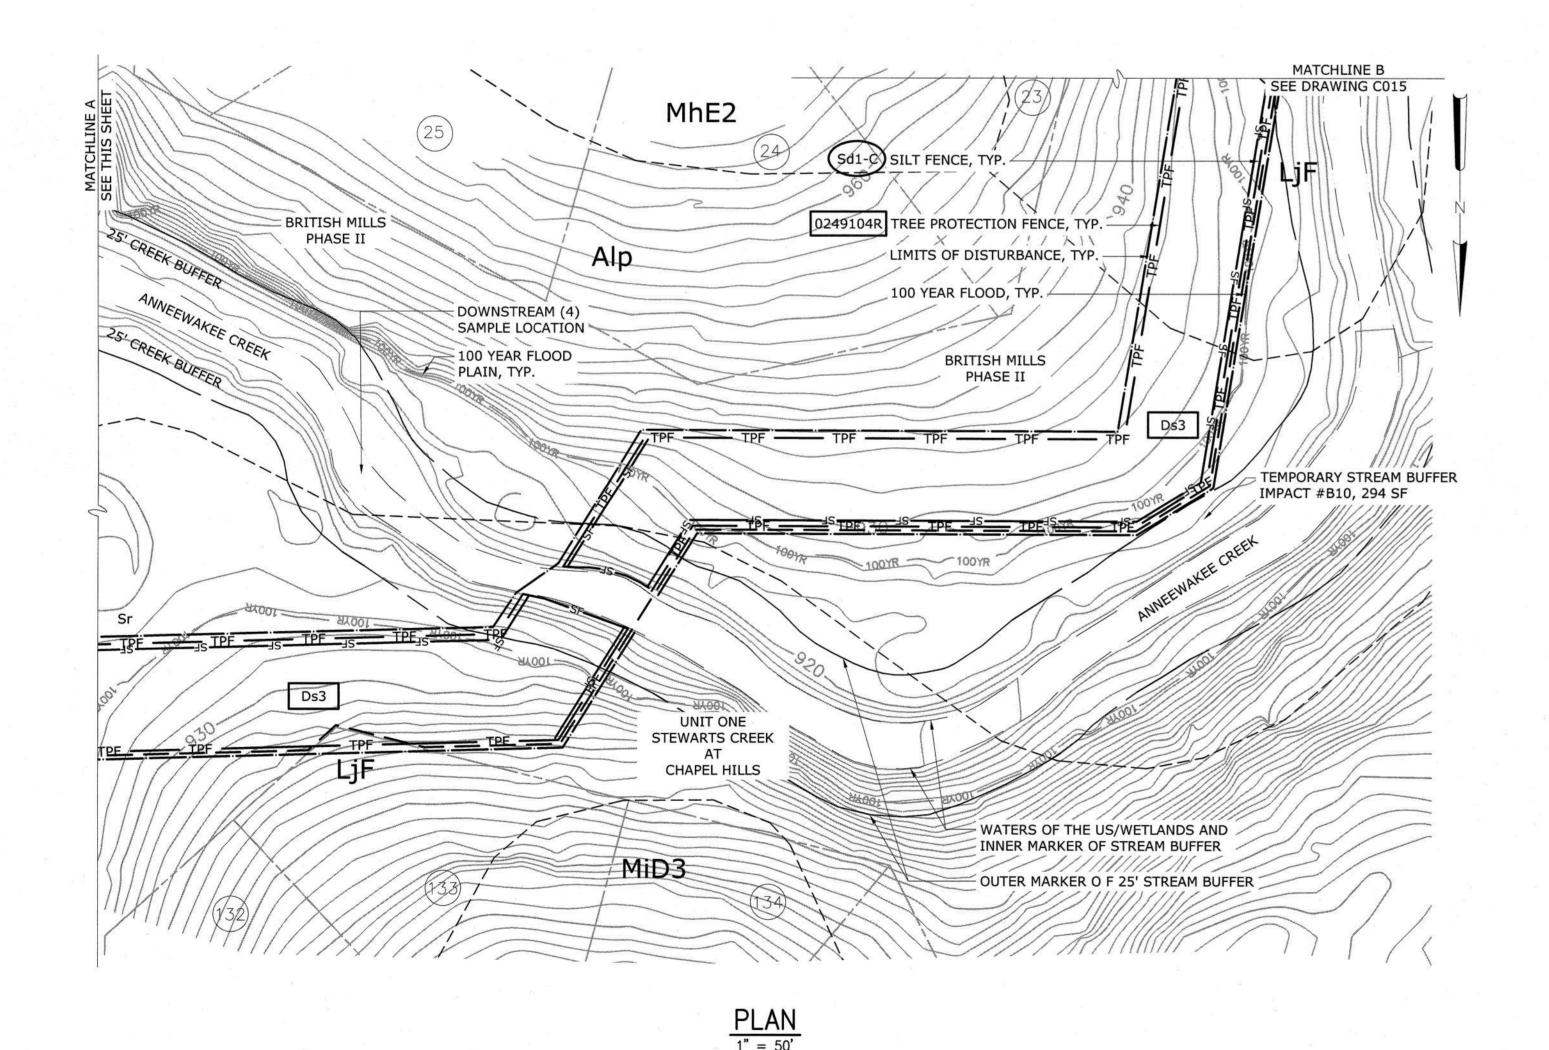



GSWCC

Certification Number: Issued: 08/10/2008


SEDIMENT BARRIER (SILT FENCE, TYPE "C")

APPROXIMATE LIMITS OF DISTURBANCE SILT FENCE, TYPE "C", SINGLE ROW

TPF TREE PROTECTION FENCE

---- APPROXIMATE LINE OF SOILS SERIES DELINEATION

TOTAL DISTURBED AREA = 4.79 ACRES

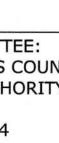

OWNER/PRIMARY PERMITTEE: DOUGLASVILLE-DOUGLAS COUNTY WATER AND SEWER AUTHORITY 8763 HOSPITAL DRIVE DOUGLASVILLE, GA 30134 PH. (770) 920-3819 MBACA@DDCWSA.COM

24-HOUR CONTACT NAME: MIGUEL A. BACA, P.E. PHONE: (770) 920-3819

NOTES:

ACTIVITIES.

GRUBBING BEGINS.

LIMITS OF THE PROJECT SITE.

INDICATING THE 1/3 FULL VOLUME.

CONTROL MATTING OR BLANKET.

ACTIVITIES.

PROFESSIONAL.

SECTION 404 PERMIT.

MULCH OR TEMPORARY SEEDING.

11. TOTAL WETLAND ACRES WITHIN THE LIMITS OF

8. TOTAL PROJECT ACRES 4.79 AC.

1. NO WASTE SHALL BE DISPOSED OF INTO STORMWATER

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7. STATE WATERS EXIST WITHIN 200 FEET OF THE LIMITS OF CONSTRUCTION ON THE PROJECT SITE. ANNEEWAKEE CREEK IS LOCATED TO THE ALONG THE PROJECT SITE, AND ITS 100-YEAR FLOODPLAIN IS LOCATED WITHIN THE

9. SEDIMENT STORAGE MAINTENANCE INDICATORS MUST BE

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10. CONCENTRATED FLOW AREAS AND ALL SLOPES STEEPER THAN 2.5:1 WITH A HEIGHT OF TEN FEET OR GREATER SHALL BE STABILIZED WITH THE APPROPRIATE EROSION

CONSTRUCTION ON THE PROJECT SITE ARE 0.06 AC.

12. CONTRACTOR TO PROVIDE INLET PROTECTION (Sd2-Bg) ON ALL STORM INLETS WITHIN LIMITS OF DISTURBANCE OR WITHIN CLOSE PROXIMITY OF CONSTRUCTION

13. THE DESIGN PROFESSIONAL WHO PREPARED THE ES&PC PLAN IS TO INSPECT THE INSTALLATION OF THE INITIAL SEDIMENT STORAGE REQUIREMENTS, PERIMETER

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SEDIMENT CONTROL MEASURES AND PRACTICES PRIOR

INLETS OR WATERS OF THE STATE.

KNOW WHAT'S BELOW.

CALL BEFORE YOU DIG.

LIAME ANTES DE CAVAR.

CALL 811 BEFORE YOU DIG! CALL BEFORE YOU DIG! 1.800.282.7411

D. EHRHARDT **ENGINEER:** B. MOSS DESIGNED BY: J. JORDAN DRAWN BY: 100% SUBMITTAL D. EHRHARDT CHECKED BY: IF THIS BAR DOES NOT
MEASURE 1" THEN DRAWING
IS NOT TO FULL SCALE DATE BY ISSUED FOR

Hazen **HAZEN AND SAWYER** 5775 PEACHTREE DUNWOODY ROAD, SUITE D-520 ATLANTA, GA 30342

DOUGLASVILLE-DOUGLAS COUNTY WATER AND SEWER AUTHORITY

STEWART MILL ROAD SANITARY SEWER REPLACEMENT PROJECT




Georgia Soil and Water Conservation Commission

Expires: 02/01/2020

Alan E Bowling
Level II Certified Design Professional

EROSION SEDIMENTATION AND POLLUTION CONTROL PLAN **CIVIL** FINAL PHASE

MAY 2019 DATE: 31247-010 HAZEN NO.: CONTRACT NO.: 22B4413-02 DRAWING NUMBER:

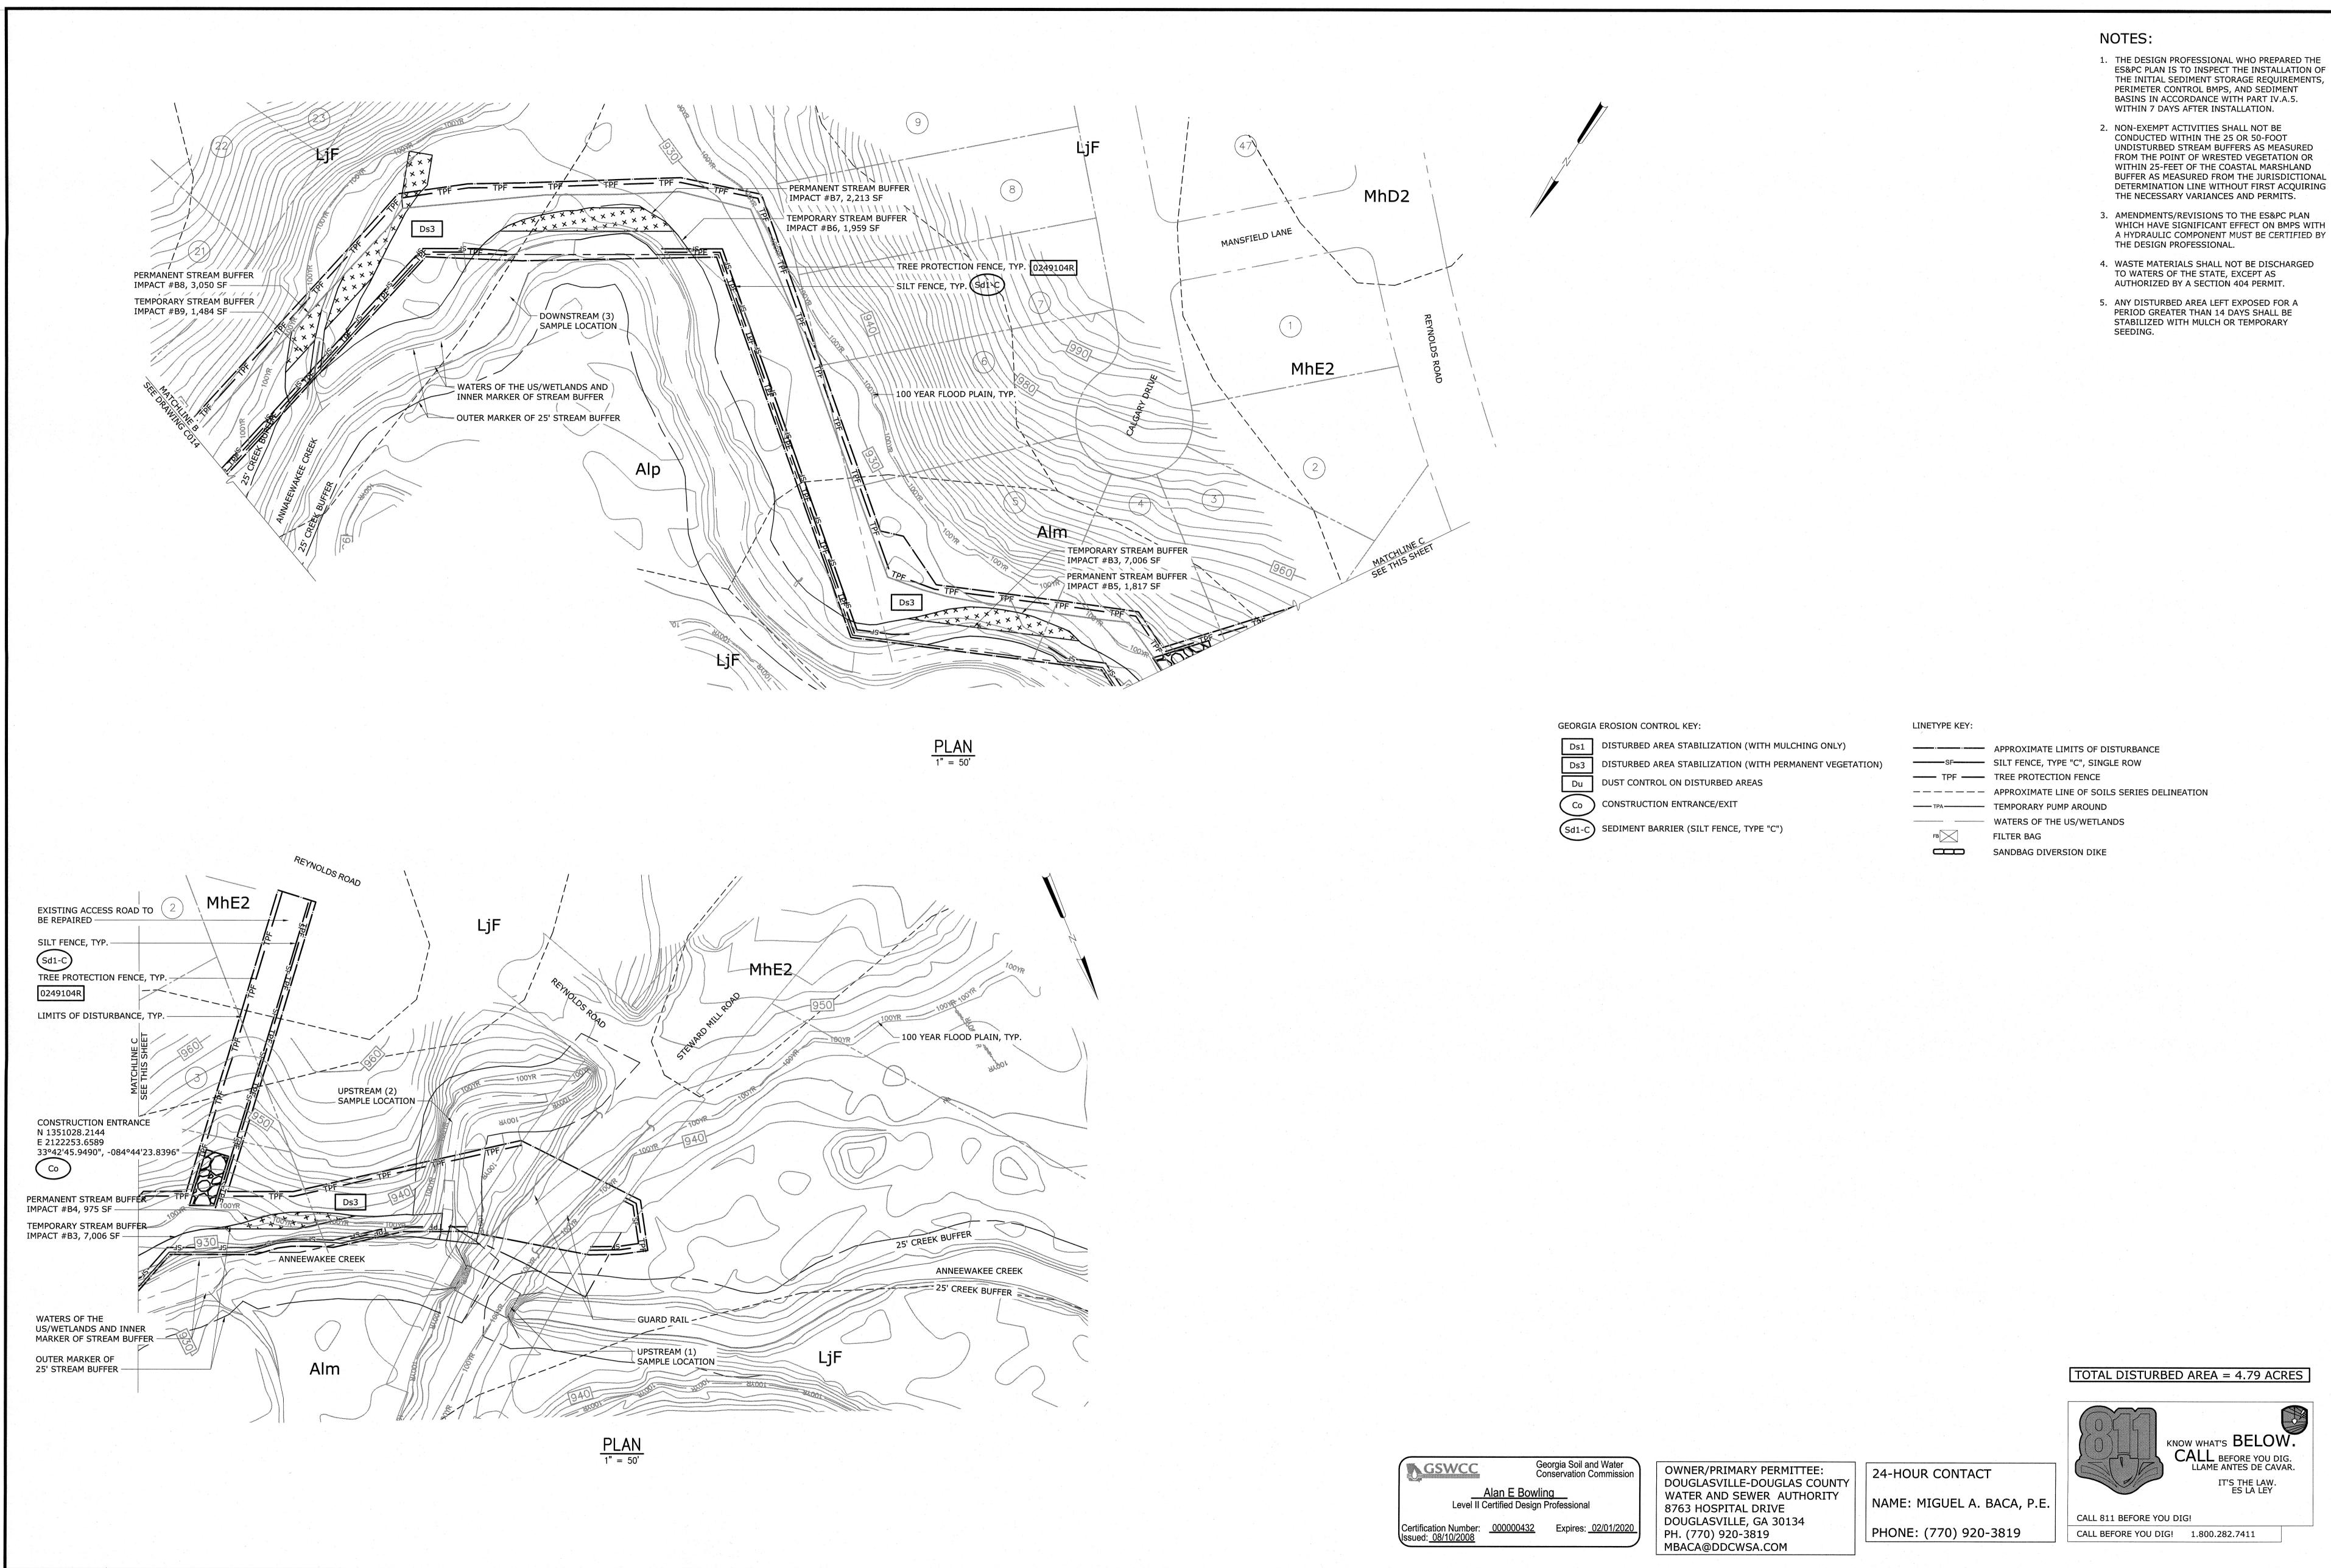

PROJECT ENGINEER: D. EHRHARDT B. MOSS DESIGNED BY: J. JORDAN DRAWN BY: D. EHRHARDT CHECKED BY: IF THIS BAR DOES NOT
MEASURE 1" THEN DRAWING
IS NOT TO FULL SCALE

DATE BY

ISSUED FOR

100% SUBMITTAL

Hazen HAZEN AND SAWYER 5775 PEACHTREE DUNWOODY ROAD,

SUITE D-520

ATLANTA, GA 30342

DOUGLASVILLE-DOUGLAS COUNTY WATER AND SEWER AUTHORITY

STEWART MILL ROAD SANITARY SEWER REPLACEMENT PROJECT



EROSION SEDIMENTATION AND POLLUTION CONTROL PLAN CIVIL FINAL PHASE

MAY 2019 31247-010 HAZEN NO.: CONTRACT NO.: 22B4413-02

DRAWING NUMBER:

EROSION, SEDIMENTATION & POLIUTION CONTROL PLAN CHECKLIST INFRASTRUCTURE CONSTRUCTION PROJECTS SWOCH West Georgia Project Name: Stewart Nill Road sewer Replacement Address: Stewart Nill Road and Reynolds Road City/County; Douglas County Name & email of person filling out checklist: Alan Bowling, Pt. Level 2: 432 abowling@hazenandsawyer.com Plan Included TO BE SHOWN ON ESSPC PLAN [2020] Y 1 The applicable Frosion, Sedimentation and Pollution Control Plan Checklist stabilished by the Commission as of January 1 of the year in which the land-disturbing activity was permitted. (The completed Checklist and be submitted with the SBPC Plan or the Plan will not be reviewed) [2012] Y 2 Level il certification number issued by the Commission, signature and seal of the certificid design professional. (Signature, seal and Level II number must be on each sheet perhalinity to ESSPC Plan or the Plan will not be reviewed) [2012] Y 3 The name and phone number of the 24-hour local contact responsible for eresion, sedimentation and pollution controls. (Signature, seal and Level II number must be on each sheet perhalinity to ESSPC Plan or the Plan will not be reviewed) [2012] Y 5 Note total and disturbed acreage of the project or phase under construction. [2014] Y 5 Note total and disturbed acreage of the project or phase under construction. [2015] Y 7 Initial date of the Plan and the dates of any revisions made to the Plan including the entity who requested the revisions. [2012] Y 1 Description of the nature of construction solvity. [2012] Y 1 Description of the nature of construction solvity. [2012] Y 10 Identify the project roceving waters and describe all sensitive adjacent area including streams, lakes, residential areas, wetlands, marchilands, act. which may be affected. [2012] Y 10 Identify the project roceving waters and describe all sensitive adjacent area including streams, lakes, residential areas, wetlands, including streams, lakes, residential and streams and signature that the site was visited on	C012 Y 19 Clearly note statement that "The escape of sediment from the site shall be prevented by the installation of erosion and sediment control measures and practices prior to land disturbing activities." C012 Y 20 Clearly note statement that "Encision control measures will be maintained at all times. If full implementation of the approved Plan dose not provide for effective erosion control, additional rection and sediment control control measures that be implemented to control or treat the sediment Survas." C012 Y 21 Clearly note the statement "Any disturbed area left exposed for a period greater than 14 days shall be stabilized with much or temporary seeding." C012 Y 22 Any construction activity which discharges storm water into an impaired Stream Segment, or within 1 timear mile upstream of and within the same watershed as, any portion of an Blots Impaired Stream Segment, which is the period Stream Segment must comply with Part III. C of the permit. Include the completed Appendix it is stilling at the EMPs that will be used for flows areas of the site with discharge to the impaired Stream Segment (selectified in term 22 above) at least six months prior to submitted of NOI, the ESBACP Plan must address any site-specific conditions or requirements included in the TMD. Implementation Plan." C012 Y 24 SMPs for concrete washdown of solis, concrete mixer chules, hoppers and the rear of the vehicles. Washout of the drum at the construction site is prohibited." C012 Y 25 Provide BMPs for the measures that will be lead for endure the publisher for the service wash of the stream of the vehicles. Washout of the drum at the construction site is prohibited." C012 Y 27 Description of the measures that will be used to reduce the publisher in storm water flow benchmarked. C013 Y 28 Description of the practices that will be used to reduce the publisher in storm water discharges." C014 Y 29 Description of the practices that will be used to reduce the publisher in storm water discharges." C015 Y 20 Provid	N/A 30 Use of alternative BMPs whose performance has been documented to be equivalent to or superior to convention at BMPs as certified by a Design Professional (unless despoymed by EPO or the Georgia Soil and Vivater Conservation Commission). Please refer to the Alternative BMP Gelderino Document found at tww, gaseous crag. A 20 Use of alternative BMP or application to the Equivalent BMP List. Please refer to Appendix A 2 of the Manual for Erosion A Sediment Control in Georgia 2016 Edition. A 20 Use of the Card Servative Alternative, Clearly not and delimented all areas of impact. A 21 Delineation of the septicable 25-50 or 59-floot undisturbed buffers adjacent to State waters and any additional buffers required by the Local Issuing Authority. Clearly not and delimented all areas of impact. A 22 Delineation of on-site wetlands and all State waters located on and within 200 feet of the project site. A 30 Delineation and acreage of contributing dinnings bearins on the propert site. A 30 Delineation and consequence of office weternative subjects Set 1/2000 The project site. A 30 Delineation and consequence of office weternative subjects Set 1/2000 The project site. A 41 Delineation of the nunoffice officient or peak discharge flow of the site prior to and after construction activities are completed. A 45 Set manual project and work valications with appropriate outlet protection to accommodate discharges without erosion. Identify/Delineate all storm water discharges portion. A 45 Set manual project and work redictions outlet protection to accommodate discharges without erosion. Identify/Delineate all storm water discharges portion. A 45 The limits of disturbance for each phase of construction. A 45 The limits of disturbance for each phase of construction. A 45 The limits of disturbance for each phase of construction. A 45 The limits of disturbance for each phase of construction. A 45 The limits of disturbance for each phase of limits delineated that phase is the later phase of limits and the phase
THE ESBFC PLAN MUST INCLUDE AT LEAST FOUR (4) OF THE FOLLOWING BMPS FOR THOSE AREAS OF THE STE WHICH DISCHARGE TO A IMPARED STRAM SEGMENT AND FOR SITES WHICH EPD MAS APPROVED B WRITING A REQUEST TO DISTURS 50 ACRES OR MORE AT ANY ONE TIME. The base of the proper of t	N	

PROJECT ENGINEER: D. EHRHARDT B. MOSS DESIGNED BY: J. JORDAN DRAWN BY: D. EHRHARDT CHECKED BY: IF THIS BAR DOES NOT
MEASURE 1" THEN DRAWING
IS NOT TO FULL SCALE DATE BY **ISSUED FOR**

100% SUBMITTAL

Hazen HAZEN AND SAWYER
5775 PEACHTREE DUNWOODY ROAD,

SUITE D-520 ATLANTA, GA 30342

DOUGLASVILLE-DOUGLAS COUNTY WATER AND SEWER AUTHORITY

STEWART MILL ROAD SANITARY SEWER REPLACEMENT PROJECT



CONTACT

GUEL A. BACA, P.E. PHONE: (770) 920-3819

KNOW WHAT'S BELOW.


CALL BEFORE YOU DIG.


LLAME ANTES DE CAVAR.

CALL 811 BEFORE YOU DIG! CALL BEFORE YOU DIG! 1.800.282.7411

EROSION SEDIMENTATION AND POLLUTION CONTROL **PLAN CIVIL** ESC PLAN CHECKLIST

MAY 2019 31247-010 HAZEN NO.: CONTRACT NO.: 22B4413-02 DRAWING NUMBER:

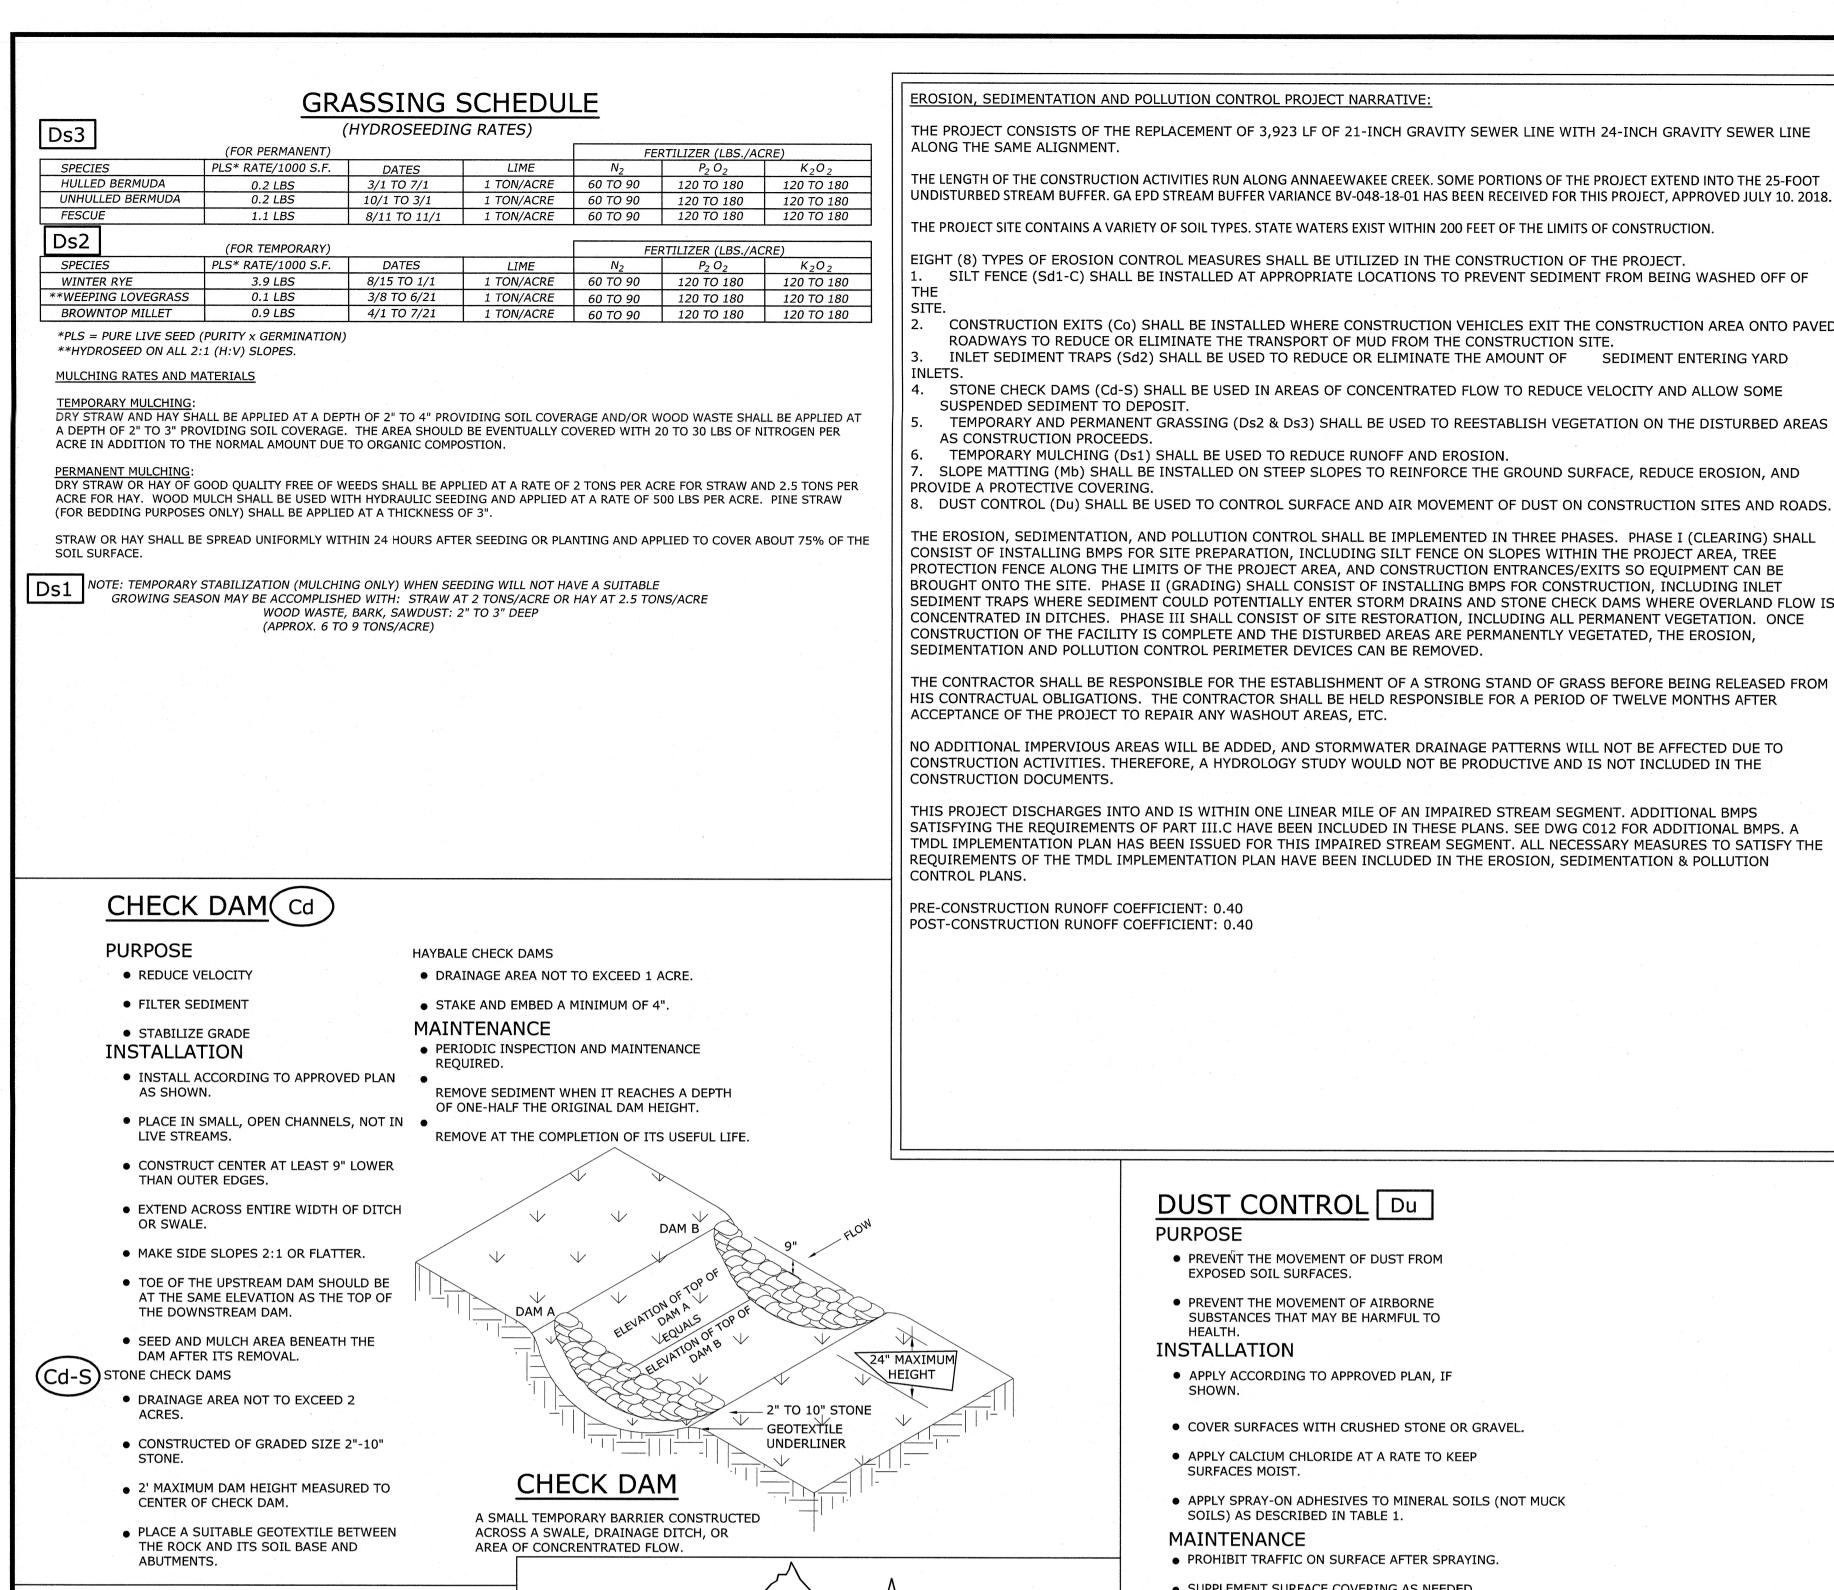

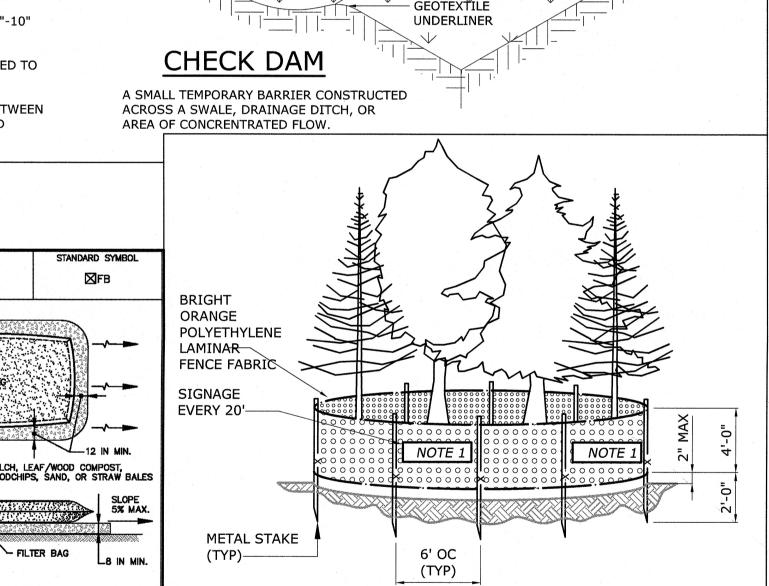

WHERE SIGNAGE IS POSTED.

EROSION, SEDIMENTATION AND POLLUTION CONTROL PROJECT NARRATIVE

THE PROJECT CONSISTS OF THE REPLACEMENT OF 3,923 LF OF 21-INCH GRAVITY SEWER LINE WITH 24-INCH GRAVITY SEWER LINE ALONG THE SAME ALIGNMENT.

THE LENGTH OF THE CONSTRUCTION ACTIVITIES RUN ALONG ANNAEEWAKEE CREEK. SOME PORTIONS OF THE PROJECT EXTEND INTO THE 25-FOOT UNDISTURBED STREAM BUFFER. GA EPD STREAM BUFFER VARIANCE BV-048-18-01 HAS BEEN RECEIVED FOR THIS PROJECT, APPROVED JULY 10. 2018.

EIGHT (8) TYPES OF EROSION CONTROL MEASURES SHALL BE UTILIZED IN THE CONSTRUCTION OF THE PROJECT. SILT FENCE (Sd1-C) SHALL BE INSTALLED AT APPROPRIATE LOCATIONS TO PREVENT SEDIMENT FROM BEING WASHED OFF OF

CONSTRUCTION EXITS (Co) SHALL BE INSTALLED WHERE CONSTRUCTION VEHICLES EXIT THE CONSTRUCTION AREA ONTO PAVED ROADWAYS TO REDUCE OR ELIMINATE THE TRANSPORT OF MUD FROM THE CONSTRUCTION SITE. INLET SEDIMENT TRAPS (Sd2) SHALL BE USED TO REDUCE OR ELIMINATE THE AMOUNT OF SEDIMENT ENTERING YARD

4. STONE CHECK DAMS (Cd-S) SHALL BE USED IN AREAS OF CONCENTRATED FLOW TO REDUCE VELOCITY AND ALLOW SOME SUSPENDED SEDIMENT TO DEPOSIT TEMPORARY AND PERMANENT GRASSING (Ds2 & Ds3) SHALL BE USED TO REESTABLISH VEGETATION ON THE DISTURBED AREAS

AS CONSTRUCTION PROCEEDS. TEMPORARY MULCHING (Ds1) SHALL BE USED TO REDUCE RUNOFF AND EROSION. SLOPE MATTING (Mb) SHALL BE INSTALLED ON STEEP SLOPES TO REINFORCE THE GROUND SURFACE, REDUCE EROSION, AND PROVIDE A PROTECTIVE COVERING.


THE EROSION, SEDIMENTATION, AND POLLUTION CONTROL SHALL BE IMPLEMENTED IN THREE PHASES. PHASE I (CLEARING) SHALL CONSIST OF INSTALLING BMPS FOR SITE PREPARATION, INCLUDING SILT FENCE ON SLOPES WITHIN THE PROJECT AREA, TREE PROTECTION FENCE ALONG THE LIMITS OF THE PROJECT AREA, AND CONSTRUCTION ENTRANCES/EXITS SO EQUIPMENT CAN BE BROUGHT ONTO THE SITE. PHASE II (GRADING) SHALL CONSIST OF INSTALLING BMPS FOR CONSTRUCTION, INCLUDING INLET SEDIMENT TRAPS WHERE SEDIMENT COULD POTENTIALLY ENTER STORM DRAINS AND STONE CHECK DAMS WHERE OVERLAND FLOW IS CONCENTRATED IN DITCHES. PHASE III SHALL CONSIST OF SITE RESTORATION, INCLUDING ALL PERMANENT VEGETATION. ONCE CONSTRUCTION OF THE FACILITY IS COMPLETE AND THE DISTURBED AREAS ARE PERMANENTLY VEGETATED, THE EROSION, SEDIMENTATION AND POLLUTION CONTROL PERIMETER DEVICES CAN BE REMOVED.

THE CONTRACTOR SHALL BE RESPONSIBLE FOR THE ESTABLISHMENT OF A STRONG STAND OF GRASS BEFORE BEING RELEASED FROM HIS CONTRACTUAL OBLIGATIONS. THE CONTRACTOR SHALL BE HELD RESPONSIBLE FOR A PERIOD OF TWELVE MONTHS AFTER ACCEPTANCE OF THE PROJECT TO REPAIR ANY WASHOUT AREAS, ETC.

NO ADDITIONAL IMPERVIOUS AREAS WILL BE ADDED, AND STORMWATER DRAINAGE PATTERNS WILL NOT BE AFFECTED DUE TO CONSTRUCTION ACTIVITIES. THEREFORE, A HYDROLOGY STUDY WOULD NOT BE PRODUCTIVE AND IS NOT INCLUDED IN THE CONSTRUCTION DOCUMENTS.

THIS PROJECT DISCHARGES INTO AND IS WITHIN ONE LINEAR MILE OF AN IMPAIRED STREAM SEGMENT. ADDITIONAL BMPS SATISFYING THE REQUIREMENTS OF PART III.C HAVE BEEN INCLUDED IN THESE PLANS. SEE DWG C012 FOR ADDITIONAL BMPS. A TMDL IMPLEMENTATION PLAN HAS BEEN ISSUED FOR THIS IMPAIRED STREAM SEGMENT. ALL NECESSARY MEASURES TO SATISFY THE REQUIREMENTS OF THE TMDL IMPLEMENTATION PLAN HAVE BEEN INCLUDED IN THE EROSION, SEDIMENTATION & POLLUTION CONTROL PLANS.

PRE-CONSTRUCTION RUNOFF COEFFICIENT: 0.40 POST-CONSTRUCTION RUNOFF COEFFICIENT: 0.40

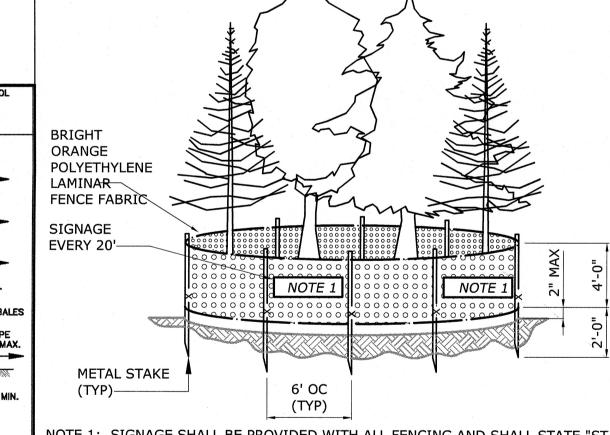

NOTE 1: SIGNAGE SHALL BE PROVIDED WITH ALL FENCING AND SHALL STATE "STAY OUT", "NO ENTRADA", "TREE SAVE", AND "SALVE UN ARBOL" IN ALL LOCATIONS

TREE PROTECTION FENCE

NOT TO SCALE

DUST CONTROL Du

PURPOSE

- PREVENT THE MOVEMENT OF DUST FROM EXPOSED SOIL SURFACES.
- PREVENT THE MOVEMENT OF AIRBORNE SUBSTANCES THAT MAY BE HARMFUL TO

INSTALLATION

APPLY ACCORDING TO APPROVED PLAN, IF

- COVER SURFACES WITH CRUSHED STONE OR GRAVEL.
- APPLY CALCIUM CHLORIDE AT A RATE TO KEEP SURFACES MOIST.
- APPLY SPRAY-ON ADHESIVES TO MINERAL SOILS (NOT MUCK SOILS) AS DESCRIBED IN TABLE 1.

MAINTENANCE

- PROHIBIT TRAFFIC ON SURFACE AFTER SPRAYING.
- SUPPLEMENT SURFACE COVERING AS NEEDED.
- MULCH DISTURBED AREAS AND TACKIFY WITH RESINS SUCH AS ASPHALT, CURASOL OR TERRATACK ACCORDING TO MANUFACTURER'S RECOMMENDATIONS.
- STABILIZE DISTURBED AREAS WITH TEMPORARY OR PERMANENT VEGETATION.
- IRRIGATE DISTURBED AREAS UNTIL SURFACE IS

TABLE 1 - SPRAY-ON ADHESIVE APPLICATION REQUIREMENTS

	ADHESIVE	WATER DILUTION	NOZZLE TYPE	APPLICATION (GAL./ACRE)	
	ANIONIC ASPHALT EMULSION	7:1*	COARSE SPRAY	1,200	
	LATEX EMULSION	12.5:1*	FINE SPRAY	235	
	RESIN-IN-WATER EMULSION	4:1*	FINE SPRAY	300	

*USE MANUFACTURER'S RECOMMENDATIONS WHEN AVAILABLE

INLET SEDIMENT TRAP (Sd2) PURPOSE PREVENT SEDIMENT FROM ENTERING - CONCRETE BLOCK STORM DRAINAGE SYSTEMS.

DO NOT INSTALL WHERE VEHICULAR

INSTALL AT OR AROUND ALL STORM

RUNOFF FROM DISTURBED AREAS.

CONSTRUCT ON NATURAL GROUND

IN EXCAVATED SEDIMENT TRAPS.

MUST BE SELF-DRAINING UNLESS

BLOCK AND GRAVEL DROP INLET PROTECTION (Sd2-Bg)

EXCAVATE FOUNDATION AT LEAST 2"

SIDE TO ALLOW POOL DRAINAGE.

PLACE THE BOTTOM ROW OF BLOCKS

AGAINST THE EDGE OF THE STORM

ADD SUPPORT BY PLACING 2"X4" WOOD

STUDS THROUGH BLOCK OPENINGS.

FIT HARDWARE CLOTH OR WIRE MESH

WITH 1/2" OPENINGS OVER ALL BLOCK

BELOW THE CREST OF THE STORM DRAIN

ON EACH SIDE OF THE STRUCTURE, PLACE

ONE BLOCK IN THE BOTTOM ROW ON ITS

MACHINE COMPACTED FILL.

EXCAVATED INLET SEDIMENT TRAP

OTHERWISE PROTECTED.

SURFACE, EXCAVATED SURFACE, OR ON

MINIMUM OF 1.5' OF SEDIMENT STORAGE

DRAIN DROP INLETS THAT RECEIVE

TRAFFIC WILL BE AFFECTED.

INSTALLATION

IF SHOWN.

GRAVEL DROP INLET PROTECTION (GRAVEL DONUT) 6d2-6

- 3:1 OR FLATTER SLOPE TOWARD THE INLET. INSTALL ACCORDING TO APPROVED PLAN,
 - CREATE A MINIMUM 1' WIDE LEVEL STONE AREA BETWEEN THE STRUCTURE AND THE INLET TO PREVENT GRAVEL FROM ENTERING
 - THE INLET. PLACE STONE 3" IN DIAMETER, OR LARGER,
 - ON THE SLOPE TOWARD THE INLET. • PLACE 1/2" TO 3/4" GRAVEL ON THE SLOPE
 - AWAY FROM THE INLET AT A MINIMUM THICKNESS OF 1'. CURB INLET PROTECTION "PIGS-IN-A-BLANKET" Sd2-P
 - INSTALL FILTER AFTER ASPHALT PAVEMENT INSTALLATION.

18" MIN

- WRAP 8" CONCRETE BLOCKS IN FILTER FABRIC AND SPAN ACROSS CATCH BASIN
- FACE OPENINGS IN BLOCKS OUTWARD. • LEAVE A GAP OF APPROXIMATELY 4 INCHES
- INSTALL OUTLET PROTECTION BELOW STORM DRAIN OUTLETS.

ALLOW FOR OVERFLOW TO PREVENT

HAZARDOUS PONDING.

BETWEEN THE CURB AND THE FILTERS TO


- MAINTENANCE
- THE END OF EACH WORKING DAY.

• INSPECT, CLEAN, AND/OR REPAIR TRAP AT

 DO NOT REMOVE INLET PROTECTION AND WASH SEDIMENT INTO THE STORM DRAIN.

W/ MIN. WEIGHT = 1.3 lbs/ft.


- REMOVE SEDIMENT FROM THE TRAP AND
- OPENINGS TO HOLD GRAVEL IN PLACE. STABILIZE IT WITH VEGETATION. • PLACE CLEAN GRAVEL 2" BELOW THE TOP • REMOVE ALL MATERIALS AND ANY UNSTABLE
- SOIL ONCE THE CONTRIBUTING DRAINAGE OF THE BLOCK ON A 2:1 OR FLATTER AREA HAS BEEN ADEQUATELY STABILIZED. SLOPE AND SMOOTH IT TO AN EVEN GRADE. GDOT #57 STONE IS
 - APPROPRIATELY STABILIZE ALL BARE AREAS AROUND THE INLET.

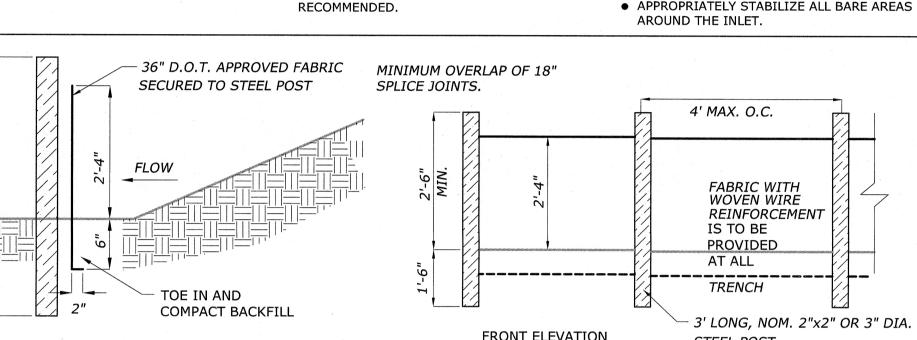

SILT FENCE TYPE POST MAT'L REINFORCEMENT **WOVEN WIRE** STEEL BEHIND FABRIC

- 1. EXTRA STRENGTH FILTER FABRIC (AS APPROVED BY ENGINEER) WITH 4'-0" POST SPACING DOES NOT REQUIRE MESH SUPPORT FENCE.
- 2. FILTER FABRIC SHALL BE WIRED DIRECTLY TO POST.
- 3. REINFORCED TYPE "C" SILT FENCING IS REQUIRED WHERE SLOPES EXCEED 2:1 OR AS REQUIRED BY ENGINEER.
- 4. FILTER FABRIC MUST BE SUPPORTED WITH 4'-0" POST SPACING AT LOCATIONS NEAR (WITHIN 25') OF SEDIMENT PONDS.
- 5. WHERE DOUBLE ROWS OF SILT FENCING ARE SPECIFIED OR ORDERED BY ENGINEER, CONTRACTOR SHALL SPACE ROWS 2' APART.
- 6. ALL SILT FENCE SHALL BE TYPE "C".

SILT FENCING (sd1-C

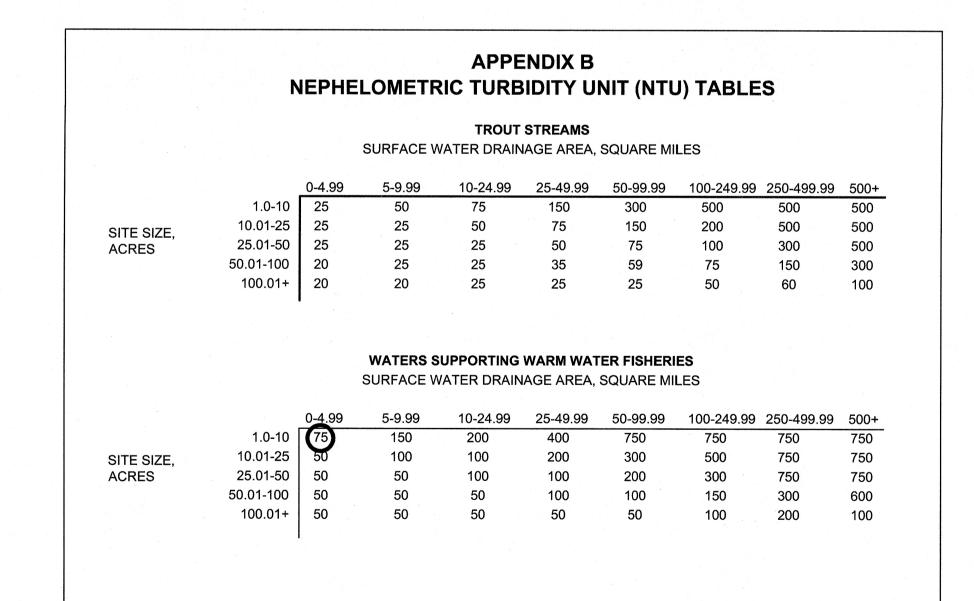

GSWCC

Certification Number: 000000432

CRUSHED STONE CONSTRUCTION EXIT **EXIT DIAGRAM**

NOTES:

1. USE STEEL OR WOOD POSTS OR AS SPECIFIED BY THE EROSION, SEDIMENTATION,

2. HEIGHT (*) IS TO BE SHOWN ON THE EROSION, SEDIMENTATION, AND POLLUTION

AND POLLUTION CONTROL PLAN.

SILT FENCE - TYPE SENSITIVE


SIDE VIEW


FRONT VIEW

— 4' MAX. O.C. ——

(WOVEN WIRE FENCE

BACKING)

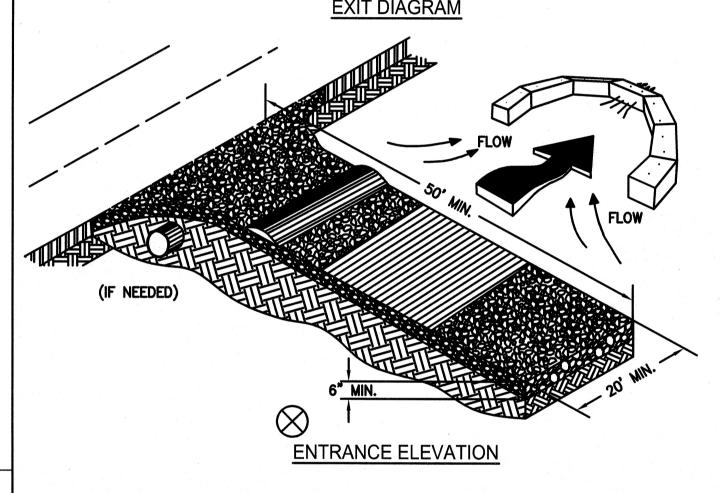

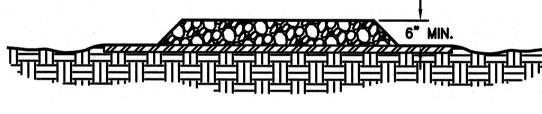

1. AVOID LOCATING ON STEEP SLOPES OR AT CURVES ON PUBLIC ROADS. 2. REMOVE ALL VEGETATION AND OTHER UNSUITABLE MATERIAL FROM THE FOUNDATION AREA, GRADE, AND CROWN FOR POSITIVE DRAINAGE. 3. AGGREGATE SIZE SHALL BE IN ACCORDANCE WITH NATIONAL STONE ASSOCIATION R-2 (1.5"-3.5" STONE). . GRAVEL PAD SHALL HAVE A MINIMUM THICKNESS OF 6".

5. PAD WIDTH SHALL BE EQUAL FULL WIDTH AT ALL POINTS OF VEHICULAR EGRESS, BUT NO LESS THAN 20°. 5. A DIVERSION RIDGE SHOULD BE CONSTRUCTED WHEN GRADE TOWARD PAVED AREA IS GREATER THAN 2%. '. INSTALL PIPE UNDER THE ENTRANCE IF NEEDED TO MAINTAIN DRAINAGE DITCHES. B. WHEN WASHING IS REQUIRED, IT SHOULD BE DONE ON AN AREA STABILIZED WITH CRUSHED STONE THAT DRAINS INTO AN APPROVED SEDIMENT TRAP OR SEDIMENT BASIN (DIVERT ALL SURFACE RUNOFF AND

DRAINAGE FROM THE ENTRANCE TO A SEDIMENT CONTROL DEVICE). . WASHRACKS AND/OR TIRE WASHERS MAY BE REQUIRED DEPENDING ON SCALE AND CIRCUMSTANCE. IF NECESSARY, WASHRACK DESIGN MAY CONSIST OF ANY MATERIAL <u>SUITABLE</u> FOR TRUCK TRAFFIC THAT

REMOVE MUD AND DIRT. 10.MAINTAIN AREA IN A WAY THAT PREVENTS TRACKING AND/OR FLOW OF MUD ONTO PUBLIC RIGHTS-OF-WAYS. THIS MAY REQUIRE TOP DRESSING, REPAIR AND/OR CLEANOUT OF ANY MEASURES USED TO TRAP SEDIMENT.

TOTAL DISTURBED AREA = 4.79 ACRES



KNOW WHAT'S BELOW CALL BEFORE YOU DIG. LLAME ANTES DE CAVAR. IT'S THE LAW. ES LA LEY

CALL 811 BEFORE YOU DIG! CALL BEFORE YOU DIG! 1.800.282.7411

D. EHRHARD ENGINEER: DESIGNED BY: T. SCHUELER DRAWN BY: S.KAN D. EHRHARD CHECKED BY: IF THIS BAR DOES NOT 1/2" MEASURE 1" THEN DRAWING IS NOT TO FULL SCALE **ISSUED FOR**

DETAIL F-4 FILTER BAG

ELEVATION

TIGHTLY SEAL SLEEVE AROUND THE PUMP DISCHARGE HOSE WITH A STRAP OR SIMILAR DEVICE.

STRAW BALES) LOCATED ON A LEVEL OR 5% MAXIMUM SLOPING SURFACE, DISCHARGE TO A STABILIZED AREA. EXTEND BASE A MINIMUM OF 12 INCHES FROM EDGES OF BAG.

CONTROL PUMPING RATE TO PREVENT EXCESSIVE PRESSURE WITHIN THE FILTER BAG IN ACCORDANCE WITH THE MANUFACTURER RECOMMENDATIONS. AS THE BAG FILLS WITH SEDIMENT, REDUCE PUMPING RATE.

REMOVE AND PROPERLY DISPOSE OF FILTER BAG UPON COMPLETION OF PUMPING OPERATIONS OR AFTER BAG HAS REACHED CAPACITY, WHICHEVER OCCURS FIRST. SPREAD THE DEWATERED SEDIMENT FROM THE BAG IN AN APPROVED UPLAND AREA AND STABILIZE WITH SEED AND MULCH BY THE END OF THE WORK DAY, RESTORE THE SURFACE AREA BENEATH THE BAG TO ORIGINAL CONDITION UPON DEPARTMENT OF THE PROPERTY.

USE NONWOVEN GEOTEXTILE WITH DOUBLE STITCHED SEAMS USING HIGH STRENGTH THREAD. SIZE SLEEVE TO ACCOMMODATE A MAXIMUM 4 INCH DIAMETER PUMP DISCHARGE HOSE. THE BAG MUST B MANUFACTURED FROM A NONWOVEN GEOTEXTILE THAT MEETS OR EXCEEDS MINIMUM AVERAGE ROLL VALUES (MARV) FOR THE FOLLOWING:

REPLACE FILTER BAG IF BAG CLOGS OR HAS RIPS, TEARS, OR PUNCTURES. DURING OPERATION KEEP CONNECTION BETWEEN PUMP HOSE AND FILTER BAG WATER TIGHT. REPLACE BEDDING IF IT BECOMES DISPLACED.

MARYLAND STANDARDS AND SPECIFICATIONS FOR SOIL EROSION AND SEDIMENT CONTROL 2011

PUMP DISCHARGE HOSE -

PUNCTURE FLOW RATE

CONSTRUCTION SPECIFICATIONS

100% SUBMITTAL



Hazen HAZEN AND SAWYER 5775 PEACHTREE DUNWOODY ROAD.

SUITE D-520

ATLANTA, GA 30342

DOUGLASVILLE-DOUGLAS COUNTY WATER AND SEWER AUTHORITY

DEWATERING -

2' MAX

SEDIMENT-

- 2:1 SLOPE, GRAVEL FILTER

-TEMPORARY SEDIMENT POOL

─ DROP INLET WITH GATE

WIRE SCREEN

DEWATERING

STEWART MILL ROAD SANITARY SEWER REPLACEMENT PROJECT



Georgia Soil and Water

Conservation Commission

Alan E Bowling
Level II Certified Design Professional

OWNER/PRIMARY PERMITTEE:

8763 HOSPITAL DRIVE

PH. (770) 920-3819

MBACA@DDCWSA.COM

DOUGLASVILLE, GA 30134

DOUGLASVILLE-DOUGLAS COUNTY

WATER AND SEWER AUTHORITY


EROSION SEDIMENTATION AND POLLUTION CONTROL PLAN CIVIL **DETAILS**

24-HOUR CONTACT

NAME: MIGUEL A. BACA, P.E

PHONE: (770) 920-3819

MAY 2019 31247-010 HAZEN NO.: CONTRACT NO.: 22B4413-02 DRAWING NUMBER:

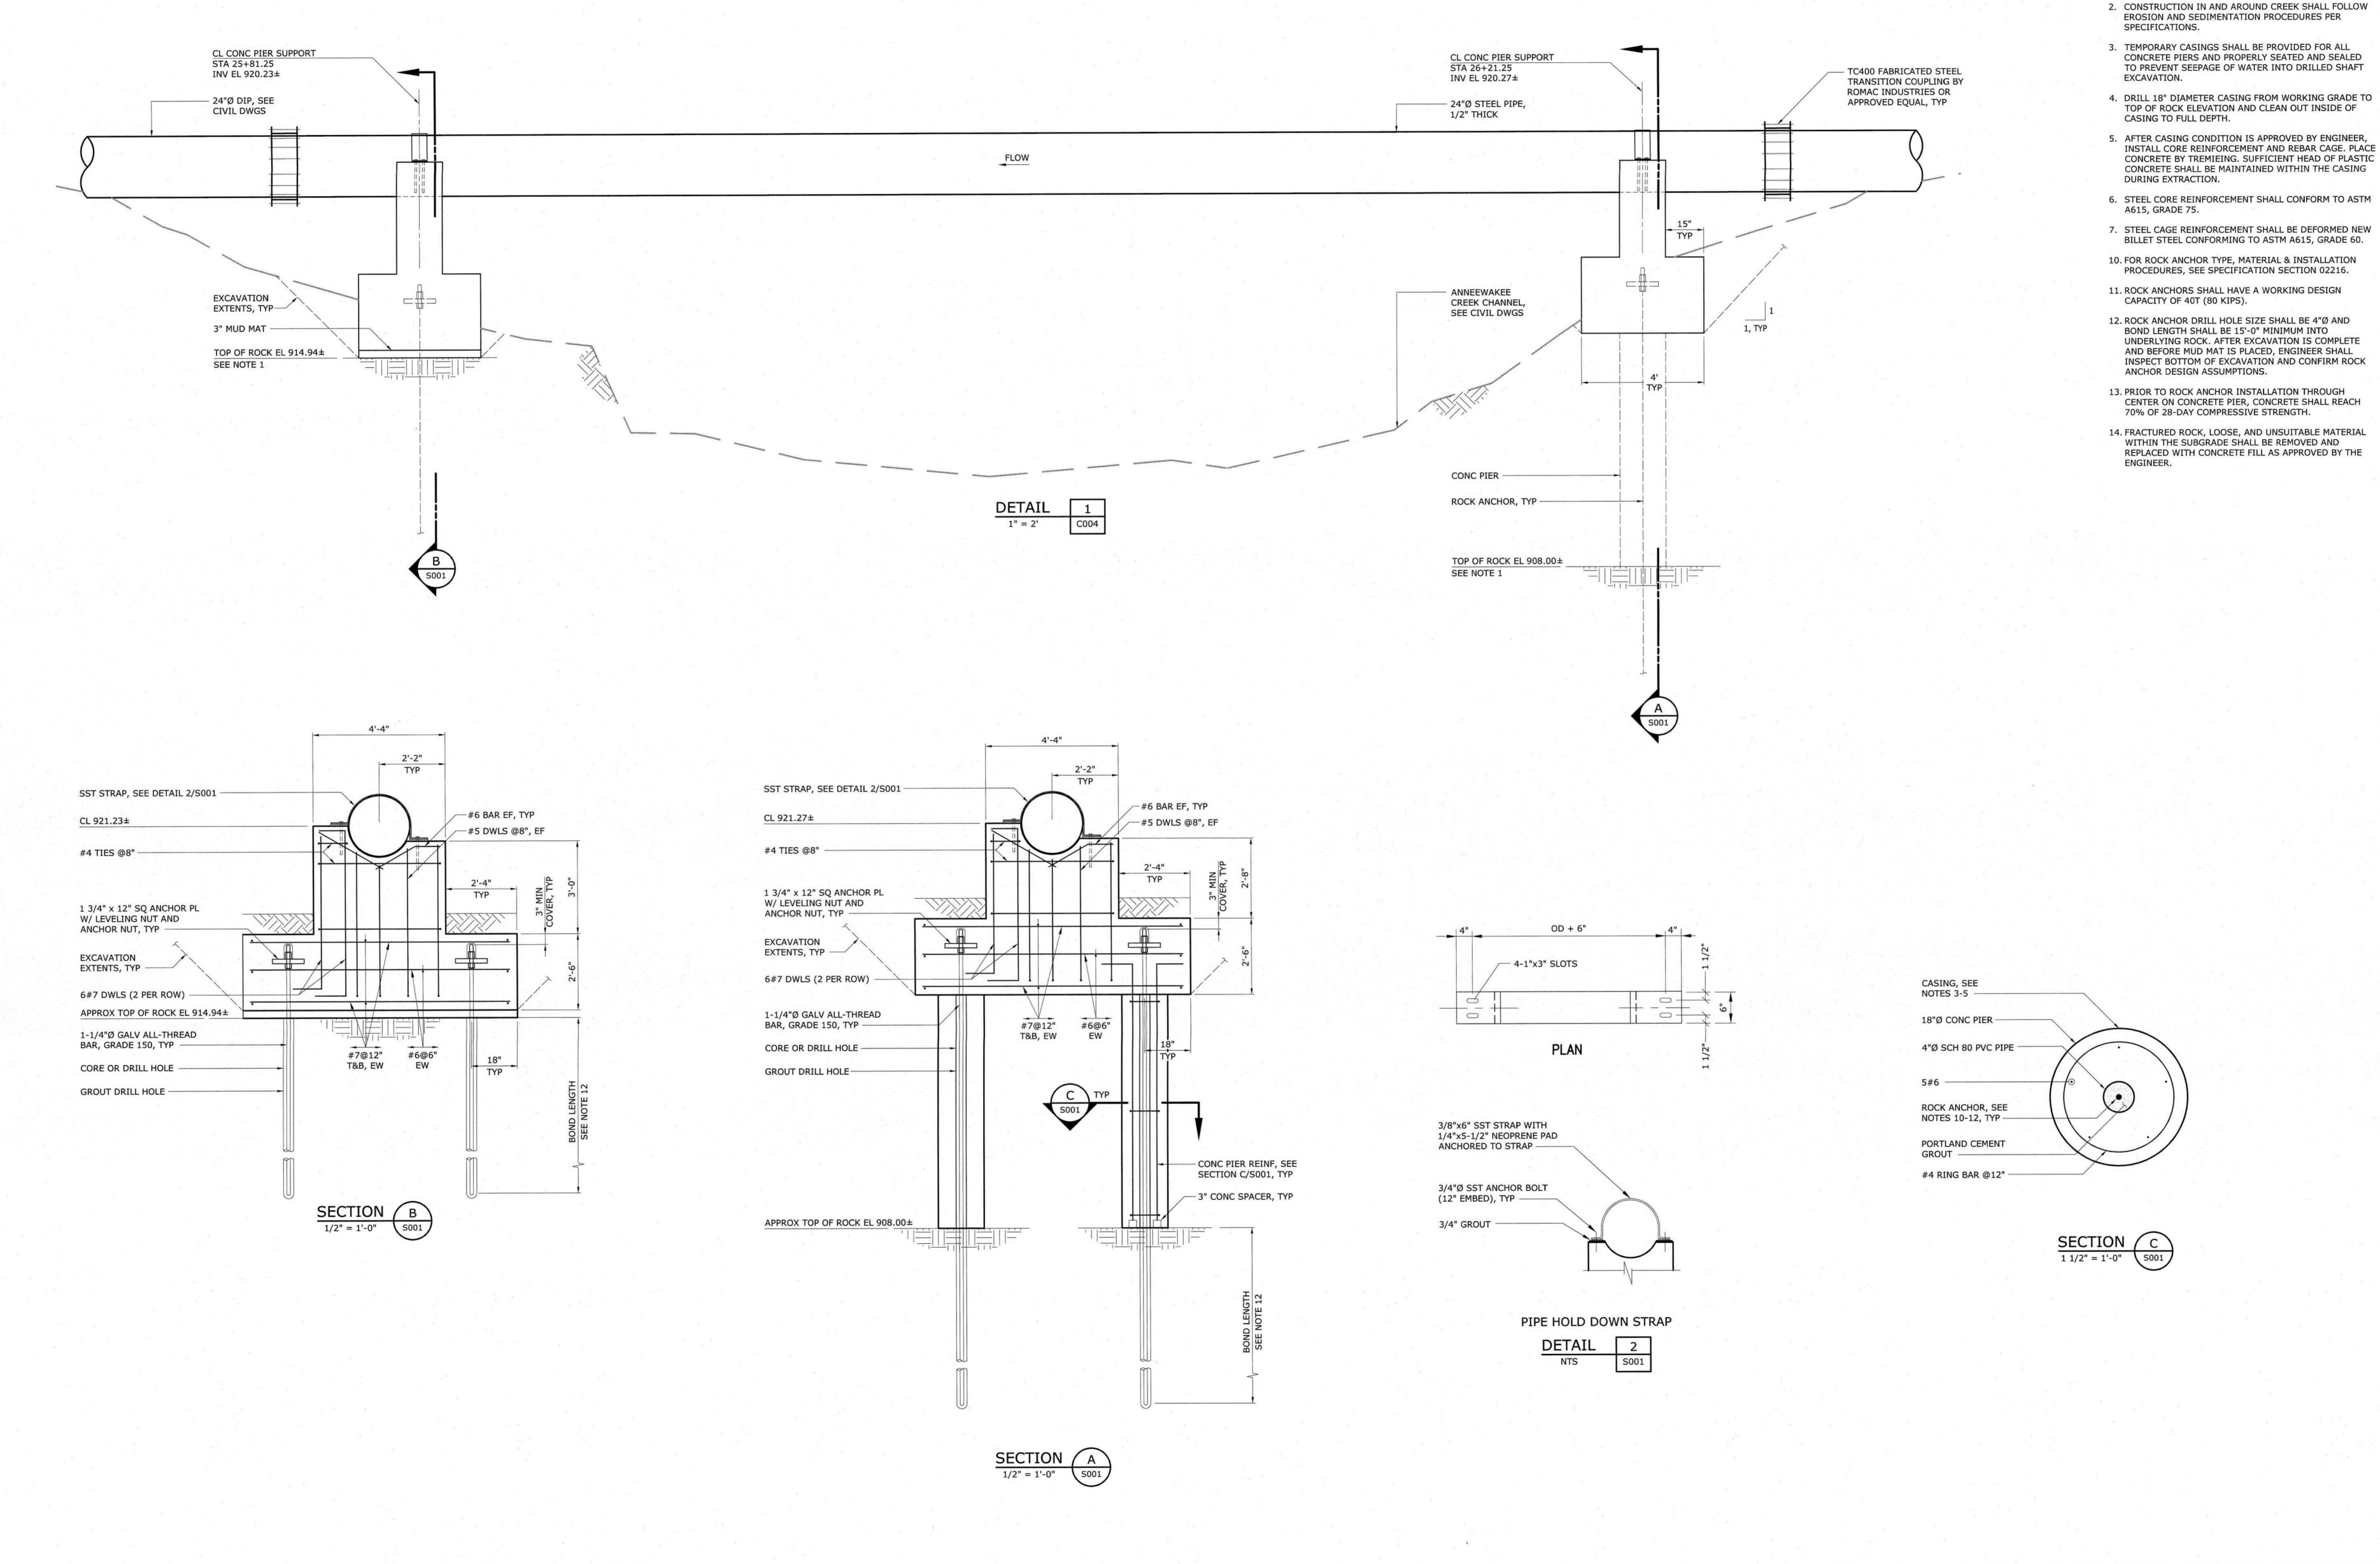

PROJECT
ENGINEER:

D. EHRHARDT

DESIGNED BY:

G. JOHNSON

DRAWN BY:

CHECKED BY:

F. POWELL

IF THIS BAR DOES NOT
MEASURE 1" THEN DRAWING
IS NOT TO FULL SCALE

O 1/2" 1"

MEASURE 1" THEN DRAWING
IS NOT TO FULL SCALE



100% SUBMITTAL

HAZEN AND SAWYER
5775 PEACHTREE DUNWOODY ROAD,
SUITE D-520
ATLANTA, GA 30342

DOUGLASVILLE-DOUGLAS COUNTY WATER AND SEWER AUTHORITY

STEWART MILL ROAD SANITARY SEWER
REPLACEMENT PROJECT



AERIAL PIPE CROSSING STRUCTURAL SECTION AND DETAIL

NOTES:


ROCK SURFACE ELEVATION SHALL BE FIELD VERIFIED.


DATE: MAY 2019


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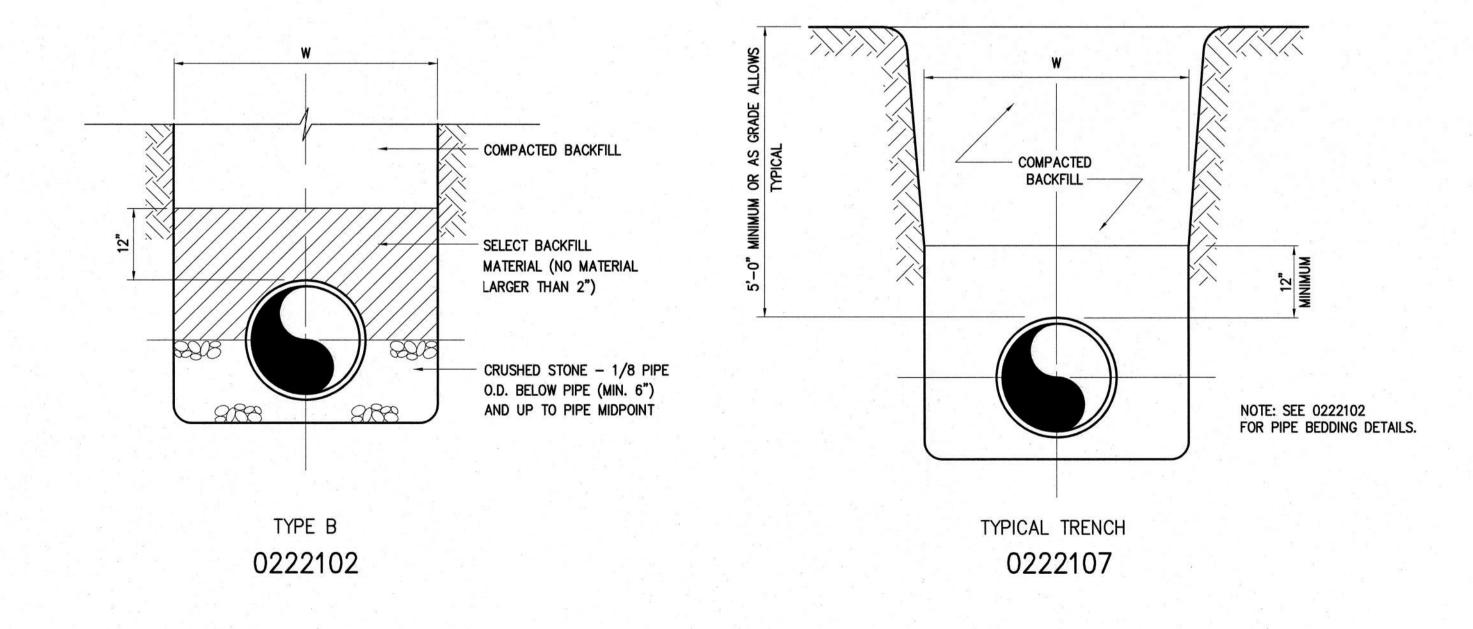
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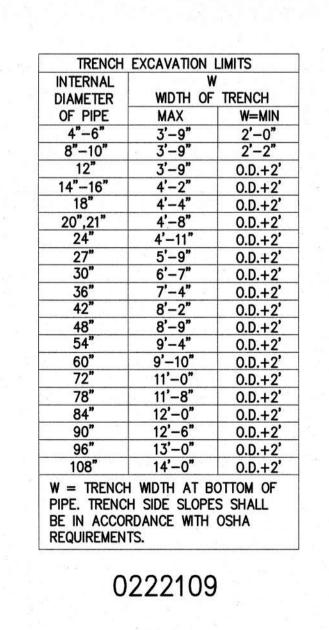
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(-					
				PROJECT ENGINEER:	D. EHRHARDT
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				DRAWN BY:	CMC
		T 150 110		CHECKED BY:	DSE
				IF THIS BAR DOES NOT MEASURE 1" THEN DRAWIN	0 1/2" 1"
DE\/	ISSUED FOR	DATE	BV	IS NOT TO FULL SCALE	

DE CONTRACTOR OF THE PROPERTY OF THE PROPERTY

100% SUBMITTAL

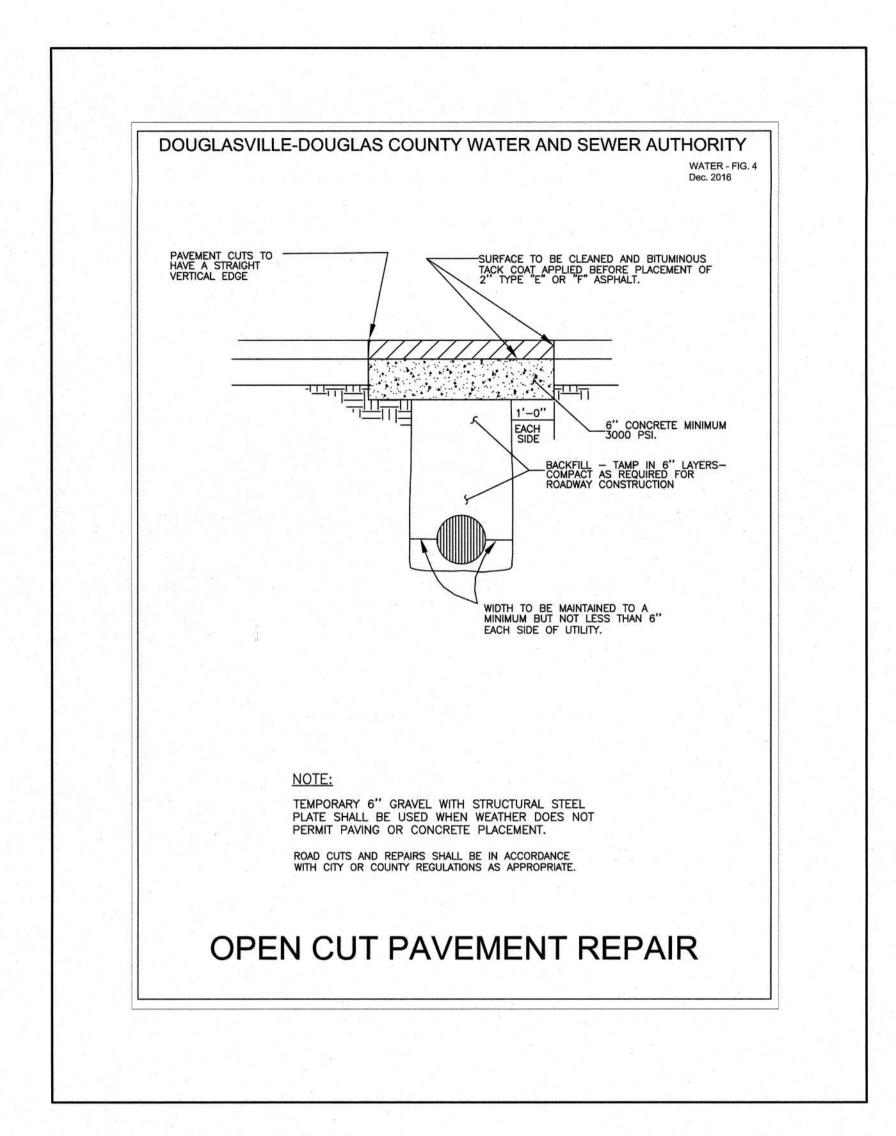

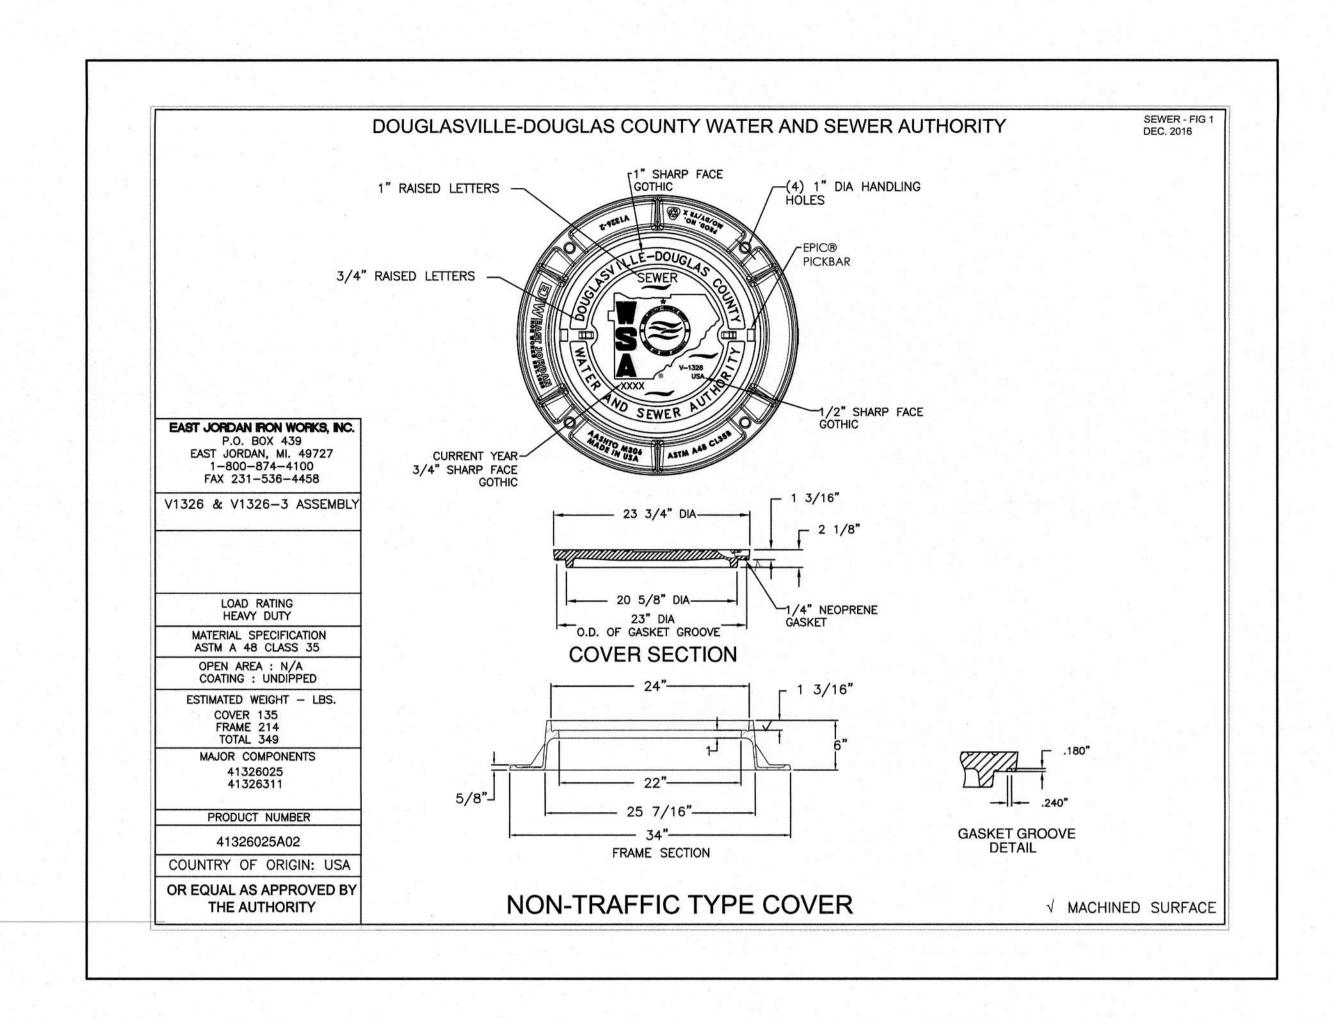DOUGLASVILLE-DOUGLAS COUNTY WATER AND SEWER AUTHORITY

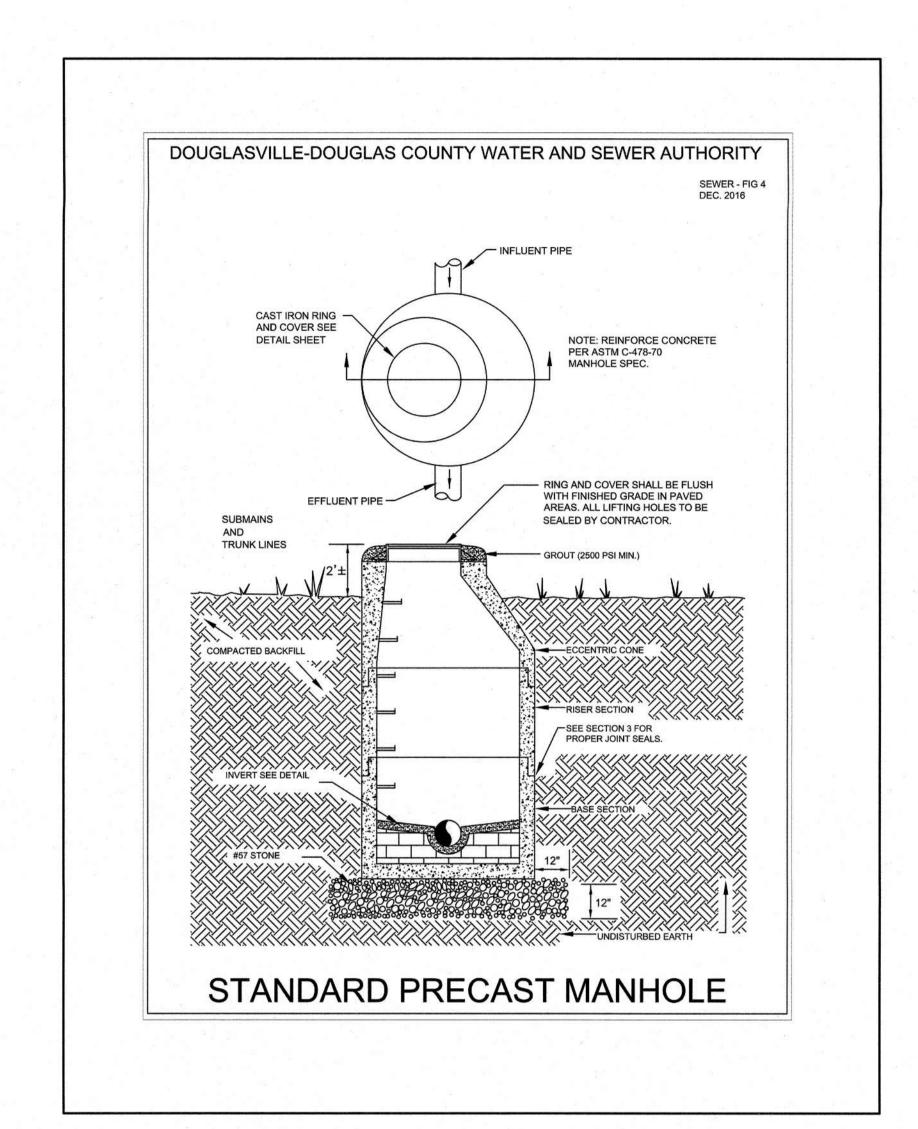STEWART MILL ROAD SANITARY SEWER
REPLACEMENT PROJECT



STANDARD DETAILS MISCELLANEOUS STANDARD DETAILS

DATE:	MAY 2019
HAZEN NO.:	31247-010
CONTRACT NO.	:22B4413-02
DRAWING NUMBER:	
	D001