

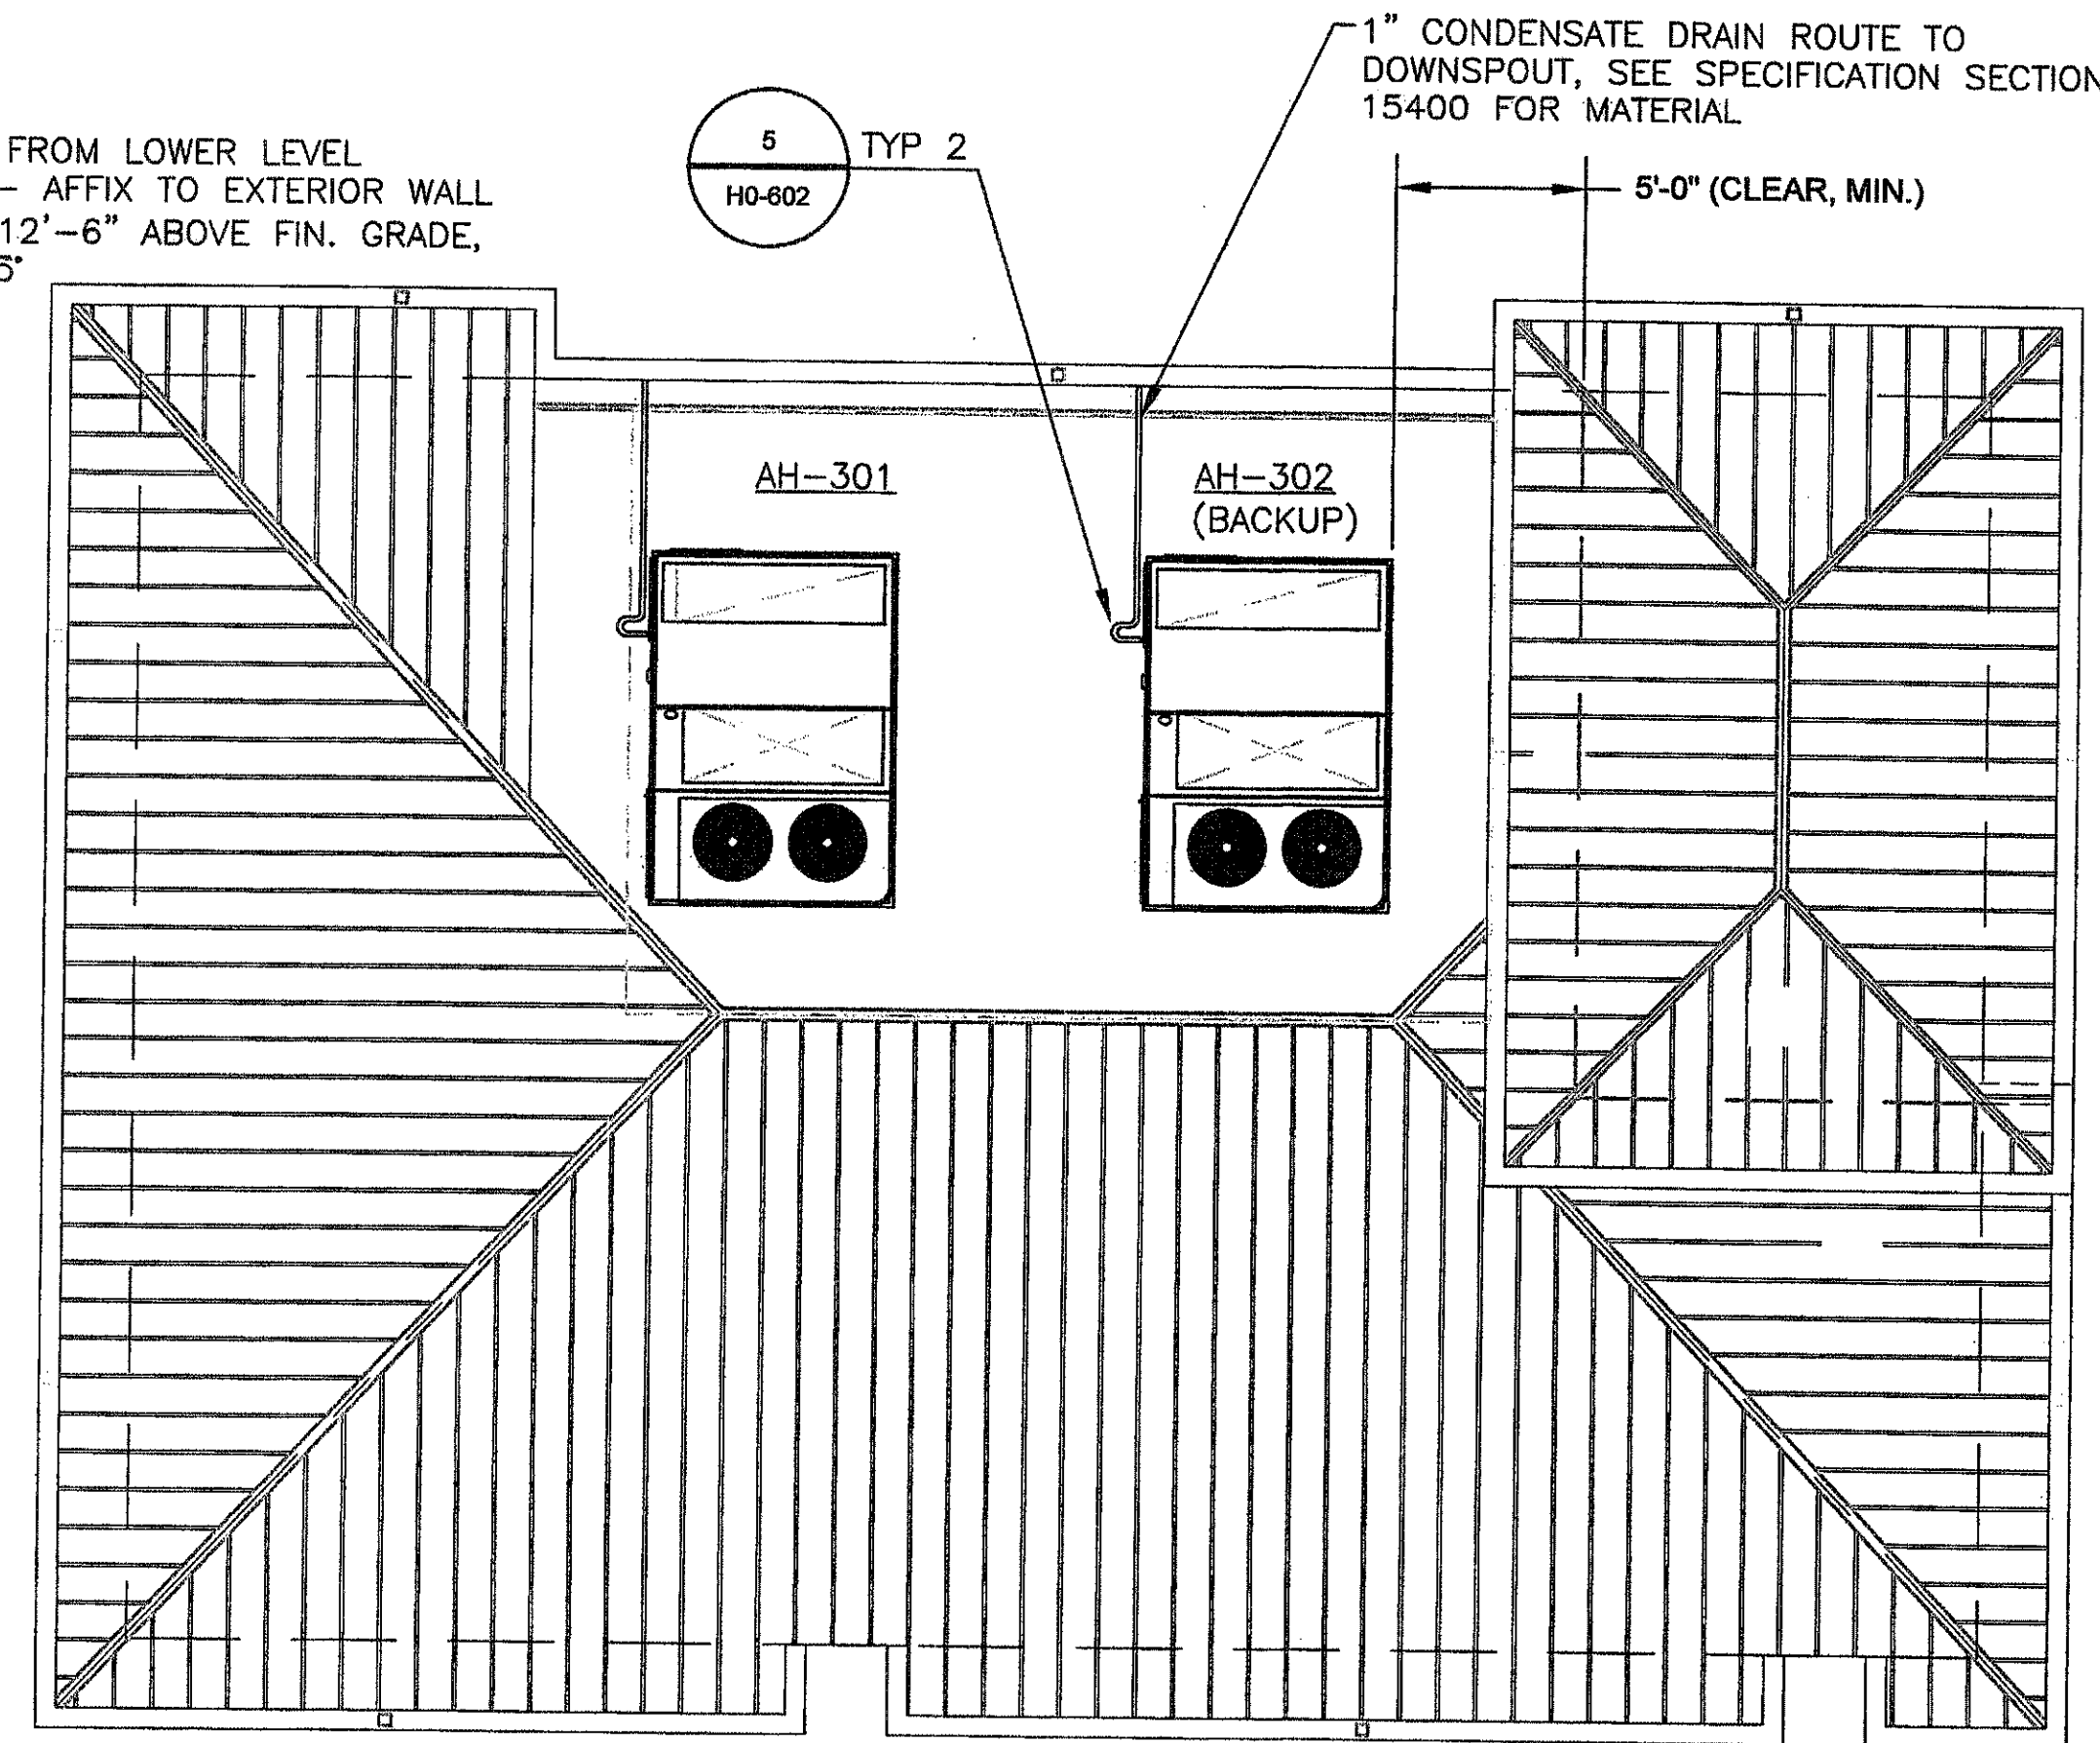


1 2 3 4 5 6 7 8

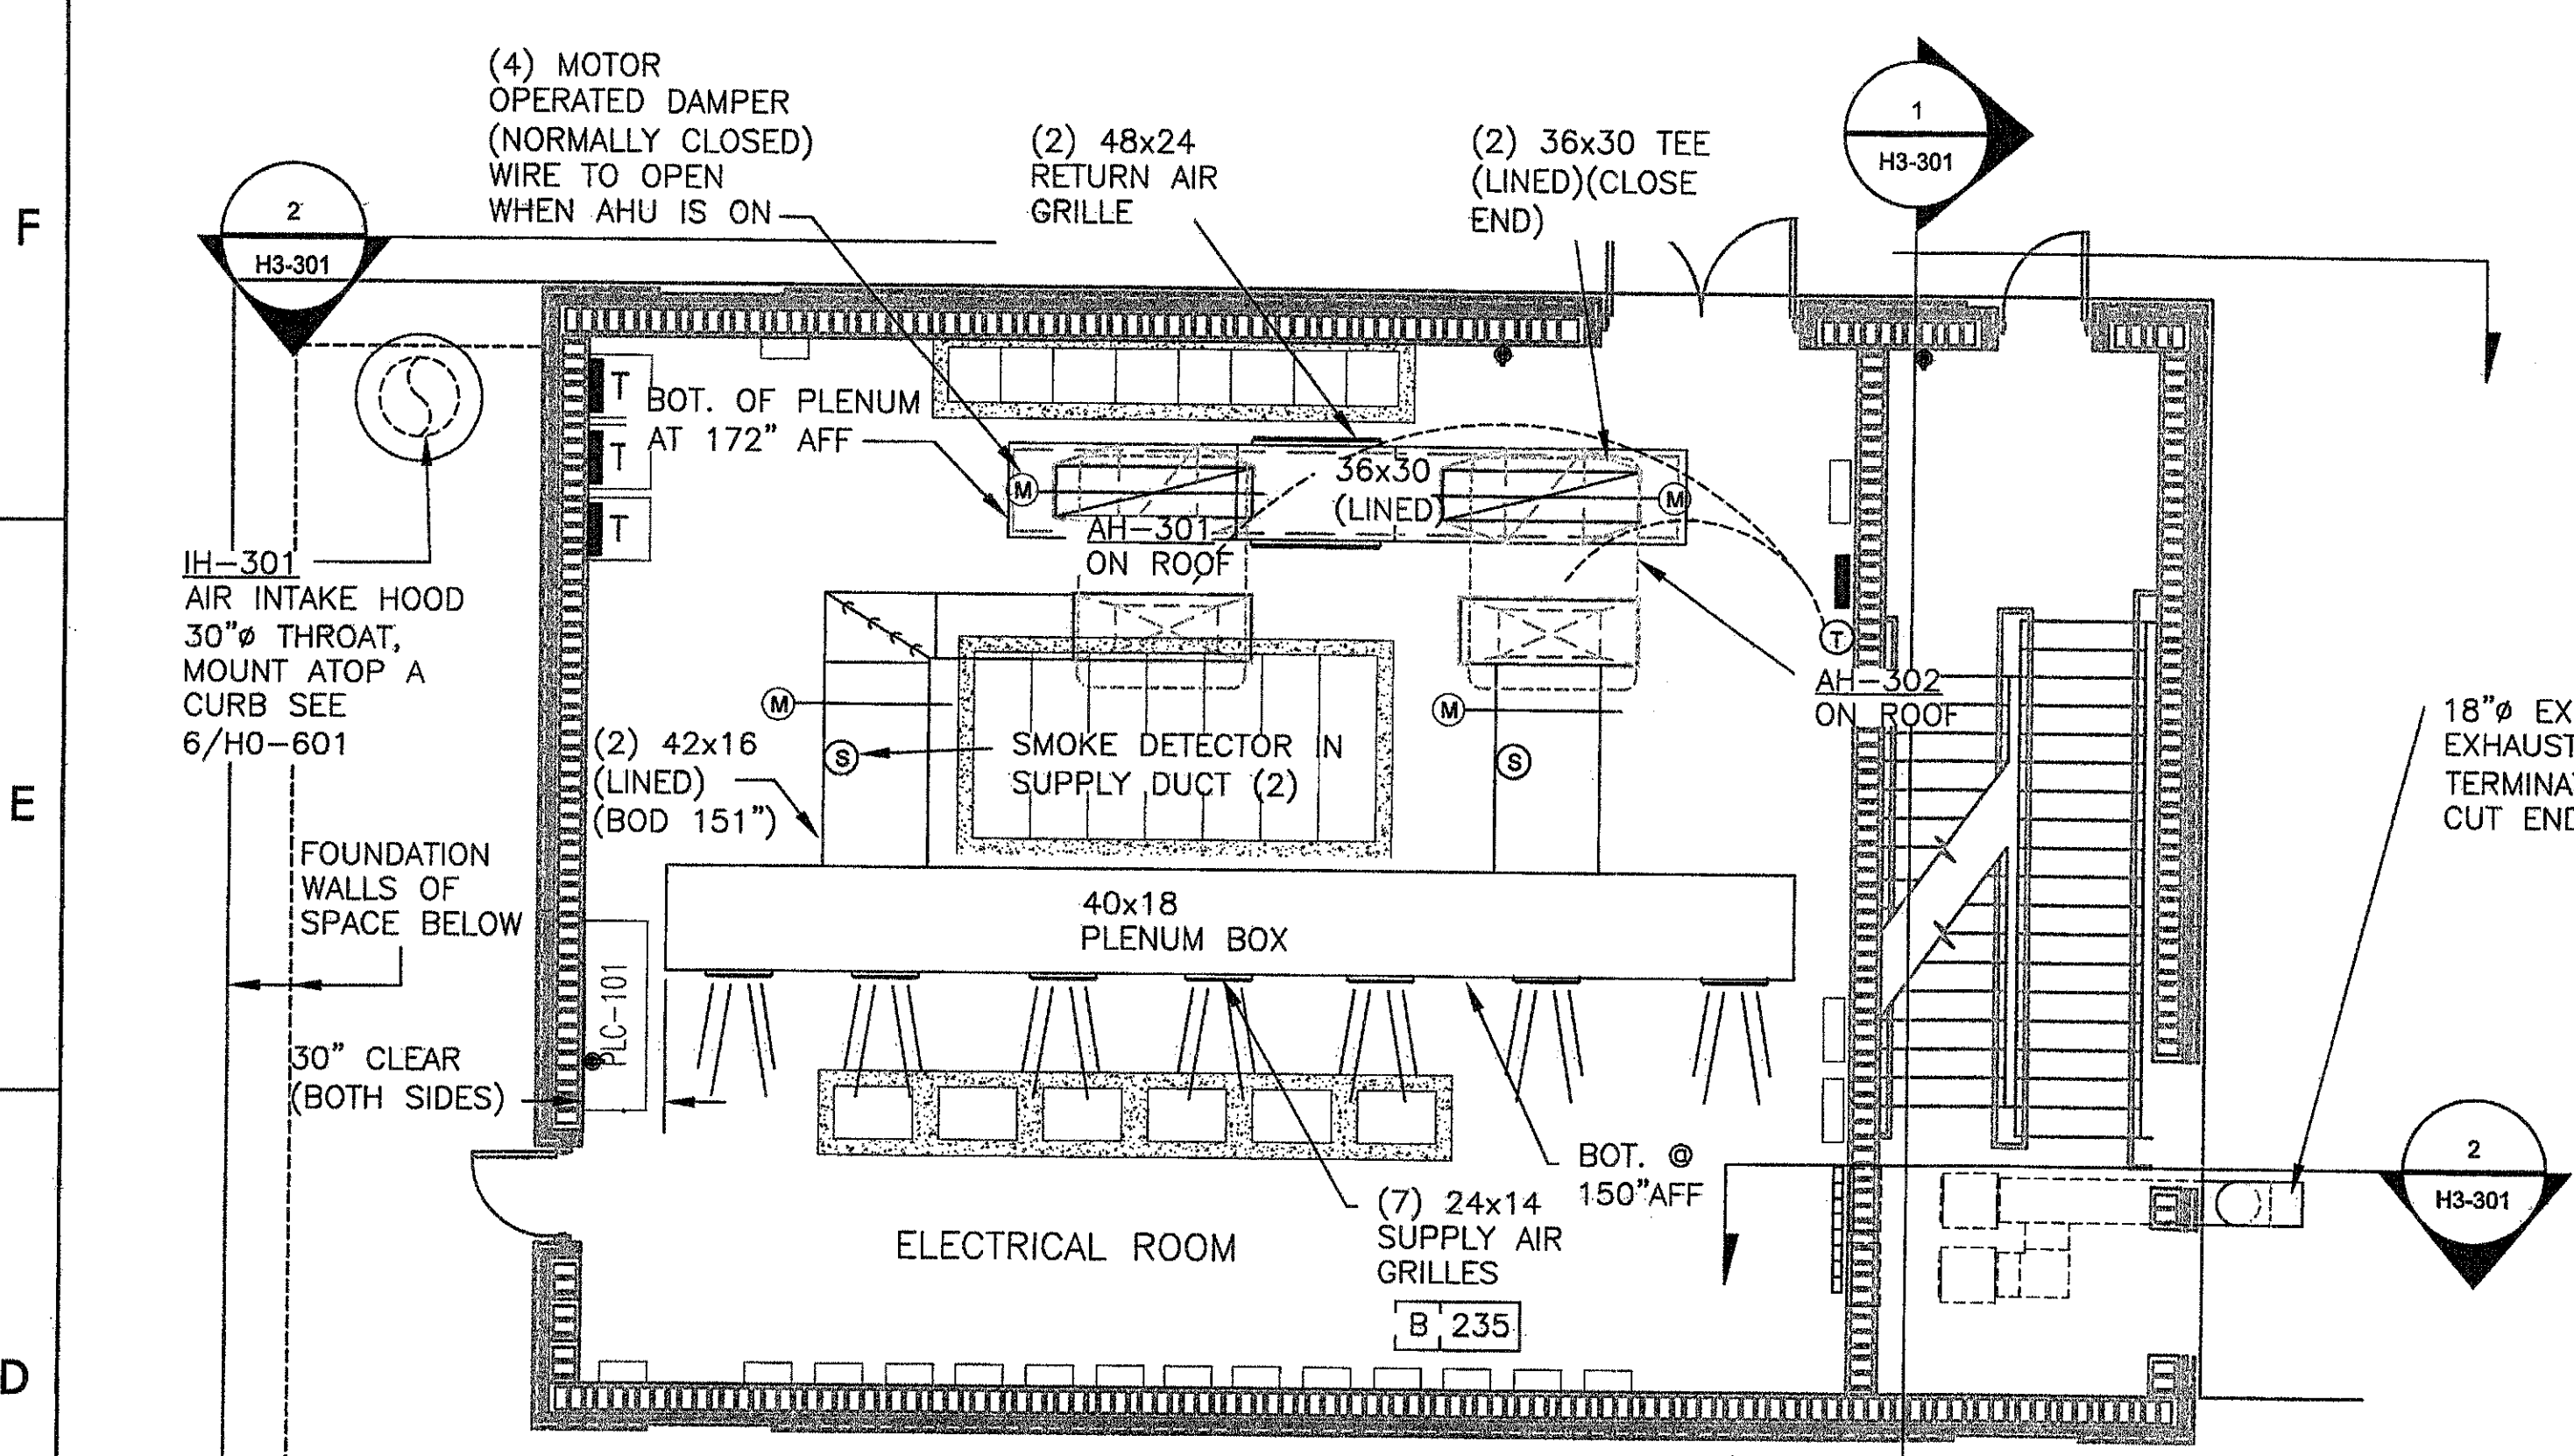

1 HVAC PLAN DIVERSION PUMP STATION UPPER LEVEL
 H3-102 SCALE: 3/16"=1'-0" FIN. FLR. EL. 824'-6" NORTH

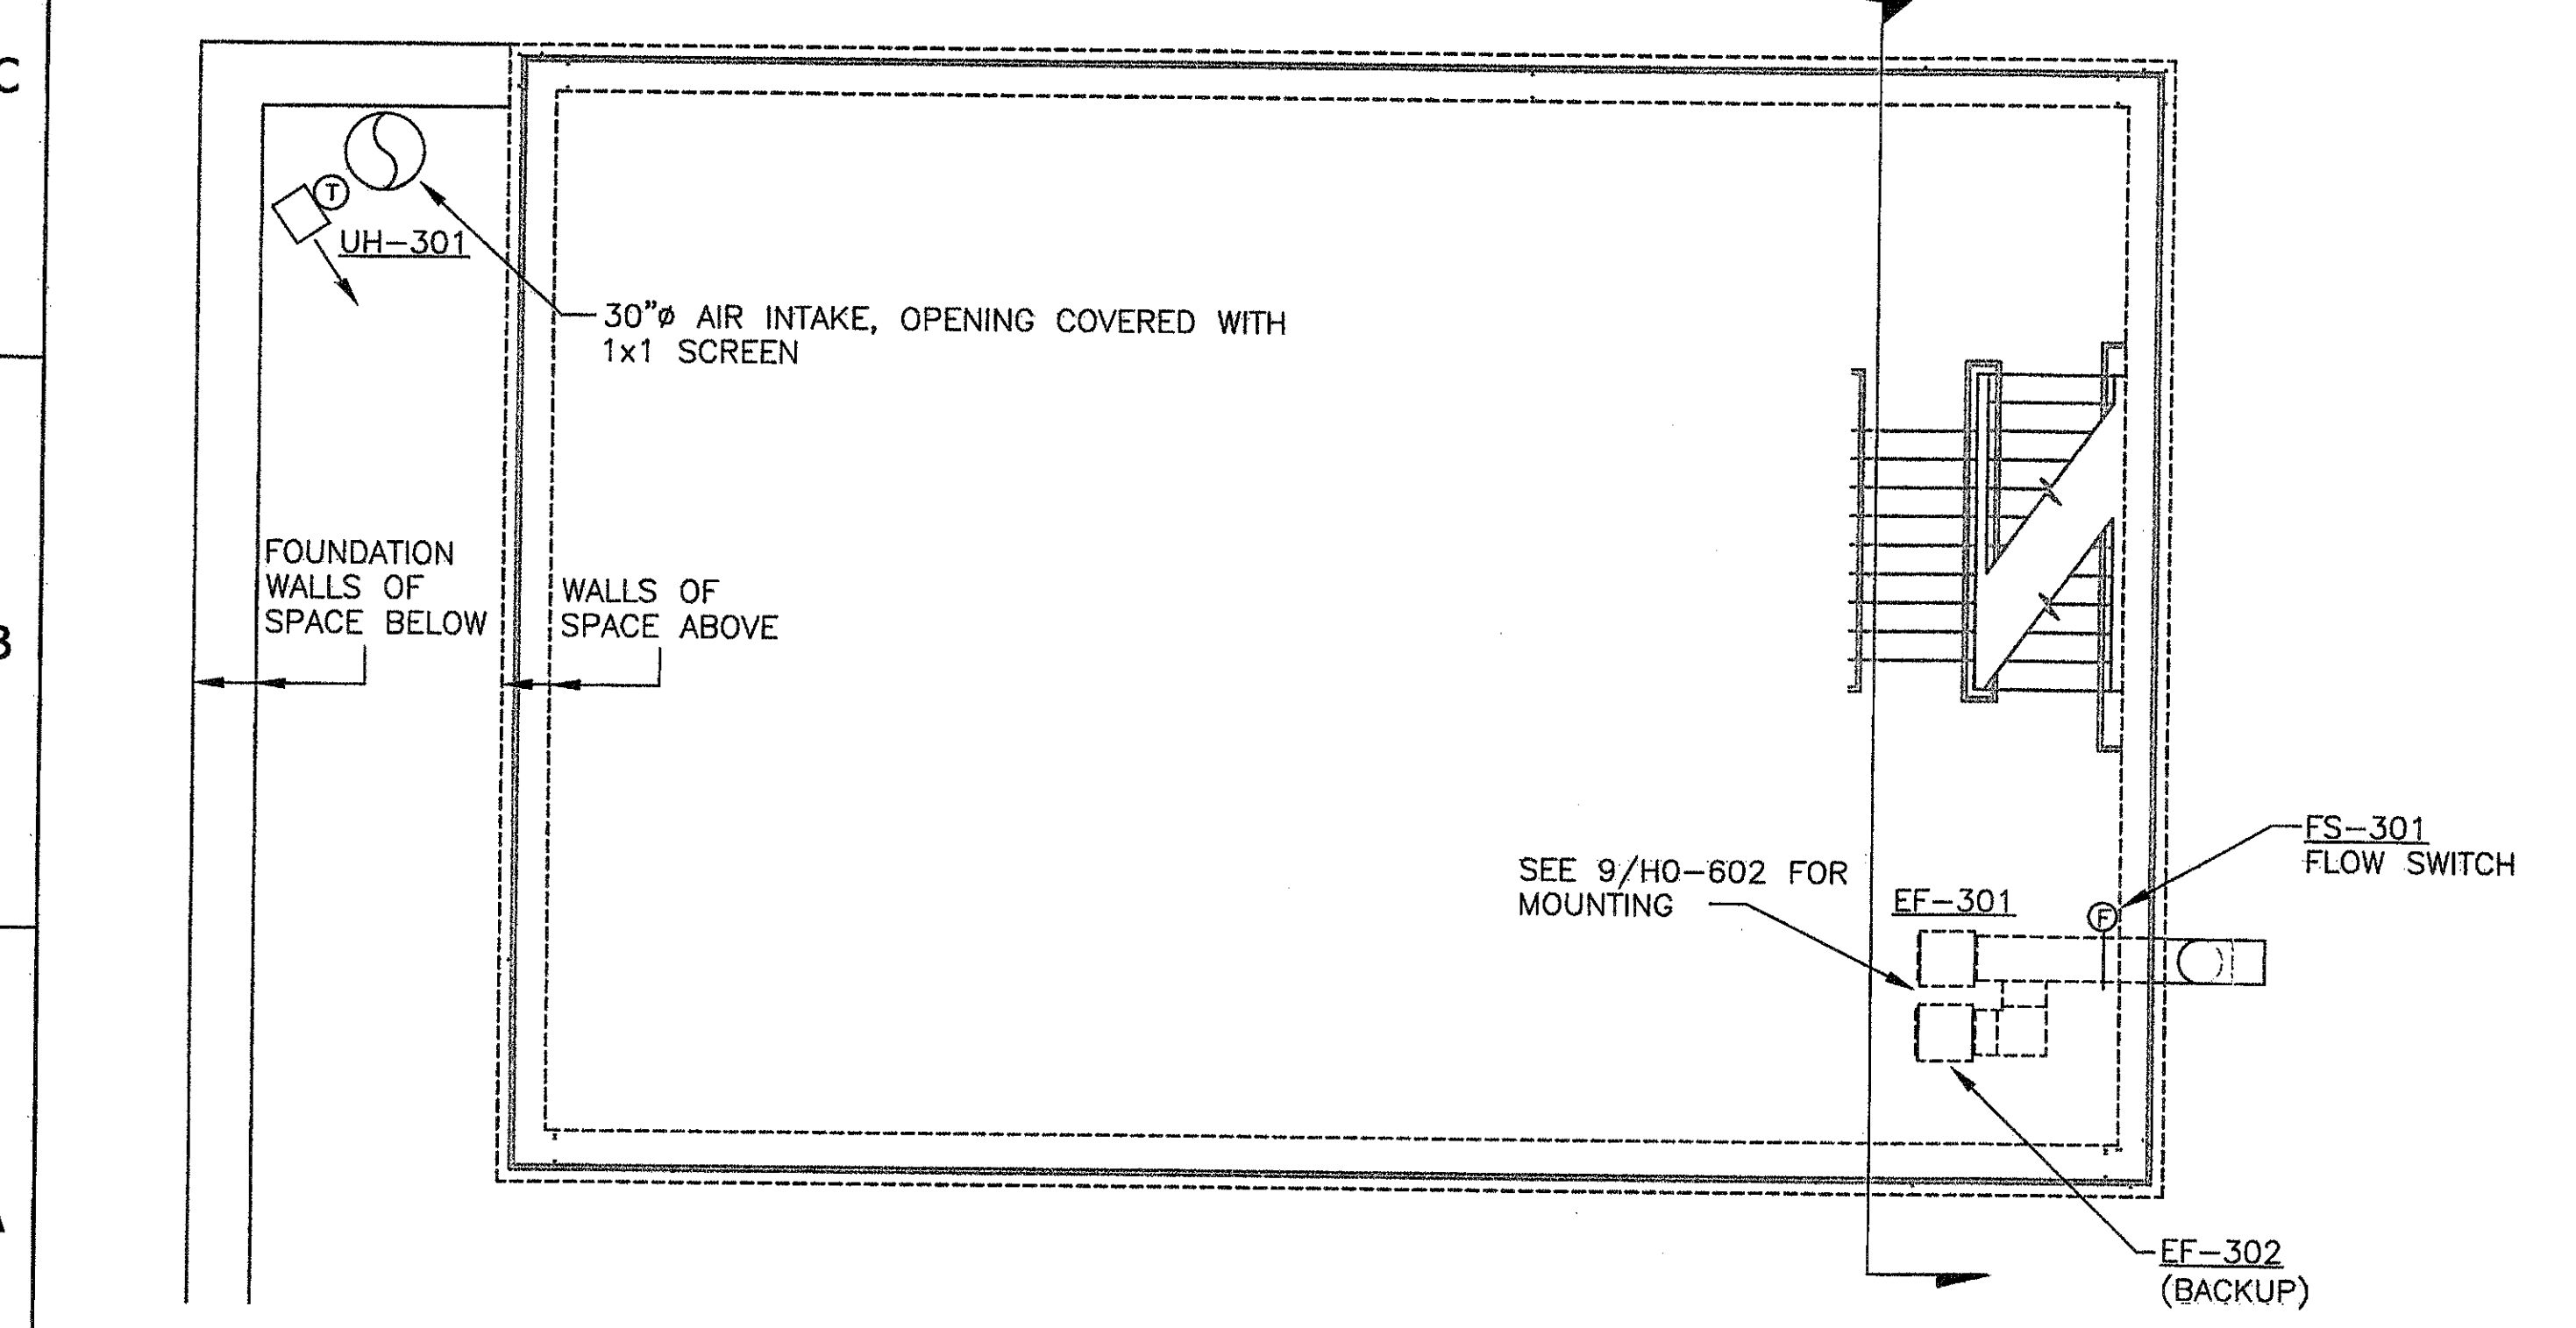

3 DIVERSION PUMP STATION HVAC ROOF PLAN
 H3-102 SCALE: 3/16"=1'-0" FIN. ROOF EL. 841'-2" NORTH

2 HVAC PLAN DIVERSION PUMP STATION LOWER LEVEL
 H3-102 SCALE: 3/16"=1'-0" FIN. FLR. EL. 808'-2" NORTH

NOTE:
 IN ORDER TO BE IN COMPLIANCE WITH THE ELECTRICAL CODE, CLEARANCE DIMENSIONS AND DUCT LAYOUT SHOWN ON PLAN MUST BE ADHERED TO.

thorburn

REGISTERED PROFESSIONAL ENGINEER
 No. 13684
 RONALD D. PATE 1/9/21/2021

PEACHTREE CREEK SOUTH FORK RELIEF STORAGE AND PUMPING STATION

CITY OF ATLANTA
 DEPARTMENT OF WATERSHED MANAGEMENT

REV	DATE	DESCRIPTION
0	10/28/12	100 PERCENT BID PACKAGE

THIS LINE IS ONE INCH LONG WHEN PLOTTED FULL SCALE
 THIS DRAWING MUST BE USED IN CONJUNCTION WITH THE APPLICABLE OR GOVERNING TECHNICAL SPECIFICATIONS AND OTHER CONTRACT DOCUMENTS.

PROJECT NO: FC-6260
 DATE: OCTOBER 2012

RESP PROF: RP DESIGNER: DC CHECKER: JST

SHEET TITLE
 HVAC
 03 - DIVERSION FACILITY PUMP STATION
 PLANS

SHEET NO. H3-101 REV. 0