


ROOM SCHEDULE																
NUMBER	ROOM NAME	FLOOR MATERIAL	FLOOR FINISH	BASE MATERIAL	NORTH WALL		EAST WALL		SOUTH WALL		WEST WALL		CEILING			COMMENTS
					MATERIAL	FINISH	MATERIAL	FINISH	MATERIAL	FINISH	MATERIAL	FINISH	MATERIAL	FINISH	HEIGHT	
FW-101	ELECTRICAL SWITCH GEAR AND MCC	CONCRETE	EPOXY	RB-1	CMU	PC-1	CMU	PC-1	CMU	PC-1	CMU	PC-1	5/8" GWB	PC-4	15'-0"	
FW-102	HIGH SERVICE PUMP ROOM	CONCRETE	EPOXY	RB-1	CMU	PC-1	CMU	PC-1	CMU	PC-1	CMU	PC-1	EXPOSED TO STRUCTURE	PC-4		CEILING HEIGHT VARIES OPEN TO DECK

DOOR SCHEDULE																	
DOOR NO	TYPE	DOOR				THICKNESS	DOOR RATING	DOOR FRAME					SILL	HDW SET	SIGN TYPE	SIGN NOTATION	Remarks
		MATERIAL	WIDTH	HEIGHT				TYPE	MATERIAL	RATING	HEAD	JAMB					
FDR-1	FD	SS	4'-0"	6'-0"													NOTE 1
FDR-2	FD	SS	4'-0"	6'-0"													NOTE 1
FDR-3	FD	SS	4'-0"	6'-0"													NOTE 1
FH-1	FH	SS	3'-0"	3'-0"													NOTE 2
FH-2	FH	SS	3'-0"	3'-0"													NOTE 2
FW101	G	FRP	3'-0"	7'-2"	1 3/4"		F2	ALUM		3/A-9501	6/A-9501		15	C	ELECTRICAL SWITCH GEAR		
FW101A	OHC	ALUM	10'-0"	12'-0"	2"		OHC	GALV		12/A-9501	13/A-9501	14/A-9501					
FW102	N	FRP	3'-0"	7'-0"	1 3/4"			F5	ALUM		1/A-9501	2/A-9501	11/A9506	6	E	23	
FW102A	OHC	ALUM	10'-0"	12'-0"	2"		OHC	GALV		12/A-9501	13/A-9501	14/A-9501					
FW102B	G	FRP	3'-0"	7'-2"	1 3/4"		F2	ALUM		3/A-9501	6/A-9501		15	C	ELECTRICAL SWITCH GEAR		
FW102C	N	FRP	3'-0"	7'-0"	1 3/4"			F5	ALUM		1/A-9501	2/A-9501	11/A9506	6	E	21	
FW102D	OHC	ALUM	10'-0"	12'-0"	2"		OHC	GALV		12/A-9501	13/A-9501	14/A-9501					
FW102E	N	FRP	3'-0"	7'-0"	1 3/4"			F5	ALUM		1/A-9501	2/A-9501	11/A9506	6	E	22	


NOTE 1. BASIS OF DESIGN FLOOR DOOR BILCO TYPE JD-AL DOUBLE LEAF FLOOR DOOR WITH TYPE 316 STAINLESS STEEL HARDWARE. DIAMOND PATTERNED TREAD PLATE COVER REINFORCED FOR 300 PSF LIVE LOAD
 NOTE 2. BASIS OF DESIGN FLOOR DOOR BILCO TYPE J-AL SINGLE LEAF FLOOR DOOR WITH TYPE 316 STAINLESS STEEL HARDWARE. DIAMOND PATTERNED TREAD PLATE COVER REINFORCED FOR 300 PSF LIVE LOAD

LISTED MANUFACTURER NOTE:
 MANUFACTURERS ARE REFERENCED TO ESTABLISH STYLE, SIZE, COLOR AND MATERIAL CHARACTERISTICS AND ARE NOT INTENDED TO LIMIT SELECTIONS FROM OTHER MANUFACTURERS. WHEN AN ALTERNATE SELECTION IS SUBMITTED, SUBMITTALS SHALL HAVE INCLUDED THE MATERIAL LISTED FOR COMPARISON.

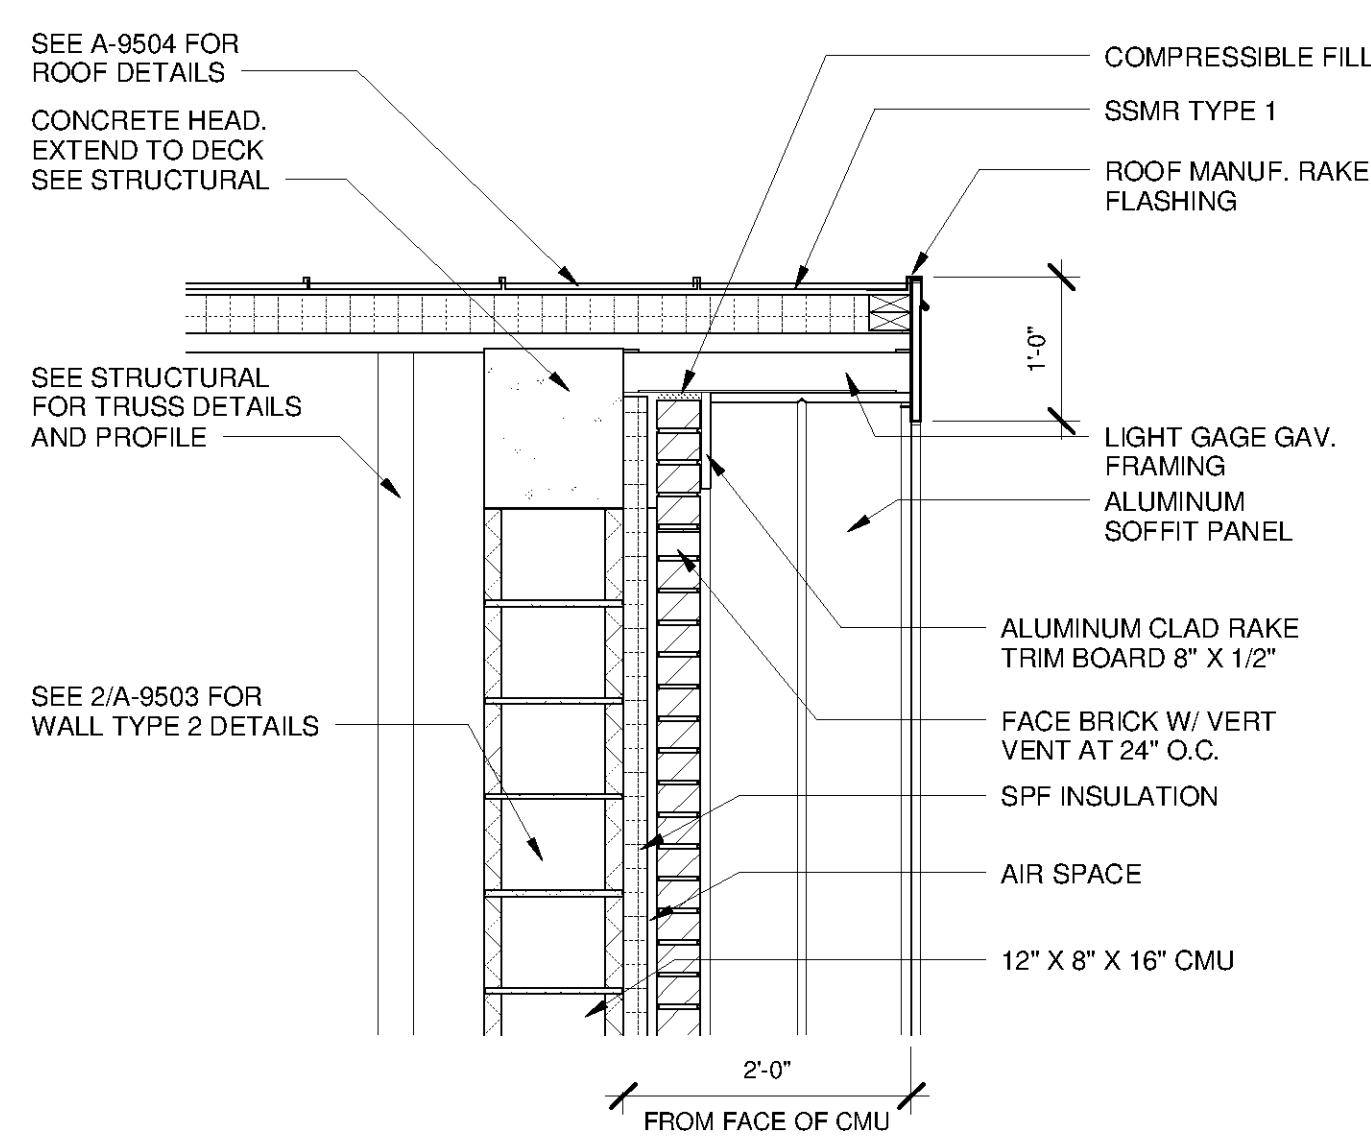


2 DETAIL AT OUTRIGGER
 SCALE: 3/4" = 1'-0"

SPRAY POLYURETHANE FOAM INSULATION NOTE:
 WALLS (R-9 MIN.) BASIS OF DESIGN HENRY PERMAX 2.0 CLOSE CELL SPRAY POLYURETHANE FOAM INSULATION

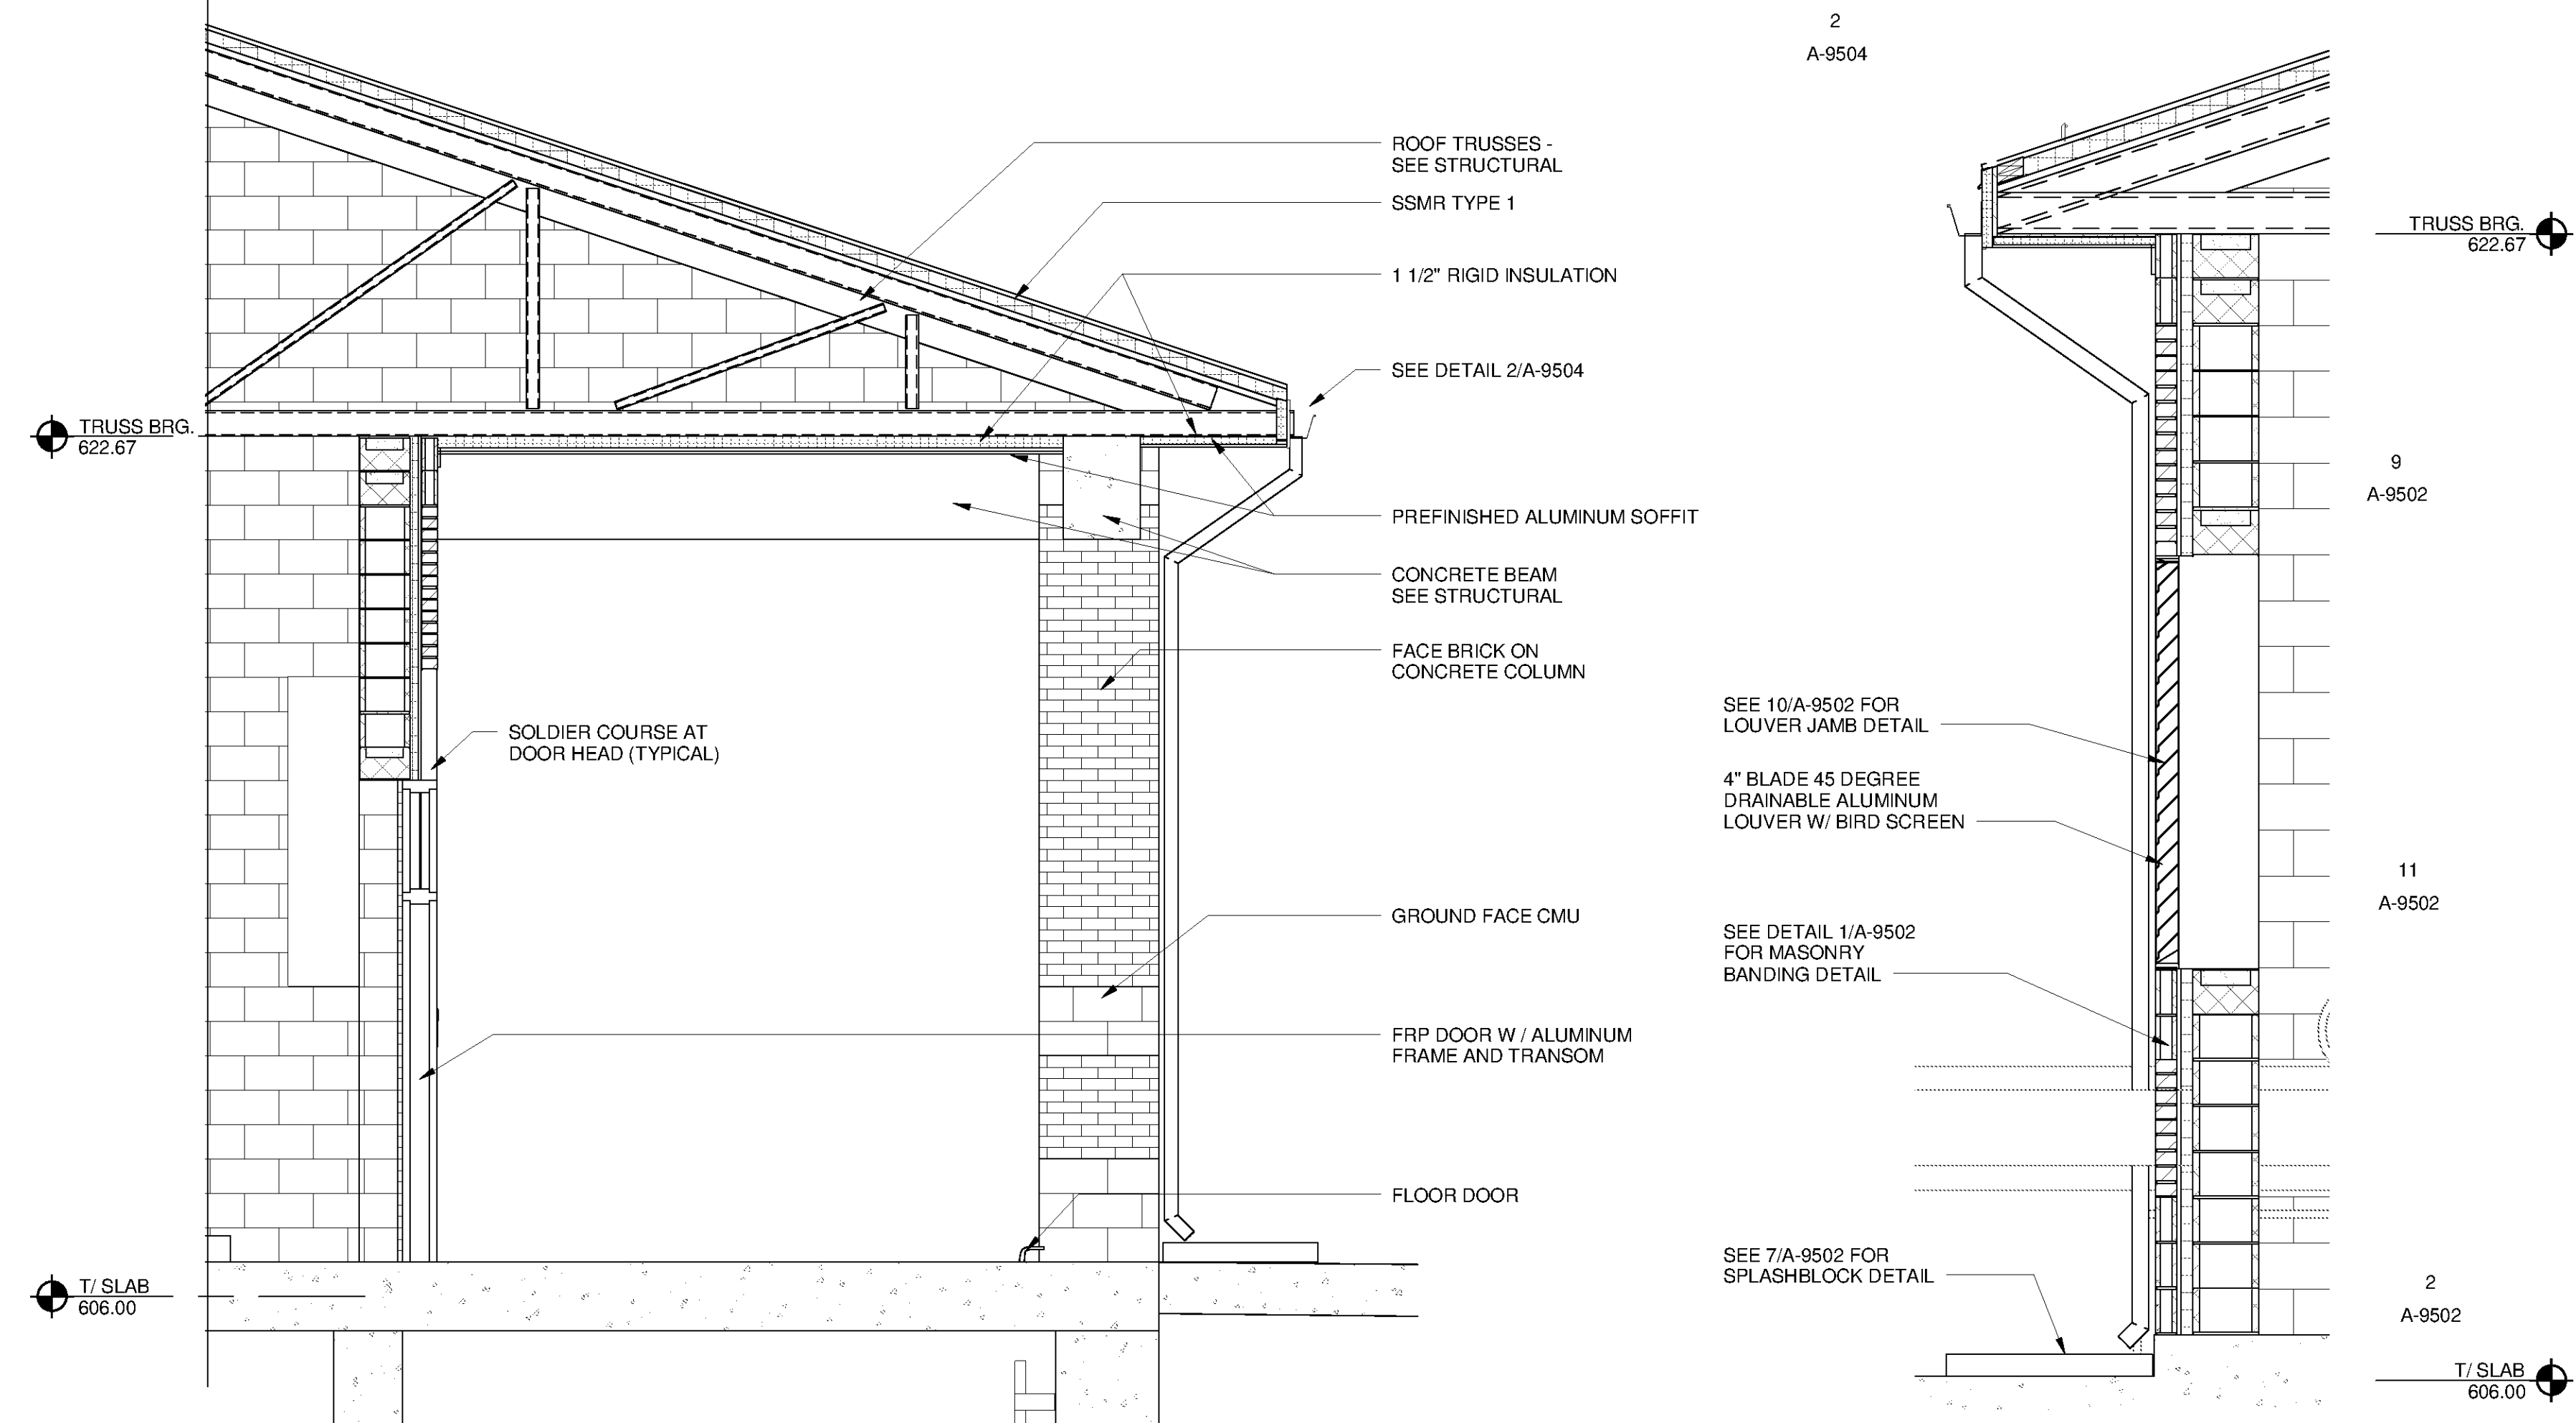

3 SECTION
 A-4601 SCALE: 3/8" = 1'-0"

1 WALL SECTION
 A-4601 SCALE: 1/2" = 1'-0"

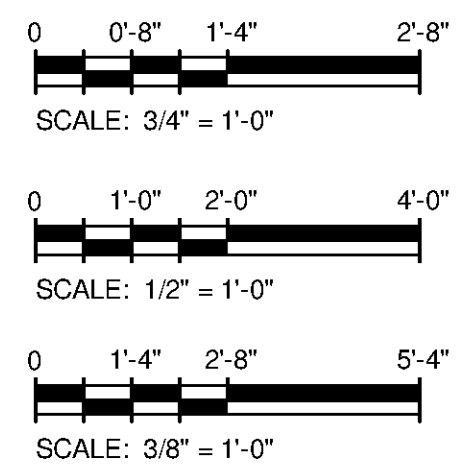

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BID SET
 HUNTSVILLE, ALABAMA
 6512
 10/24/14

BY	DATE	DESCRIPTION

HUNTSVILLE UTILITIES
 SOUTHEAST WATER TREATMENT PLANT
SCHEDULE AND DETAILS

Project No.: 200-1170-10003
 Designed By: Q.BIAGI
 Drawn By: Q.BIAGI
 Checked By: D.GALANTE

A-4601

Bar Measures 1 Inch