
PLANS FOR U.S. HIGHWAY 49 AT 18TH STREET DRAINAGE IMPROVEMENTS GULFPORT, MISSISSIPPI

SEPTEMBER 2020

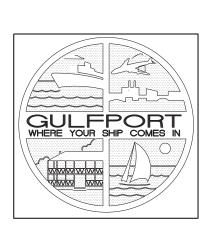



ENGINEERING DEPARTMENT 4050 HEWES AVENUE GULFPORT, MS 39507 (228) 868-5815



DIRECTOR OF ENGINEERING ROBERT K. RIEMANN, P.E.

	PERMITS	ACQ	UIRED	
MDOH		YES	× NO	□ N/A
MDEG) 🗷	YES	□ NO	□ N/A
MDMF	×	YES	□ NO	□ N/A
MDOT	-	YES	□ NO	□ N/A
USAC	E *	YES	□ NO	□ N/A

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BILLY HEWES,

Mayor

KENNETH L. CASEY, SR., Councilman Ward 1 - RON ROLAND, Councilman Ward 2 - ELLA HOLMES-HINES, Councilwoman Ward 3 - F.B. "RUSTY" WALKER, IV, Councilman Ward 4



LEGEND OVERHEAD POWER LINE **EXISTING GAS LINE EXISTING WATER LINE EXISTING SEWER LINE EXISTING UNDER GROUND** POWER LINE **EXISTING TELEPHONE LINE** UNDERGROUND TELEPHONE LINE UNDERGROUND FIBER OPTIC LINE EXISTING DRAINAGE LINE TO BE REMOVED MY FIRE HYDRANT $(\widehat{\mathbf{s}})$ SEWER MANHOLE WV WATER VALVE \bowtie WM WATER METER POWER POLE CONSTRUCTION EASEMENT LINE DRAINAGE EASEMENT LINE PROPERTY LINE **EXISTING DITCH LINE BENCHMARK** EXISTING DRAINAGE STRUCTURE PROPOSED DRAINAGE STRUCTURE PROPOSED DRAINAGE LINE

GENERAL NOTES

UTILITY COMPANIES

CITY OF GULFPORT PUBLIC WORKS 228-868-5740 (WATER/SEWER/DRAINAGE) 228-896-7500 CENTERPOINT ENERGY ENTEX (GAS) 1-800-532-1502 MISSISSIPPI POWER CO. (POWER) 1-800-624-3348 COAST ELECTRIC (POWER) AT&T (COMMUNICATIONS) 1-877-737-2478 228-864-1506 CABLE ONE (COMMUNICATIONS) MISSISSIPPI 811 (ONE CALL) 1-800-227-6477 COAST ELECTRIC (POWER) 228-832-1761 1-800-327-9686 WORLD COM (COMMUNICATIONS) 1-888-315-5005 GULF SOUTH PIPE (GAS LINE - KOCH) MCI (COMMUNICATIONS) 1-800-759-0038

GENERAL INFORMATION

BEFORE UNDERTAKING EACH PART OF THE WORK, THE CONTRACTOR SHALL CAREFULLY STUDY AND COMPARE THE PLANS & SPECIFICATIONS AND CHECK AND VERIFY PERTINENT FIGURES SHOWN THEREON AND ALL APPLICABLE FIELD MEASUREMENTS. IF ANY CONFLICTS, ERRORS, DISCREPANCIES, OR OTHER UNSATISFACTORY CONDITIONS ARE DISCOVERED EITHER ON THE CONSTRUCTION DOCUMENTS OR IN THE FIELD CONDITIONS, THE CONTRACTOR SHALL PROMPTLY REPORT IN WRITING TO THE ENGINEER OR HIS REPRESENTATIVE, AND SHALL OBTAIN A WRITTEN INTERPRETATION OR CLARIFICATION FROM THE ENGINEER OR HIS REPRESENTATIVE BEFORE PROCEEDING WITH ANY WORK AFFECTED THEREBY.

THE CONTRACTOR SHALL CALL THE MISSISSIPPI DAMAGE PREVENTION NUMBER (1-800-227-6477) BY LAW TO LOCATE ALL EXISTING UTILITIES ON SITE PRIOR TO HIS WORK. THE CONTRACTOR SHALL BE RESPONSIBLE FOR PROTECTING UTILITIES UNDER THIS CONTRACT AND BE RESPONSIBLE FOR ANY AND ALL DAMAGES TO UTILITIES THAT RESULT FROM CONTRACTOR'S WORK.

GENERAL NOTES

- 1. NOTIFY MISSISSIPPI 811 PRIOR TO EXCAVATION. (1-800-227-6477)
- 2. CONCRETE SHALL CONFORM TO MDOT CLASS B.
- 3. ASPHALT SHALL CONFORM TO CURRENT MDOT STANDARDS.
- 4. USE TRENCH BOX FOR DEPTHS GREATER THAN 4 FEET.
- 5. ALL PIPE TO BE FLUSH WITH INNER WALL OF BOX.
- 6. IF YOU HAVE ANY QUESTIONS ABOUT THE PROJECT CONSTRUCTION, CONTACT THE DESIGN ENGINEER/PROJECT ENGINEER.
- 7. STAGE MATERIAL IN CITY'S RIGHT-OF-WAY.
- 8. AT END OF WORKDAY, NO DRIVEWAYS SHOULD BE BLOCKED.

NOTICE TO DRAWING HOLDER

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DRAINAGE IMPROVEMENTS ON 18TH STREET AT US49 TO BRICKYARD BAYOU

> CITY OF GULFPORT GULFPORT, MISSISSIPPI



GENERAL NOTES, LEGEND & ABBREVIATIONS

working number: Drawing number: 02

GENERAL NOTES (CONTINUED)

UTILITIES

- 1. THE LOCATIONS OF EXISTING UNDERGROUND UTILITIES ARE SHOWN ON THE PLANS BASED UPON THE BEST INFORMATION AVAILABLE TO THE ENGINEER. AND HAVE NOT BEEN INDEPENDENTLY VERIFIED BY THE OWNER OR HIS AUTHORIZED REPRESENTATIVE. THE ENGINEER CANNOT AND DOES NOT WARRANT THAT THE INFORMATION IS COMPLETE OR ACCURATE. THE CONTRACTOR SHALL PERFORM A PRELIMINARY INVESTIGATION TO DETERMINE EXACT LOCATION OF UTILITY LINES BEFORE EXCAVATION OPERATION AND AGREES TO BE FULLY RESPONSIBLE FOR ANY AND ALL DAMAGES, WHICH MIGHT BE OCCASIONED BY THE CONTRACTOR'S FAILURE TO EXACTLY LOCATE AND PRESERVE ANY AND ALL UNDERGROUND UTILITIES.
- 2. CONTRACTOR SHALL BE RESPONSIBLE FOR IMMEDIATELY REPLACING OR REPAIRING AT HIS OWN EXPENSE ANY DAMAGED WATER LINES APPURTENANCES: STORM DRAIN LINES AND APPURTENANCES: SANITARY SEWER LINES AND APPURTENANCES. DRAINAGE STRUCTURES: OR ANY OTHER EXISTING SERVICES OR OBSTRUCTIONS WHICH. IN THE OPINION OF THE CITY OR THE ENGINEER. WERE DAMAGED BY THE CONTRACTOR. THE CONTRACTOR SHALL HAVE ON HAND AT ALL TIMES THE NECESSARY FITTINGS AND ACCESSORIES NEEDED TO PERFORM AN EMERGENCY REPAIR ON ANY EXISTING WATER MAIN, SANITARY SEWER LINE, STORM DRAIN, FORCE MAIN, SERVICE, ETC. SHOULD THE MAIN (S) OR SERVICE (S) BE DAMAGED DURING THE CONSTRUCTION OF THIS PROJECT.
- CONTRACTOR MUST KEEP THE WATER, SEWER, AND DRAINAGE SYSTEMS FUNCTIONAL AND ALL HOUSES IN SERVICE AT ALL TIMES UNLESS MINIMAL UTILITY OUTAGES ARE APPROVED BY THE CITY OR THE ENGINEER WITH A MINIMUM OF FIVE (5) CITY WORKING DAYS NOTICE. NO SERVICE SHALL BE LEFT OFF TO ANY PROPERTY OVERNIGHT.
- ADJUSTMENTS TO GAS. TELEPHONE. TELEVISION CABLE. POWER APPURTENANCES AND OTHER UTILITIES SHALL BE MADE BY OTHERS. BUT SHALL BE COORDINATED BY THE CONTRACTOR.
- THE WORK INCLUDED AS PART OF THIS PROJECT REQUIRES EXCAVATION IN THE IMMEDIATE VICINITY OF TRAFFIC AND ADJACENT PROPERTIES. THEREFORE. THE RISK OF A FAILURE OCCURRING DURING THE EXCAVATION REQUIRES THAT EXTREME CAUTION BE EXERCISED IT SHALL BE THE CONTRACTOR'S RESPONSIBILITY TO PLACE WHAT BRACING, SHORING OR GROUND SUPPORT SYSTEM THAT IS DEEMED NECESSARY TO PREVENT FAILURE AND TO PROTECT THE PERSONS WORKING NEAR THE EXCAVATION OR ANY STRUCTURE ADJACENT TO THE EXCAVATION, ALL COSTS FOR ANY PROTECTIVE MEASURES. INCLUDING THE MATERIALS AND LABOR FOR DESIGNING. DRAWING AND CONSTRUCTING THE FACILITY. SHALL BE INCLUDED IN THE PRICE BID FOR THE CONTRACT ITEMS, ALL TRENCHING DEEPER THAN 20' MUST BE DESIGNED BY AN ENGINEER.

UTILITIES (CONTINUED)

7. CONTRACTOR SHALL EXPLORE AHEAD (SURFACE AND SUBSURFACE) 200 FEET OF THE PIPE BEING LAID SO THAT NECESSARY ADJUSTMENTS CAN BE MADE IN THE ALIGNMENT OF THE PIPE IN CASE OF CONFLICTS WITH EXISTING STRUCTURES, UTILITIES, OR ANY OTHER KNOWN OR UNKNOWN OBSTRUCTION.

EROSION CONTROL

- 1. THE CONTRACTOR SHALL BE REQUIRED TO FURNISH ALL MATERIALS AND PERFORM ALL WORK FOR THE PROPER INSTALLATION. MAINTENANCE AND REMOVAL OF ANY TEMPORARY EROSION CONTROL MEASURE(S) NECESSARY TO CONTROL SILTATION. IF THERE IS NO SEPARATE PAY ITEM FOR TEMPORARY EROSION CONTROL MEASURES. THE COST OF TEMPORARY EROSION CONTROL SHALL BE ABSORBED IN OTHER BID ITEMS.
- CONTRACTOR SHALL INSTALL AND MAINTAIN SILT FENCES AROUND THE PERIMETER OF ALL VEGETATED AREAS WHICH ARE DISTURBED AND SHALL PREVENT SILTATION OF ADJACENT DRAINAGE SYSTEMS AND CHANNELS WITH SILT FENCING. THE USE OF HAY BALES IS PROHIBITED. CONTRACTOR SHALL BE RESPONSIBLE FOR MAINTAINING EROSION CONTROLS DURING THE ENTIRE COURSE OF THIS PROJECT PER ACCEPTABLE/APPROVED STORMWATER BEST MANAGEMENT PRACTICES. THE PLACEMENT OF EROSION AND SEDIMENT CONTROL BEST MANAGEMENT PRACTICES (BMPS) SHALL BE IN ACCORDANCE WITH THE MISSISSIPPI DEPARTMENT OF ENVIRONMENTAL QUALITY'S PLANNING AND DESIGN MANUAL FOR THE CONTROL OF EROSION. SEDIMENT AND STORMWATER.
- SILT FENCES SHALL BE INSTALLED AND PROPERLY MAINTAINED AROUND ALL STOCKPILED MATERIALS.
- ALL DISTURBED AREAS WITHIN THE RIGHT-OF-WAY AND/OR EASEMENTS SHALL BE GRASSED PER THE SPECIFICATIONS. ACCEPTANCE SHALL BE BASED ON SATISFACTORY GROWTH AND COVERAGE OF SEED(S) PLANTED.
- EXISTING VEGETATION SHALL BE MAINTAINED AND PROTECTED WHEREVER POSSIBLE.
- WHERE APPLICABLE ALL CONSTRUCTION TRAFFIC SHALL ENTER/EXIT THE SITE THROUGH THE CONSTRUCTION ENTRANCE: A CONSTRUCTION ENTRANCE IS REQUIRED AT ALL ACCESS POINTS ON THE SITE.
- 7. TEMPORARY OR PERMANENT VEGETATIVE PRACTICES SHALL BE IMPLEMENTED WITHIN SEVEN CALENDAR DAYS WHEN A DISTURBED AREA WILL BE LEFT UNDISTURBED FOR THIRTY DAYS OR MORE.
- TEMPORARY EROSION AND SEDIMENT CONTROLS SHALL NOT BE REMOVED UNTIL PERMANENT EROSION CONTROLS ARE ESTABLISHED ON ALL DISTURBED AREAS. FINAL APPROVAL ON THE PROJECT WILL NOT BE MADE UNTIL ALL TEMPORARY EROSION CONTROLS ARE REMOVED AND PERMANENT EROSION CONTROLS ARE EFFECTIVELY ESTABLISHED.
- ALL EQUIPMENT REPAIR AND MAINTENANCE SHALL BE DONE OFFSITE.

EROSION CONTROL (CONTINUED)

- 10. RECEPTACLES SHALL BE PROVIDED TO PROPERLY DISPOSE OF ALL TRASH AND WASTE. ALL CONSTRUCTION DEBRIS SHALL BE PICKED UP AT THE END OF EACH DAY AND SHALL BE REMOVED COMPLETELY FROM THE SITE AT THE END OF THE PROJECT.
- 11. SANITARY FACILITIES SHALL BE PROVIDED ON-SITE FOR ALL EMPLOYEES.
- 12. TEMPORARY EROSION AND SEDIMENT CONTROLS SHALL BE INSTALLED PRIOR TO THE START OF ANY WORK, IF IT WILL BE REQUIRED TO REMOVE THEM TEMPORARILY DUE TO CONSTRUCTION ACTIVITIES. ONCE THOSE ACTIVITIES ARE COMPLETED OR AT THE END OF THE WORK DAY, THE TEMPORARY CONTROLS SHALL BE REINSTALLED IMMEDIATELY.
- 13. ALL EROSION CONTROLS SHALL BE INSTALLED IN ACCORDANCE WITH THE DETAILS.
- 14. ADDITIONAL EROSION AND SEDIMENT CONTROLS MAY BE DEEMED NECESSARY IF THE CONTROLS FOUND IN THIS STORMWATER MANAGEMENT PLAN ARE FOUND TO BE INEFFECTIVE.
- 15. ACCUMULATED SEDIMENT SHALL BE REMOVED FROM CONTROLS WHEN IT REACHES ONE-HALF (1/2) THE HEIGHT OF THE CONTROL. THE SEDIMENT SHALL BE PROPERLY DISPOSED OF SO AS NOT TO CAUSE SEDIMENTATION IN ANOTHER LOCATION.
- 16. EROSION AND SEDIMENT CONTROLS SHALL BE INSPECTED WEEKLY AND FOLLOWING ANY RAIN EVENT. NON-FUNCTIONING. INEFFECTIVE OR DAMAGED CONTROLS SHALL BE REPAIRED. REPLACED OR SUPPLEMENTED WITH FUNCTIONAL CONTROLS WITHIN 24 HOURS OF DISCOVERY.
- 17. THE CONTRACTOR IS RESPONSIBLE FOR THE REMOVAL OF ANY SEDIMENT THAT MIGRATES INTO THE STORM DRAIN SYSTEM
- 18. THE CONTRACTOR IS RESPONSIBLE FOR THE REMOVAL OF ANY SEDIMENT OR CONSTRUCTION DEBRIS THAT IS TRACKED ONTO ADJACENT PAVED AREAS. ADJACENT STREETS SHALL BE KEPT CLEAN THROUGHOUT CONSTRUCTION AND SHALL BE CLEANED WITH A STREET-SWEEPER OR SIMILAR TECHNIQUE IMMEDIATELY UPON DISCOVERY OF SEDIMENT. WASHING DOWN OF THE STREET OR ANY PAVED AREAS IS NOT ALLOWED.
- 19. ANY SEDIMENT THAT HAS MIGRATED OFFSITE WHETHER ONTO PUBLIC OR PRIVATE PROPERTY SHALL BE REMOVED IMMEDIATELY UPON DISCOVERY.

TRAFFIC/SIGNS

MAINTENANCE OF TRAFFIC SHALL INCLUDE ALL SIGNS, BARRICADES. PAVEMENT MARKINGS. WARNING LIGHTS. PERSONNEL. TRAFFIC CONTROL DEVICES, SUPERVISION, AND OTHER ITEMS CONCERNING TRAFFIC CONTROL. THERE SHALL BE NO OTHER PAYMENTS MADE FOR THIS WORK. ALL WORK SHALL BE DONE IN ACCORDANCE WITH THE LATEST EDITION OF THE MANUAL ON UNIFORM TRAFFIC CONTROL DEVICES FOR STREETS AND HIGHWAYS (MUTCD) AND THE ATTACHED TRAFFIC CONTROL PLAN.

NOTICE TO DRAWING HOLDER
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DRAINAGE IMPROVEMENTS ON 18TH STREET AT US49 TO BRICKYARD BAYOU

> CITY OF GULFPORT GULFPORT. MISSISSIPPI



GENERAL NOTES

03

WORKING NUMBER: DRAWING NUMBER:

GN-02

GENERAL NOTES (CONTINUED)

TRAFFIC/SIGNS (CONTINUED)

- 2. CONTRACTOR SHALL INVENTORY ALL EXISTING SIGNS AND LOCATION WITHIN THE PROJECT LIMITS. CONTRACTOR SHALL REMOVE, SAFELY STORE TO PREVENT DAMAGE AND REINSTALL ANY STREET SIGNS IMPACTED BY THE PROJECT. ONLY SIGNS DISTURBED DURING CONSTRUCTION SHALL BE REMOVED. ANY SIGNS DAMAGED BY THE CONTRACTOR SHALL BE REPLACED AT THE CONTRACTOR'S EXPENSE. ALL SIGNS REPLACED MUST CONFORM TO CITY SPECIFICATIONS. NO SEPARATE PAYMENT SHALL BE MADE FOR THE REMOVAL AND INSTALLATION OF EXISTING SIGNS.
- 3. IF CONTRACTOR FAILS TO MAINTAIN TRAFFIC CONTROL AS PRESCRIBED FOR TYPE OF CONSTRUCTION, THE CITY MAY WITHHOLD PAYMENT OF ALL OR ANY RECENT PAY REQUESTS UNTIL TRAFFIC CONTROL IS IN COMPLIANCE WITH PLANS.
- 4. ALL CONSTRUCTION SIGNS SHALL BE IN PLACE BEFORE THE START OF ANY CONSTRUCTION AND SHALL BE PROPERLY MAINTAINED AND REMAIN IN PLACE FOR THE LIFE OF THE PROJECT.
- 5. THE LOCATION AND SPACING OF SIGNS SHOWN ON THE TRAFFIC CONTROL PLANS ARE APPROXIMATE AND MAY BE ADJUSTED AS NECESSARY TO FIT FIELD CONDITIONS OR AS APPROVED BY THE CITY ENGINEER, OR HIS AUTHORIZED REPRESENTATIVE.
- 6. REPLACEMENT OF LOST OR DAMAGED CONSTRUCTION SIGNS OR DEVICES SHALL BE THE SOLE RESPONSIBILITY OF THE CONTRACTOR. LOST OR DAMAGED SIGNS SHALL BE REPLACED IMMEDIATELY. NO PAYMENT SHALL BE MADE FOR SUCH REPLACEMENT OR REPAIR.

VEGETATION

- SHRUBS, TREES, AND OTHER VEGETATION TO BE DISTURBED SHALL BE CAREFULLY REMOVED AND OFFERED TO THE PROPERTY OWNERS. THE PROPERTY OWNER SHALL BE RESPONSIBLE FOR REPLANTING THE VEGETATION. ALL UNWANTED SHRUBBERY SHALL BE PROPERLY DISPOSED OF OFF THE PROJECT SITE. THIS WORK SHALL BE CONSIDERED INCLUDED IN THE COST OF THE PROJECT AND SHALL NOT BE MEASURED FOR SEPARATE PAYMENT.
- 2. REMOVE ONLY TREES WITHIN THE LIMITS OF THE WORK NOTED ON THE DRAWINGS TO BE REMOVED AND THAT ARE NECESSARY FOR CONSTRUCTION OF THE PROJECT. NO TREES PROTECTED BY LOCAL ORDINANCE SHALL BE REMOVED, TRIMMED, OR DAMAGED, INCLUDING ROOTS, UNLESS SPECIFICALLY PERMITTED IN WRITING BY THE CITY. ANY DAMAGES TO ANY TREE CAUSED BY THE CONTRACTOR SHALL BE THE CONTRACTOR'S RESPONSIBILITY. ANY RESULTING PENALTIES OR REQUIREMENTS IMPOSED BY THE CITY SHALL ALSO BE THE RESPONSIBILITY OF THE CONTRACTOR.

MISCELLANEOUS

- 1. FENCES IN CONFLICT WITH NEW CONSTRUCTION SHALL BE RELOCATED TO THE EDGE OF THE RIGHT-OF-WAY AND/ OR EASEMENT LINE BY THE CONTRACTOR. THE COST OF THIS WORK SHALL BE INCLUDED IN THE COST OF THE NEW FENCE.
- 2. FENCES WHICH ARE REMOVED DURING CONSTRUCTION SHALL BE RE-PLACED WITH A NEW FENCE IN A TIMELY MANNER AS SHOWN ON THE DRAWINGS.
- 3. CONCRETE FOR INSTALLATION OF FENCE POSTS ON PRIVACY FENCES SHALL BE AN ABSORBED COST.

MISCELLANEOUS (CONTINUED)

- 4. SPRINKLER SYSTEM REMOVAL AND REPLACEMENT SHALL BE AN ABSORBED COST.
- THE CONTRACTOR SHALL RELOCATE ANY MAILBOXES AND SIGNS NECESSARY TO COMPLETE THIS WORK. THIS INCLUDES ALL DECORATIVE (E.G. BRICK, STONE, WOOD, ETC.) MAILBOXES. REMOVAL, STORAGE AND REPLACEMENT OF MAILBOXES AND SIGNS ARE NOT SEPARATE PAY ITEMS AND SHALL BE INCLUDED IN THE COST OF THE PROJECT. ANY MAILBOXES OR SIGNS DAMAGED BY THE CONTRACTOR SHALL BE REPLACED IN KIND AT THE CONTRACTOR'S EXPENSE.
- THE CONTRACTOR SHALL BE AWARE THAT THERE MAY BE EXISTING RETAINING WALLS LOCATED THROUGHOUT THE PROJECT AREA THAT ARE TO REMAIN AS THEY CURRENTLY EXIST. IT IS THE CONTRACTOR'S RESPONSIBILITY TO PROTECT AND/ OR REPAIR/ REPLACE ANY PORTION OF THESE EXISTING RETAINING WALL (S) THAT ARE DAMAGED DURING CONSTRUCTION OPERATIONS. THE WALL SHALL BE REPLACED IN KIND TO MATCH EXISTING AS CLOSELY AS POSSIBLE. NO SEPARATE PAYMENT SHALL BE PROVIDED FOR THIS WORK. IT SHOULD BE NOTED THAT THERE MAY BE INSTANCES WHERE AN EXISTING RETAINING WALL MUST BE DISTURBED DURING CONSTRUCTION. THE LIMIT (S) OF THIS DISTURBANCE WILL BE CLEARLY DELINEATED ON THE DRAWINGS AND NECESSARY PAY ITEMS WILL BE PROVIDED. AS NOTED ABOVE, THESE WALLS SHALL BE REPLACED IN KIND TO MATCH ITS PREVIOUS CONSTRUCTION TO THE EXTENT REASONABLE. IF NO SEPARATE PAY ITEM IS PROVIDED IN THE PLANS FOR RETAINING WALL REPLACEMENT/ REPAIR THEN THE WORK IS CONSIDERED TO BE INCLUDED IN THE COST OF THE PROJECT
- 7. CONTRACTOR SHALL DISPOSE OFF-SITE ALL MISCELLANEOUS TRASH, DEBRIS, AND DAMAGED VEGETATION FROM ALL AREAS WITHIN THE LIMITS OF WORK. ALL SUCH WORK SHALL BE IN ACCORDANCE WITH ALL LOCAL. STATE. AND FEDERAL REQUIREMENTS.
- 8. STREET SWEEPING BY THE CONTRACTOR SHALL BE COMPLETED AS NECESSARY OR AS DIRECTED BY THE CITY OR THE ENGINEER. NO SEPARATE PAYMENT SHALL BE MADE FOR THIS WORK; IT SHALL BE INCLUDED IN THE COST OF THE PROJECT.
- 9. CONTRACTOR SHALL BE RESPONSIBLE FOR REPLACING OR REPAIRING AT HIS OWN EXPENSE ANY DAMAGES DONE TO PUBLIC RIGHT-OF-WAYS OR PRIVATE PROPERTY, WHICH WAS DAMAGED, IN THE OPINION OF THE CITY ENGINEER, DUE TO THE NEGLIGENCE OF THE CONTRACTOR.
- 10. THE OWNER AND THE ENGINEER SHALL BE CONTACTED A MINIMUM OF 72 HOURS IN ADVANCE OF ANY WORK WITHIN THE CITY'S RIGHT-OF-WAY. ONE LANE OF TRAFFIC WITHIN CITY RIGHT-OF-WAYS SHALL REMAIN OPEN AT ALL TIMES FOR EMERGENCY VEHICLES.
- 11. ALL SOILS DISTURBED AROUND MANHOLES SHALL BE COMPACTED BACK TO 95% ASTM D1557.

MISCELLANEOUS (CONTINUED)

- 12. IF EXISTING MATERIAL IS USED FOR BACKFILL, THERE SHALL BE NO ADDITIONAL PAYMENT FOR EXCAVATION AND BACKFILL. IF EXISTING MATERIAL IS UNSUITABLE FOR BACKFILL, BORROW MATERIAL SHALL BE USED. APPROVED PLACEMENT OF BORROW SHALL BE PAID FOR AT THE CONTRACT UNIT PRICE. THE EXCAVATION AND DISPOSAL OF UNSUITABLE MATERIAL SHALL BE MEASURED AND PAID FOR AS EXCESS EXCAVATION. BORROW MATERIAL SHALL BE B3 MATERIAL. A MECHANICAL ANALYSIS (AASHTO T88), PLASTICITY INDEX ANALYSIS (AASHTO T91), MOISTURE DENSITY CURVE ANALYSIS (AASHTO T180 OR ASTM D1557), AND A CLASSIFICATION IN ACCORDANCE WITH AASHTO M145 SOIL CLASSIFICATION SYSTEM SHALL BE REQUIRED TO VERIFY B5 MATERIAL PROPERTIES.
- 13. CONTRACTOR TO STOCKPILE STRIPPING AND UNCLASSIFIED EXCAVATION THAT IS SUITABLE FOR PLANTING MATERIAL. (THERE IS NO SEPARATE PAY ITEM FOR INTERIM STOCKPILING OF MATERIAL).
- 14. THE CONTRACTOR SHALL ONLY BE PAID FOR VOLUME (FM) OF UTILITY LINE EMBEDMENT MATERIAL PER THE AUTHORIZED TRENCH WIDTH OF THE UTILITY PIPE OUTSIDE DIAMETER PLUS 2 FEET PER THE UTILITY EMBEDMENT DETAIL(S).
- 15. CONTRACTOR IS REQUIRED TO FIELD SURVEY AND VERIFY ALL EXISTING CONDITIONS AND DIMENSIONS BEFORE ORDERING OR CUTTING MATERIALS. ELEVATIONS AND DIMENSIONS SHOWN ON THE PLANS ARE APPROXIMATE. THE CONTRACTOR SHALL NOTIFY THE ENGINEER IMMEDIATELY OF ANY AND ALL ELEVATION AND DIMENSION DISCREPANCIES FOUND IN THE FIELD SURVEY THE CONTRACTOR IS REQUIRED TO RECORD, MAINTAIN AND MAKE AVAILABLE ALL FIELD SURVEY NOTES TO THE ENGINEER UPON REQUEST.

NOTICE TO DRAWING HOLDER

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DRAINAGE IMPROVEMENTS ON 18TH STREET AT US49 TO BRICKYARD BAYOU

> CITY OF GULFPORT GULFPORT, MISSISSIPPI



GENERAL NOTES

WORKING NUMBER: DRAWING NUMBER:

GN-03

04

RECAPITULATION OF QUANTITIES

BASE BID

ITEM NO.	DESCRIPTION	UNIT	TOTAL
01030-A	KCS Insurance Requirements	LS	1
01030-B	KCS General Requirements	LS	1
01505-A	Mobilization	LS	1
01505-B	Project Sign	EA	1
01720-A	Construction Layout	LS	1
02050-A	Removal of Pavement (All Types and Thicknesses)	SY	805
02050-D	Removal of Sidewalk	SY	25
02050-G	Removal of Fence, All Types and Sizes	LF	590
02050-H	Removal of Obstructions	LS	1
02111-A	Clearing and Grubbing (PM)	ACRE	1.0
02221-A	Select Bedding Material (PM)	CY	585
02221-B	Select Foundation Material (PM)	CY	690
02226-A	Borrow Material, Class B3 (PM)	CY	2,500
02226-B	Excess Excavation (PM)	CY	2,500
02295-A	Silt Fence	LF	3,705
02295-B	Straw Wattles	LF	390
02668-A	72" Steel Casing (Jack and Bored)	LF	120
02668-B	72" Steel Casing (Open Cut)	LF	80
02668-D	16" Steel Split Casing	LF	20
02721-A	Precast Drainage Structure (DN-3, DN-4, DN-5, DN-7, DN-8)	EA	5
02721-B	Precast Drainage Structure (DN-6)	EA	1
02721-C	Class "B" Structural Concrete, Minor Structures	CY	20
02721-D	Reinforcing Steel	LBS	2,087
02721-E	Castings	LBS	1,993
02722-B	60" Reinforced Concrete Pipe, Class III	LF	2,056
02722-C	72" Reinforced Concrete Pipe, Class III	LF	16
02724-A	63" HDPE Fusible Pipe	LF	200
02752-A	Riprap (18" Thick) (200 pounds)	SY	70
02931-B	Plant Establishment (Hydro-Seeding)	ACRE	2.0
02935-A	Maintenance of Traffic	LS	1

ADDITIVE ALTERNATE #1

ITEM NO.	DESCRIPTION	UNIT	TOTAI
01505-A	Mobilization	LS	1
01720-A	Construction Layout	LS	1
02050-A	Removal of Pavement (All Types and Thicknesses)	SY	1,130
02050-B	Saw Cut (All Types and Thicknesses)	LF	735
02050-C	Removal of Curb (All Types)	LF	110
02050-D	Removal of Sidewalk	SY	55
02050-E	Removal of Pipe (All Types and Sizes)	LF	320
02050-F	Removal of Drain Inlets, All Types and Sizes	EA	3
02221-A	Select Bedding Material (PM)	CY	280
02221-B	Select Foundation Material (PM)	CY	350
02226-A	Borrow Material, Class B3 (PM)	CY	1,525
02226-B	Excess Excavation (PM)	CY	1,525
02234-A	Crushed Limestone Sub-base for Cuts in the Street R-O-W (FM)	CY	60
02234-B	Limestone Granular Base Course for Driveways (FM)	CY	20
02295-A	Silt Fence	LF	630
02295-B	Straw Wattles	LF	165
02512-A	Asphalt Pavement, MT, (9.5 mm mix)	TON	145
02512-B	Asphalt Pavement, MT, (12.5 mm mix)	TON	80
02521-A	Concrete Curb and Gutter	LF	65
02521-B	Header Curb	LF	110
02522-A	Concrete Sidewalk	SY	55
02522-B	Concrete Driveway	SY	80
02522-C	Detectable / Tactile Warning Surface Tiles	SF	16
02581-A	Thermoplastic Traffic Markings	LS	1
02668-D	16" Steel Split Casing	LF	20
02721-A	Precast Drainage Structure (DN-9)	EA	1
02721-B	Precast Drainage Structure (DN-10)	EA	1
02721-C	Class "B" Structural Concrete, Minor Structures	CY	53
02721-D	Reinforcing Steel	LBS	8,930
02721-E	Castings	LBS	919
02721-F	Gratings	LBS	1,653
02722-A	18" Reinforced Concrete Pipe, Class III	LF	48
02722-B	60" Reinforced Concrete Pipe, Class III	LF	632
02722-D	73"X45" Reinforced Concrete Arch Pipe, Class III	LF	296
02931-A	Plant Establishment - Solid Sod	SY	1,095
02931-B	Plant Establishment (Hydro-Seeding)	ACRE	0.5
02935-A	Maintenance of Traffic	LS	1

<u>N</u>	<u>OTI</u>	<u> CE</u>	<u>TO</u>	DR/	<u> </u>	IG H	<u> </u>	<u>DEF</u>	?
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DRAINAGE IMPROVEMENTS ON 18TH STREET AT US49 TO BRICKYARD BAYOU

> CITY OF GULFPORT GULFPORT, MISSISSIPPI



SUMMARY	OF	QUANTITIES

							R	EMO	VAL		I	ГЕМЅ	5		
WORK	STA	TION				CONC	RETE				ASPI	HALT	FENCE	PIPES	
NUMBER	ר	O TION	PAVEMENT	DR'WYS.	PAVED DITCH	MEDIAN & ISLAND PAVEMENT	SLOPE PAVING	SIDEWALK	STRUCTURE	CURBS	PAVEMENT	DR'WYS.	ALL TYPES	ALL TYPES	REMARKS
PP-2	5+75	6+15									111 SY				
	6+35	7+10									110 SY				
	6+55	6+95						22 SY							
	8+38	8+39											30 LF		
PP-2	10+20	10+80											70 LF		
PP-3	10+80	13+53											380 LF		
PP-3	16+60	16+80											50 LF		
PP-4	16+80	17+23											60 LF		
PP-4	19+50	21+45									583 SY				
PP-5	25+25	25+50										47 SY			
PP-5	25+22	25+50									47 SY				
PP-6	27+15	27+70									102 SY				
PP-6	28+08	29+40										462 SY			
PP-6	29+70	30+10		80 SY											
PP-6	30+45	31+65									102 SY				
PP-7	32+50	33+70									320 SY				
GEO-1	32+55	33+52												193 LF	
GEO-1	33+57	33+63												12 LF	
GEO-1	33+54	33+54							1 EA						
GEO-1	33+63	33+63							1 EA						
	33+60									75 LF					
	22162									35 LF					
	33+63													40 1 5	
GEO-1 GEO-1	33+60	33+63												40 LF	
GEO-1 GEO-1 GEO-1		33+63 33+59						38 SY	1 EA					40 LF	

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DRAINAGE IMPROVEMENTS ON 18TH STREET AT US49 TO BRICKYARD BAYOU

CITY OF GULFPORT GULFPORT, MISSISSIPPI



REMOVAL ITEMS

WORKING NUMBER:	DRAWING NUMBER:
EQ-1	06

WK.	STAT	ΓΙΟΝ								PIPE	E CU	LVEI	RT.					END	SEC	TIO	NS (Ente	er Si	zes)			SIZE		
SH. NO.	T	0	ID NO.	TYPE	63'	18	24	30	36	42	48	60	72	36x23	44x27	73x45	15	18 2	4 30	0 18)	(11 22	2X13 4	44X27	65X40	4X10 BOX	L	W	Н	REMARKS
PP-1	1+33		1	HW-1																									
PP-1	1+33	1+54		RCP									16																
PP-1	1+54		2	JB																						9.50	5.17	11.48	
PP-1	1+54	6+05		RCP								449																-	
PP-2	6+05		3	PRECAST																									
PP-2	6+05	11+00		RCP								492																I	
PP-3	11+00		4	PRECAST																									
PP-3	11+00	16+00		RCP								497																I	
PP-3	16+00		5	PRECAST																									
PP-4	16+00	21+48		RCP								543																	
PP-4	21+48		6	PRECAST																								I	
PP-5	21+48	22+07		RCP								56																-	
PP-5	22+07		7	PRECAST																									
PP-5	22+07	24+11		HDPE	200																							I	
PP-5	24+11		8	PRECAST																									
PP-5	24+11	25+68		RCP								158																I	
PP-5	25+68		9	PRECAST																								I	
PP-5	25+68	26+95		RCP								120																-	
PP-5	26+95		10	PRECAST																								I	
PP-6	26+95	30+48		RCP								348																	
PP-6	30+48		11	JB																						9.17	13.17	8.21	
PP-6	30+48	31+39		RCAP												81													
PP-7	31+39		12	DBL PI																						13.17	5.67	7.41	
PP-7	31+39	32+40		RCAP												94													
PP-7	32+40		13	DBL PI																						9.75	5.67	7.53	
PP-7	32+40	33+64		RCP												120													
PP-7	33+64		14	JB																						12.16	5.67	10.13	
PP-7	33+59	33+64		RCP		45																							
PP-7	33+59		15	SS-2																						10.00	3.00	4.81	
		JNITS			L.F.	L.F.	L.F.	EA.	EA. E	A. E	A. E	A. E	EA.	EA.	EA.	EA.													
	TC	OTALS			200	45	0	0	0	0	0	2663	16	0	0	295	0	0 (0 0)	0	0	0	0				

ESTIMATED DRAINAGE CALCULATIONS ARE FOR PLANNING PURPOSES ONLY CONTRACTOR TO VERIFY ALL VALUES PRIOR TO CONSTRUCTION.

NOTICE TO DRAWING HOLDER

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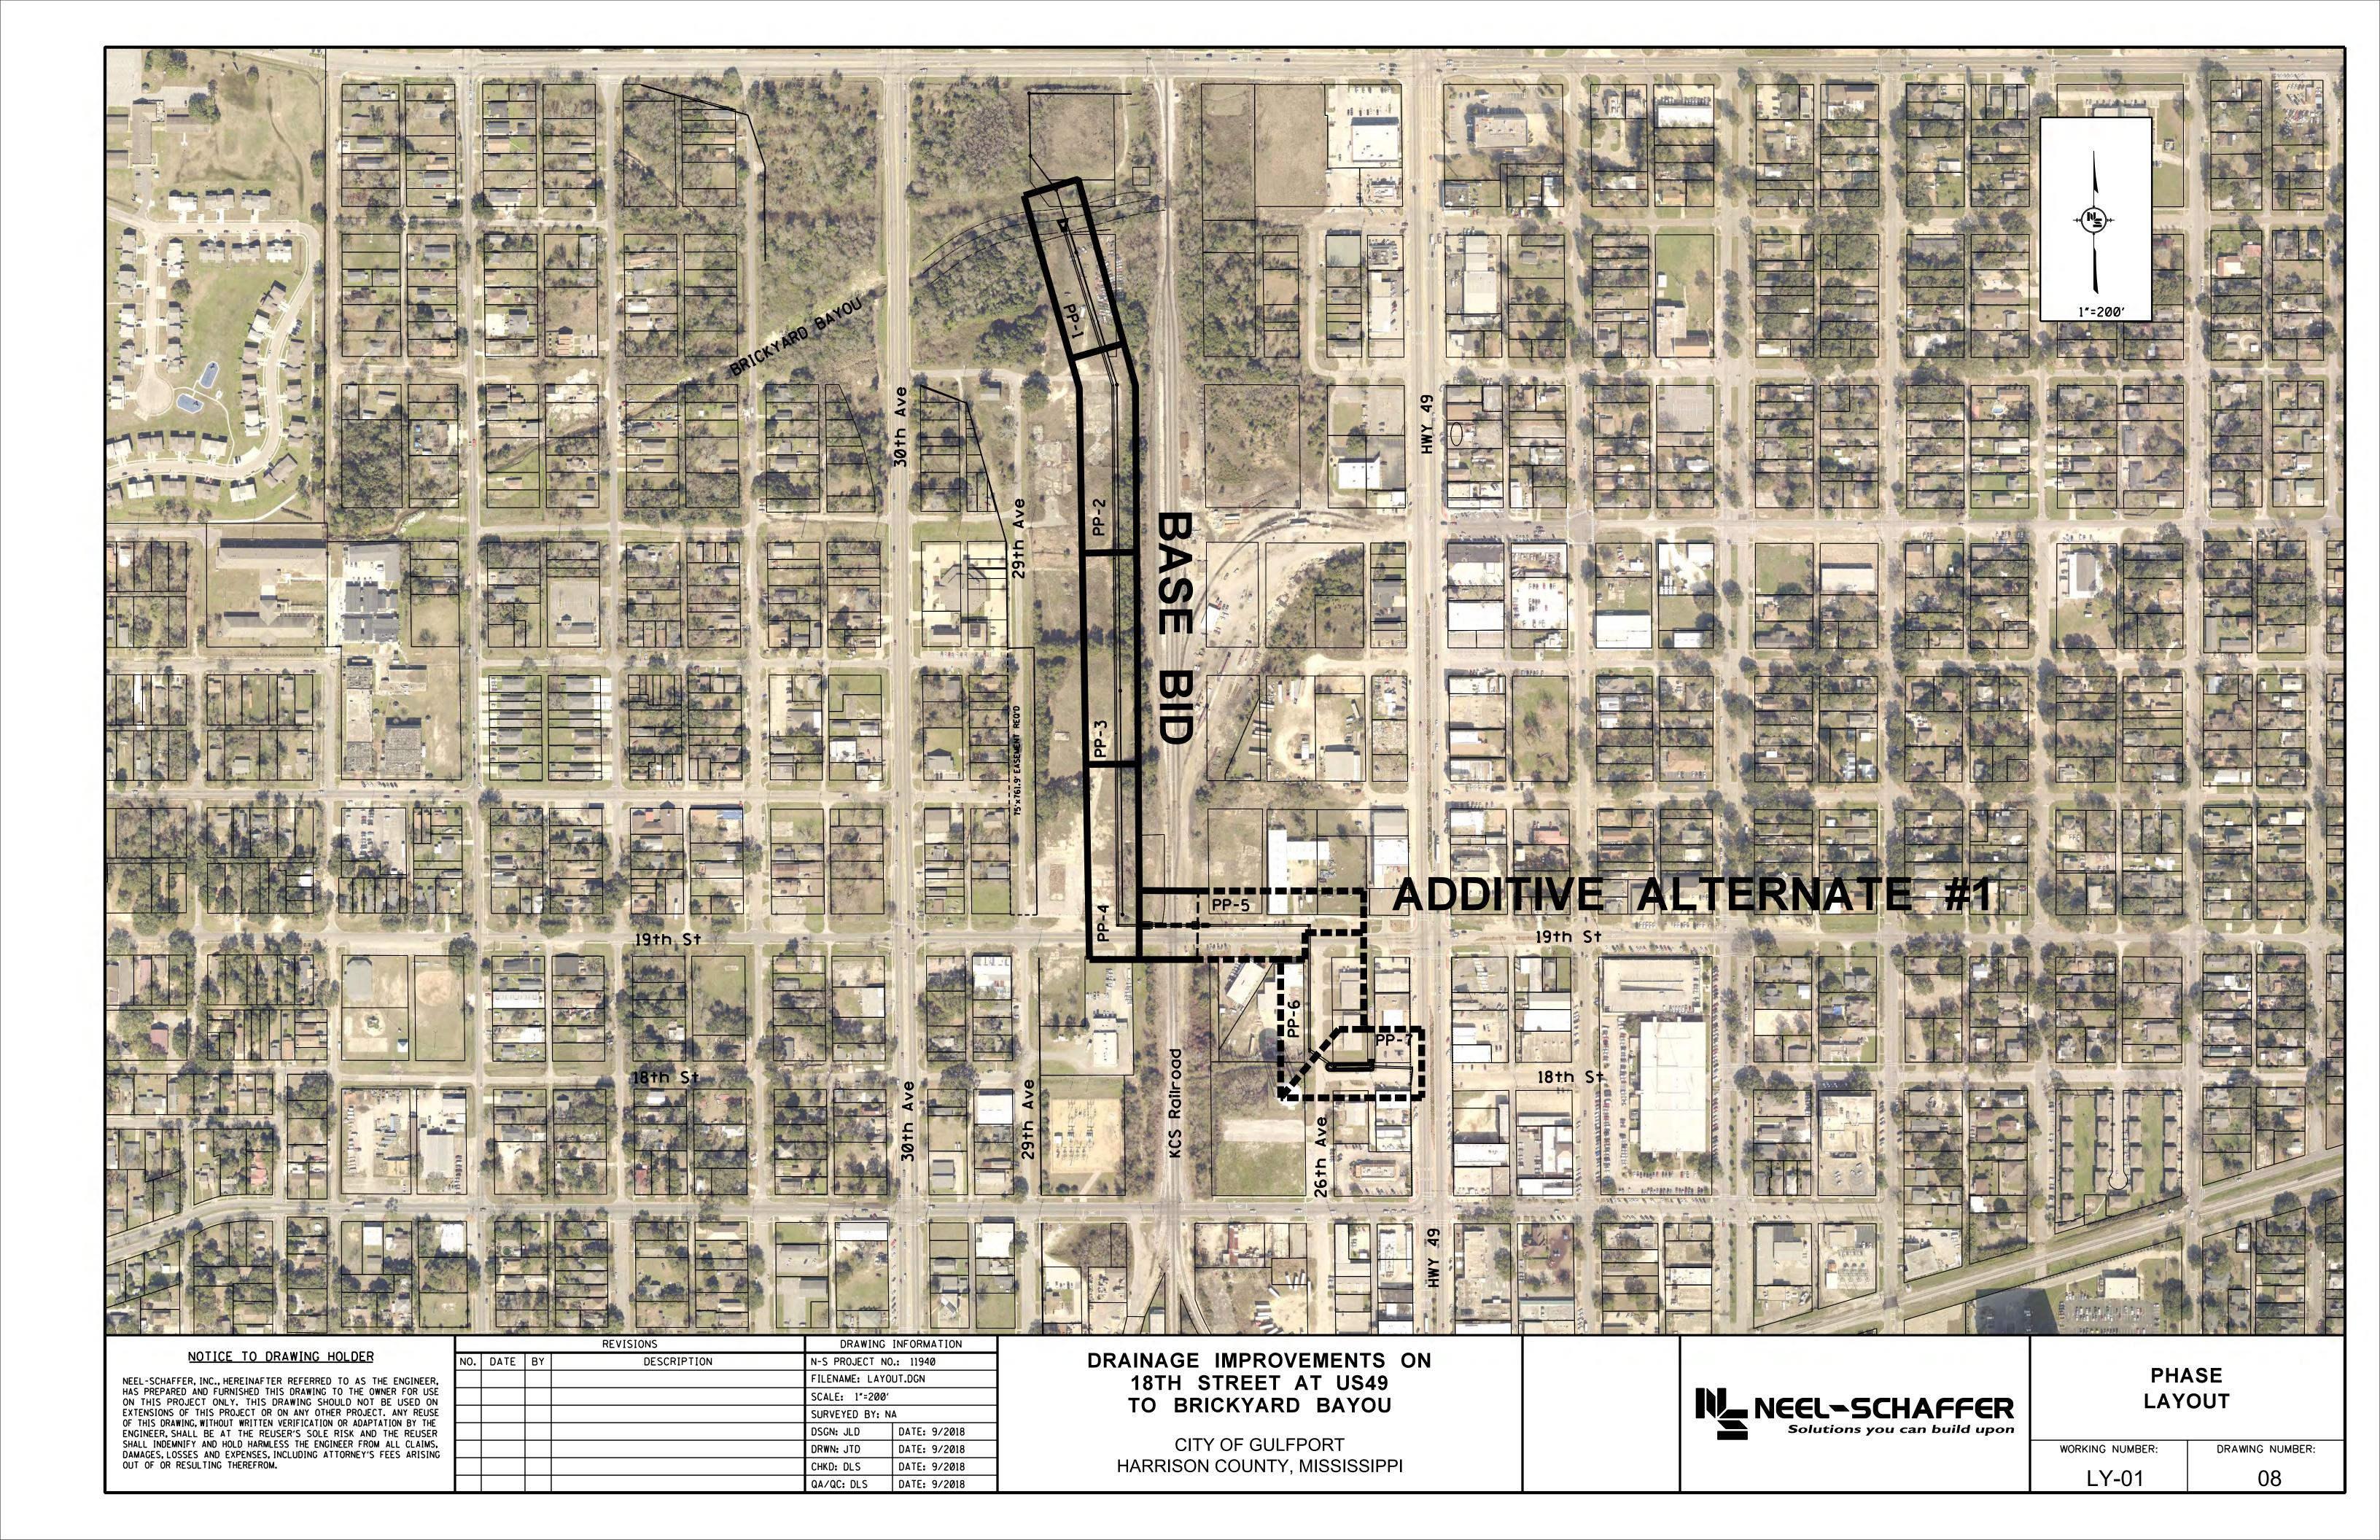
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CITY OF GULFPORT GULFPORT, MISSISSIPPI




ESTIMATED DRAINAGE ITEMS

WORKING NUMBER:	DRAWING NUMBER
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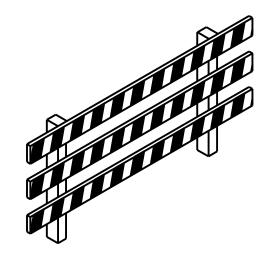





TYPE I

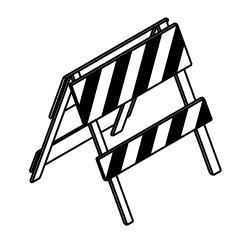



TYPE II



TYPE Ⅲ

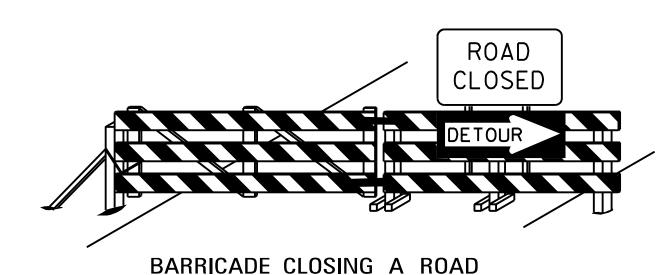

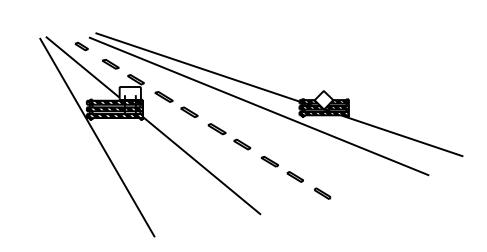

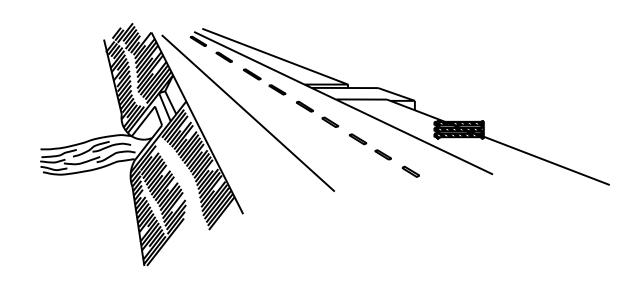

1. A TYPE I BARRICADE CONSISTS OF ONE (1) HORIZONTAL RAIL SUPPORTED BY A DEMOUNTABLE FRAME OR A LIGHT "A" FRAME. A TYPE I BARRICADE NORMALLY WOULD BE USED ON CONVENTIONAL ROADS OR URBAN STREETS AND ARTERIALS.

STANDARD BARRICADES

- 2. A TYPE II BARRICADE CONSISTS OF TWO (2) HORIZONTAL RAILS ON A LIGHT "A" FRAME. TYPE II BARRICADES ARE INTENDED FOR USE ON EXPRESSWAYS AND FREEWAYS AND OTHER HIGH-SPEED ROADWAYS.
- 3. TYPE I AND TYPE II BARRICADES ARE INTENDED FOR USE WHERE THE HAZARD IS RELATIVELY SMALL AS, FOR EXAMPLE, ON CITY STREETS, OR FOR THE MORE OR LESS CONTINUOUS DELIMITING OF A RESTRICTED ROADWAY, OR FOR TEMPORARY DAYTIME USE.
- 4. A TYPE III BARRICADE CONSISTS OF THREE (3) HORIZONTAL RAILS SUPPORTED BY FIXED POSTS, A RIGID SKID, A HEAVY DEMOUNTABLE FRAME OR A HEAVY, HINGED "A" FRAME.
- 5. TYPE III BARRICADES ARE INTENDED FOR USE ON CONSTRUCTION AND MAINTENANCE PROJECTS AS WING BARRICADES AND AT ROAD CLOSURES, WHERE THEY MUST REMAIN IN PLACE FOR EXTENDED PERIODS.
- 6. THE MARKING FOR BARRICADE RAILS SHALL BE ORANGE AND WHITE (SLOPING DOWNWARD AT AN ANGLE OF 45° IN THE DIRECTION TRAFFIC IS TO PASS).
- 7. DO NOT PLACE SANDBAGS OR OTHER DEVICES TO PROVIDE MASS ON THE BOTTOM RAIL THAT WILL BLOCK VIEW OR RAIL FACE.
- 8. FOR ADDITIONAL INFORMATION OR DETAILS, SEE MUTCD, LATEST EDITION.


ORANGE 18" BLACK CHEVRON SIGN DETAIL

- 1. A CHEVRON SIGN CONSISTS OF A BLACK CHEVRON TYPE MARKING ON AN ORANGE BACKGROUND AND SHALL POINT IN THE DIRECTION OF TRAFFIC FLOW.
- 2. THE CHEVRON SIGN SHALL BE MOUNTED ON FIXED POST OR RIGID SKID.
- 3. CHEVRON SIGNS MAY BE USED TO SUPPLEMENT OTHER STANDARD DEVICES WHERE ONE OR MORE LANES ARE CLOSED FOR CONSTRUCTION OR MAINTENANCE. THEY SHALL BE PLACED APPROXIMATELY 2'-0" BEHIND THE LANE TRANSITION STRIPE.


BARRICADE CHARACTERISTICS

	I	п	ш	
WIDTH OF RAIL * *	8" MIN 12" MAX.	8" MIN 12" MAX.	8" MIN 12" MAX.	
LENGTH OF RAIL**	24" MIN.	24" MIN.	48" MIN.	
WIDTH OF STRIPE *	6"	6″	6*	
HEIGHT	36" MIN.	36" MIN.	60" MIN.	
NUMBER OF REFLECTORIZED RAIL FACES	2 (ONE EACH DIRECTION)	4 (TWO EACH DIRECTION)	3 IF FACING TRAFFIC IN ONE DIRECTION 6 IF FACING TRAFFIC IN TWO DIRECTIONS	
TYPE OF FRAME	LIGHT	LIGHT "A" FRAME	POST OR SKID	

- * 1. FOR RAILS LESS THAN 36" LONG, 4" WIDE STRIPES MAY BE USED.
- ** 2. BARRICADES INTENDED FOR USE ON EXPRESSWAYS, FREEWAYS AND OTHER HIGH SPEED ROADWAYS, SHALL HAVE A MINIMUM OF 270 in² OF REFLECTIVE AREA FACING TRAFFIC.

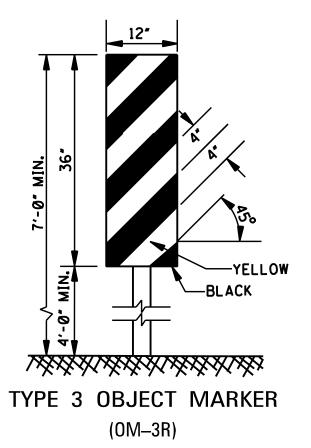

- 1. TYPE 3 OBJECT MARKERS SHALL BE USED AT ALL EXPOSED BRIDGE ABUTMENTS AND AT OTHER LOCATIONS AS DEEMED NECESSARY BY THE ENGINEER.
- 2. THE OM-3R IS SHOWN. THE OM-3L IS SIMILAR EXCEPT THE STRIPES SLOPE DOWNWARD FROM THE UPPER LEFT SIDE TO THE LOWER RIGHT SIDE AND SHALL BE PLACED ON THE LEFT SIDE OF THE OBJECT.
- 3. THE INSIDE EDGE OF THE MARKER SHALL BE IN LINE WITH THE INNER EDGE OF THE OBSTRUCTION.

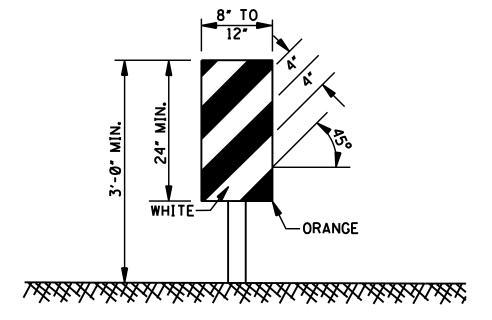

VERTICAL PANEL

- 1. VERTICAL PANELS CONSIST OF AT LEAST ONE PANEL 8" TO 12" IN WIDTH AND A MINIMUM OF 24" IN HEIGHT.
- 2. THE DIAGONAL STRIPES SHALL SLOPE DOWNWARD
 IN THE DIRECTION THAT TRAFFIC IS TO PASS THE PANEL.
 THE PANELS SHALL BE MOUNTED WITH THE TOP A
 MINIMUM OF 36" ABOVE THE ROADWAY ON A SINGLE
 LIGHTMASS POST.
- 3. VERTICAL PANELS USED ON EXPRESSWAYS, FREEWAYS AND OTHER HIGH-SPEED ROADWAYS SHALL HAVE A MINIMUM OF 270 in² OF RETROREFLECTIVE AREA FACING TRAFFIC.
- 4. FOR TWO-WAY TRAFFIC OPERATIONS, BACK-TO-BACK PANELS SHALL BE USED.

GENERAL NOTES:


- 1. MARKINGS ON ALL DEVICES SHOWN ON THIS SHEET SHALL BE HIGH INTENSITY REFLECTIVE SHEETING.
- 2. THE TRAFFIC CONTROL PLAN WILL LIST THE VARIOUS TRAFFIC CONTROL DEVICES REQUIRED FOR EACH PROJECT.

WING BARRICADES

- 1. WING BARRICADES ARE TYPE III BARRICADES ERECTED ON THE SHOULDER ON ONE OR BOTH SIDES OF THE PAVEMENT TO GIVE THE SENSATION OF A NARROWING OR RESTRICTED ROADWAY. WING BARRICADES MAY BE USED AS A MOUNTING FOR THE ADVANCE WARNING SIGNS OR FLASHERS.
- 2. WING BARRICADES SHOULD BE USED:

 A IN ADVANCE OF A CONSTRUCTION P
 - A. IN ADVANCE OF A CONSTRUCTION PROJECT EVEN WHEN NO PART OF THE ROADWAY IS ACTUALLY CLOSED.

B. IN ADVANCE OF ALL BRIDGE OR CULVERT WIDENING OPERATIONS.

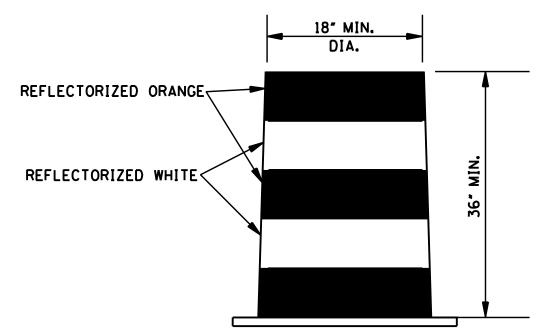

PLASTIC DRUM STRIPING DETAIL

- 1. PLASTIC DRUMS SHALL BE ON END AND USED AS AN EXPEDIENT METHOD FOR TRAFFIC CHANNELIZATION. THE COLOR AND MARKING OF DRUMS SHALL BE CONSISTENT WITH MARKING STANDARDS FOR BARRICADE. THE PREDOMINANT COLOR ON DRUMS SHALL BE ORANGE WITH FOUR (4) REFLECTORIZED, HORIZONTAL, CIRCUMFERENTIAL STRIPES (2 ORANGE & 2 WHITE) 6" WIDE.
- 2. DRUMS SHOULD NEVER BE PLACED IN THE ROADWAY WITHOUT WARNING SIGNS.
- 3. WHERE PRACTICAL PLASTIC DRUMS SHALL BE PLACED NO CLOSER THAN 3'-0" FROM THE EDGE OF TRAVELED LANE.

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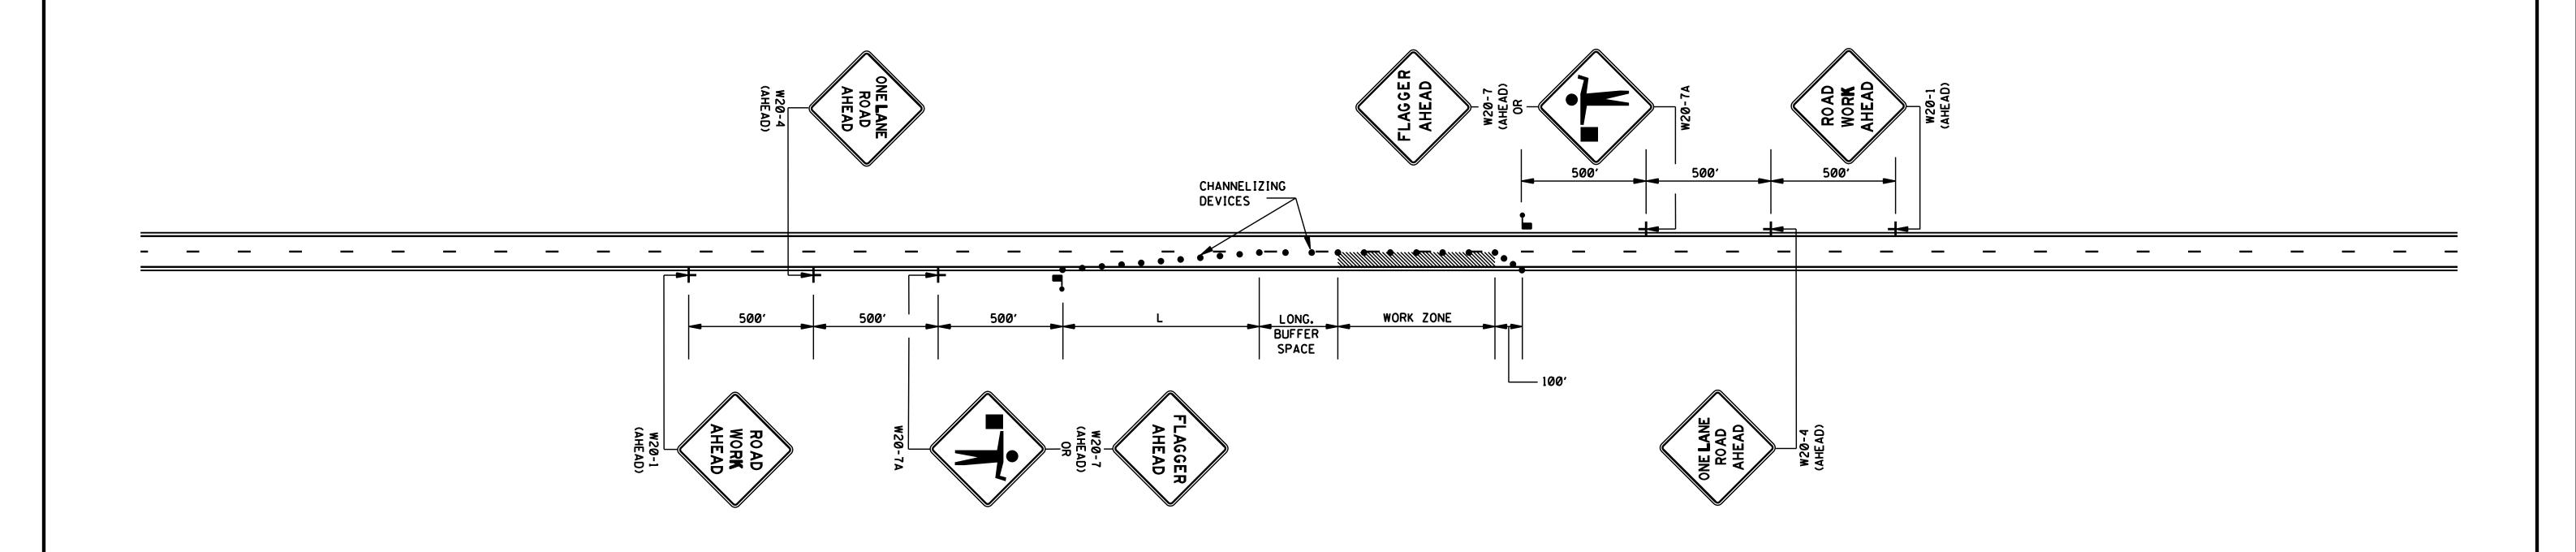
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CITY OF GULFPORT GULFPORT, MISSISSIPPI



TRAFFIC CONTROL DETAIL

WORKING NUMBER: DRAWING NUMBER: 09



GENERAL NOTES:

1. THE LOCATION OF CHANNELIZING DEVICES AND THE WORK AREA

I ABLE:					
POSTED SPEED AND/OR DESIGN SPEED	CHA	AXIMUM NNELIZING CE SPACING (ft)	MINIMUM LONGITUDINAL	TAPER † RATES	
DESIGN SPEED	TAPER	ALONG LANE LINE &	BUFFER SPACE (f+)		
mph		WORK ZONE			
≤40	40	80	170	27:1	
45	45	90	220	45:1	
50	50	100	280	50:1	
55	55	110	335	55:1	
60	60	120	415	60:1	
65	65	130	485	65:1	
70	70	140	575	70:1	

- + NOTE: TAPER RATES ARE DETERMINED USING THE FOLLOWING EQUATIONS:
- L = WS FOR SPEEDS OF 45 mph OR GREATER
- L = WS²/60 FOR SPEEDS OF 40 mph OR LESS WHERE: L = MINIMUM LENGTH OF TAPER IN FEET
 - W = WIDTH OF OFFSET (USUALLY LANE WIDTH) IN FEET
 - S = DESIGN SPEED OR 85TH PERCENTILE SPEED IN
 - MILES PER HOUR

- 2. ALL CHANNELIZING DEVICES SHALL BE A MINIMUM OF 24" IN HEIGHT.
- 3. ALL TRAFFIC CONTROL ITEMS SHOWN ON THIS SHEET WILL NOT BE MEASURED FOR SEPARATE PAYMENT. THIS WORK IS TO BE INCLUDED IN THE PRICE BID FOR MAINTENANCE OF TRAFFIC.
- 4. DIAMOND SHAPED TRAFFIC CONTROL SIGNS SHALL BE A MINIMUM OF $48" \times 48"$.
- 5. WHEN THERE IS NO EXISTING HAZARD OR AT THE END OF THE WORK DAY, ALL SIGNS SHALL BE COVERED OR REMOVED AND ALL CHANNELIZING DEVICES SHALL BE MOVED TO THE SHOULDER EDGE.
- 6. WHERE THE WORK ZONE IS STATIONARY, THE W20-7 (500 FT.) SIGN OR THE W20-7A SIGN TOGETHER WITH THE W20-7 (500 FT.) SUPPLEMENTAL PLATE SHOULD BE USED TO INDICATE THE DISTANCE TO THE FLAGGER.

LEGEND

FLAGGER

• CHANNELIZING DEVICES

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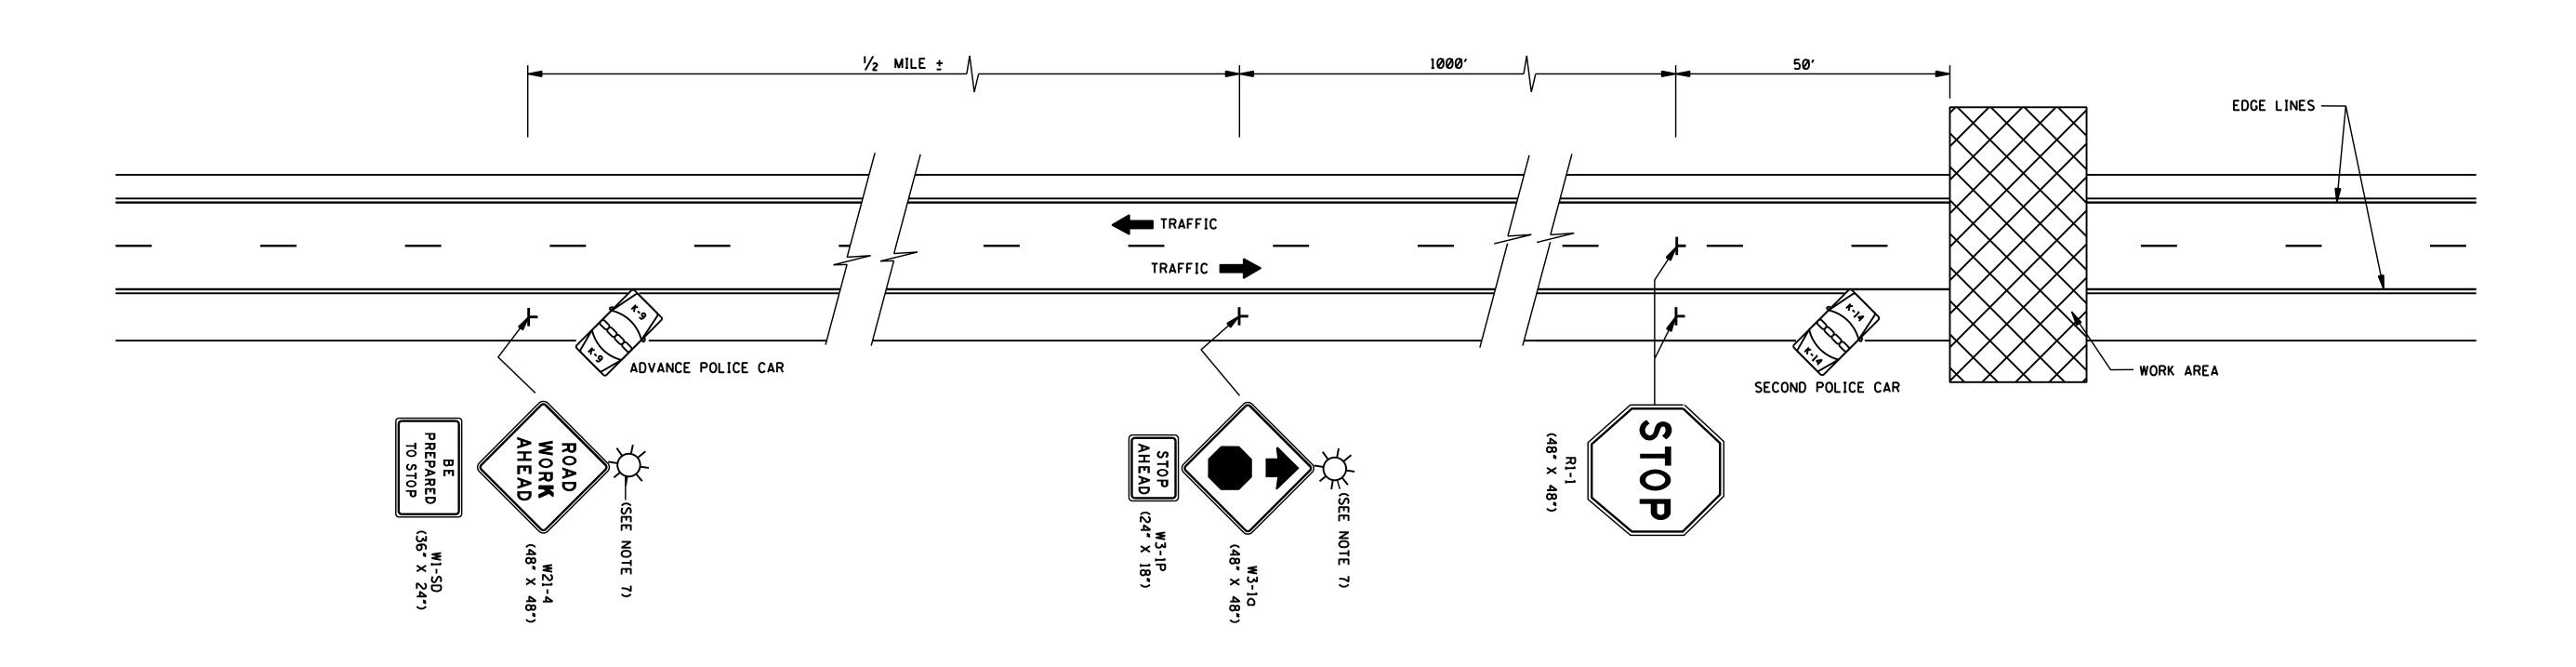
DRAINAGE IMPROVEMENTS ON 18TH STREET AT US49 TO BRICKYARD BAYOU

> CITY OF GULFPORT GULFPORT, MISSISSIPPI



TRAFFIC CONTROL PLAN

WORKING NUMBER: DRAWING NUMBER: TCP-2 10



GENERAL NOTES:

- 1. THIS TYPE OF HIGHWAY CLOSURE SHALL ONLY BE USED FOR EMERGENCIES OR FOR CONSTRUCTION OPERATIONS WHEN THE DURATION OF CLOSURE WILL NOT EXCEED 30 MINUTES. AFTER THE HIGHWAY HAS BEEN CLOSED AND REOPENED VIA THIS PROCEDURE, A MINIMUM PERIOD OF 30 MINUTES SHALL ELAPSE BEFORE ANOTHER SHORT DURATION CLOSURE, EXCEPT WITH THE APPROVAL OF THE ENGINEER.
- 2. AT LEAST TWO POLICEMEN AND TWO POLICE CARS SHALL BE PROVIDED ON EACH APPROACH TO THE CLOSURE. EACH POLICE CAR SHALL HAVE A ROOF MOUNTED ROTATING BLUE LIGHT OR LIGHT BAR.
- 3. ROAD CLOSURES ARE NOT PERMITTED ON HOLIDAYS OR BETWEEN THE HOURS OF 6 AM TO 9 AM, 11 AM TO 1 PM AND 3 PM TO 6 PM ON MONDAY THROUGH FRIDAY, EXCEPT BY PERMISSION OF THE ENGINEER.
- 4. THE ADVANCE POLICE CAR AND THE "W21-4 (48" X 48")", "W1-SD (36" X 24")", "W3-1a (48" X 48")", AND "W3-1P (24" X 18")" SIGNS SHALL BE MOVED BACK AS REQUIRED BY THE QUEUING OF STOPPED VEHICLES.

- 5. TRAFFIC CONTROL FOR THE CLOSURE SHALL BE ACCOMPLISHED IN THE FOLLOWING ORDER:
- A. ADVANCE POLICE CAR, LIGHTS AND FLASHERS ON.
- B. "W21-4 (48" X 48")" AND "W1-SD (36" X 24")" SIGNS ERECTED.
- C. "W3-1a (48" X 48")" AND "W3-1P (24" X 18")" SIGNS ERECTED.
- D. SECOND POLICE CAR, LIGHTS AND FLASHERS ON.
- E. "R1-1 (48" X 48")" SIGNS ERECTED TO STOP TRAFFIC. THE ORDER OF ERECTION SHALL BE IN THE FOLLOWING ORDER: RIGHT SHOULDER THEN CENTER.
- 6. TRAFFIC CONTROL SHALL BE REMOVED IN THE FOLLOWING ORDER:
- A. WITH TRAFFIC STOPPED REMOVE THE "R1-1 (48" X 48")" SIGNS TOWARD THE RIGHT SHOULDER IN THE FOLLOWING ORDER: CENTER THEN SIGN ON THE RIGHT SHOULDER.
- B. AFTER ALL STOPPED VEHICLES HAVE STARTED MOVING, THE "W3-10 (48" X 48")" AND "W3-1P (24" X 18")" SIGNS SHALL BE REMOVED. THESE SIGNS MAY BE COVERED IF RE-USE IS IMMINENT.
- C. AFTER ALL CARS HAVE RESUMED APPROXIMATELY NORMAL SPEED, THE "W21-4 (48" X 48")" AND "W1-SD (36" X 24")" SIGNS SHALL BE REMOVED. THESE SIGNS MAY BE COVERED IF RE-USE IS IMMINENT.

- 7. UNILLUMINATED SECTIONS OF HIGHWAYS SHALL NOT BE CLOSED DURING HOURS OF DARKNESS EXCEPT FOR EMERGENCIES OR WITH THE APPROVAL OF THE ENGINEER. WHEN THE HIGHWAY MUST BE CLOSED DURING HOURS OF DARKNESS, A TYPE B HIGH INTENSITY FLASHING BARRICADE WARNING LIGHT SHALL BE USED ON EACH W21-4 AND W3-10 SIGN.
- 8. IF AN ENTRANCE RAMP IS LOCATED BETWEEN THE W21-4 AND R1-1, THE "W21-4 (48" X 48")", "W1-SD (36" X 24")", "W3-1a (48" X 48")", AND "W3-1P (24" X 18")" SIGNS SHALL ALSO BE ERECTED ON THE RAMP SHOULDER.
- 9. SIGN "W1-SD (36" X 24")" IS 4" SERIES "C"
 BLACK LEGEND AND BORDER ON ORANGE BACKGROUND.
- 10. ALL TRAFFIC CONTROL ITEMS SHOWN ON THIS SHEET WILL NOT BE MEASURED FOR SEPARATE PAYMENT. THIS WORK IS TO BE INCLUDED IN THE PRICE BID FOR MAINTENANCE OF TRAFFIC, INCLUDING SECURING POLICE SERVICES.
- 11. THE ABOVE DURATION WILL APPLY TO EACH APPROACH TO THE CLOSURE.

NOTICE TO DRAWING HOLDER

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			REVISIONS	DRAWING	DRAWING INFORMATION			
NO.	DATE	BY	DESCRIPTION	N-S PROJECT N	N-S PROJECT NO.: 00.14470.00			
				FILENAME: DET	FILENAME: DETAILS.DGN			
				SCALE: NTS	SCALE: NTS			
				SURVEYED BY:				
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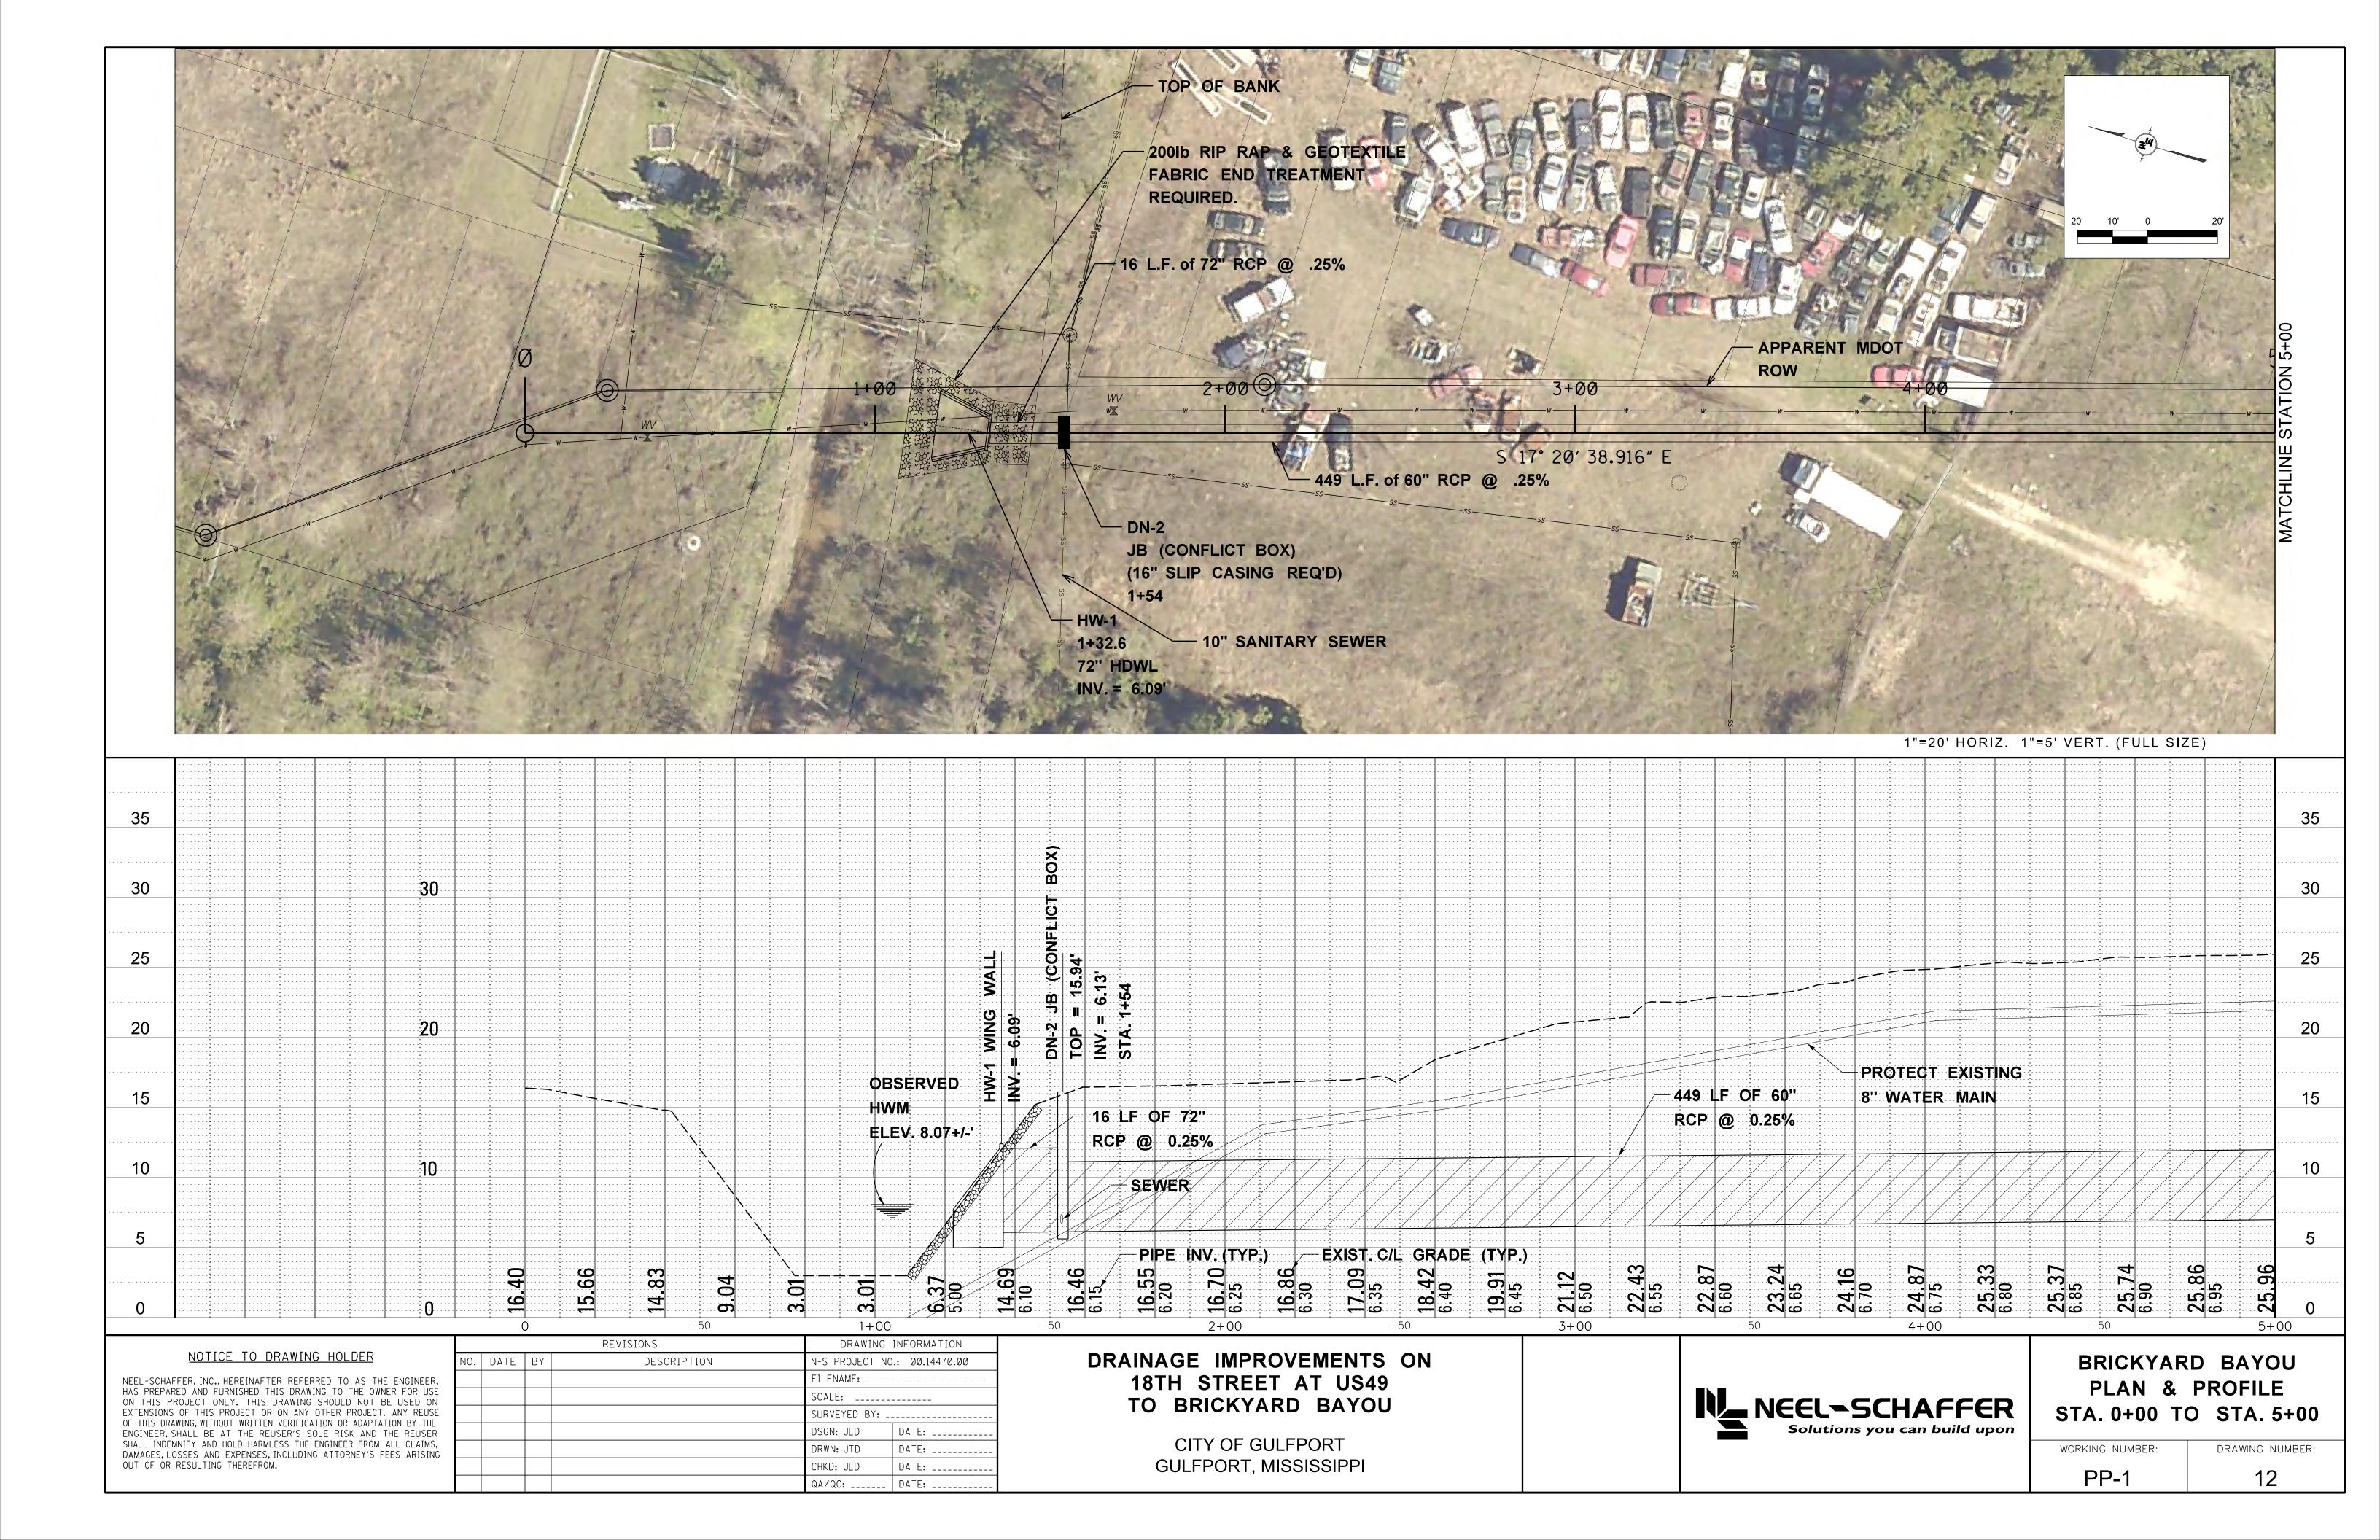
DRAINAGE IMPROVEMENTS ON 18TH STREET AT US49 TO BRICKYARD BAYOU


CITY OF GULFPORT GULFPORT, MISSISSIPPI





TRAFFIC CONTROL PLAN


working number: Drawing number: TCP-3 11




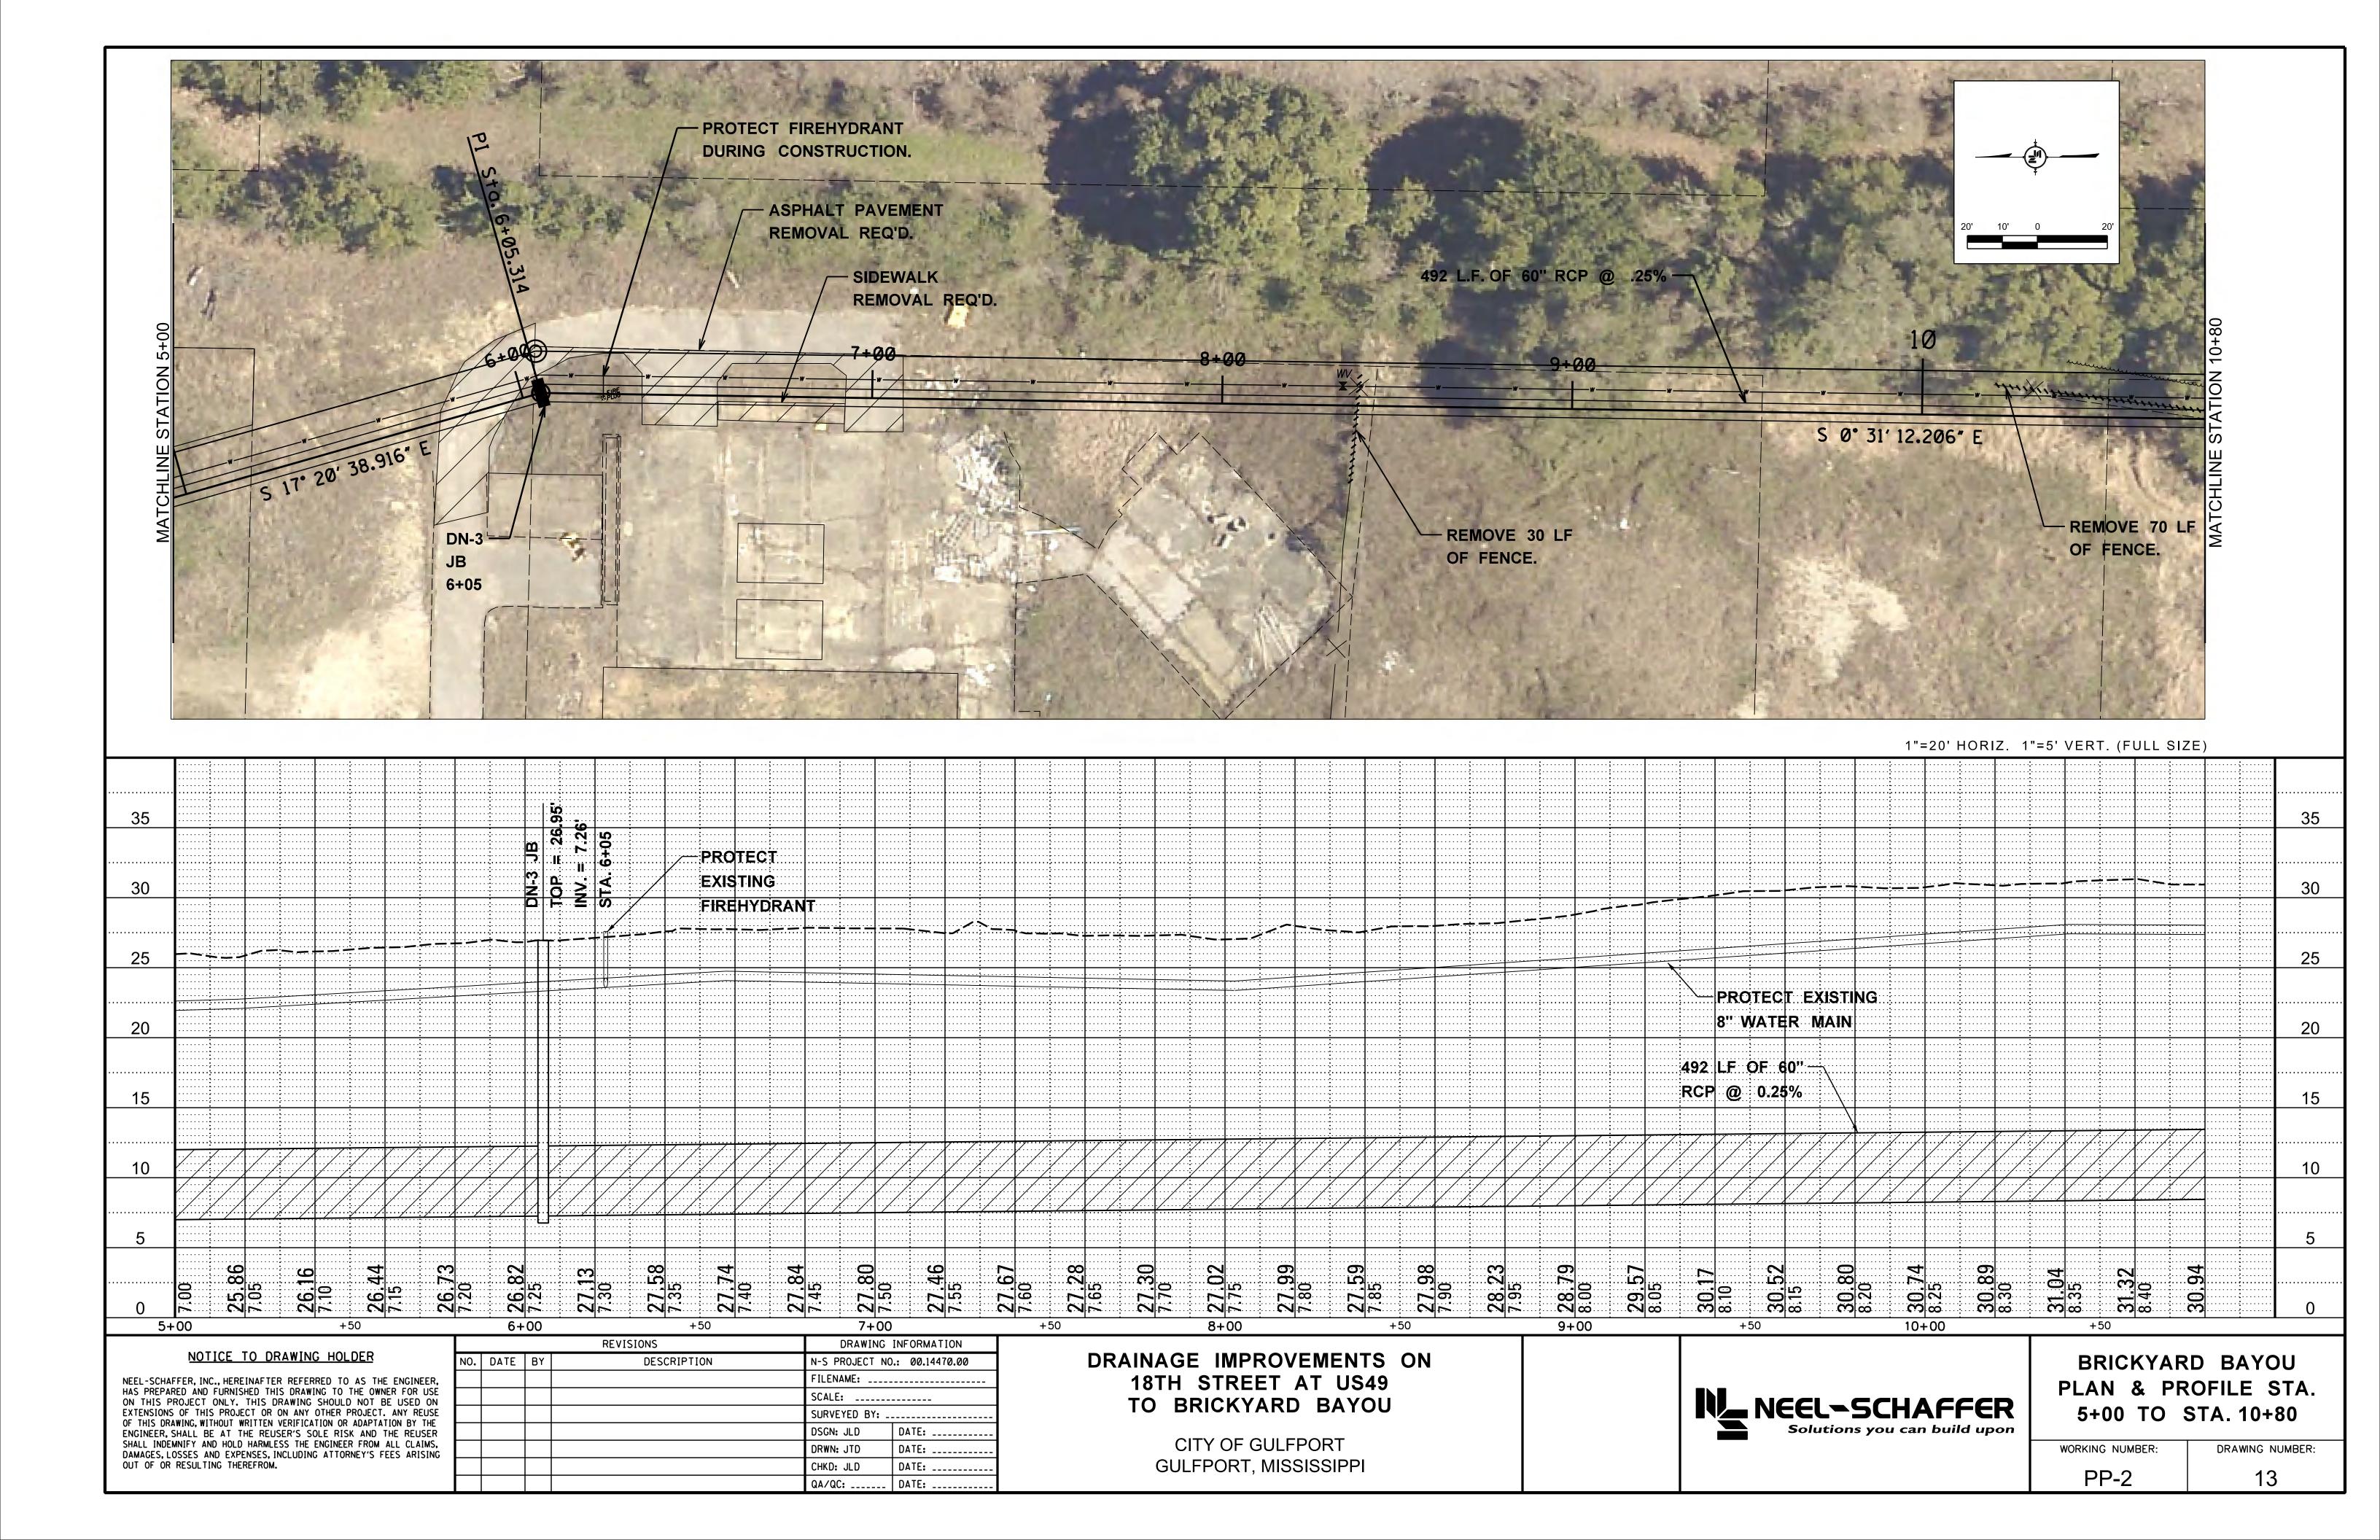


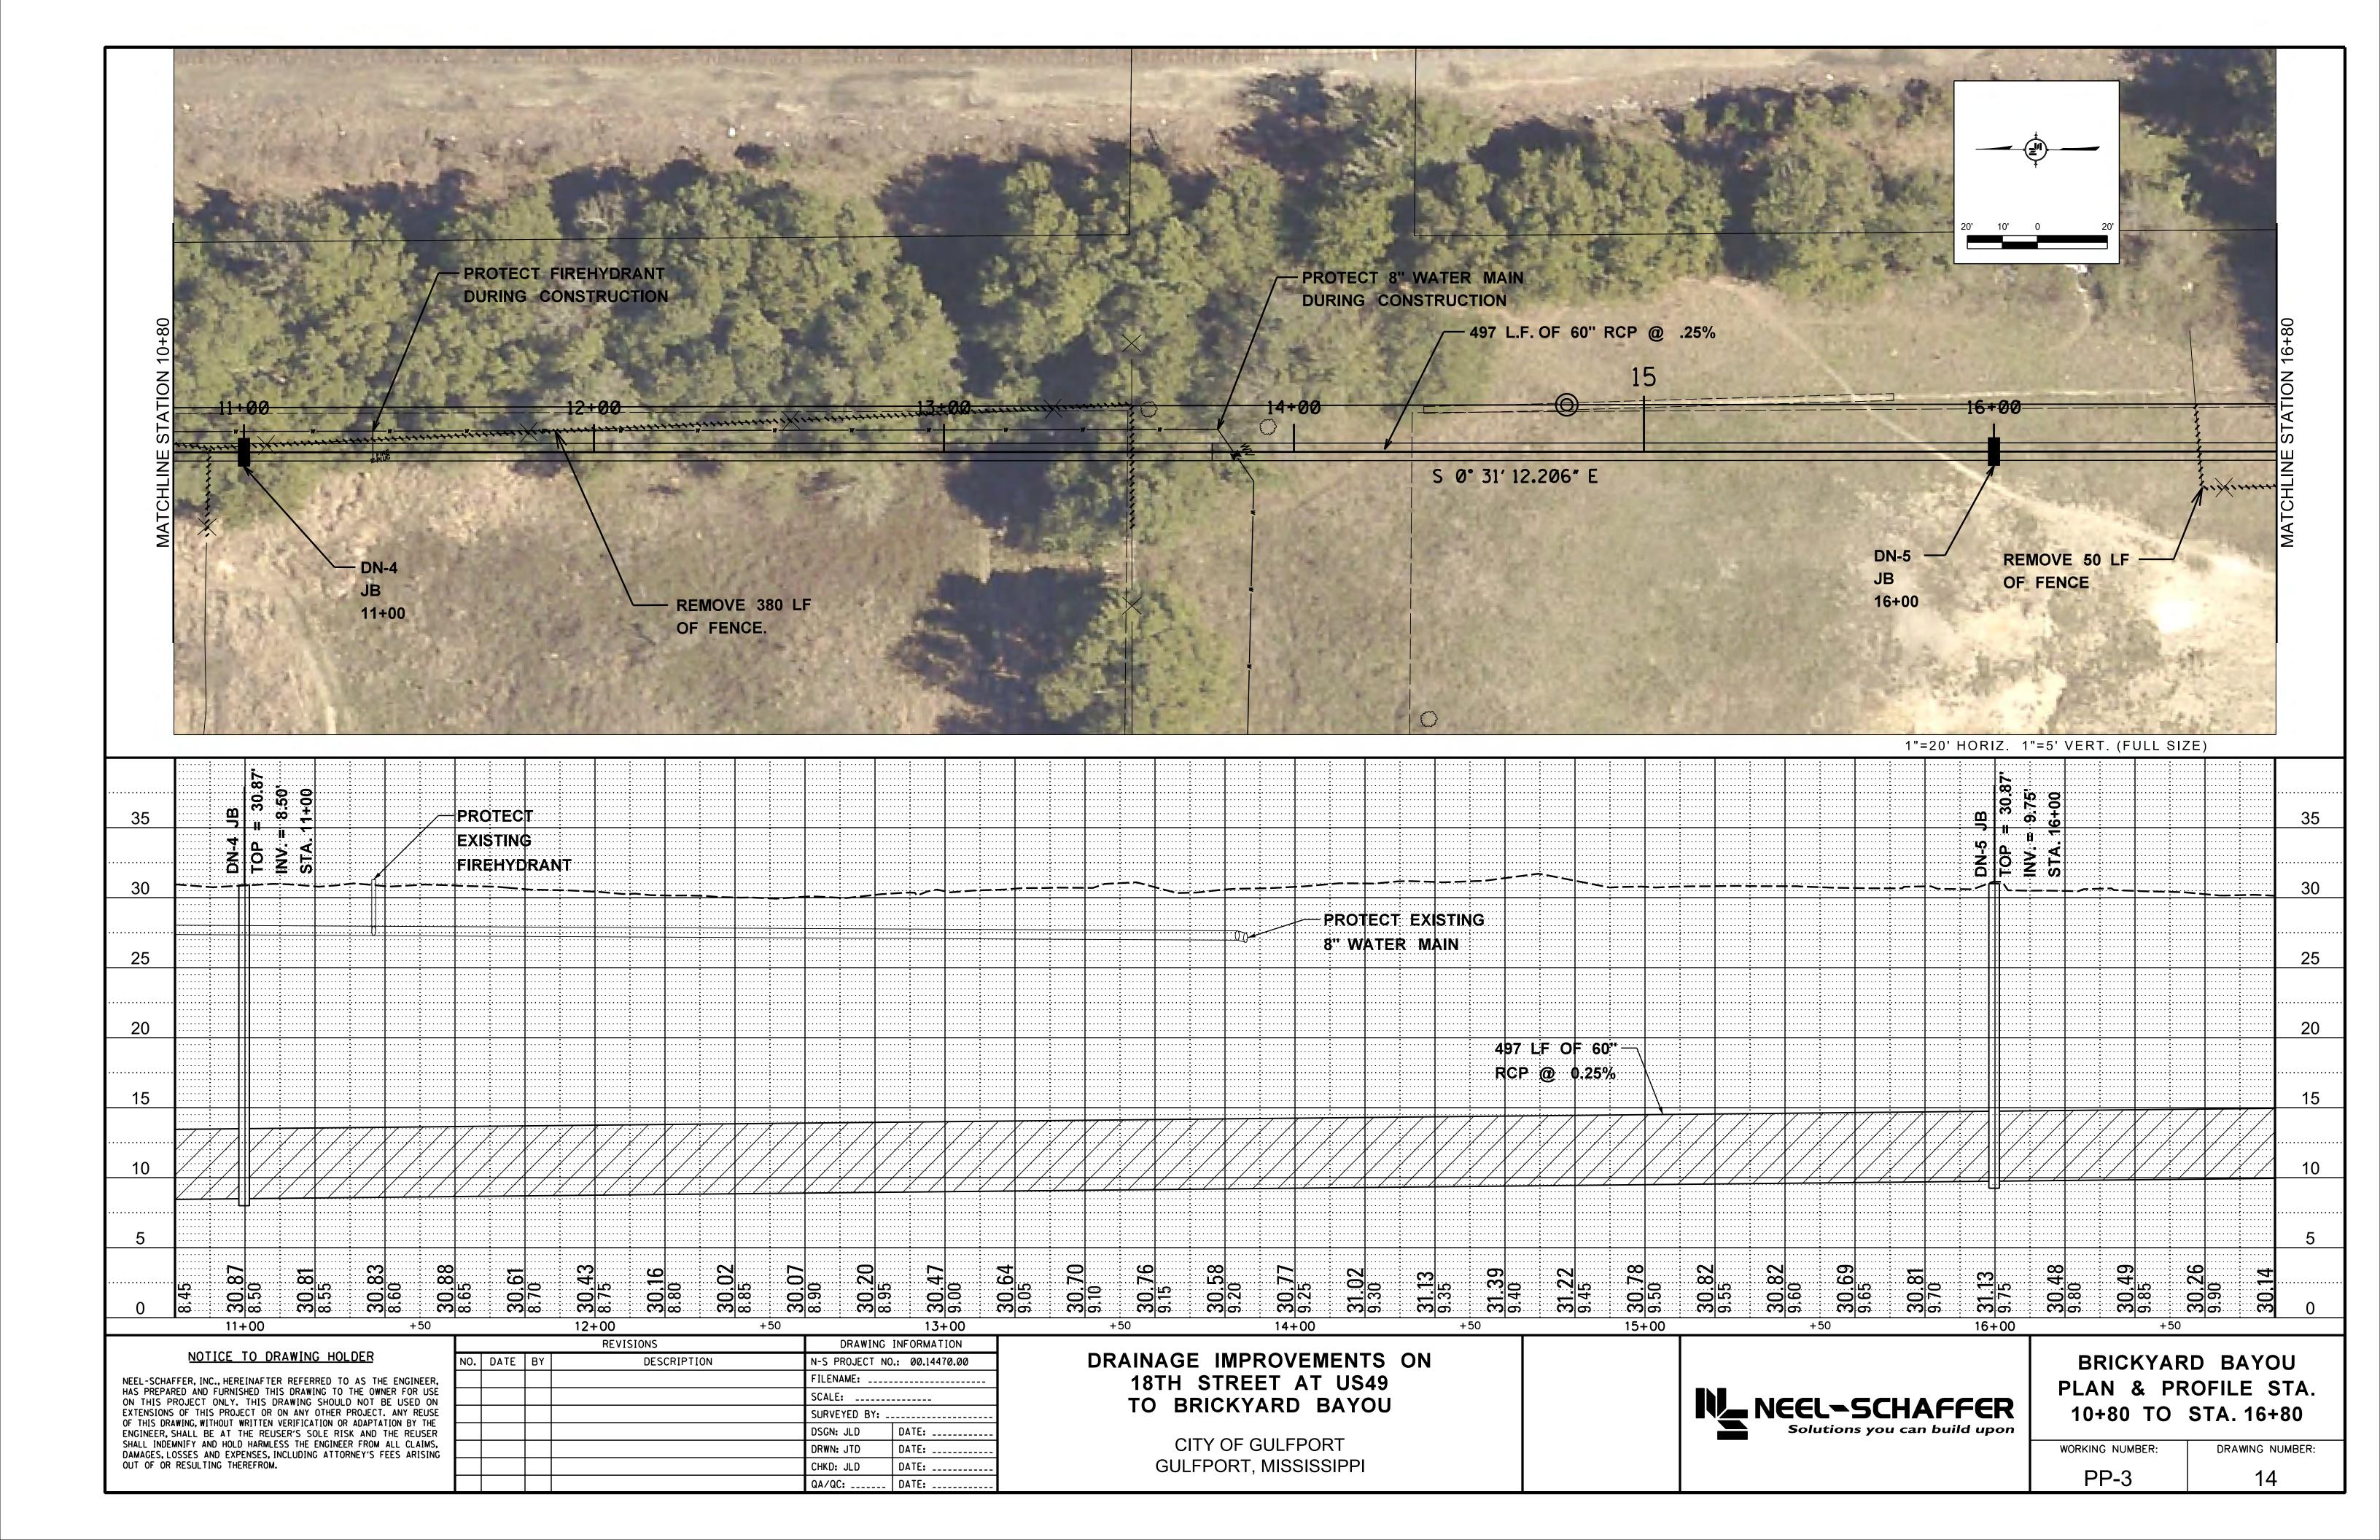


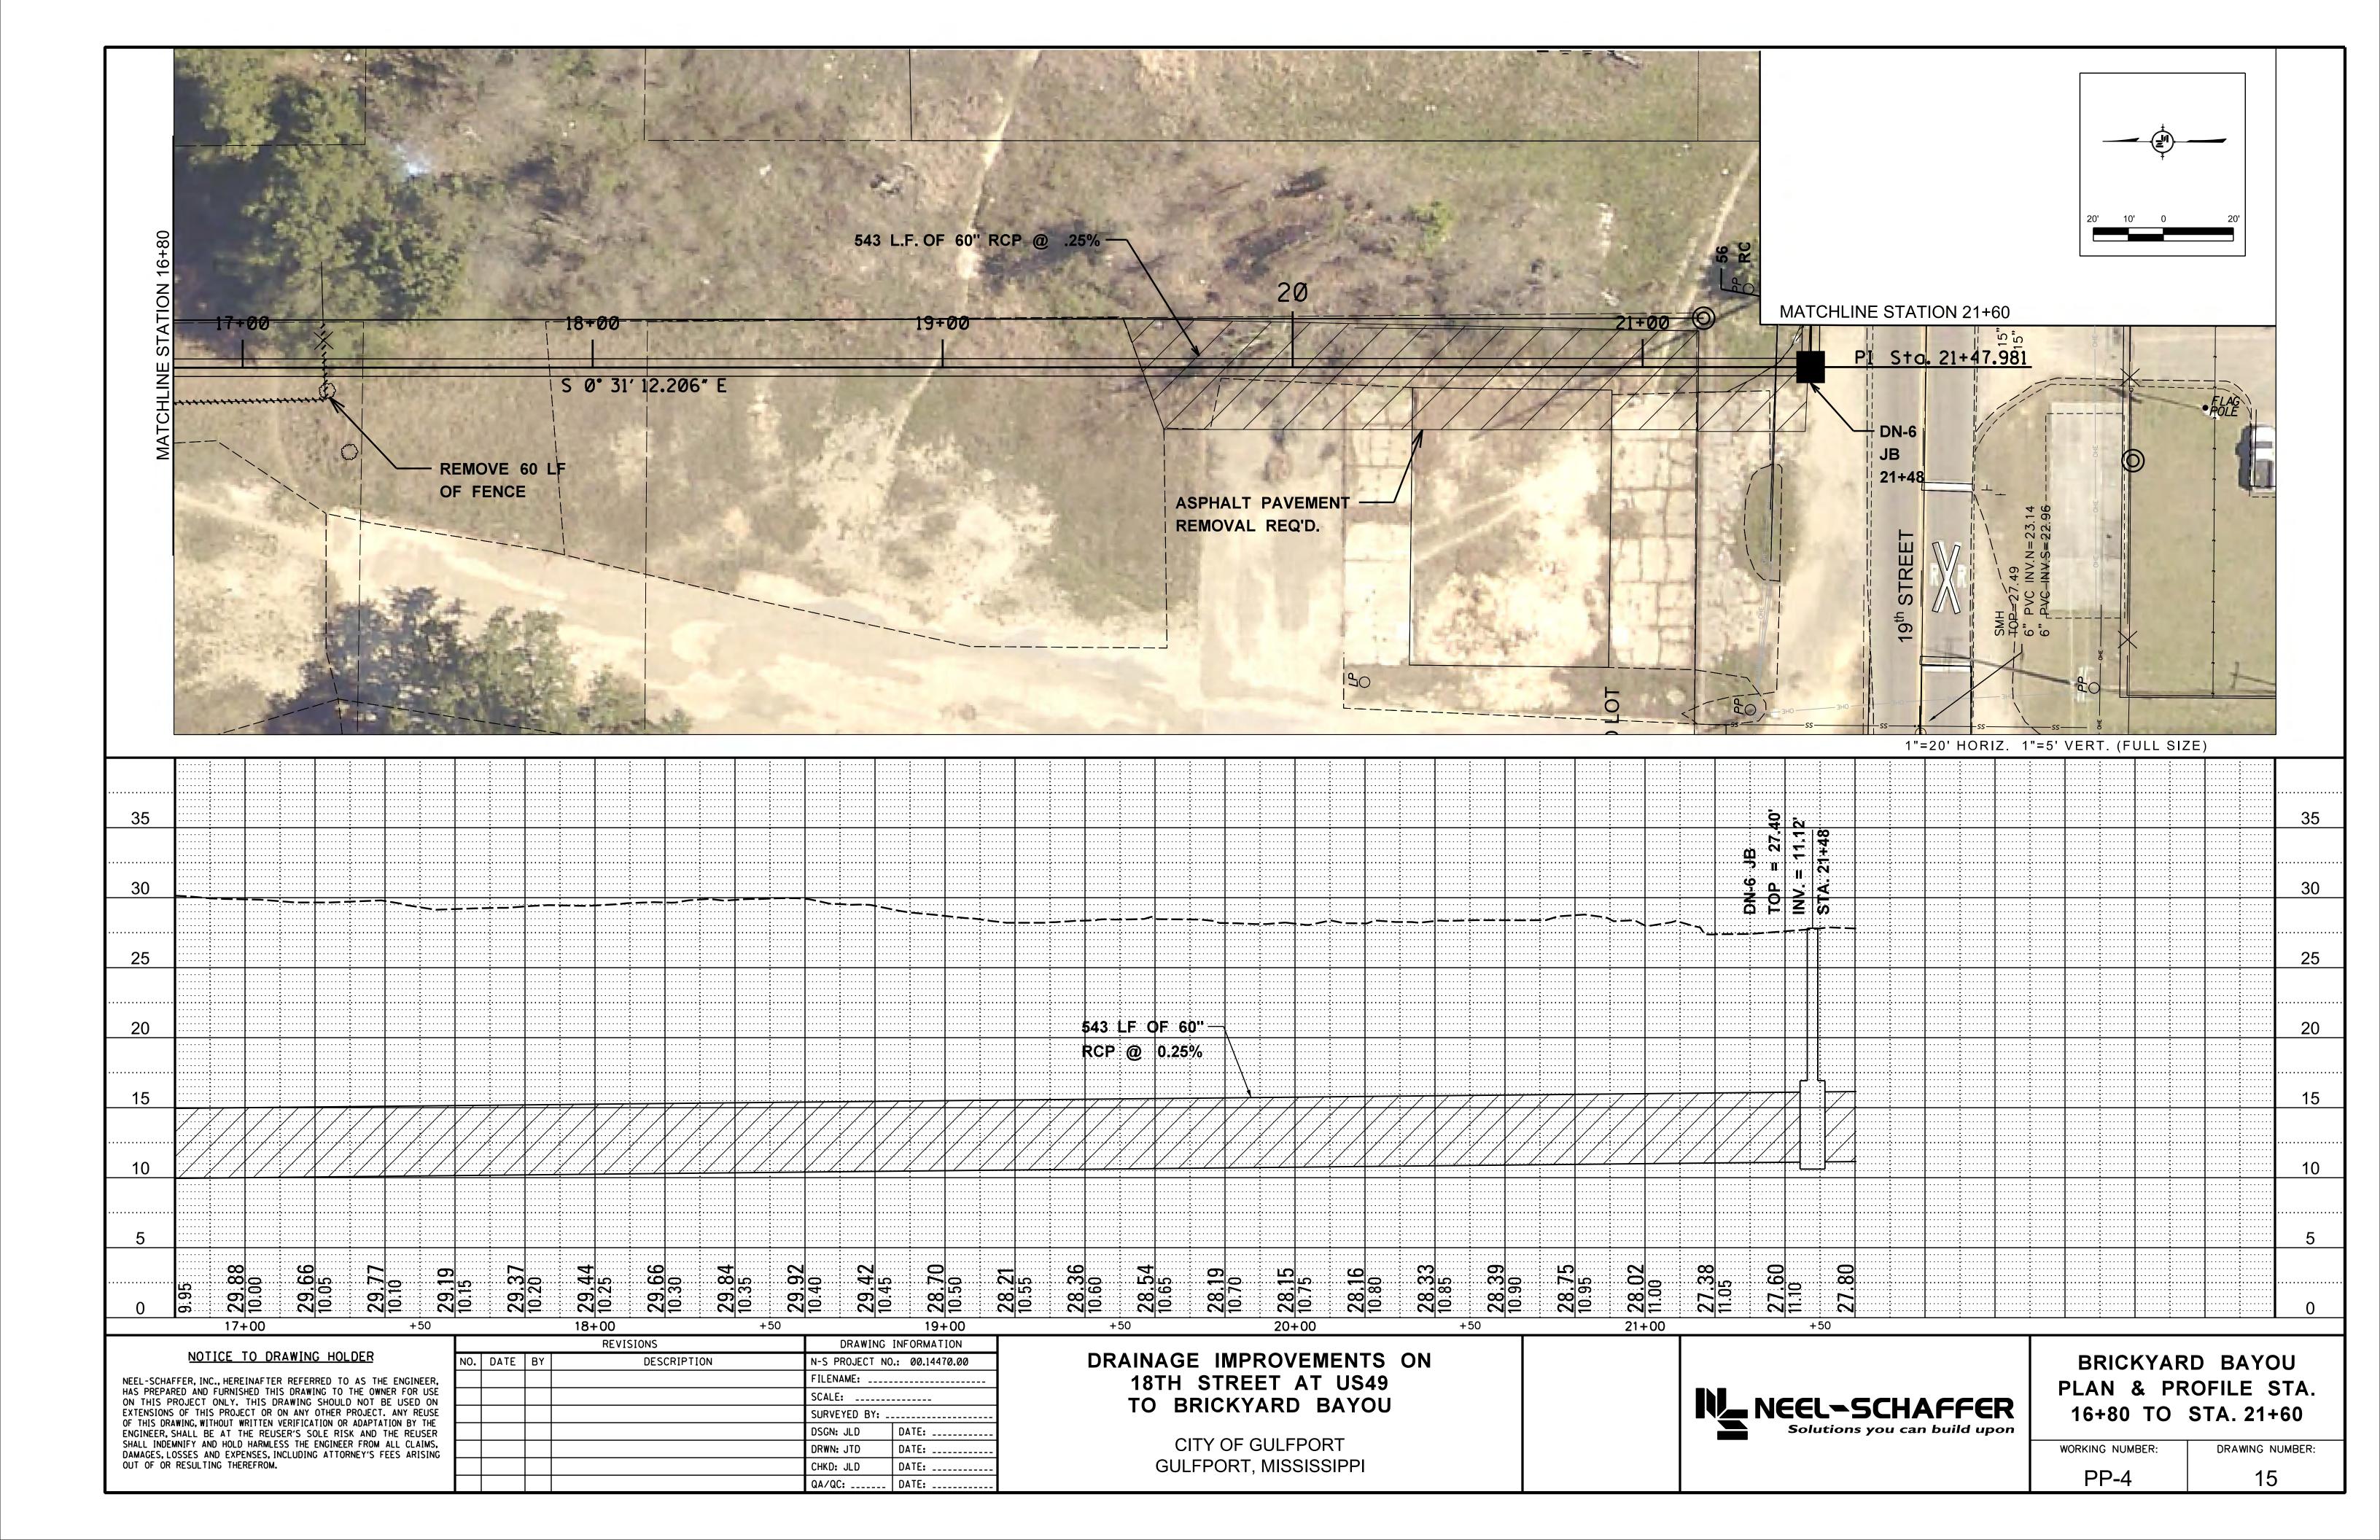


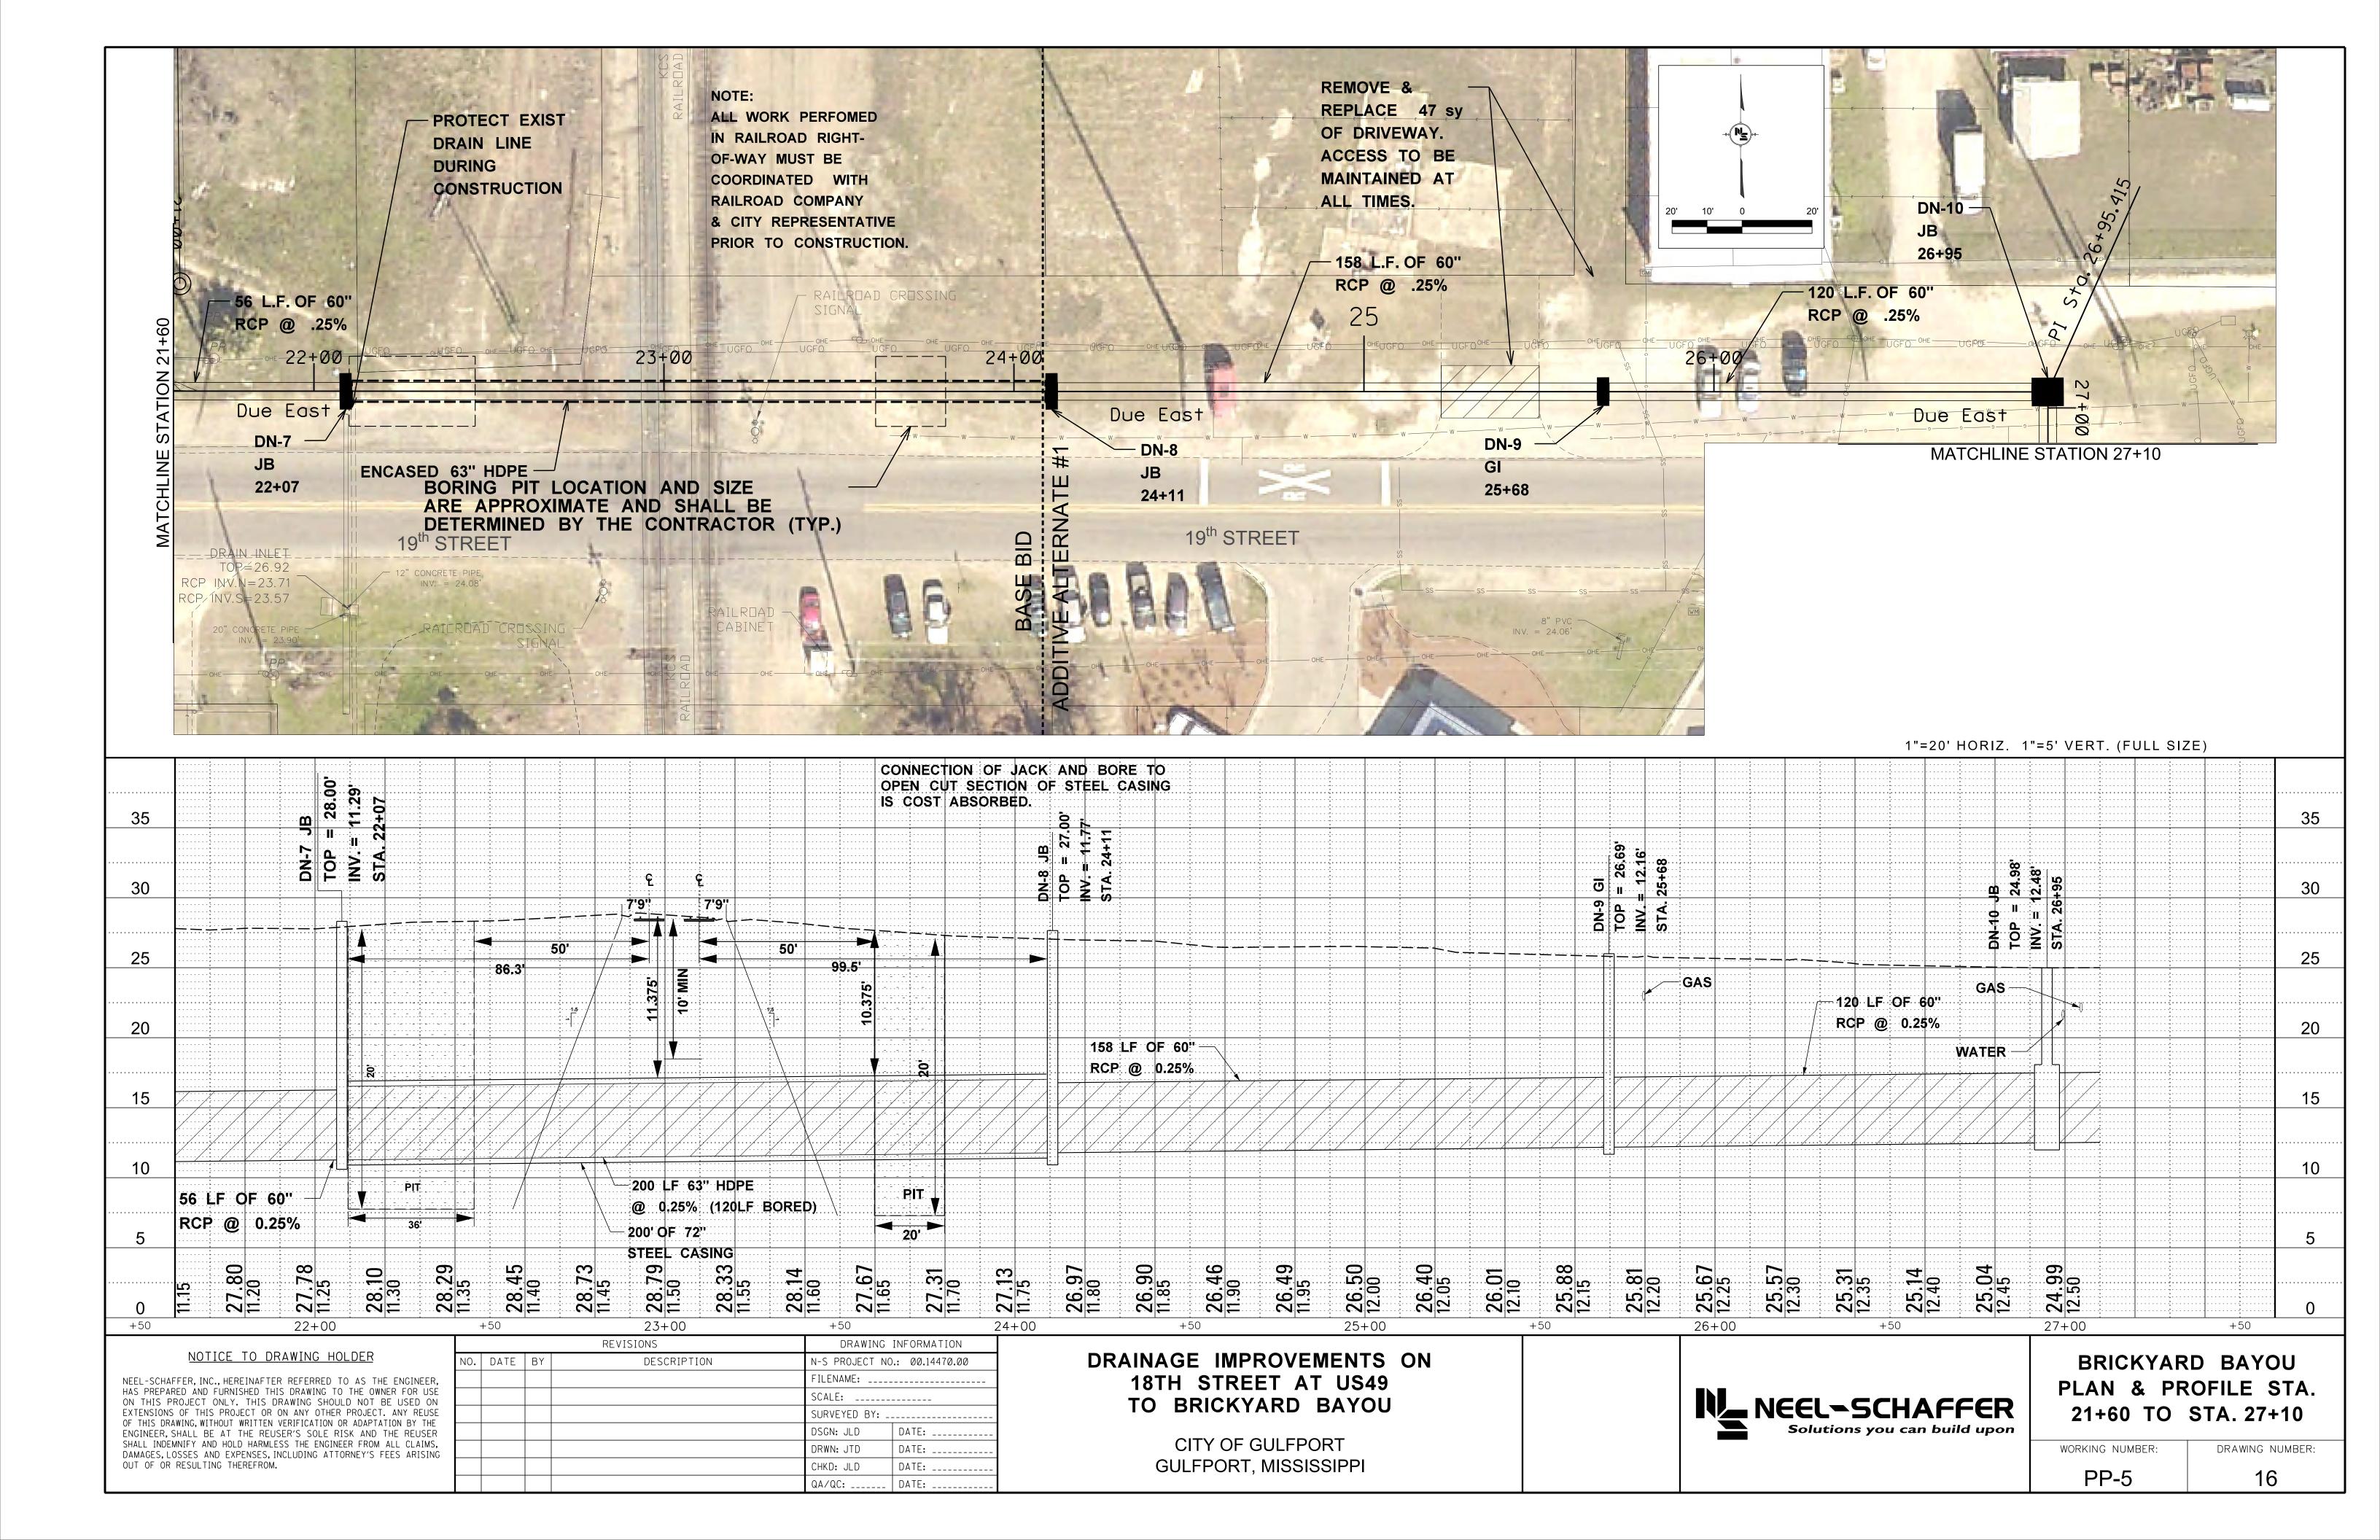


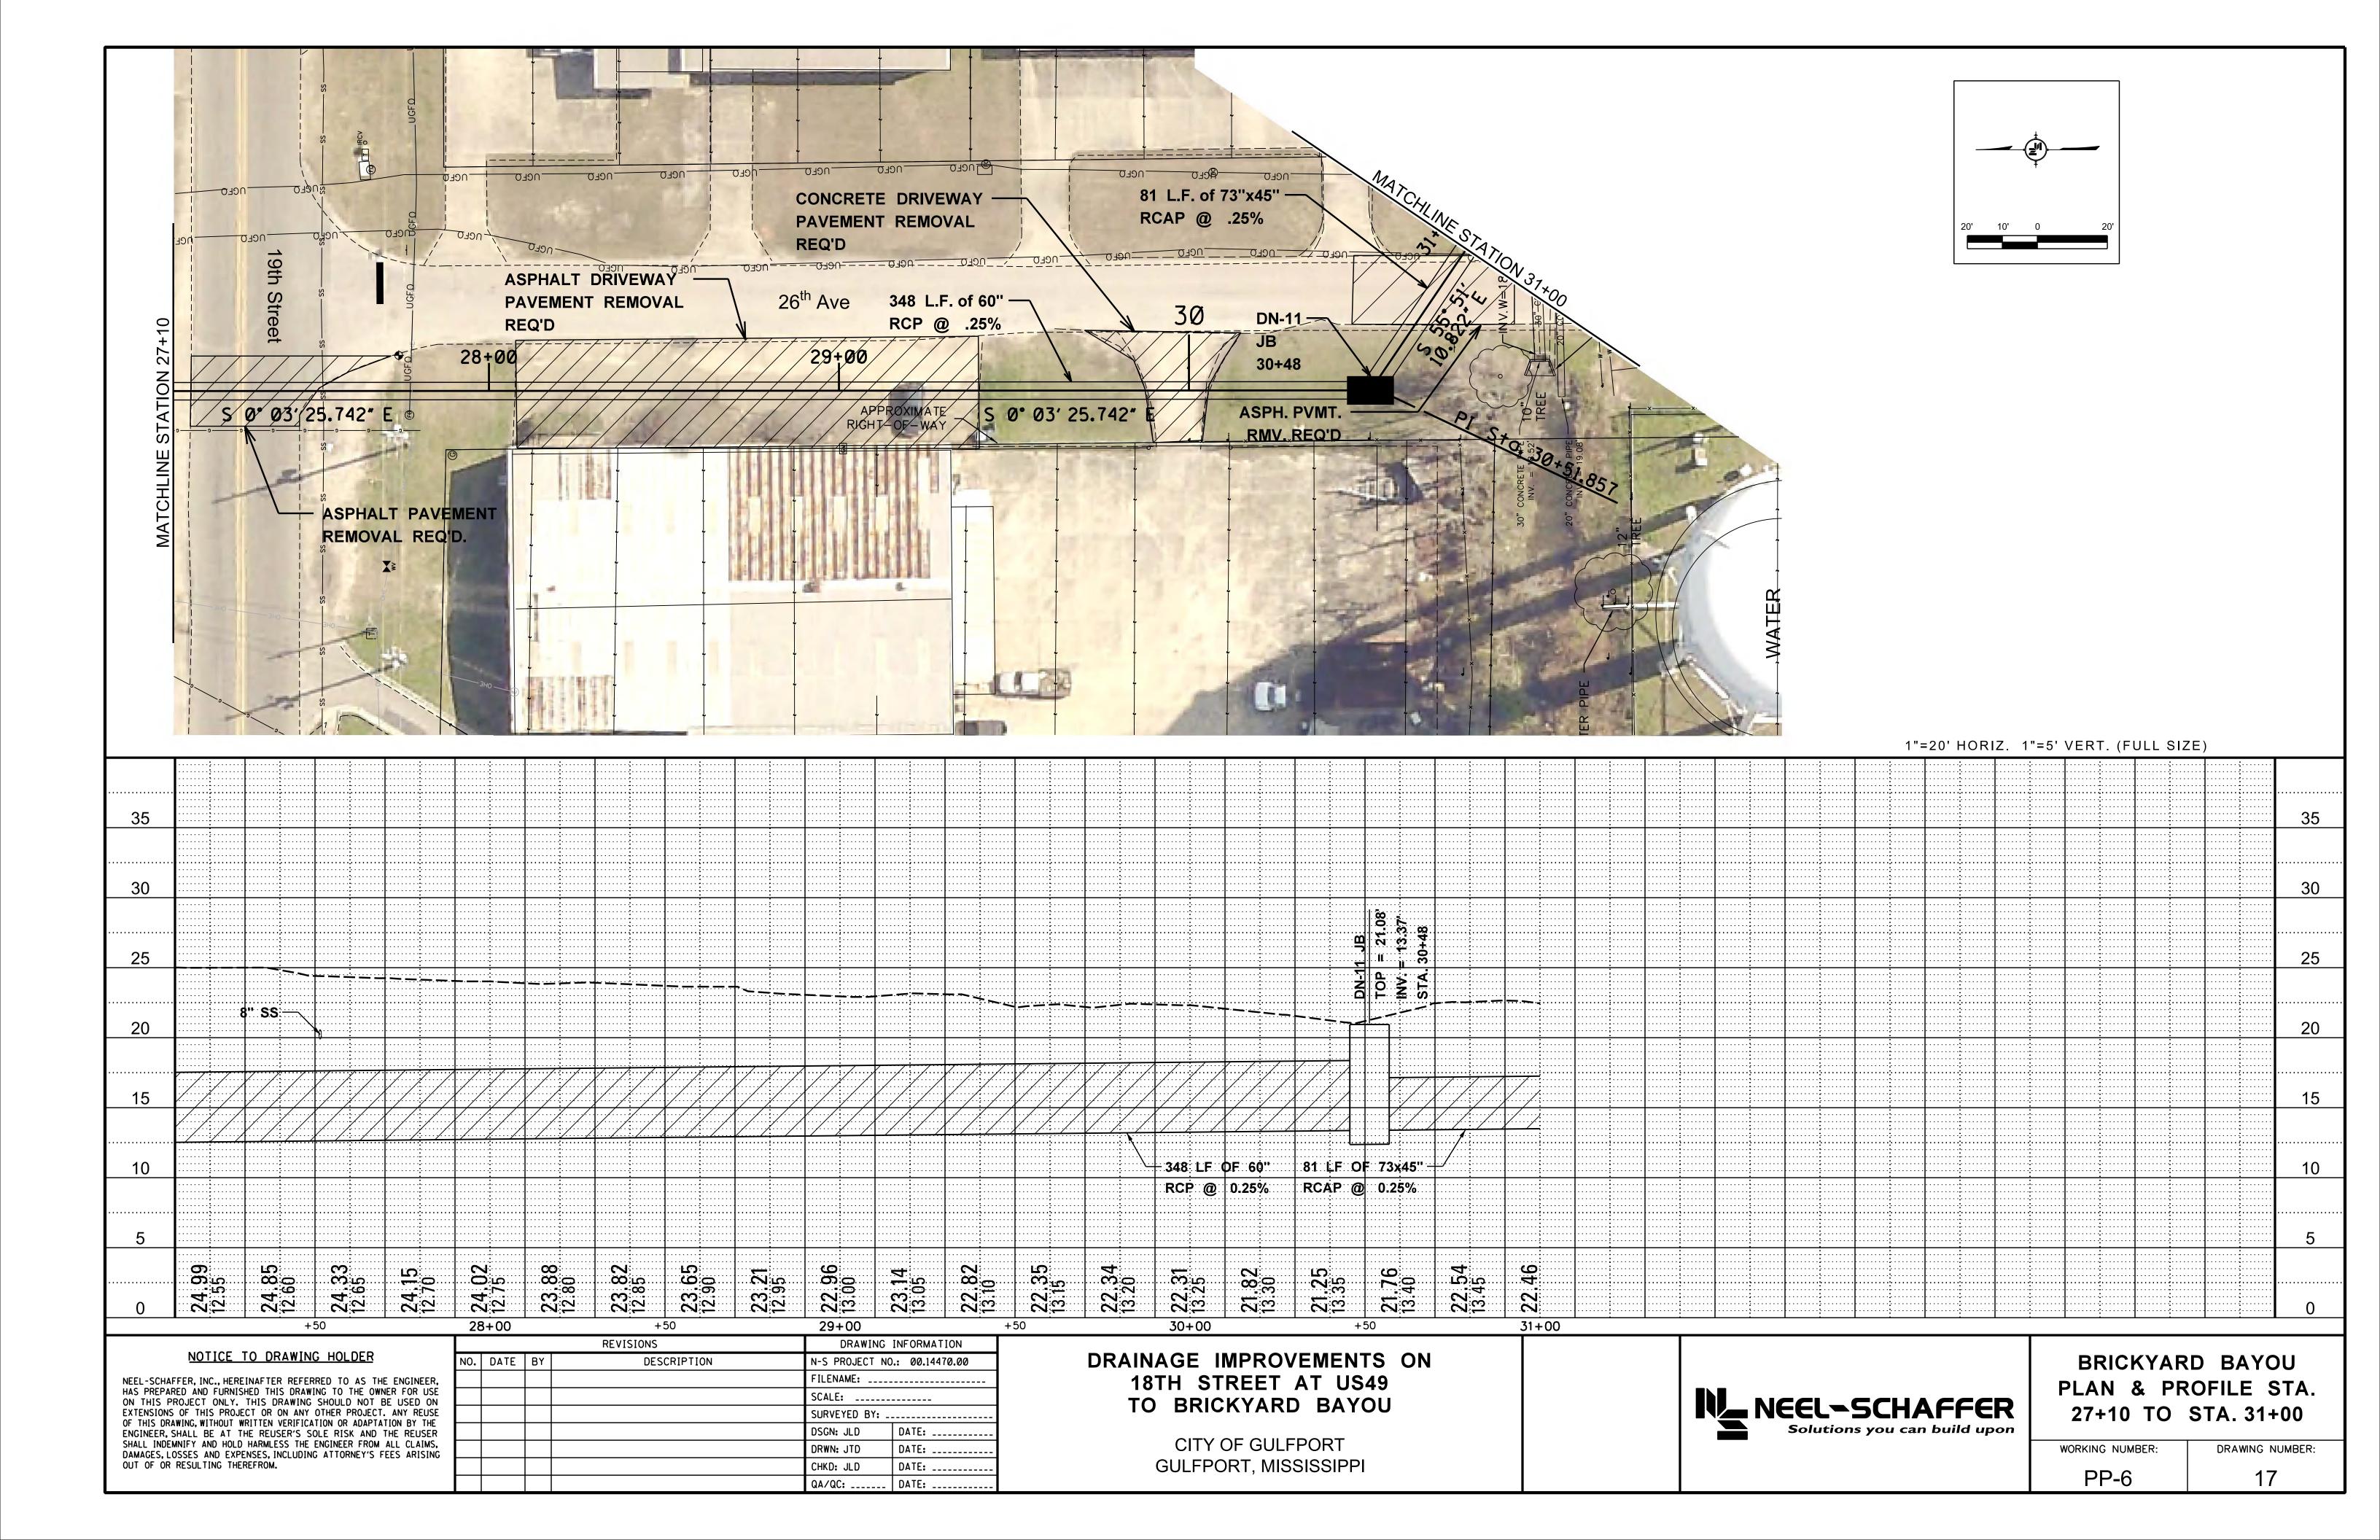

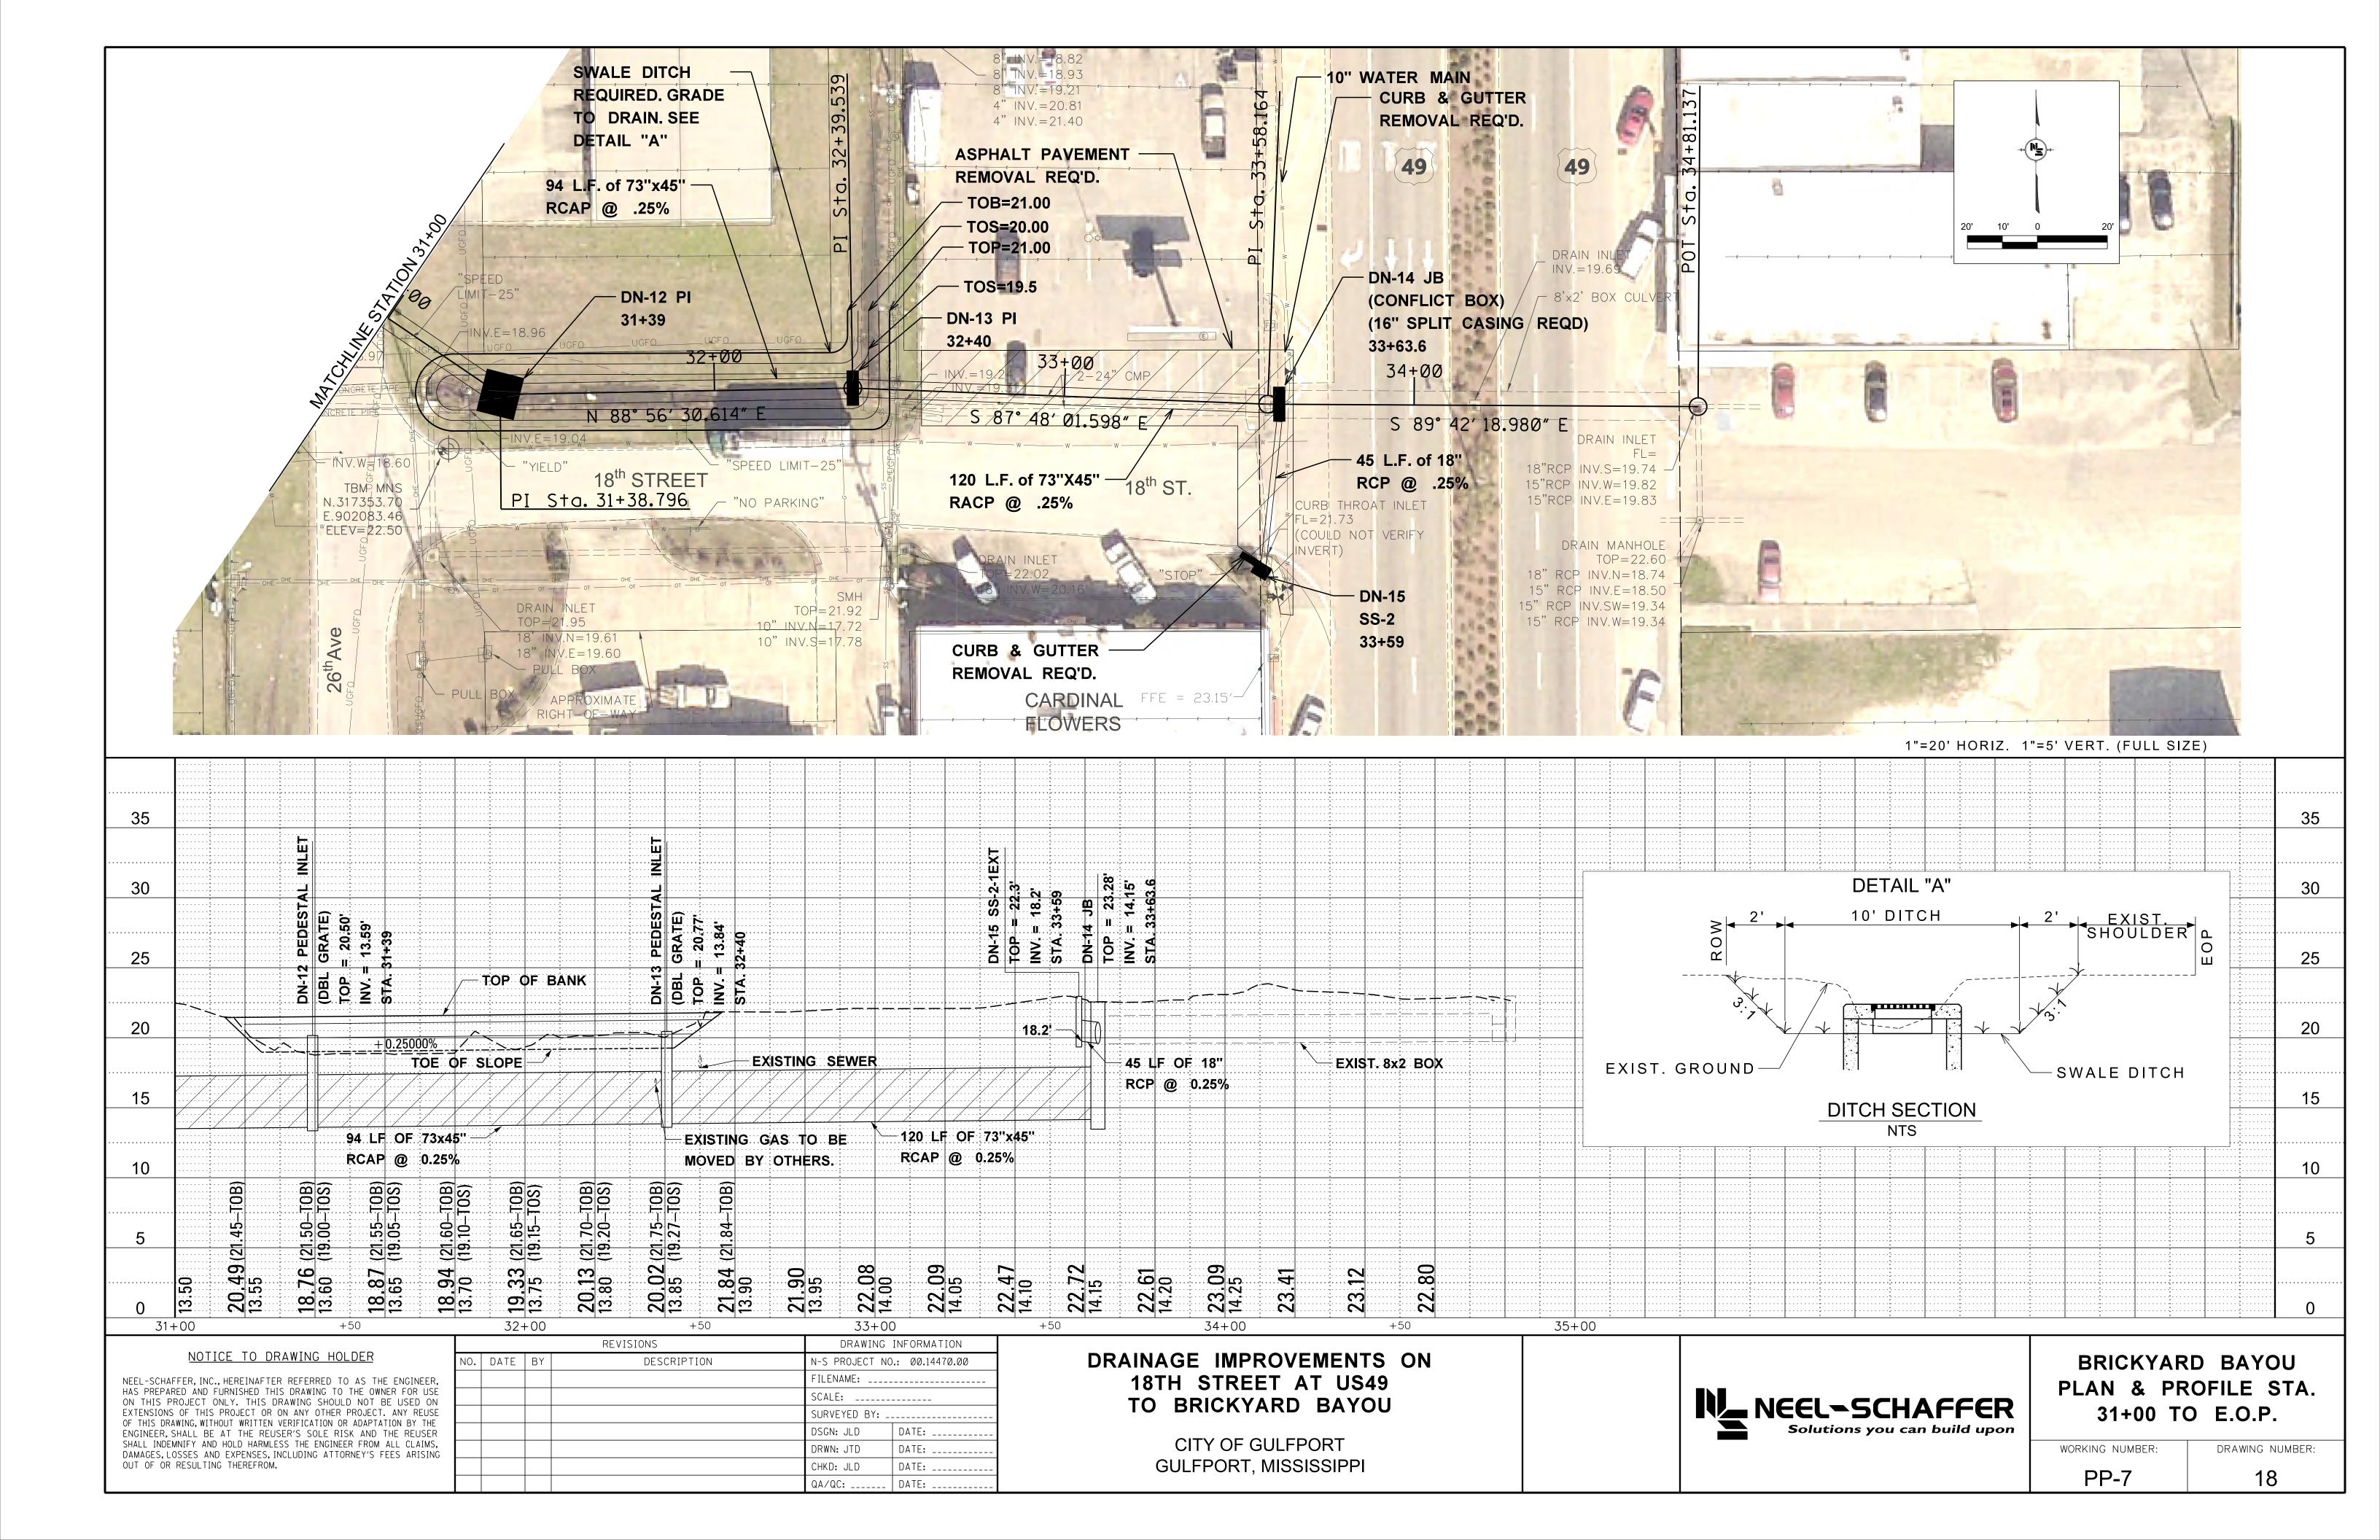

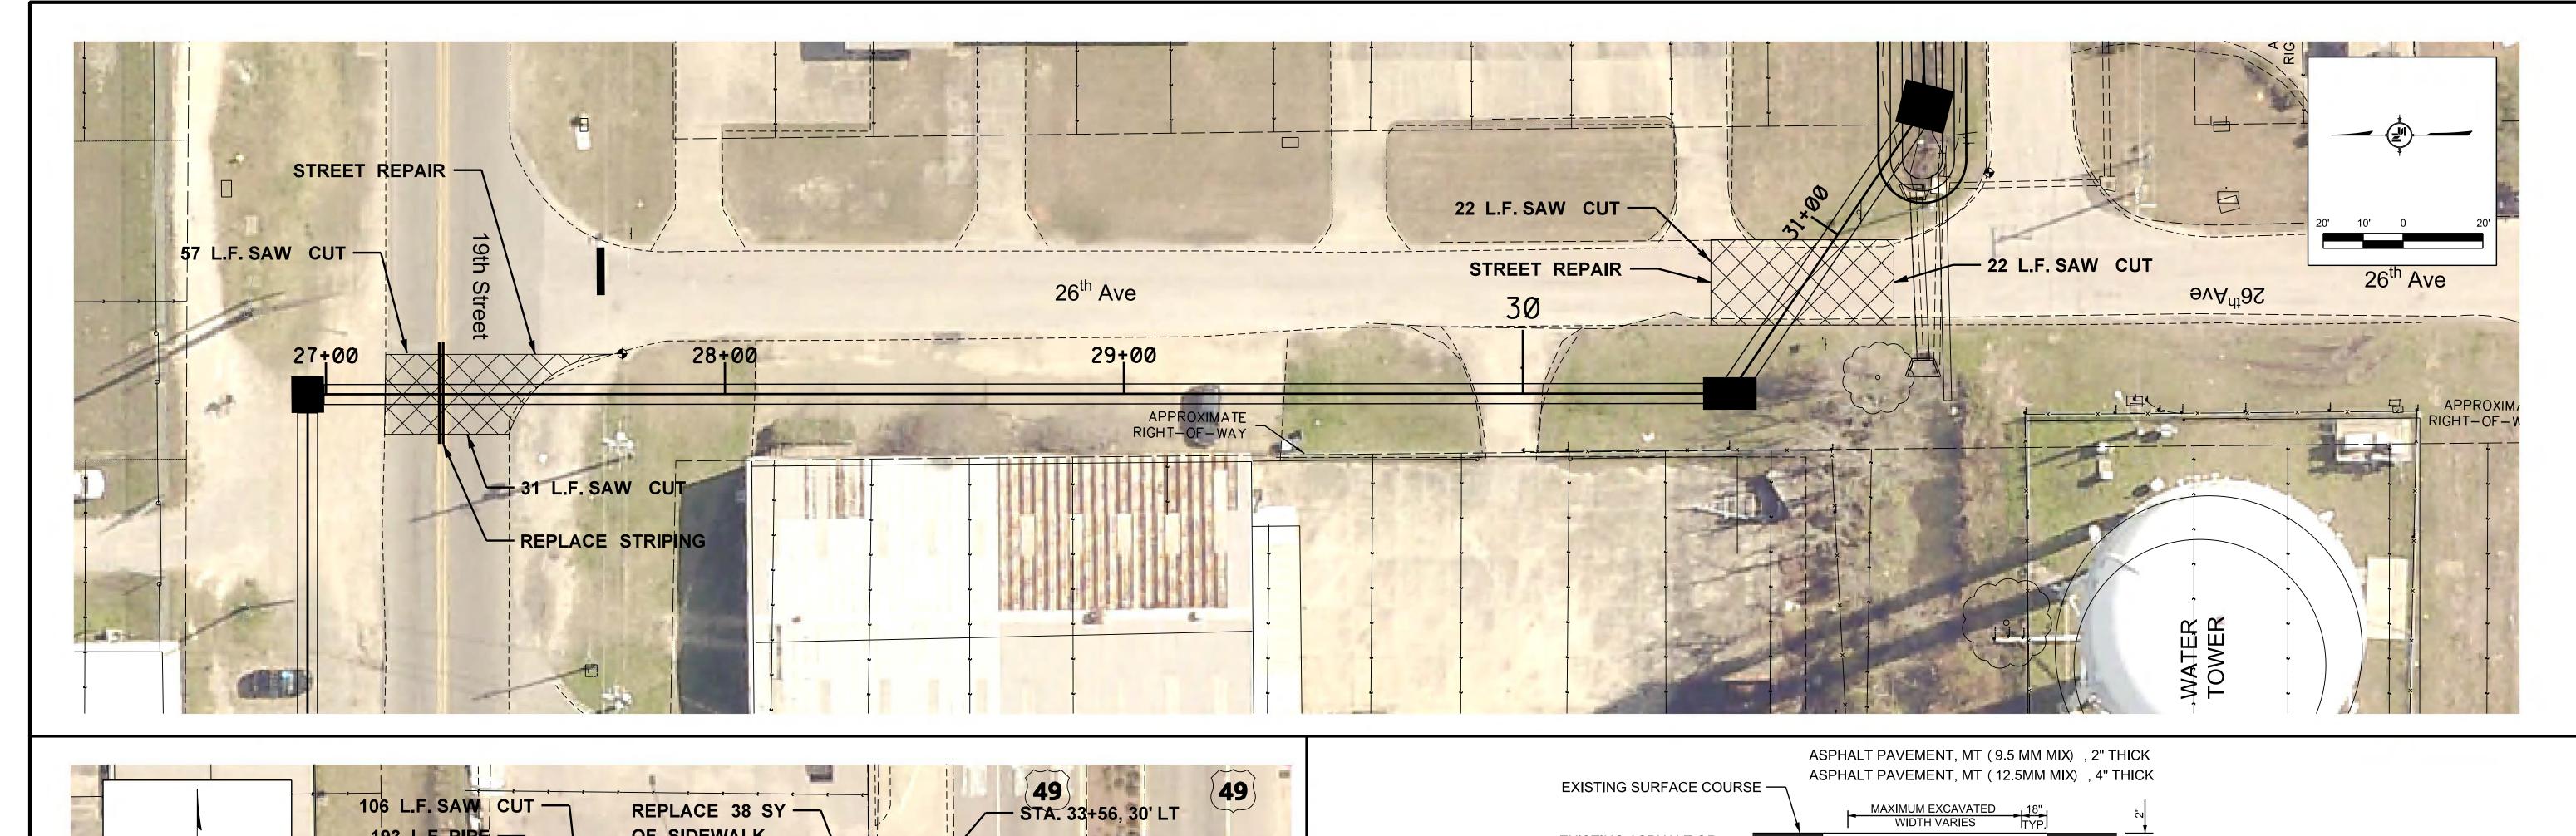

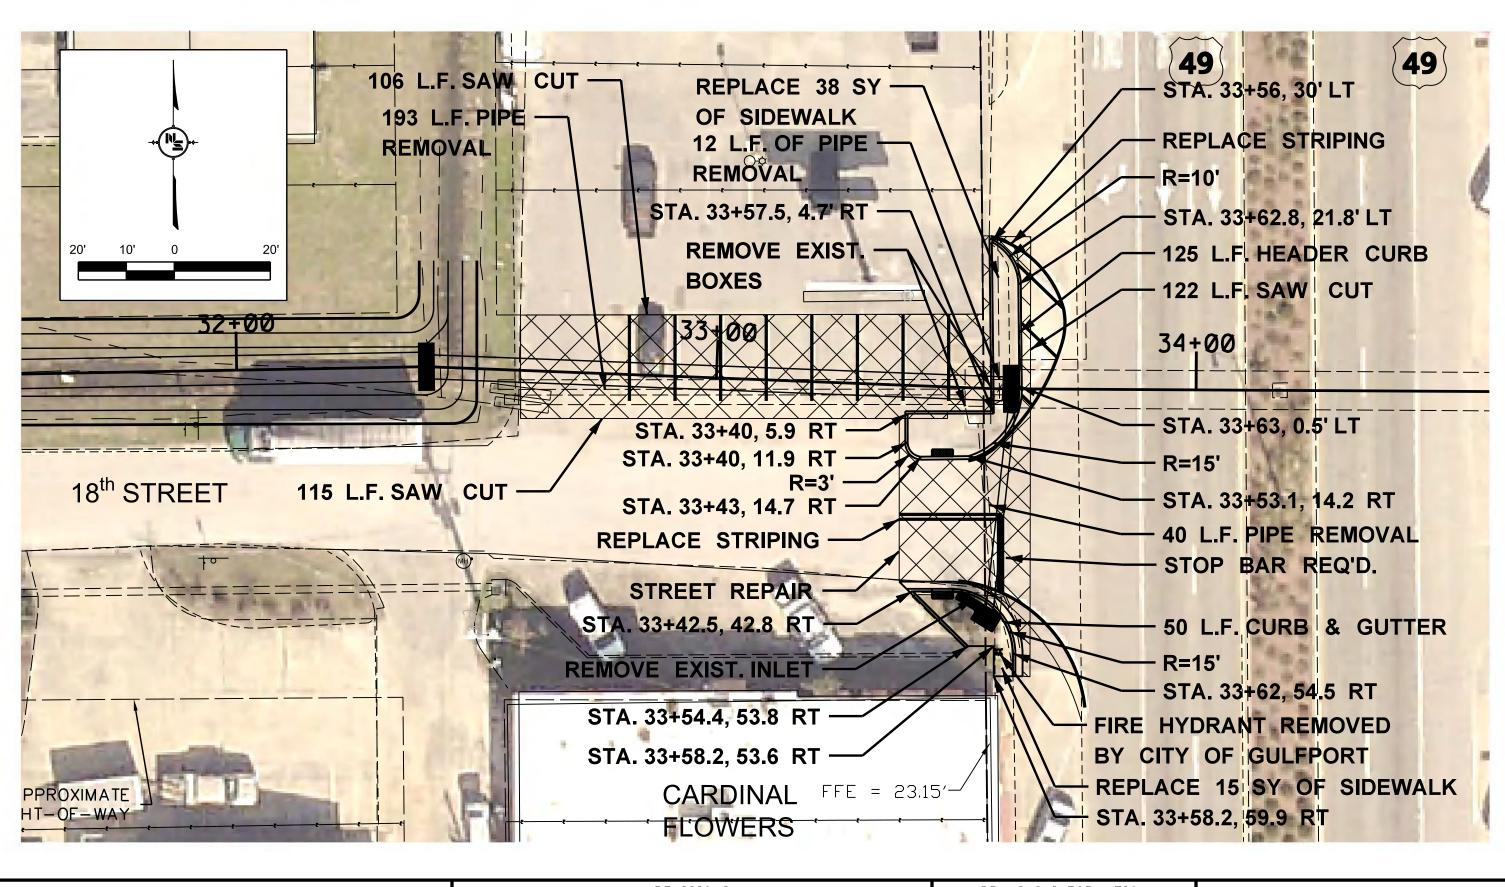

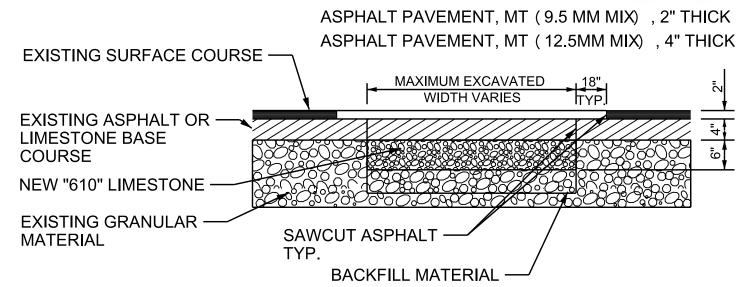

NOTES:

- 1. EXISTING GRANULAR MATERIAL, NEW BACKFILL MATERIAL, AND NEW "610" LIMESTONE SHALL BE COMPACTED TO 95% PROCTOR PER ASTM D1557.
- 2. TACK COAT SHALL BE APPLIED WHERE NEW ASPHALT MEETS EXISTING ASPHALT AND SHALL BE COST ABSORBED.
- 3. REFER TO OTHER DETAILS FOR UTILITY PLACEMENT. PAVEMENT MARKINGS REMOVED SHALL BE REPLACED AND PAID FOR UNDER PAY ITEM 02581-A, PAINTED TRAFFIC MARKINGS PER LUMP SUM.
- 4."MAXIMUM EXCAVATED WIDTH"REFERS TO THE MAXIMUM WIDTH THAT WILL BE USED FOR COMPUTATION OF APPLICABLE PAY ITEMS FOR BEDDING, BORROW FOR BACKFILL, LIMESTONE, OR PAVING. THE CONTRACTOR MAY EXCAVATE A WIDER TRENCH AT HIS OWN EXPENSE AS LONG THE TRENCH REMAINS WITHIN THE LIMITS OF THE CITY R.O.W., PROPERTY OR EASEMENT AND THE CITY ENGINEER OR HIS AUTHORIZED REPRESENTATIVE APPROVES THE DIMENSIONS OF THE WIDER TRENCH. SEE UTILITY PLACEMENT DETAILS FOR "MAXIMUM EXCAVATED TRENCH WIDTH".LIMITS OF EXCAVATION FOR POINT REPAIRS SHALL BE DETERMINED IN THE FIELD BY THE CITY ENGINEER OR HIS AUTHORIZED REPRESENATIVE.
- 5. ASPHALT DRIVEWAY REPAIR SHALL BE 2" THICK 9.5 MM, MT ASPHALT PAVEMENT.

ASPHALT STREET REPAIR DETAIL

N.T.S.

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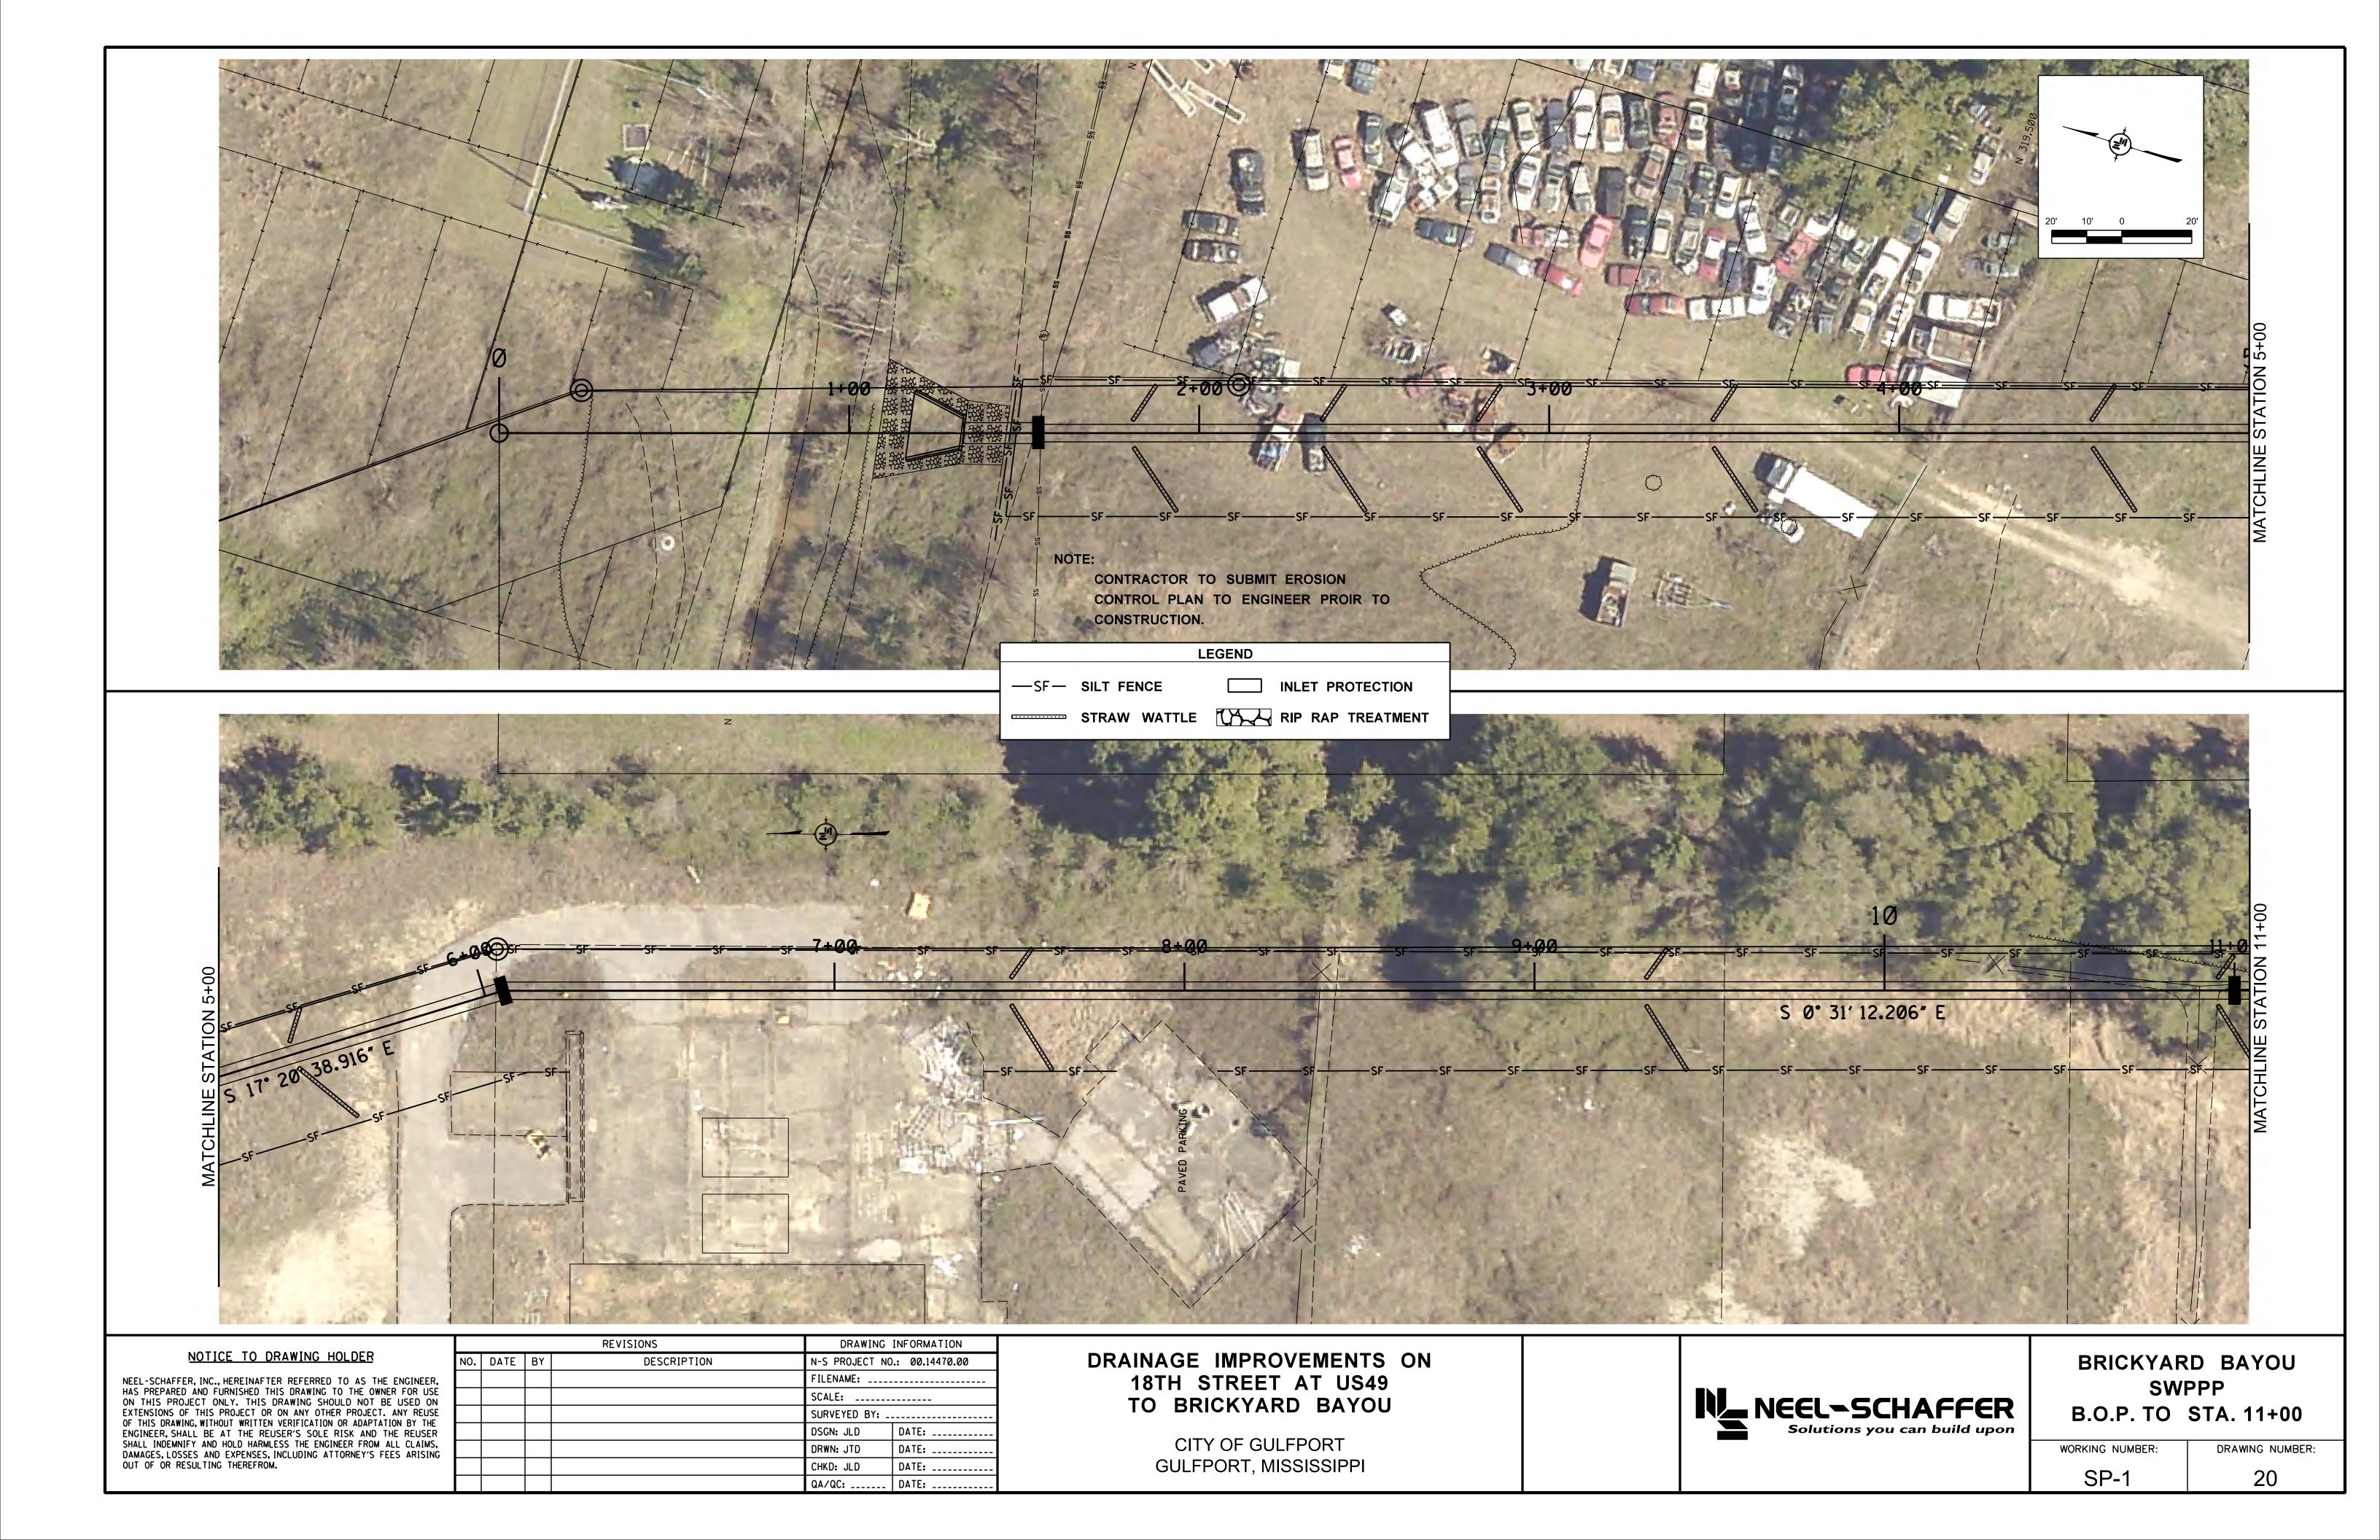
DRAINAGE IMPROVEMENTS ON 18TH STREET AT US49 TO BRICKYARD BAYOU


CITY OF GULFPORT GULFPORT, MISSISSIPPI





BRICKYARD BAYOU GEOMETRIC PLAN

WORKING NUMBER:	DRAWING NUMBER:
GEO-1	19



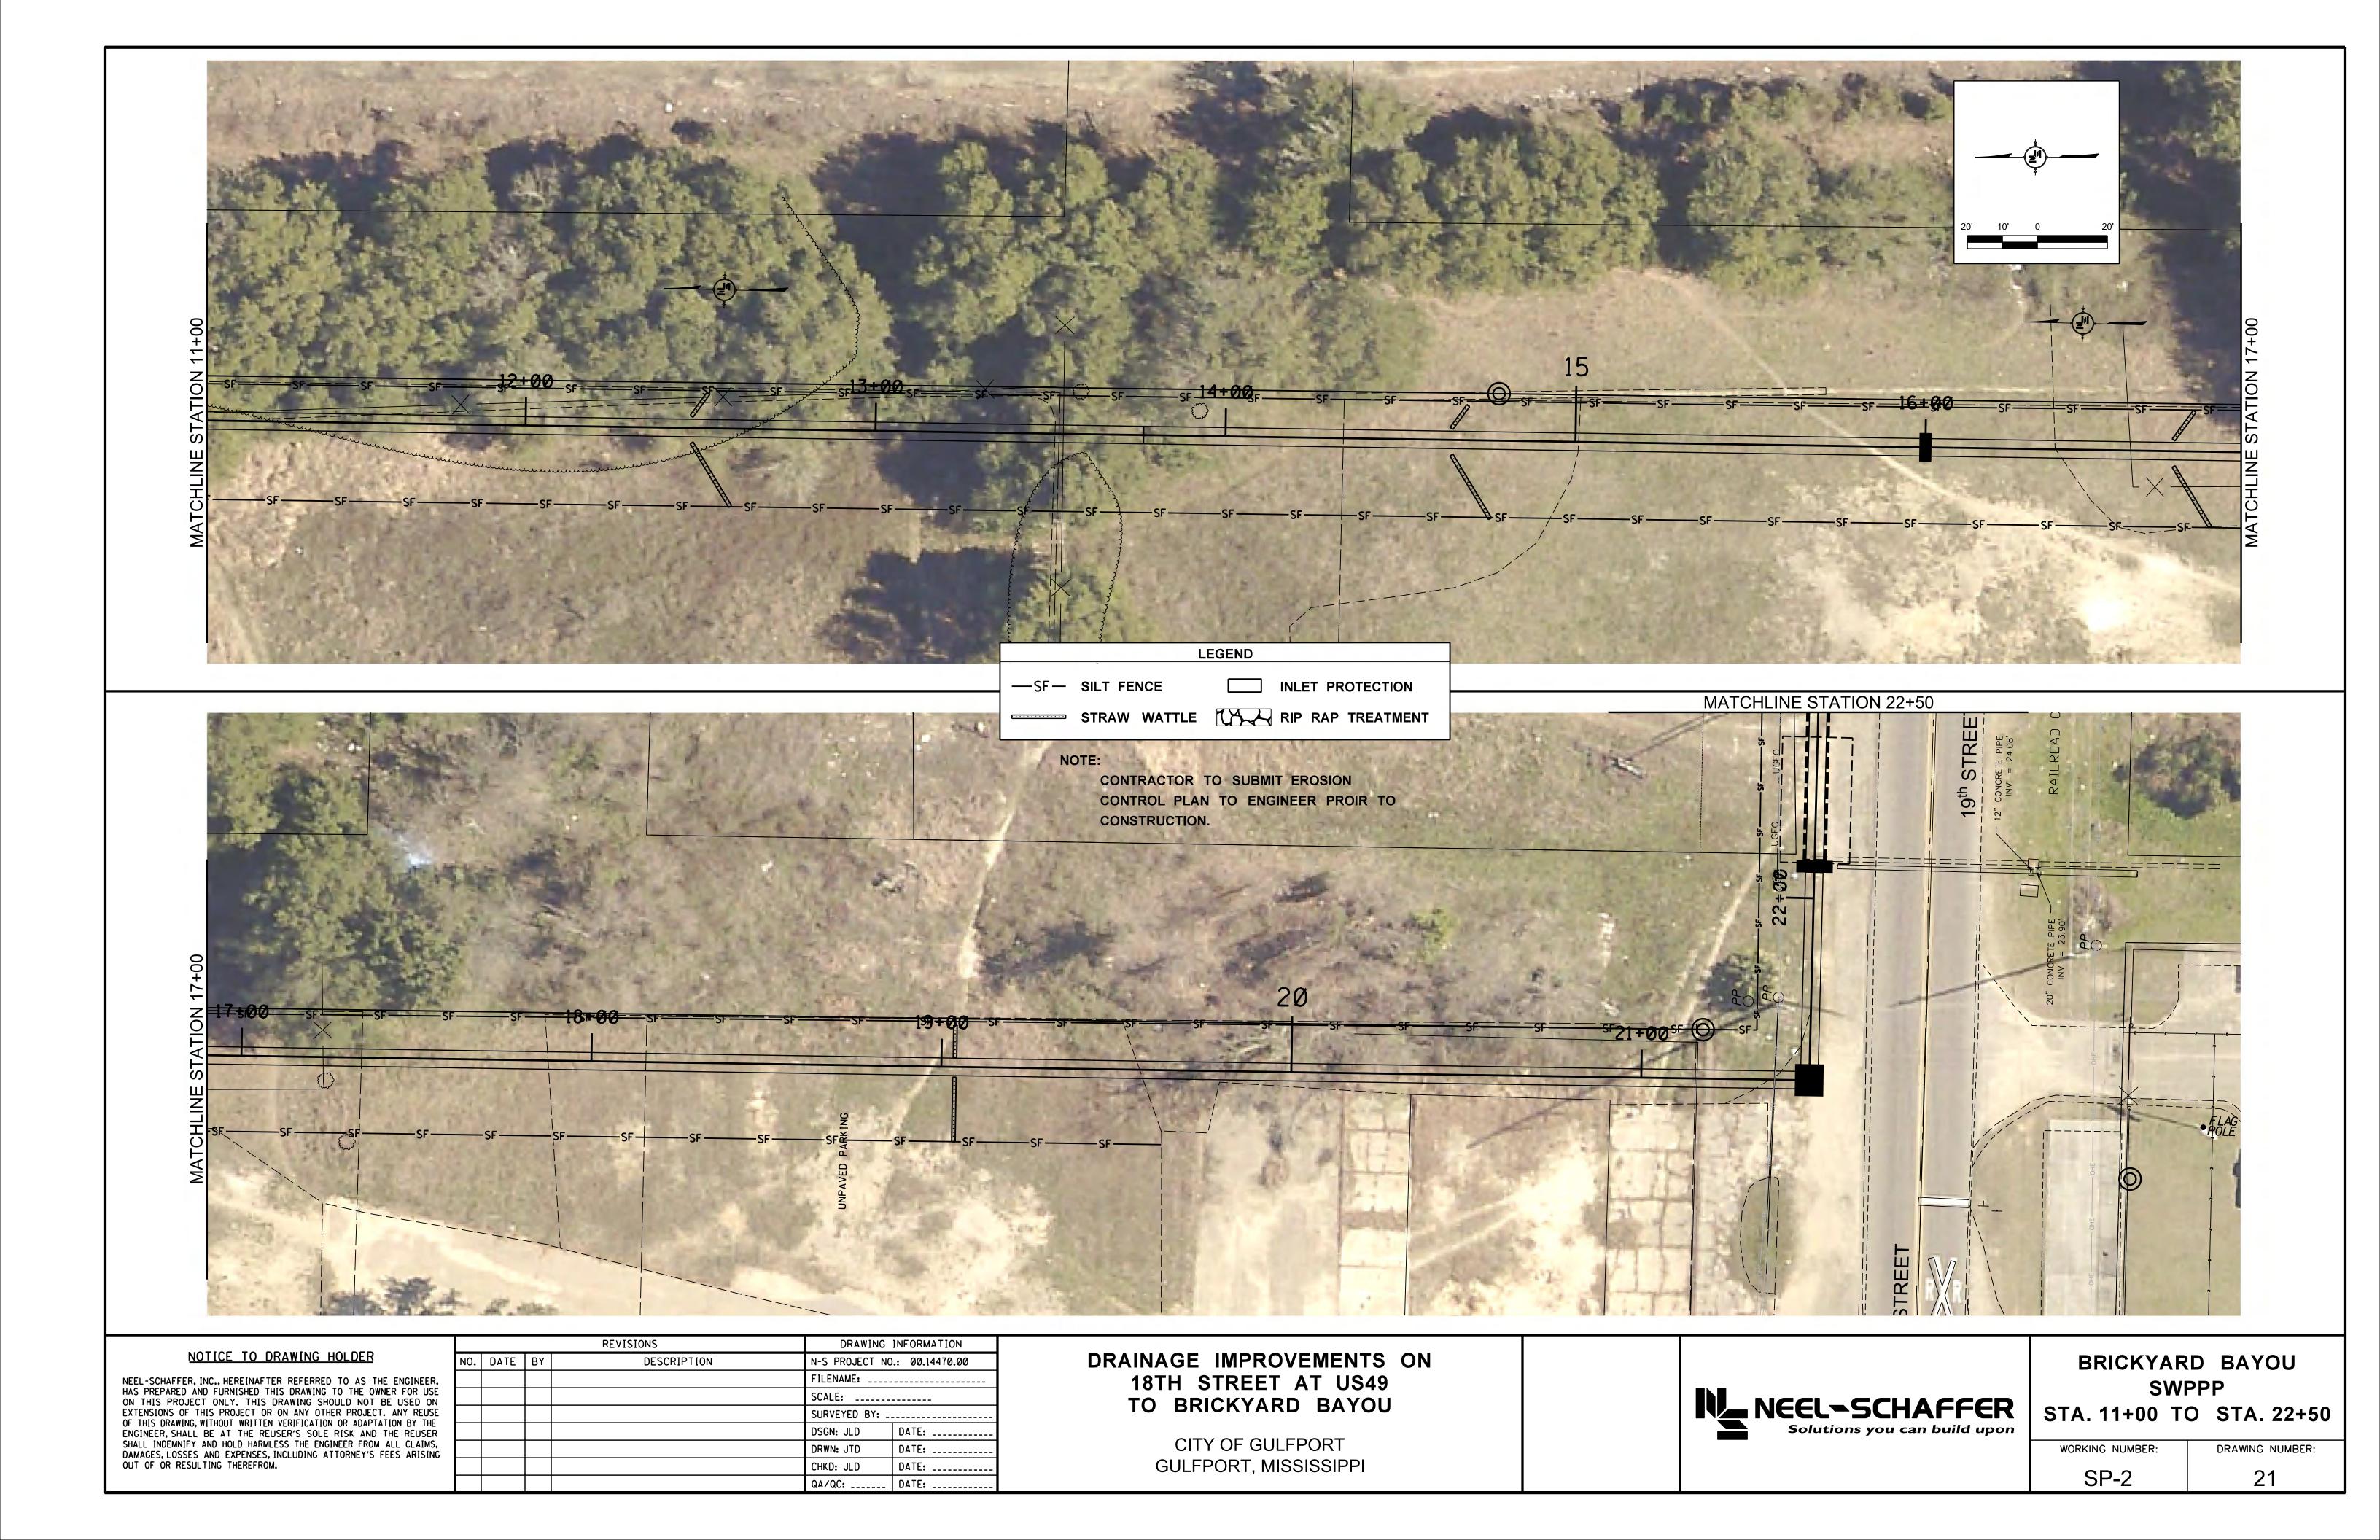

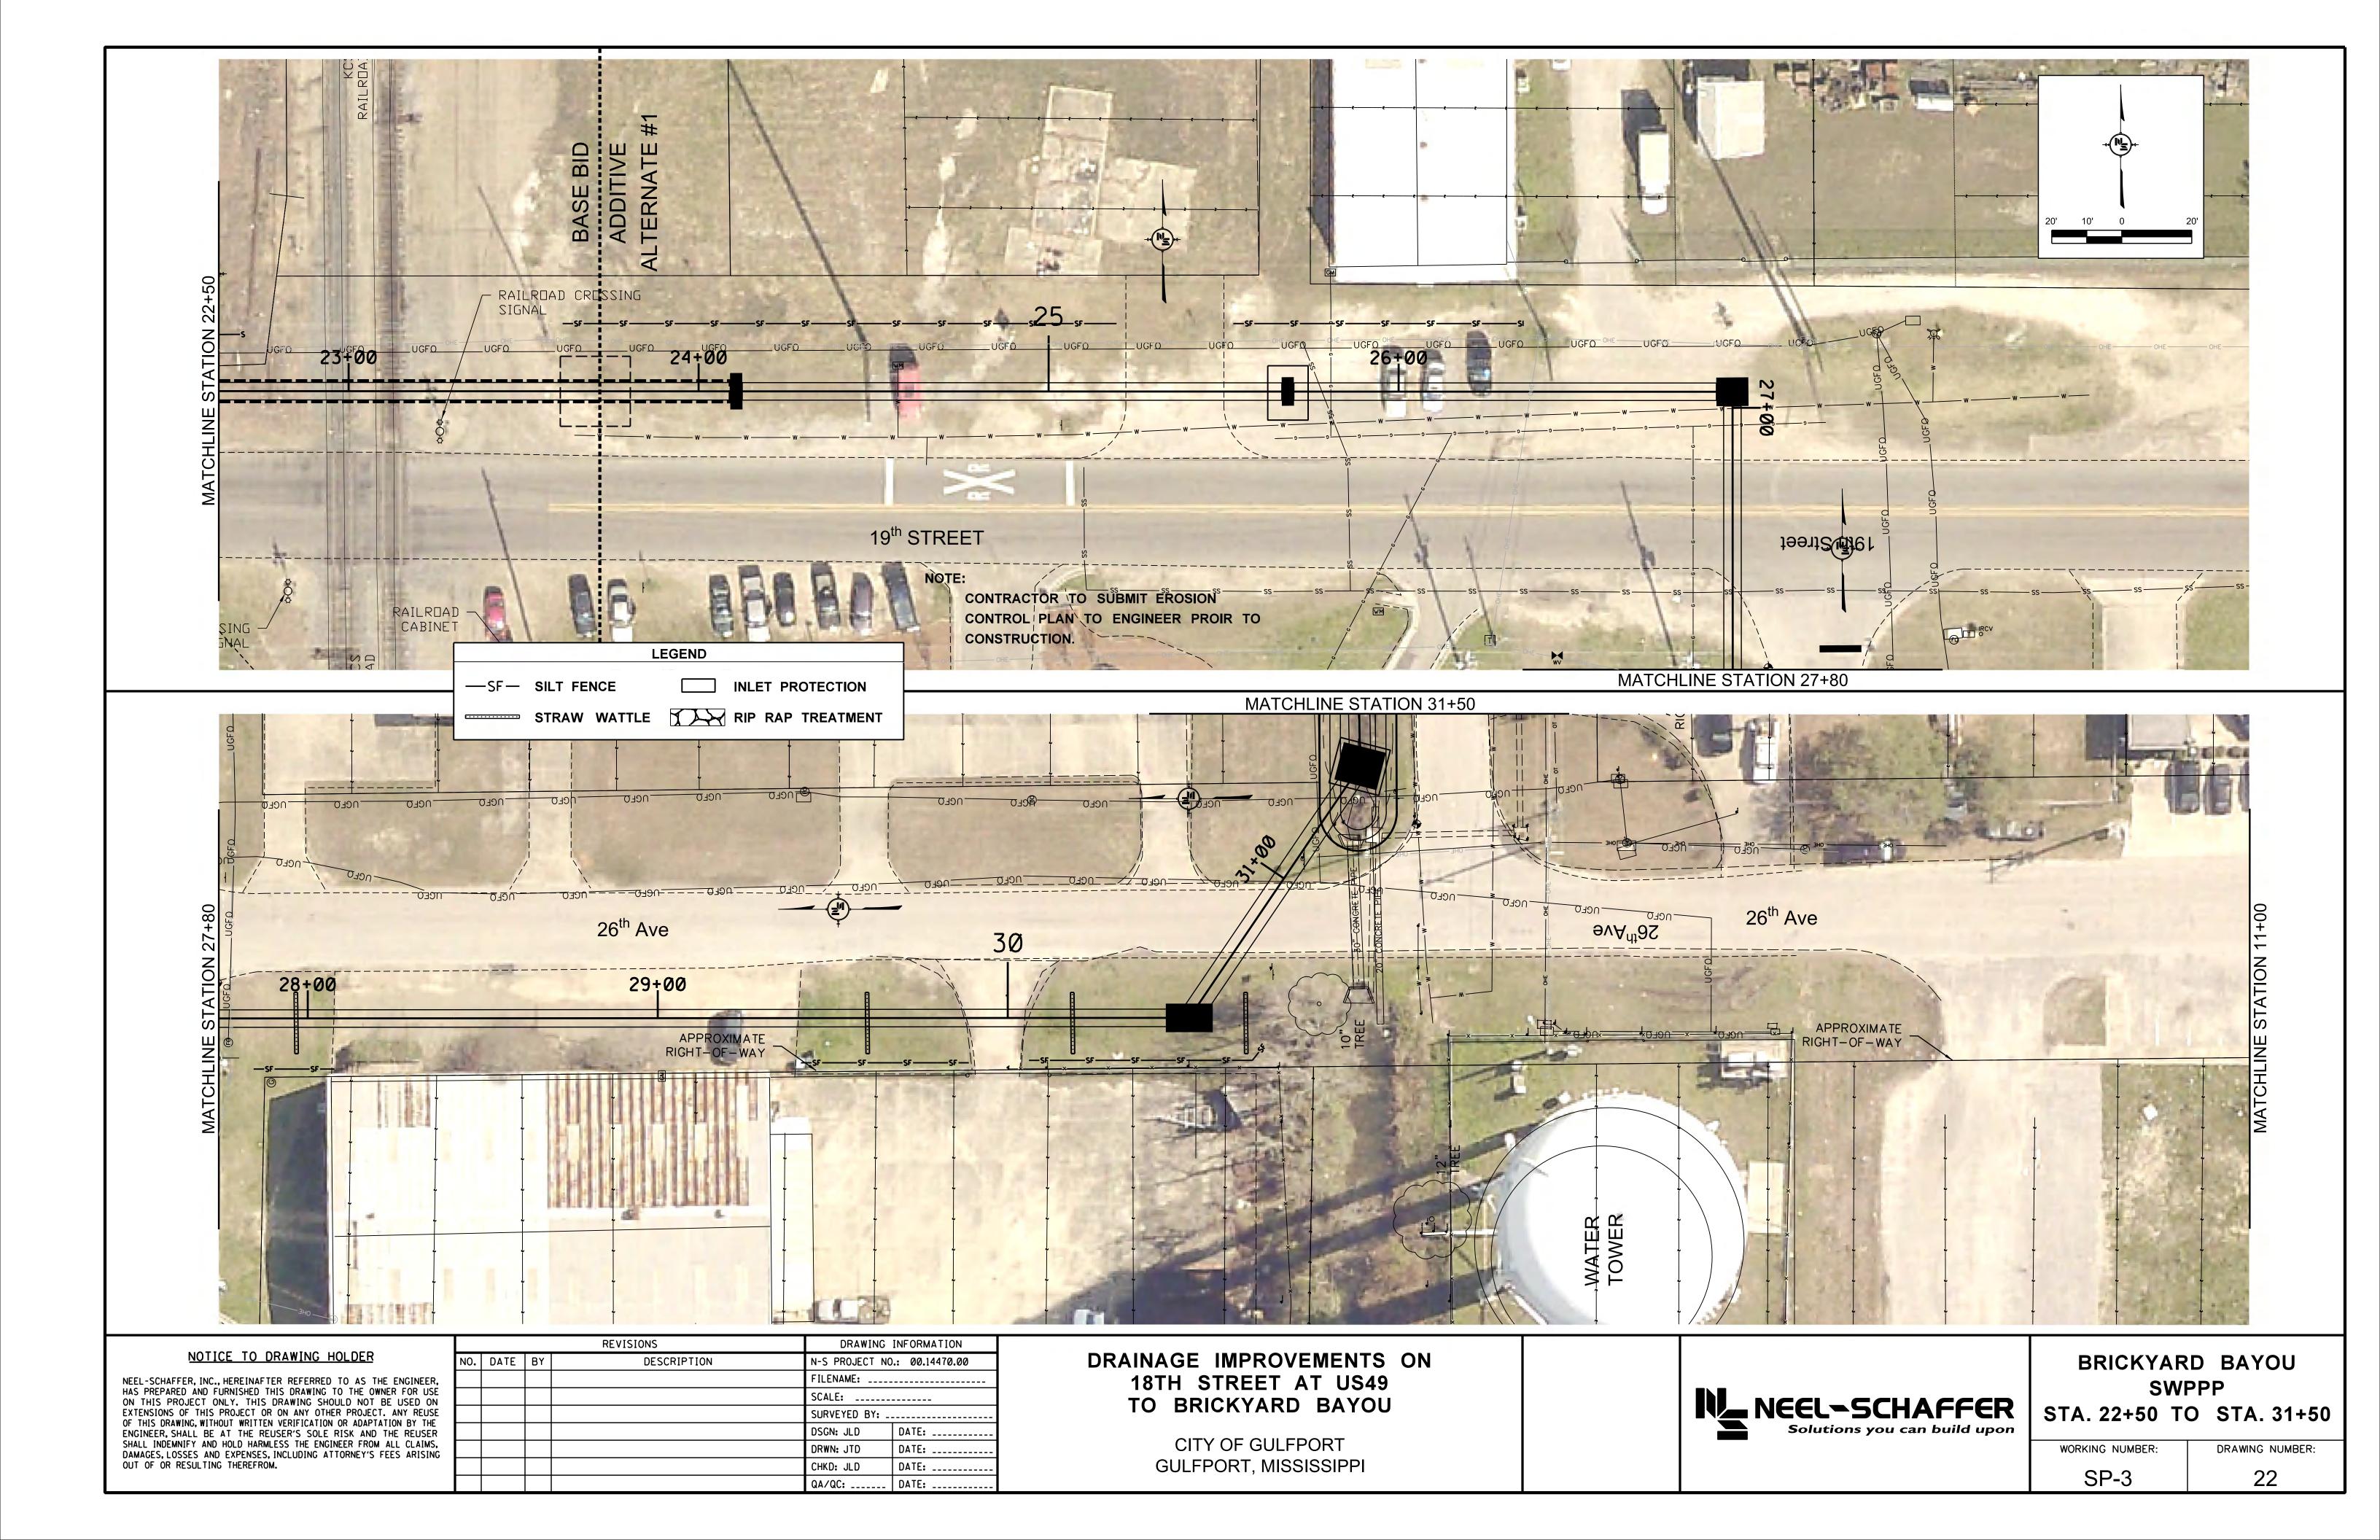

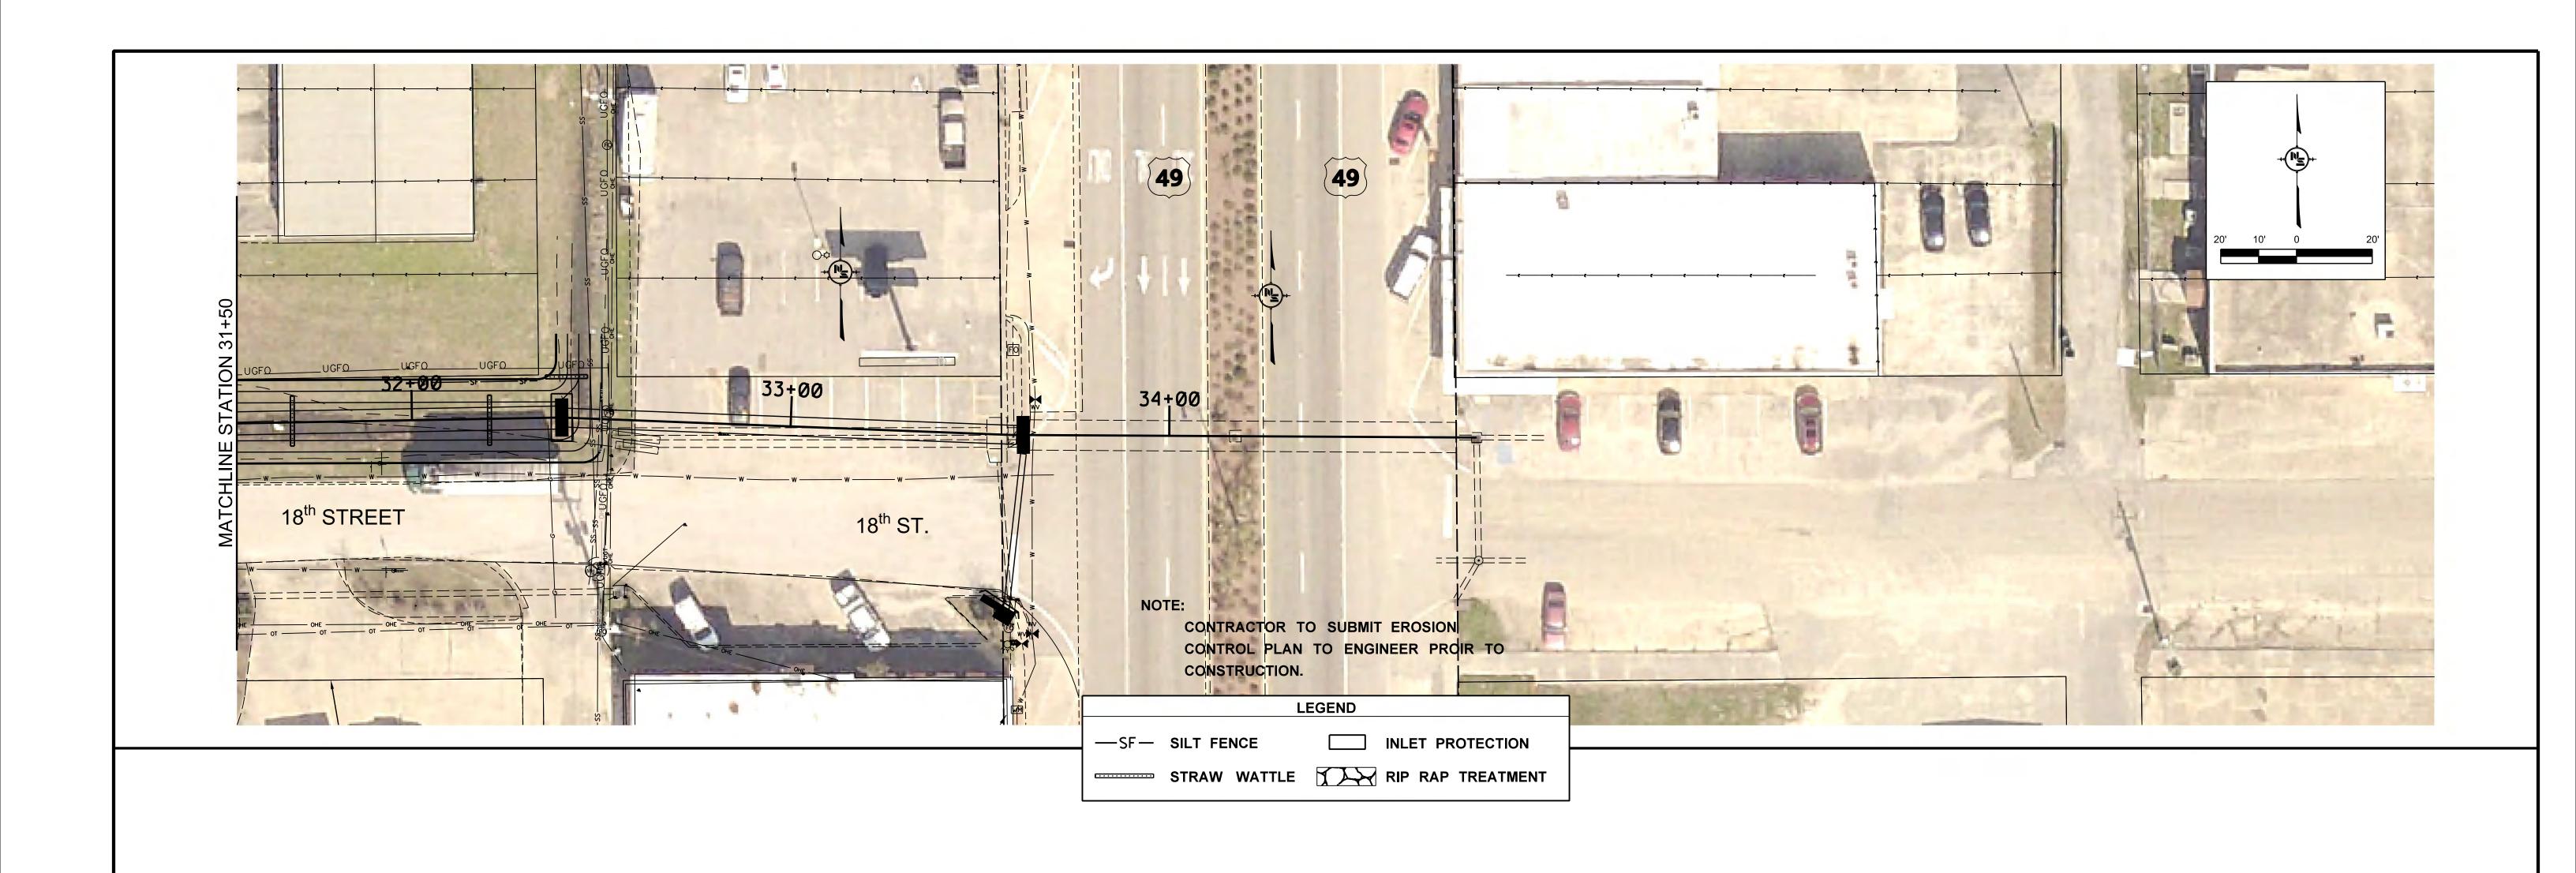

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DRAINAGE IMPROVEMENTS ON 18TH STREET AT US49 TO BRICKYARD BAYOU


CITY OF GULFPORT GULFPORT, MISSISSIPPI



BRICKYARD BAYOU SWPPP STA. 31+50 TO E.O.P.

working number: Drawing number: SP-4 23

PRECAST DRAINAGE STRUCTURE NOT TO SCALE

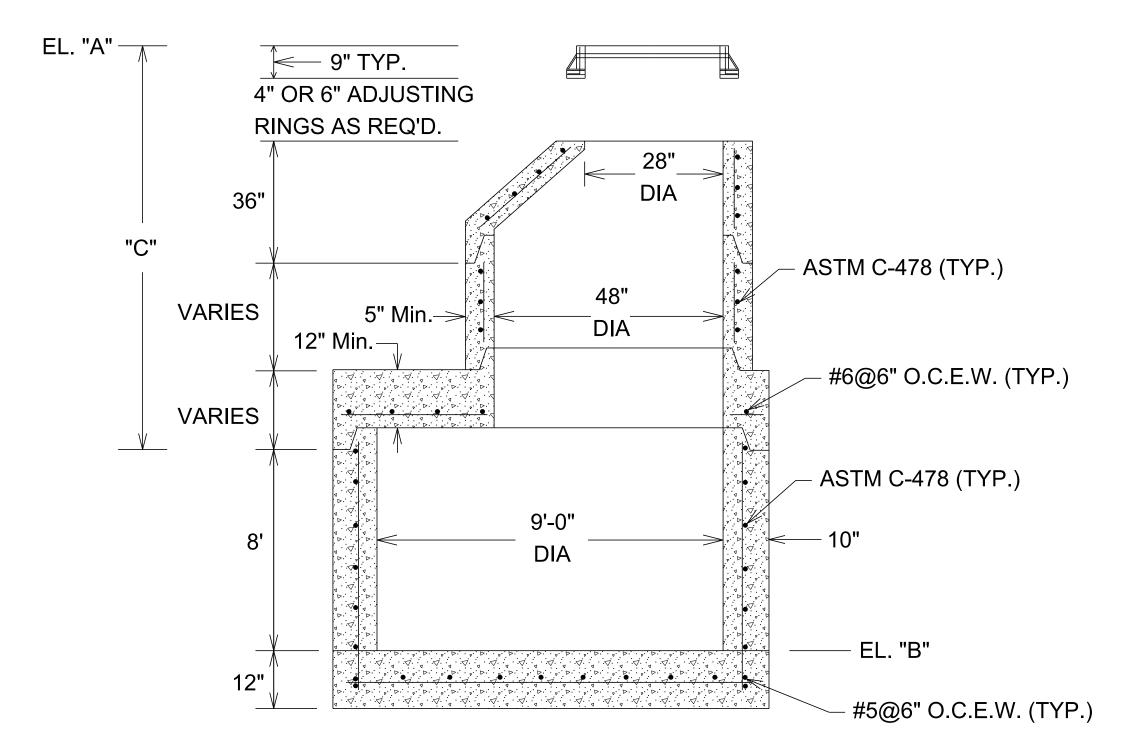


* CONCRETE: 4,000 PSI WALL REINFORCING PER ASTM C-478 STANDARD

JB#	"A"	"B"	"C"
DN-3	26.95	7.26	11.69
DN-4	30.87	8.5	14.37
DN-5	30.87	9.75	13.12
DN-7	28.0	11.29	8.71
DN-8	27.0	11.77	7.23
DN-9	26.84	12.16	6.68
	DN-3 DN-4 DN-5 DN-7 DN-8	DN-3 26.95 DN-4 30.87 DN-5 30.87 DN-7 28.0 DN-8 27.0	DN-3 26.95 7.26 DN-4 30.87 8.5 DN-5 30.87 9.75 DN-7 28.0 11.29 DN-8 27.0 11.77

ALL ELEVATIONS TO BE VERIFIED PRIOR TO CONSTRUCTION

PRECAST DRAINAGE STRUCTURE NOT TO SCALE

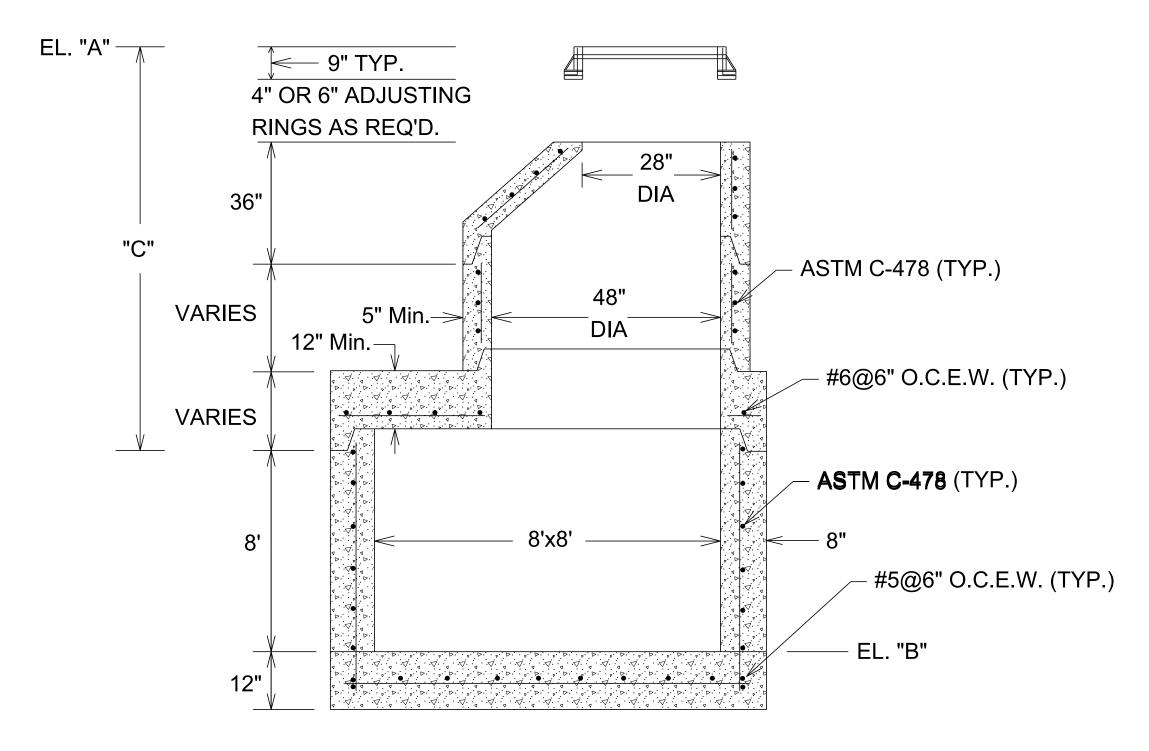

* CONCRETE: 4,000 PSI WALL REINFORCING PER ASTM C-478 STANDARD

JB#	"A"	"B"	"C"
DN-6	27.40	11.12	8.28
DN-10	24.98	12.48	4.5

ALL ELEVATIONS TO BE VERIFIED PRIOR TO CONSTRUCTION

NOTES:

VERIFY DIMENSIONS PRIOR TO ORDERING.
BOXES SHALL CONFORM TO ASTM C-478
O.C.E.W. - ON CENTER EACH WAY.
ANY MODIFICATIONS TO THE BOX DESIGN
SHALL BE SUBMITTED TO THE ENGINEER

FOR APPROVAL.

NOTICE TO DRAWING HOLDER

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;					DRWN: JTD	DATE:
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	·				QA/QC: DLS	DATE:

DRAINAGE IMPROVEMENTS ON 18TH STREET AT US49 TO BRICKYARD BAYOU


CITY OF GULFPORT GULFPORT, MISSISSIPPI



PRECAST BOX **DETAIL**

WORKING NUMBER: DRAWING NUMBER: DET-1

24

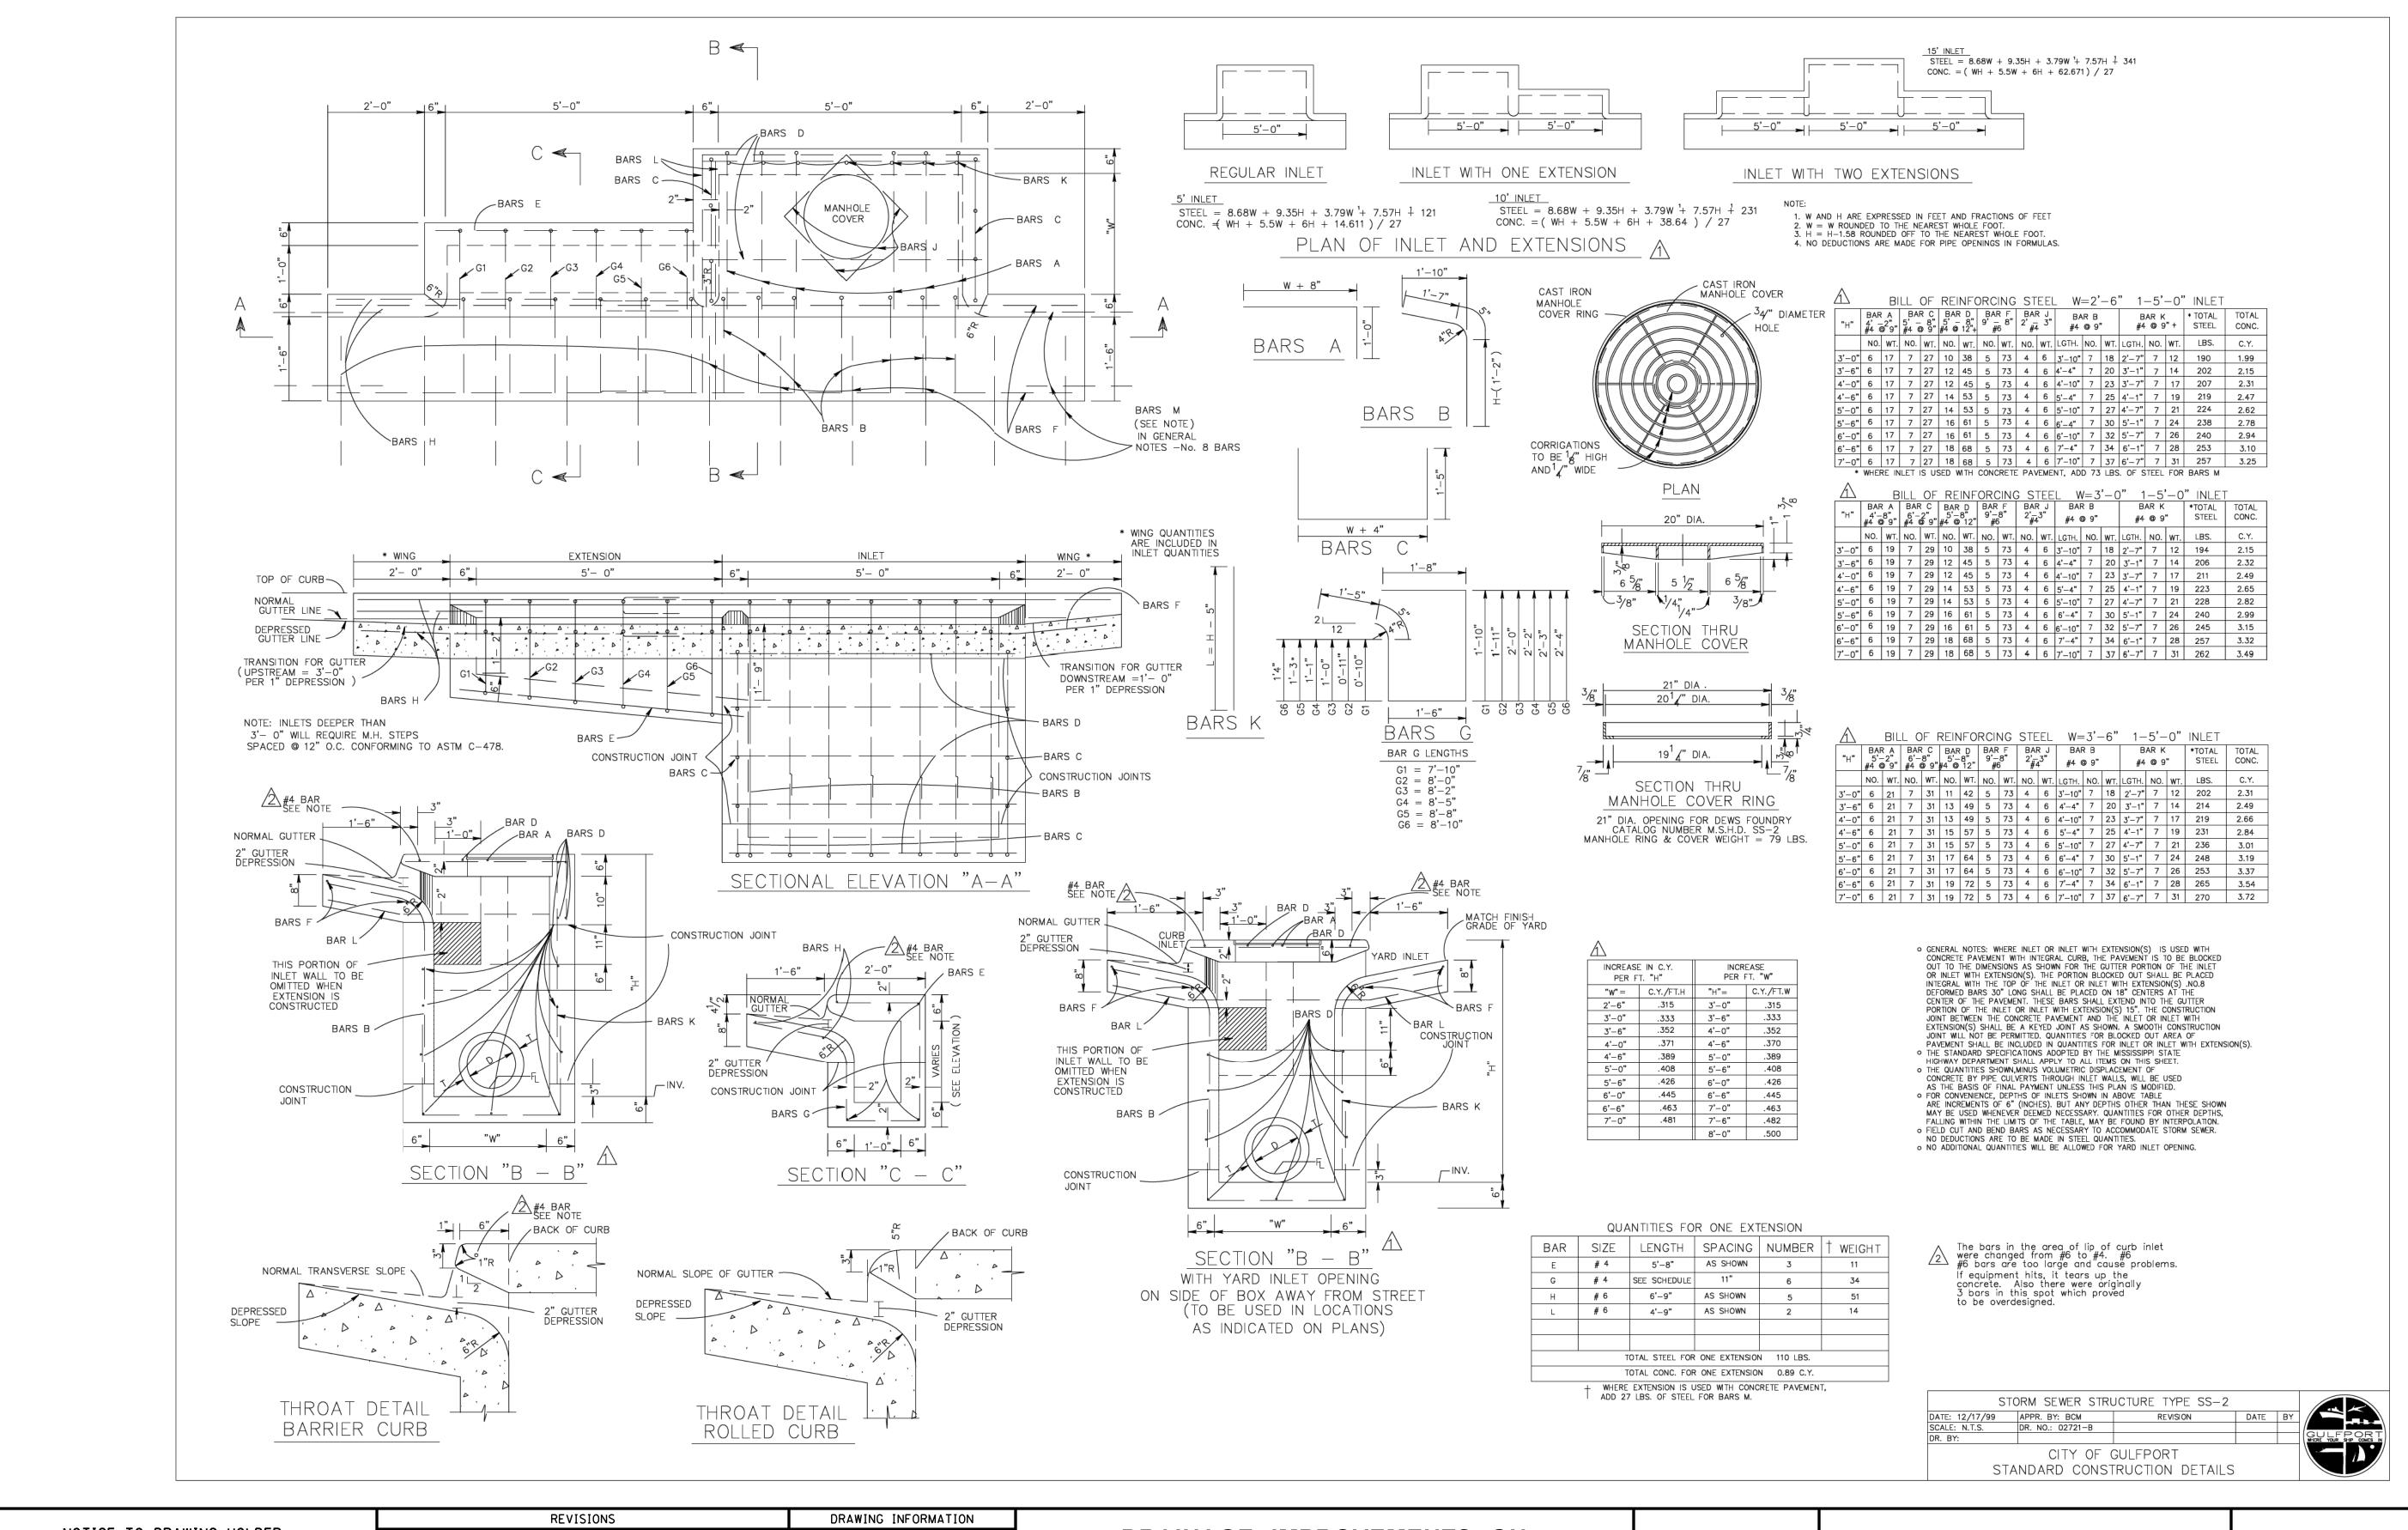

NEEL-SCHAFFER, INC., HEREINAFTER REFERRED TO AS THE ENGINEER, HAS PREPARED AND FURNISHED THIS DRAWING TO THE OWNER FOR USE ON THIS PROJECT ONLY. THIS DRAWING SHOULD NOT BE USED ON EXTENSIONS OF THIS PROJECT OR ON ANY OTHER PROJECT. ANY REUSE OF THIS DRAWING, WITHOUT WRITTEN VERIFICATION OR ADAPTATION BY THE ENGINEER, SHALL BE AT THE REUSER'S SOLE RISK AND THE REUSER SHALL INDEMNIFY AND HOLD HARMLESS THE ENGINEER FROM ALL CLAIMS, DAMAGES, LOSSES AND EXPENSES, INCLUDING ATTORNEY'S FEES ARISING OUT OF OR RESULTING THEREFROM.

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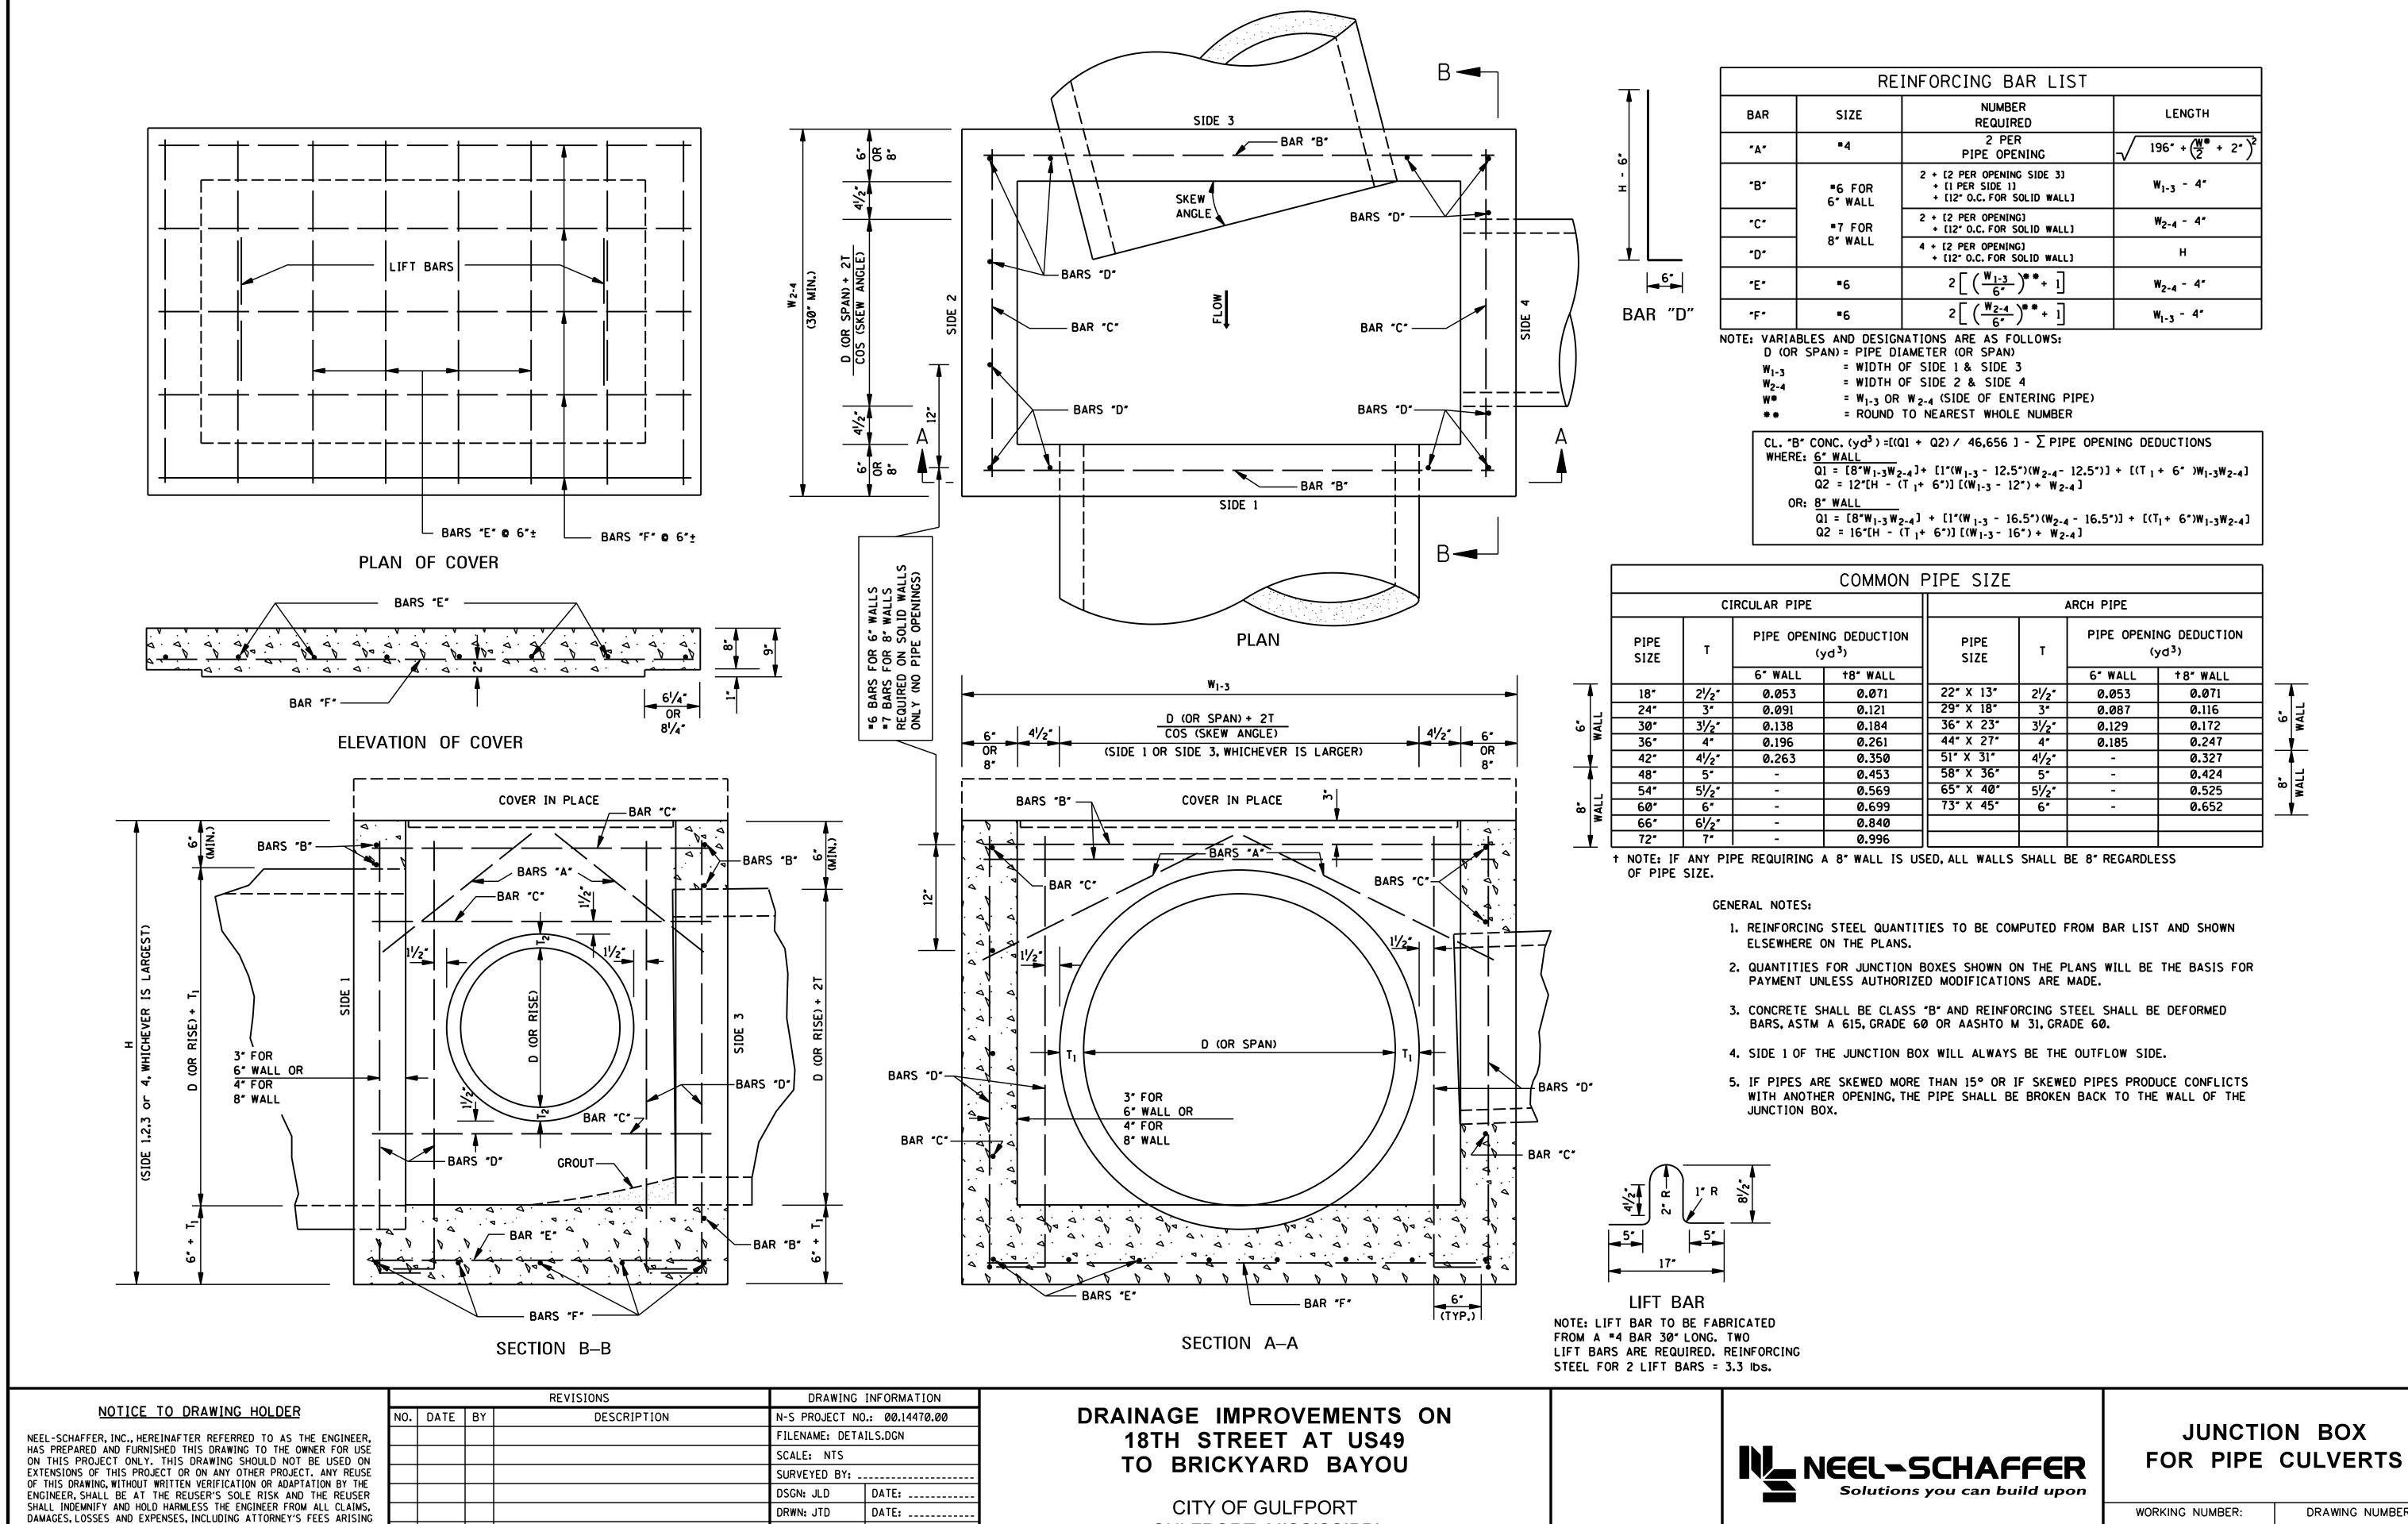
DRAINAGE IMPROVEMENTS ON 18TH STREET AT US49 TO BRICKYARD BAYOU

CITY OF GULFPORT GULFPORT, MISSISSIPPI



DRAINAGE DETAILS

WORKING NUMBER:	DRAWING NUMBER:
DFT-2	25



GULFPORT, MISSISSIPPI

CHKD: JLD

QA/QC: DLS

DATE: _____


DATE: ___

OUT OF OR RESULTING THEREFROM.

DET-3


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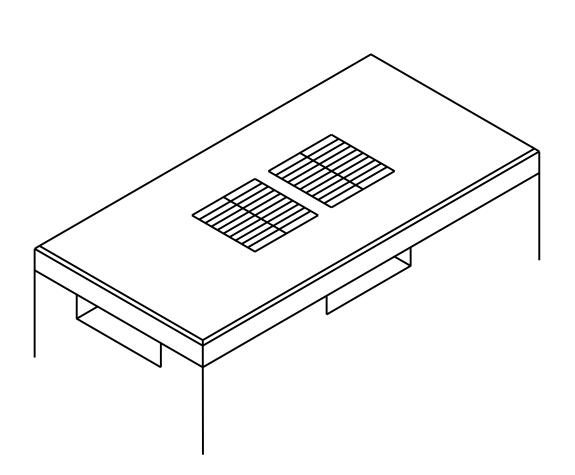
DET-3

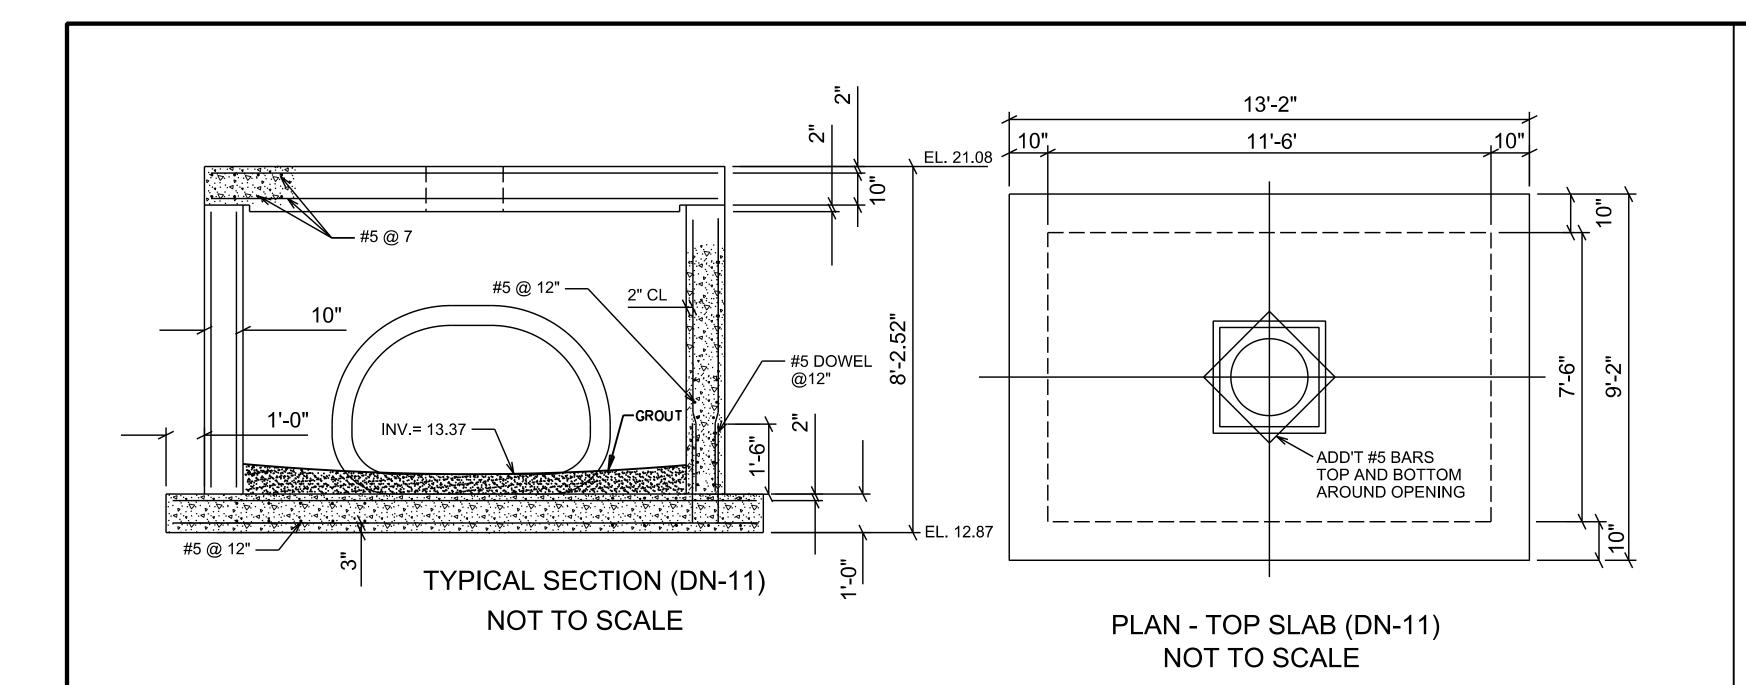


NOTE:

ALL REBAR AND HATCHING NOT SHOWN FOR CLARITY.




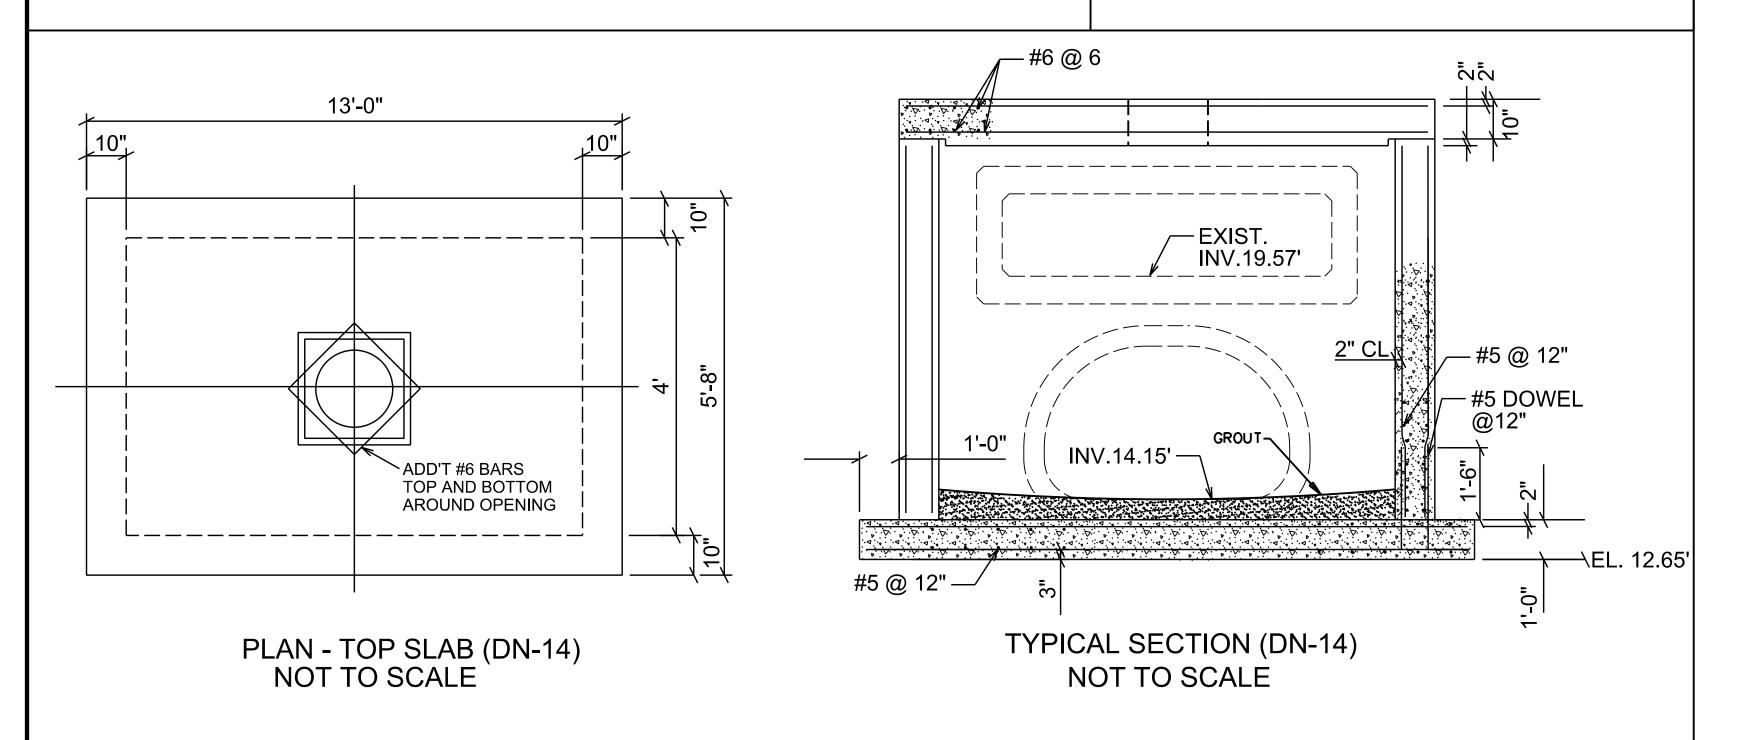

ISOMETRIC (DN-12 & DN-13) NOT TO SCALE

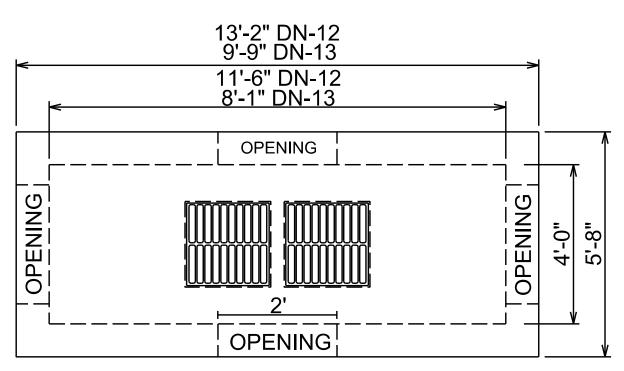

PLAN - TOP SLAB (DN-12 & DN-13) NOT TO SCALE

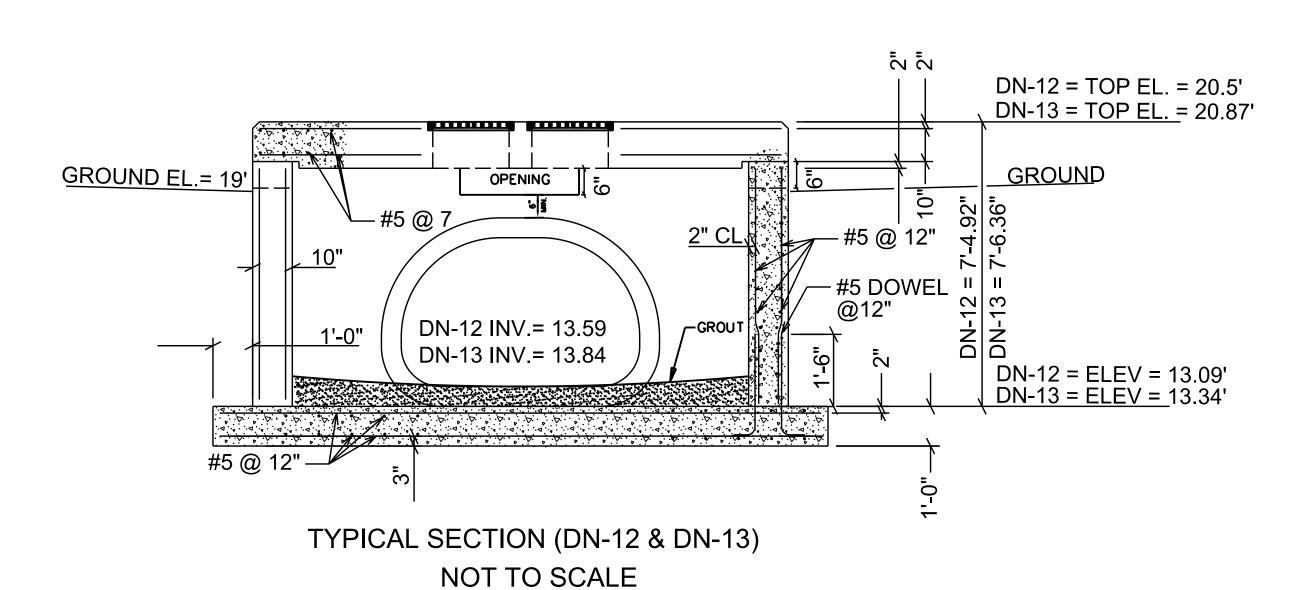

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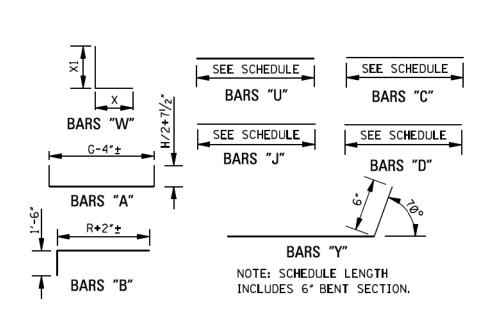
DRAINAGE IMPROVEMENTS ON 18TH STREET AT US49 TO BRICKYARD BAYOU

> CITY OF GULFPORT GULFPORT, MISSISSIPPI



JUNCTION BOX DETAILS

working number: DRAWING NUMBER: 27




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PIPE	TUK							U			W1				W2	2				W3				W4				W5	ı			W6				1	W 7			W8			Y1	Y2	2	Y3	Y4						
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54	51/2	8 6	$-3\frac{1}{2}$ 1	11-0 11-	-5 % 11-8/	/2 9	2-1	11-5	4	# 5	3-9	5-7	9-4	6 *	4 3-	3 4-	7 7-10	i 8	#4	2-6 3	-7 6	-1 8	#4	1-11	2-7	4-6																	2 2-10	Ø 2 5	-11 2	9-11	+ 12-9						
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72	7	8 8	8-2 1	4-9 15	-4/ ₁₆ 15-8	3⁄ ₈ 1−Ø	2-9	15-4	4	#6	5-2	7-10 1	.3-Ø	6 •	5 4-	7 6-	10 11-5	8	#4	3-11 5-	-1Ø 9	-9 6	#4	3-3	4-10	8-1	6	#4 2-5	3-10	6-3	2 #4	2-5	3-5	5-10									2 3-1	1 2 6	5-1 2	10-1 7	2 13-1	2 16-1	1 4	17-Ø			
84	8	8 9	9-4 1	.6-9 17	-5 % 17-9	√ ₈ 1-Ø	3-2	17-7	2	#8	5-9	8-11 1	4-8	6	7 5-	6 7-	11 13-5	8	#6	4-10 6	-11 11	- 9 6	#5	4-1	5-11 1	10-0	6	# 4 3-6	4-11	8-5	8 #4	2-10	3-11	6-9									2 3-0	0 2 6	5-3 2	9-4 2	2 12-8	2 15-1/	Ø 6	18-8			
96	9	8 1	0-5 1	.9-3 20	-01/16 20-5	7 ⁄ ₈ 1−4	3-6	1 20-3	4	#7	6-3	10-2 1	6-5	6	7 6-	3 9-	2 15-5	8	#6	5-8 8	- 2 13	-10 6	#4	5-0	7-2 1	12-2	4	# 4 4-4	6-2	10-6	6 # 4	3-8	5-2	8-10	4	# 4 2	-10 4-6	7-4					2 3-0	0 2 6	5-Ø 2	10-0 2	2 13-Ø	2 15-F	<i>i</i> 2	19-3 F	ô 21 - 8		
1Ø8	10	8 1	11-7 2	21-4 22	-21/ ₁₆ 22-81	/2 1-4	4-0	22-5	6	#7	7-0	11-4 1	.8-4	8	7 7-	Ø 10·	-4 17-4	6	#7	6-5 9	-4 15	-9 6	#6	5-9	8-4	14-1	6	# 5 5-1	7-4	12-5	6 # 5	4-5	6-4	10-9	4	# 4 3	5-4	9-1	4 :	* 4 3-8	5-1	8-9	2 3-5	5 2 6		9-5 2	2 12-5	2 16-2	2 2 1	19-11 7	2 22-5	8 23-9	j


BAR BENDING DETAILS

NOTE: WHENEVER THE COMPUTED LENGTH OF BAR EXCEEDS 30', THE SCHEDULED LENGTH INCLUDES A 12" LAP. ALL BARS ARE #4 EXCEPT BARS "W". SEE SCHEDULE FOR SIZE OF BARS "W".


GENERAL NOTES:

- 1. ALL CONCRETE SHALL BE CLASS "B".
- 2. ALL EXPOSED EDGES SHALL BE CHAMFERED 3/4".
- 3. EXPOSED CONCRETE SURFACES SHALL BE FINISHED IN ACCORDANCE WITH THE APPLICABLE SECTION OF THE MDOT SPECIFICATIONS.
- 4. ALL LENGTHS AND QUANTITIES IN THE TABLES HEREON ARE BASED ON CONCRETE PIPE.
- 5. QUANTITIES SHOWN SHALL BE THE BASIS FOR FINAL PAYMENT UNLESS AUTHORIZED
- MODIFICATIONS ARE MADE.

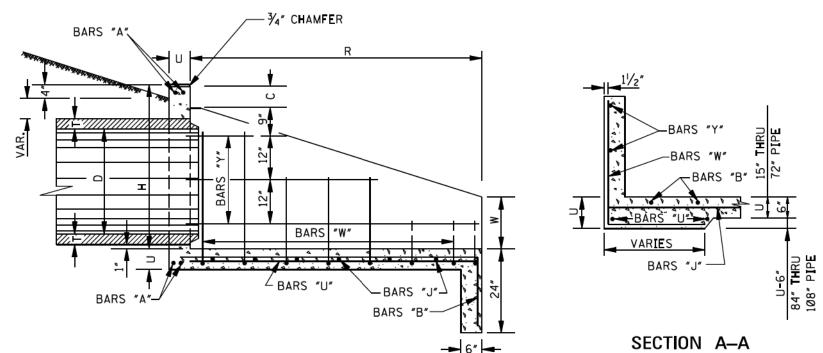

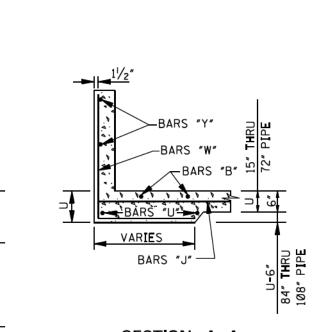

SECTION	R_R
SECTION	D-D

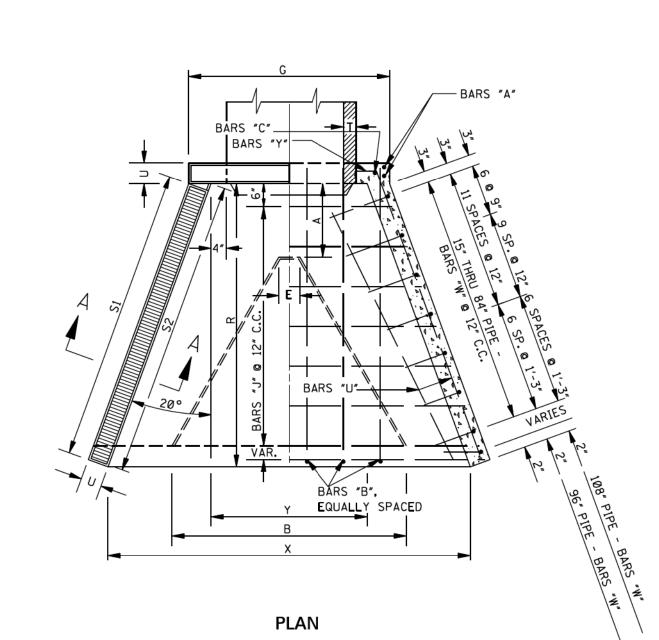



															D.T. (NICTONIC	AND DEE	FOROTHO	EOD EL	DED HEAD		D CTNOI	E 1 THE 5	TDE OUT	VEDE												OTV
	PIPE DIMENSIONS														PAY																						
DIDE	PIPE DIA A B E G X Y O LGTH O														_																						
			l _		l ., l	.,		Α		В	(;	D	J1	J2	J3	J4	J5	J6	J7	J8	J9	J1Ø	J11	J12	J13	J14	J15	J16	J17	J18	J19	J2Ø	J21	J22	CONC	STEEL
DIA	A	В	E	G	X	Y	Z	N LGTH	NO	LGTH	ZO L	GTH C	LGTH	N LGTH	N LGTH	LGTH	N LGTH	N LGTH	N LGTH	LGTH 0	LGTH	LGTH	N O LGTH	N LGTH	N LGTH	N LGTH	NO LGTH	LGTH	LGTH	N LGTH	LGTH	N LGTH	N LGTH	N LGTH	LGTH	CU YDS	S LBS
18	-	-	-	3-11	5-91/4	2-6	_	4 7-7	5	6-4	2	3-2 2	2-0	1 3-9	1 4-6	1 5-2	1 5-11	1 6-6																			111
24	-	-	-	4-6	7-31/4	3-1	_	4 8-9	5	7-7	2	3-9 2	2-3	1 4-3	1 5-0	1 5-8	1 6-5	1 7-2	1 7-11																	2.01	142
3Ø	-	-	-	5-11/2	8-71/2	3-81/2	-	4 10-0	6	8-7	2	4-4 2	2-6	1 5-1	1 5-9	1 6-6	1 7-2	1 7-11	1 8-7	1 9-4																2.69	188
36	_	_	-	5-8	9-113/4	4-3	_	4 11-1	7	9-8	2 4	4-11 2	2-9	1 5-6	1 6-3	1 7-0	1 7-8	1 8-5	1 9-2	1 9-10 1	10-7	10-8														3.47	237
42	-	_	-	6-3	$11-3\frac{1}{2}$	4-10	_	4 12-3	7	10-8	2	5-6 2	3 - Ø	1 6-1	1 6-10	1 7-6	1 8-3	1 9-0	1 9-8	1 10-5 1	11-2	11-11	1 12-0													4.33	290
48	_	-	-	6-10	12-81/4	5-5	_	4 13-5	8	11-10	2	6-1 2	3-3	1 6-8	1 7-4	1 8-1	1 8-10	1 9-7	1 10-3	1 11-0 1	11-9	12-6	1 13-2	1 13-4												5.33	369
54	-	-	-	7-81/8	14-11/8	6-1	_	4 14-10	8 (12-11	2	6-9 2	3-6	1 7-6	1 8-2	1 8-11	1 9-8	1 10-5	1 11-1	1 11-10 1			1 14-0	1 14-9	1 14-11											7.23	430
6Ø	-	-	-	8-31/8	15-7	6-8	_	4 16-0	9	14-2	2	7-4 2	3-9	1 8-Ø	1 8-9	1 9-6	1 10-3	1 11-Ø	1 11-8	1 12-5 1	13-2	13-11	1 14-8	1 15-4	1 16-1	1 16-6										8.68	549
66	-	-	-	9-4%	17-3 ¹ / ₈	7-3	_	4 17-11	. 9	15 - 11		8-3 2	4-3	1 9-3	1 9-11	1 10-8	1 11-4	1 12-1	1 12-10	1 13-7 1	14-4	15-1	1 15-9	1 16-6	1 17-3	1 17-11	1 18-8									14.39	647
72	-	_	-	9-11%	18-6 1/8	7-10	_	4 19-1	10	16-10	2 8	3-11 2		1 9-8	1 10-5	1 11-2	1 11-11	1 12-8	1 13-5	1 14-2 1	14-10	15-7	1 16-4	1 17-1	1 17-10	1 18-6	1 19-3	1 20-0								16.46	749
84	3-6	15-9	2-0	11-1%	21-23/8	9 - Ø	_	4 21-5	11	18-9			5-3	1 10-11	1 11-7	1 12-4	1 13-1	1 13-9	1 14-6	1 15-2 1			1 17-4	1 18-1	1 18-10		1 20-4	1 21-1	1 21-9	1 22-6							
96	4-0	18-Ø	2-0	13-Ø1/16	24-21/8	10-2	_	4 24-4		21-7		1-5 2	5-9	1 13-Ø		1 14-6	1 15-2	1 15-11	1 16-8					1 20-3			1 22-6			1 24-8			1 26-7			31.94	1379
108	4-6	20-3	2-0	14-21/16	26-103/8	11-4	_	4 26-8	14	23-7	2 1	2-7 2	6-4	1 14-2	1 14-11	1 15-7	1 16-4	1 17-1	1 17-10	1 18-6 1	19-3	20-0	1 20-8	1 21-5	1 22-2	1 22-11	1 23-7	1 24-4	1 25-1	1 25-10	1 26-6	1 27-3	1 28-0	1 28-8	1 29-3	38.88	1966


														DIM	ENSIONS	AND REI	vForcIng	FOR FLA	RED HEAD	WALL FO	R DOUBLE	LINE P	IPE CULV	/ERT											PAY (QTY
D.T.D.E.			D	IMENSION	NS															R	INFORCIN	G STEEL													1-HEAD	WALL
PIPE		_						Α	В		С	D	J1	J2	J3	J4	J5	J6	J7	J8	J9	J1Ø	J11	J12	J13	J14	J15	J16	J17	J18	J19	J2Ø	J21	J22	CONC	STEEL
DIA	Α	В	E	G	X	Y	Z	N LGTH	NO L	GTH	LGTH	N LGTH	N LGTH	N LGTH	N LGTH	N LGTH	N LGTH	N LGTH	LGTH C	LGTH	LGTH C	LGTH C	LGTH C	LGTH 0	LGTH	LGTH C	LGTH	N LGTH	LGTH	LGTH	N LGTH	LGTH	N LGTH	N LGTH	JU YDS	LBS
18	-	-	-	6-10	8-71/4	5-4	1-0	4 10-5	8	6-4	3 3-2	4 2-0	1 6-7	1 7-4	1 8-Ø	1 8-9	1 9-4																		1.95	145
24	-	-	-	7-11	10-81/4	6-6	1-0	4 12-2	9	7-7	3 3-9	4 2-3	1 7-8	1 8-5	1 9-1	1 9-10	1 10-7	1 11-4																	2.80	190
3Ø	-	-	-	9-5	12-11	8-0	1-3	4 14-3	10	8-7	4 4-4	4 2-6	1 9-4	1 10-0	1 10-9	1 11-5	1 12-2	1 12-10	1 13-7																3.82	251
36	-	-	-	10-9	15-03/4	9-4	1-6	4 16-2	12	9-8	4 4-11	4 2-9	1 10-7	1 11-4	1 12-1	1 12-9	1 13-6	1 14-3	1 14-11 1	15-8	1 15-9														4.97	324
42	_	-	-	12-2	$17-2\frac{1}{2}$	10-9	1-9	4 18-2	13 1	10-8	4 5-6	4 3-0	1 12-0	1 12-9	1 13-5	1 14-2	1 14-11	1 15-7	1 16-4 1	17-1	1 17-10 1	17-11													6.26	399
48	_	-	-	13-7	19-51/4	12 - 2	2-0	4 20-2	15 1	1-10	4 6-1	4 3-3	1 13-5	1 14-1	1 14-10	1 15-7	1 16-4	1 17-Ø	1 17-9 1	18-6	1 19-3 1	19-11 1	20-1												7.78	5Ø4
54	-	-	-	15-41/8	21-91/8	13-9	2-3	4 22-6	16 1	2-11	5 6-9	4 3-6	1 15-2	1 15-10	1 16-7	1 17-4	1 18-1	1 18-9	1 19-6 1	20-3	1 21-0 1	21-8 1	22-5 1	l 22-7											10.61	600
6Ø	-	-	-	16-91/8	24-1	15 - 2	2-6	4 24-6	17 1	14-2	5 7-4	4 3-9	1 16-6	1 17-3	1 18-0			1 20-2	1 20-11 1	21-8	1 22-5 1	23-2 1	23-10 1	l 24-7 1	25-0										12.78	741
66	_	-	-	18-8%	26 - 71/8	16-7	2-9	4 27-3	18 1	.5-11	5 8-3	4 4-3	1 18-7	1 19-3	1 20-0				1 22-11 1	23-8	1 24-5 1	25-2 1	25-10 1	l 26-7 1	27-3	l 28-Ø									21.02	877
72	-	-	-	20-1%	28-87/8	18-Ø	3-Ø	4 29-3	20 1	6-10	5 8-11		1 19-10		1 21-4		1 22-10		1 24-4 1	25-Ø	1 25-9 1	26-6 1	27-3 1	l 28-Ø 1	28-8	1 29-5 1	31-2								24.16	1Ø15
84	3-0	27-7		ð 22 - 11%		20-10	3-6			18-9	6 10-0	4 5-3	1 22-9	1 23-5		1 24-11		1 26-4	1 27-0 1	27-9	1 28-6 1		29-11 1	1 31-8 1	32-5	1 33-2 1	33-11	1 34-7 1	1 35-4						26.00	1463
96	3-0	31-6	15-6	26-61/16	37-81/8	23-8		4 38-10		21-7	7 11-5	4 5-9	1 26-6	1 27-3	1 27-11	1 28-8	1 29-5	1 31-2	1 31-10 1	32-7	1 33-4 1	34-0 1	34-9 1		36-3	1 36-11 1	37-8	1 38-5 1	1 39-2	1 39-10	1 40-7	1 41-3			42.40	1855
108	3-Ø	35-5	17-2	29-41/16	42-03/8	26-6	4-6	4 42-10	29 2	23-7	7 12-7	4 6-4	1 29-4	1 31-1	1 31-9	1 32-6	1 33-3	1 34-0	1 34-8 1	35-5	1 36-2 1	36-10 1	37-7 1	1 38-4 1	39-1	1 39-9 1	40-6	1 41-3 1	1 42-Ø	1 42-8	1 43-5	1 44-1	1 44-11	1 45-5	55.62	2532

DIMENSIONS AND REINFORCING FOR FLARED HEADWALL FOR TRIPLE LINE PIPE CULVERT														PAY QTY																					
DIDE			D	IMENSION	S															RE	INFORCI	NG STEEL													1-HEADWALL
PIPE		_					Τ_	Α		В	С	D	J1	J2	J3	J4	J5	J6	J7	J8	J9	J1Ø	J11	J12	J13	J14	J15	J16	J17	J18	J19	J2Ø	J21	J22	CONC STEEL
DIA	A	В	E	G	×	Y	Z	N LGTH	OZ	LGTH	N LGTH	N LGTH	N LGTH	N LGTH	NO LGTH	N LGTH	N LGTH	N LGTH	N LGTH	LGTH C	LGTH	N LGTH	N LGTH	LGTH	LGTH	N O LGTH	LGTH C	LGTH	N C LGTH	N LGTH	LGTH	LGTH	N LGTH	0 LGTH	CU YDS LBS
18	_	_	-	9-7	11 - 5 ¹ / ₄	8-2	1-0	4 13-3	11	6-4	4 3-2	6 2-0	1 9-5	1 10-2	1 10-10	1 11-7	1 12-2																		2.49 180
24	_	_	-	11-4	14-11/4	9-11	1-0	4 15-7	13	7-7	4 3-9	6 2-3	1 11-1	1 11-10	1 12-6	1 13-3	1 14-0	1 14-9																	3.59 239
3Ø	-	-	-	13-81/2	17-21/2	12-31/2	1-3	4 18-7	14	8-7	6 4-4	6 2-6	1 13-7	1 14-3	1 15-0	1 15-8	1 16-5	1 17-1	1 17-10																4.95 314
36	_	_	-	15-10	20-13/4	14-5	1-6	4 21-3	17	9-8	6 4-11	6 2-9	1 15-8	1 16-5		1 17-10			1 20-0 1																6.48 411
42	_	_	-	18-1	23-11/2	16-8	1-9	4 24-1	19	10-8	6 5-6		1 17-11	1 18-8					1 22-3 1																8.20 509
48	_	_	-	20-4	26-21/4	18-11	2-0	4 26-11	1 22	11-10	6 6-1	6 3-3	1 20-2	1 20-10	1 21-7	1 22-4	1 23-1	1 23-9	1 24-6 1	25-3	1 26-0	1 26-8	1 26-10												10.22 640
54	_	_	-	23-01/8	29 - 51/8	21-5	2-3	4 30-2	24	12-11	8 6-9	6 3-6	1 22-10	1 23-6	1 24-3				1 27-2 1		1 28-8	1 29-4	1 31-1 1	1 31-3											13.99 770
60	-	-	-	25-31/8	32 - 7	23-8	2-6	4 34-0	25	14-2	8 7-4	6 3-9	1 25-0	1 25-9	1 26-6	1 27-3			1 29-5 1				1 33-4 1		1 34-6										16.89 939
66	-	_	-	28-0%	35-111/8	25-11	2-9	4 37-7		15-11	8 8-3	6 4-3	1 27-11		1 29-4	1 31-0			1 33-3 1						1 37-7	1 38-4									27.43 1117
72	_	_	-	30-3%	38-10%	28-2	3-0	4 40-5	30	16-10	8 8-11	6 4-7	1 31-Ø	1 31-9	1 32-6	1 33-3	1 34-0	1 34-9	1 35-6 1	36-2	1 36-11	1 37-8	1 38-5 1	1 39-2	1 39-10	1 40-7	1 41-4								31.86 1292
84	3 - Ø	39-5	25-8	34-9%	44-103/8	32-8	3-6	4 46-1	35	18-9	10 10-1	6 5-3	1 35-7	1 36-3	1 37-0	1 37-9	1 38-5	1 39-2	1 39-10 1	40-7	1 41-4	1 42-0	1 42-9 1	1 43-6	1 44-3	1 45-0	1 45-9 1	1 46-5	1 47-2						33.16 1820
96	3-0	45-0	29-0	40-01/16	51-21/8	37-2	4-0	4 52-4	39	21-7	12 11-5	6 5-9	1 41-0	1 41-9	1 42-5	1 43-2	1 43-11		1 45-4 1						1 49-9	1 50-5	1 51-2 1	1 51-11	1 52-8	1 53-4	1 54-1	1 54-6			53.17 2308
108	3-0	50-7	7 32-4	44-61/16	57-23/8	41-8	4-6	4 58-0	44	23-7	12 12-7	6 6-4	1 45-6	1 46-3	1 46-11	1 47-8	1 48-5	1 49-1	1 49-10 1	50-7	1 51-4	1 52-1	1 52-9 1	1 53-6	1 54-3	1 55-0	1 55-8 1	1 56-5	1 57-1	1 57-10	1 58-7	1 59-4	1 61-1	1 61-7	64.52 3085

DIMENSIONS AND REINFORCING FOR FLARED HEADWALL FOR QUADRUPLE LINE PIPE CULVERT													PAY QTY																								
DIDE			D	IMENSION	٧S																		1-HEADWALL														
PIPE		_		_			_	Α		В		С	D	J1	J2	J3	J4	J	15	J6	J7	J8	J9	J1Ø	J11	J12	J13	J14	J15	J16	J17	J18	J19	J2Ø	J21	J22	CONC STEEL
DIA	A	В	E	G	X	Y	Z	N LG	TH N	LGTH	÷ OZ	LGTH	N LGTH	I N LGTH	N LGTH	N LGTH	N O LGT	H O L	GTH N	LGTH	LGTH C	LGTH	N LGTH	N LGTH	N LGTH	N LGTH	N LGTH	N LGTH	LGTH	C LGTH	LGTH	LGTH	N LGTH	N LGTH	N LGTH	NO LGTH	CU YDS LBS
18	-	-	-	12-5	16-5%	11-Ø	1-0	4 16	-1 14	6-4	5	3-2	8 2-0	1 12-3	1 13-Ø	1 13-8	1 14-	5 1 1	5-Ø																		3.03 229
24	-	-	-	14-9	2Ø-3 ¹ ¾e	13-4		4 19-		7-7	5	3-9	8 2-3	1 14-6	1 15-3	1 15-11	1 16-	8 1 1	7-5 1	18-2																	4.38 310
30	-	-	-	17-11	24-9 ¹ / ₄	16-7	1-3	4 22-	-11 18	8-7	8	4-4	8 2-6	1 17-9	1 18-6	1 19-3	1 19-	11 1 2	Ø-8 1	21-5	1 22-2																6.08 413
36	-	-	-	20-11	29-03/4	19-6	1-6	4 26	-4 22	9-8	8	4-11			1 21-6				3-8 1	24-5	1 25-1	1 25-10	1 25-11														7.99 564
42	-	-	-	24-0	33-4 ¹ / ₄	22-7	1-9	4 30	-Ø 25	10-8	8	5-6	8 3-0	1 23-10	1 24-7	1 25-3	1 26-	Ø 1 2			1 28-2	1 28-11	1 29-8	1 29-9													10.14 653
48	-	-	-	27-1	37-9 ¹³ / ₆	25-8	2-0	4 33	-8 29	11-10	8 (6-1	8 3-3	1 26-11	1 27-8	1 28-4	1 29-	-1 1 29	9-10 1	31-7	1 32-3	1 33-0	1 33-9	1 34-6	1 34-8												12.66 845
54	-	-	-	30-105/	6 42-5 ¹ / ₈	29-1	2-3	4 38	-1 32	12-11	1 11	6-9	8 3-6	1 31-8	1 32-5	1 33-1	1 33-	10 1 3	4-7 1	35-4	1 36-0	36-9	1 37-6	1 38-3	1 38-11	1 39-2											17.37 1030
60	-	-	-	33-11%	47-01/4	32-2	2-6	4 43	-9 33	14-2	11	7-4	8 3-9	1 34-8	1 35-5	1 36-1	1 36-	10 1 3	7-7 1	38-4	1 39-0	1 39-9	1 40-6	1 41-3	1 41-11	1 42-8	1 43-1										21.00 1234
66	-	-	-	37-4%	51-11/8	35-3	2-9	4 47-	-11 36	15-11	1 11	8-3	8 4-3	1 38-3	1 39-Ø	1 39-8	1 40-	5 1 4	1-2 1	41-11	1 42-7	1 43-4	1 44-1	1 44-10	1 45-6	1 46-3	1 47-0	1 47-9									33.84 1461
72	-	-	-	40-5%	56-2%	38-4	3-Ø	4 51-	-7 40	16-10	ð 11	8-11	8 4-7	1 41-2	1 41-11	1 42-7	1 43-	4 1 4	4-1 1	44-10	1 45-6	1 46-3	1 47-Ø	1 47-9	1 48-5	1 49-2	1 49-11	1 50-8	1 51-4								39.56 1709
84	3-Ø	51-3	37-6	46-7%	64-9%	44-6	3-6	4 57-	-11 47	7 18-9	14	10-1	8 5-3	1 47-5	1 48-2	1 48-10	1 49-	7 1 5	0-4 1	51-1	1 51-9	1 52-6	1 53-3	1 54-0	1 54-8	1 55-5	1 56-2	1 56-11	1 57-7	1 58-4 1	1 59-1						40.32 2347
96	3-0 !	58-6	42-6	53-61/16	73-0%	50-8	4-0	4 65-	10 52	21-7	17	11-5		1 54-6	1 55-3	1 55-11					1 58-10					1 63-6	1 64-3			1 66-5 1	1 67-2	1 67-11	1 68-7	1 69-0			63.94 2969
108	3-Ø (65-9	47-6	59-81/16	81-71/8	56-10	4-6	4 73	-2 59	23-7	17	12-7	8 6-4	1 61-8	1 62-5	1 63-1	1 63-	10 1 6	4-7 1	65-4	1 66-0	1 66-9	1 67-6	1 68-3	1 68-11	1 69-8	1 70-5	1 71-2	1 71-10	1 72-7 1	1 73-4	1 74-1	1 74-9	1 75-6	1 76-3	1 76-9	73.42 3902

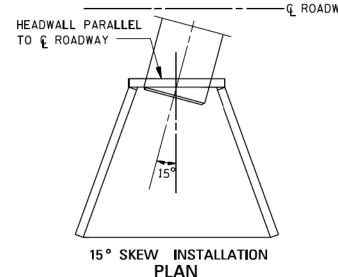

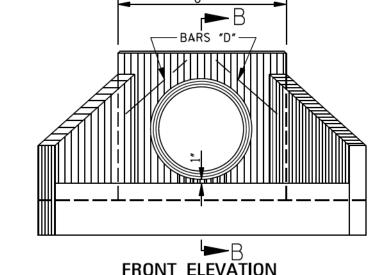

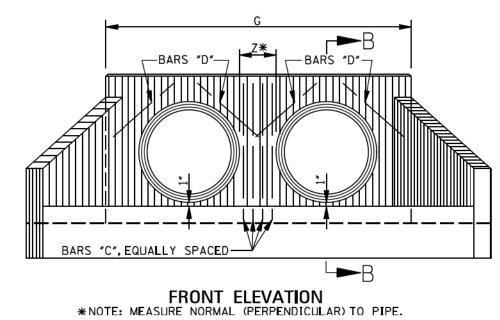

PLAN	FRONT ELEVATION

NOTICE TO DRAWING HOLDER
NEEL-SCHAFFER, INC., HEREINAFTER REFERRED TO AS THE ENGINEER, HAS PREPARED AND FURNISHED THIS DRAWING TO THE OWNER FOR USE ON THIS PROJECT ONLY. THIS DRAWING SHOULD NOT BE USED ON EXTENSIONS OF THIS PROJECT OR ON ANY OTHER PROJECT. ANY REUSE OF THIS DRAWING, WITHOUT WRITTEN VERIFICATION OR ADAPTATION BY THE ENGINEER, SHALL BE AT THE REUSER'S SOLE RISK AND THE REUSER SHALL INDEMNIFY AND HOLD HARMLESS THE ENGINEER FROM ALL CLAIMS, DAMAGES, LOSSES AND EXPENSES, INCLUDING ATTORNEY'S FEES ARISING OUT OF OR RESULTING THEREFROM.

				REVISIONS	DRAWING	INFORMATION
	NO.	DATE	BY	DESCRIPTION	N-S PROJECT NO).: 00.14470.00
,					FILENAME: DETA	ILS.DGN
					SCALE: NTS	
					SURVEYED BY: _	
					DSGN: JLD	DATE:
5					DRWN: JTD	DATE:
					CHKD: JLD	DATE:
					QA/QC: DLS	DATE:


DRAINAGE IMPROVEMENTS ON 18TH STREET AT US49 TO BRICKYARD BAYOU


CITY OF GULFPORT GULFPORT, MISSISSIPPI



HEADWALL	DETAIL

WORKING NUMBER:	DRAWING NUMBER:
DFT-5	28

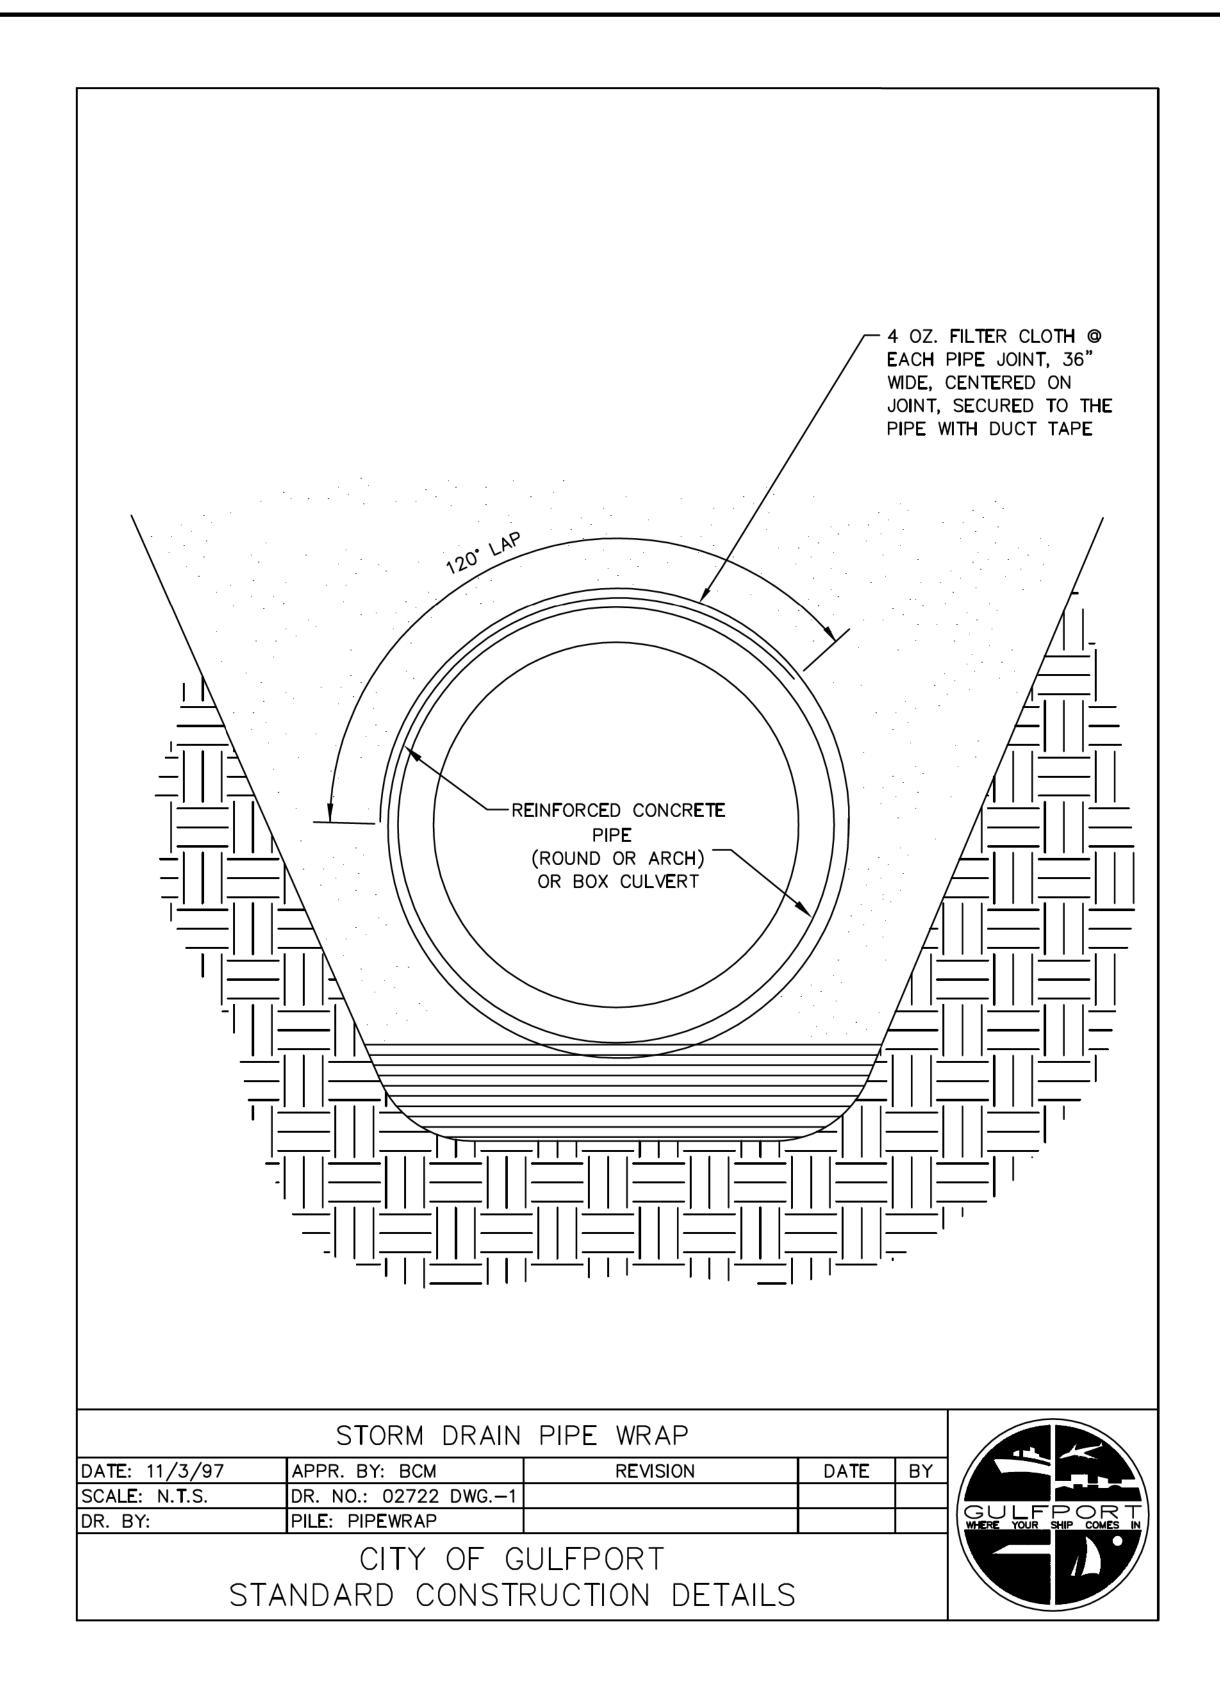

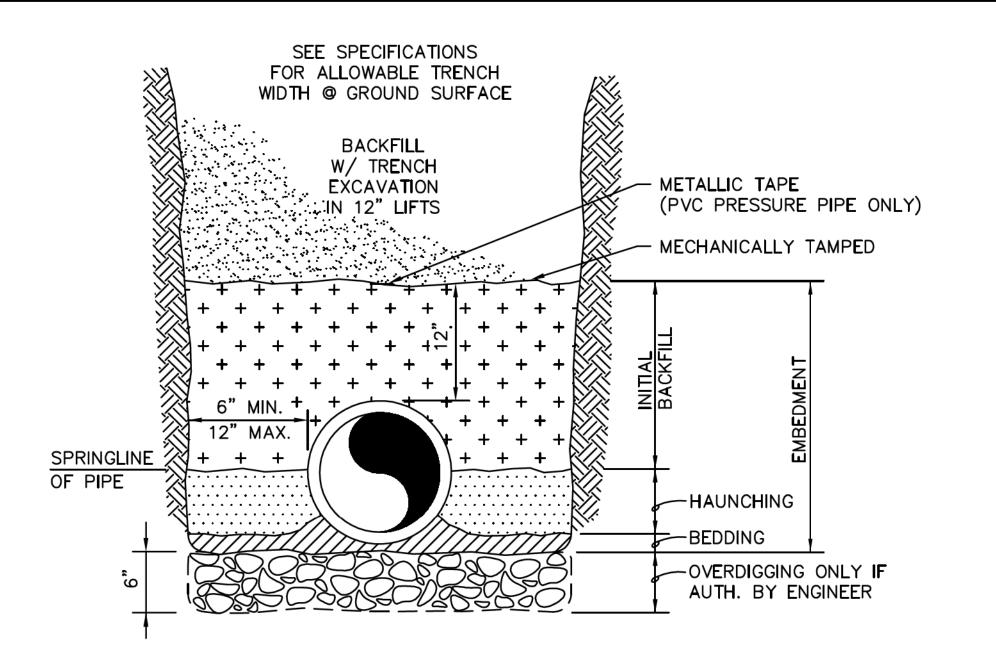

FOR WATER MAINS, FORCE MAINS, GRAVITY SEWERS & CULVERT PIPE

PIPE EMBEDMENT AND BACKFILL

Should Engineer determine that the native material at the bottom of the trench is not a suitable foundation for the pipe, he may authorize overdigging the trench a depth of 6 inches and replace with a suitable foundation material which is included in the contract as a pay item.

Generally, loose material left by the excavator on the trench bottom and soft material shaved from the trench excavation will be adequate for bedding the pipe so that it is fully supported. The haunching material shall be select material secured from the trench excavation and thoroughly compacted to the spring line of the pipe and extending to the side walls of the trench. A minimum 90 percent Standard Proctor will be considered adequate compaction.

The initial backfill (select material secured from the trench excavation) may then proceed to a height of 12 inches above the top of the pipe and mechanically tamped. Further backfill shall not proceed until initial backfill has been observed by Engineer.

Should Engineer determine that the select material secured from the trench excavation is not suitable for embedment and/or backfill, he may authorize the use of a suitable backfill material which is included in the contract as a pay item.

Further backfill may then proceed to the original ground surface in 12 inch lifts compacted to eliminate air voids. In areas where the ground surface is to receive pavement, a minimum 90 percent Standard Proctor for each lift shall be considered adequate compaction.

Contractor shall maintain trench backfill at original ground surface until final acceptance of the Work.

All surplus materials not used in backfilling shall be removed and disposed of by Contractor at his own expense.

Metallic tape will be placed in the backfill 12 inches above the top of PVC water mains and sewage force mains with lettering facing up. PVC sanitary sewers do not require marking tape.

PIPE EMBEDMENT & BACKFILL

DATE: 7/31/97	APPR. BY: BCM	REVISION	DATE	BY
SCALE: N.T.S.	DR. NO.: 02660			
DR. BY:	FILE: PIPEBED2			



CITY OF GULFPORT STANDARD CONSTRUCTION DETAILS

NOTICE TO DRAWING HOLDER

NEEL-SCHAFFER, INC., HEREINAFTER REFERRED TO AS THE ENGINEER, HAS PREPARED AND FURNISHED THIS DRAWING TO THE OWNER FOR USE ON THIS PROJECT ONLY. THIS DRAWING SHOULD NOT BE USED ON EXTENSIONS OF THIS PROJECT OR ON ANY OTHER PROJECT. ANY REUSE OF THIS DRAWING, WITHOUT WRITTEN VERIFICATION OR ADAPTATION BY THE ENGINEER, SHALL BE AT THE REUSER'S SOLE RISK AND THE REUSER SHALL INDEMNIFY AND HOLD HARMLESS THE ENGINEER FROM ALL CLAIMS, DAMAGES, LOSSES AND EXPENSES, INCLUDING ATTORNEY'S FEES ARISING OUT OF OR RESULTING THEREFROM.

			REVISIONS	DRAWING INFORMATION						
NO.	DATE	BY	DESCRIPTION	N-S PROJECT I	NO.: 00.14470.00					
				FILENAME: DET	AILS.DGN					
				SCALE: NTS						
				SURVEYED BY:						
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				DRWN: JTD	DATE:					
				CHKD: JLD	DATE:					
				QA/QC: DLS	DATE:					


DRAINAGE IMPROVEMENTS ON 18TH STREET AT US49 TO BRICKYARD BAYOU

CITY OF GULFPORT GULFPORT, MISSISSIPPI



DRAINAGE DETAILS

WORKING NUMBER:	DRAWING NUMBER:
DET-6	29

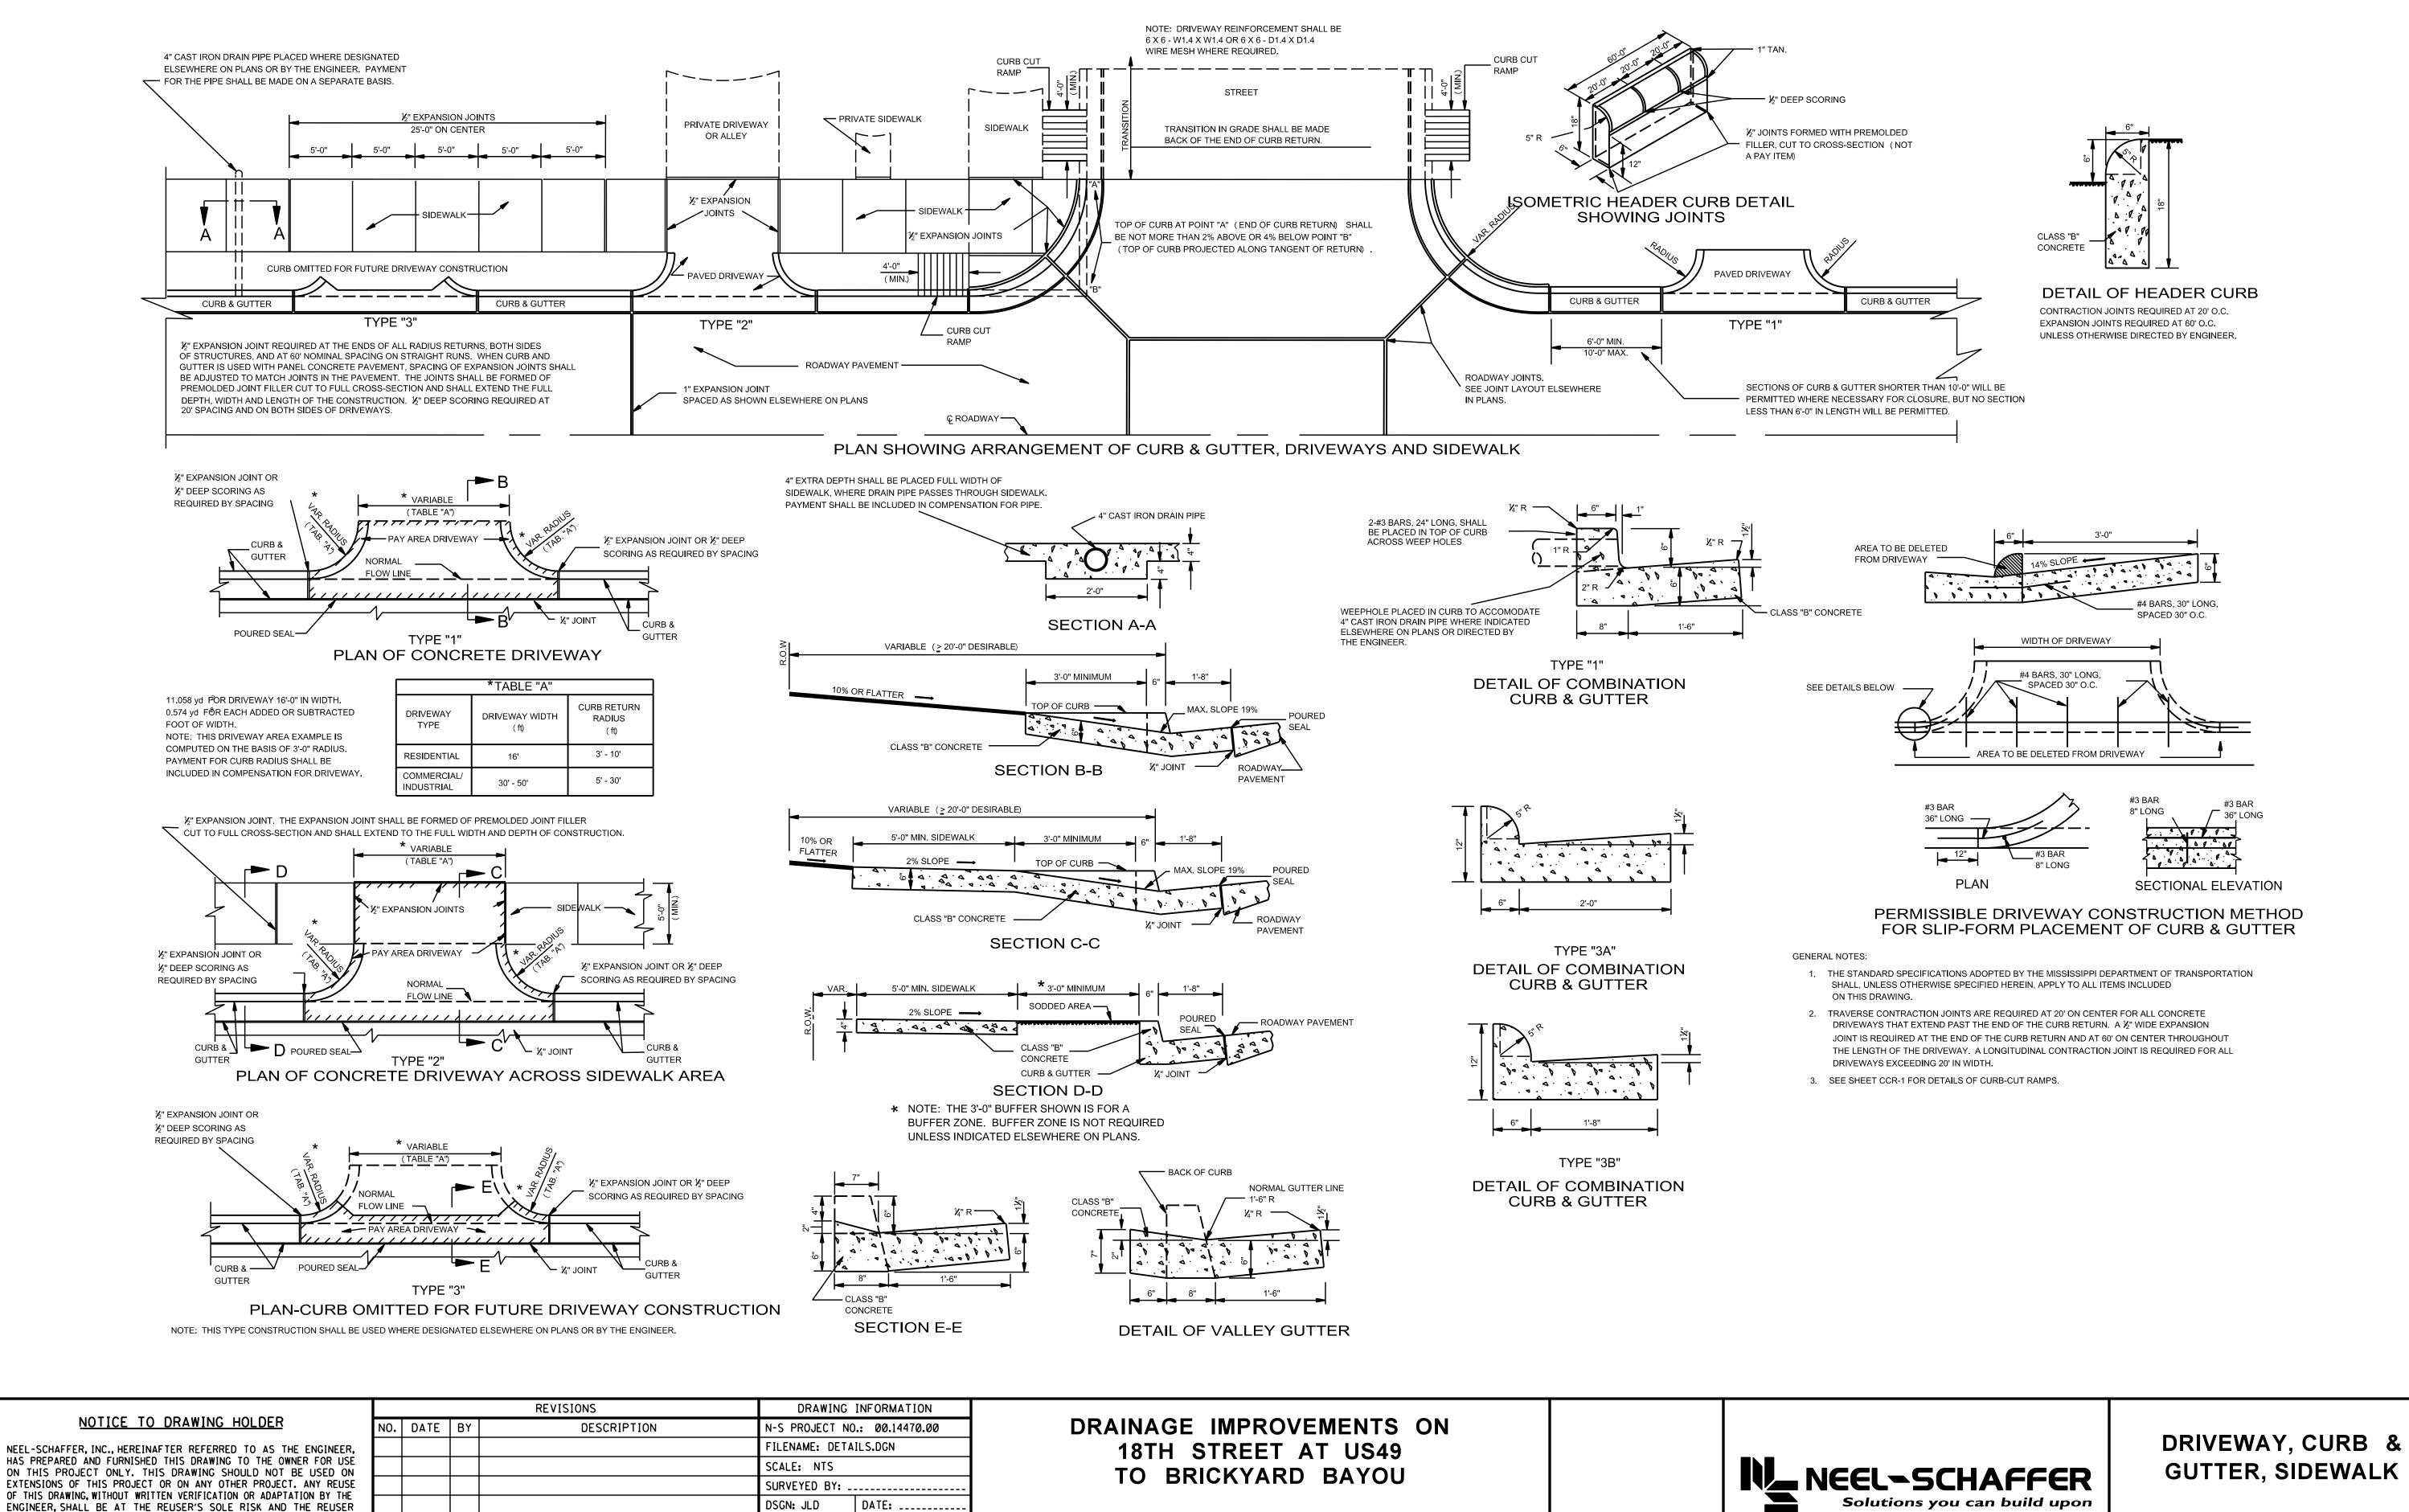

DATE: _____

DATE: _____

DATE: ___

DRWN: JTD

CHKD: JLD

QA/QC: DLS

SHALL INDEMNIFY AND HOLD HARMLESS THE ENGINEER FROM ALL CLAIMS,

OUT OF OR RESULTING THEREFROM.

DAMAGES, LOSSES AND EXPENSES, INCLUDING ATTORNEY'S FEES ARISING


CITY OF GULFPORT
GULFPORT, MISSISSIPPI

DET-7

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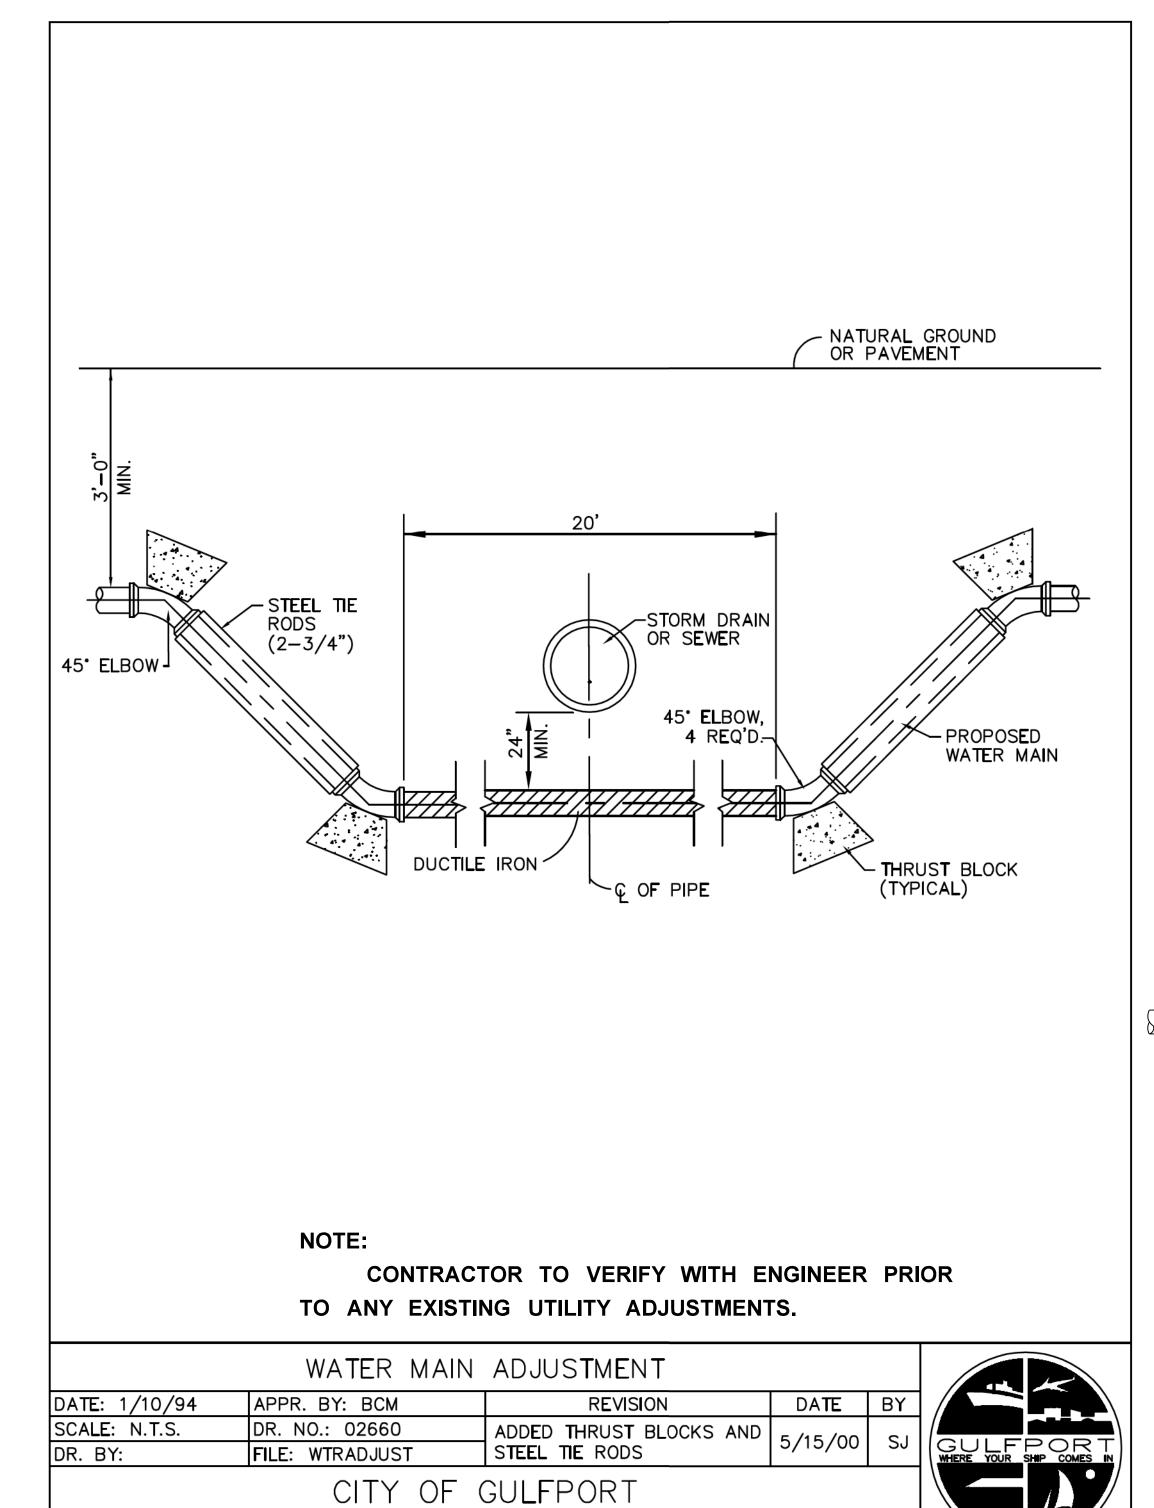
DET-7


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CITY OF GULFPORT

STANDARD CONSTRUCTION DETAILS

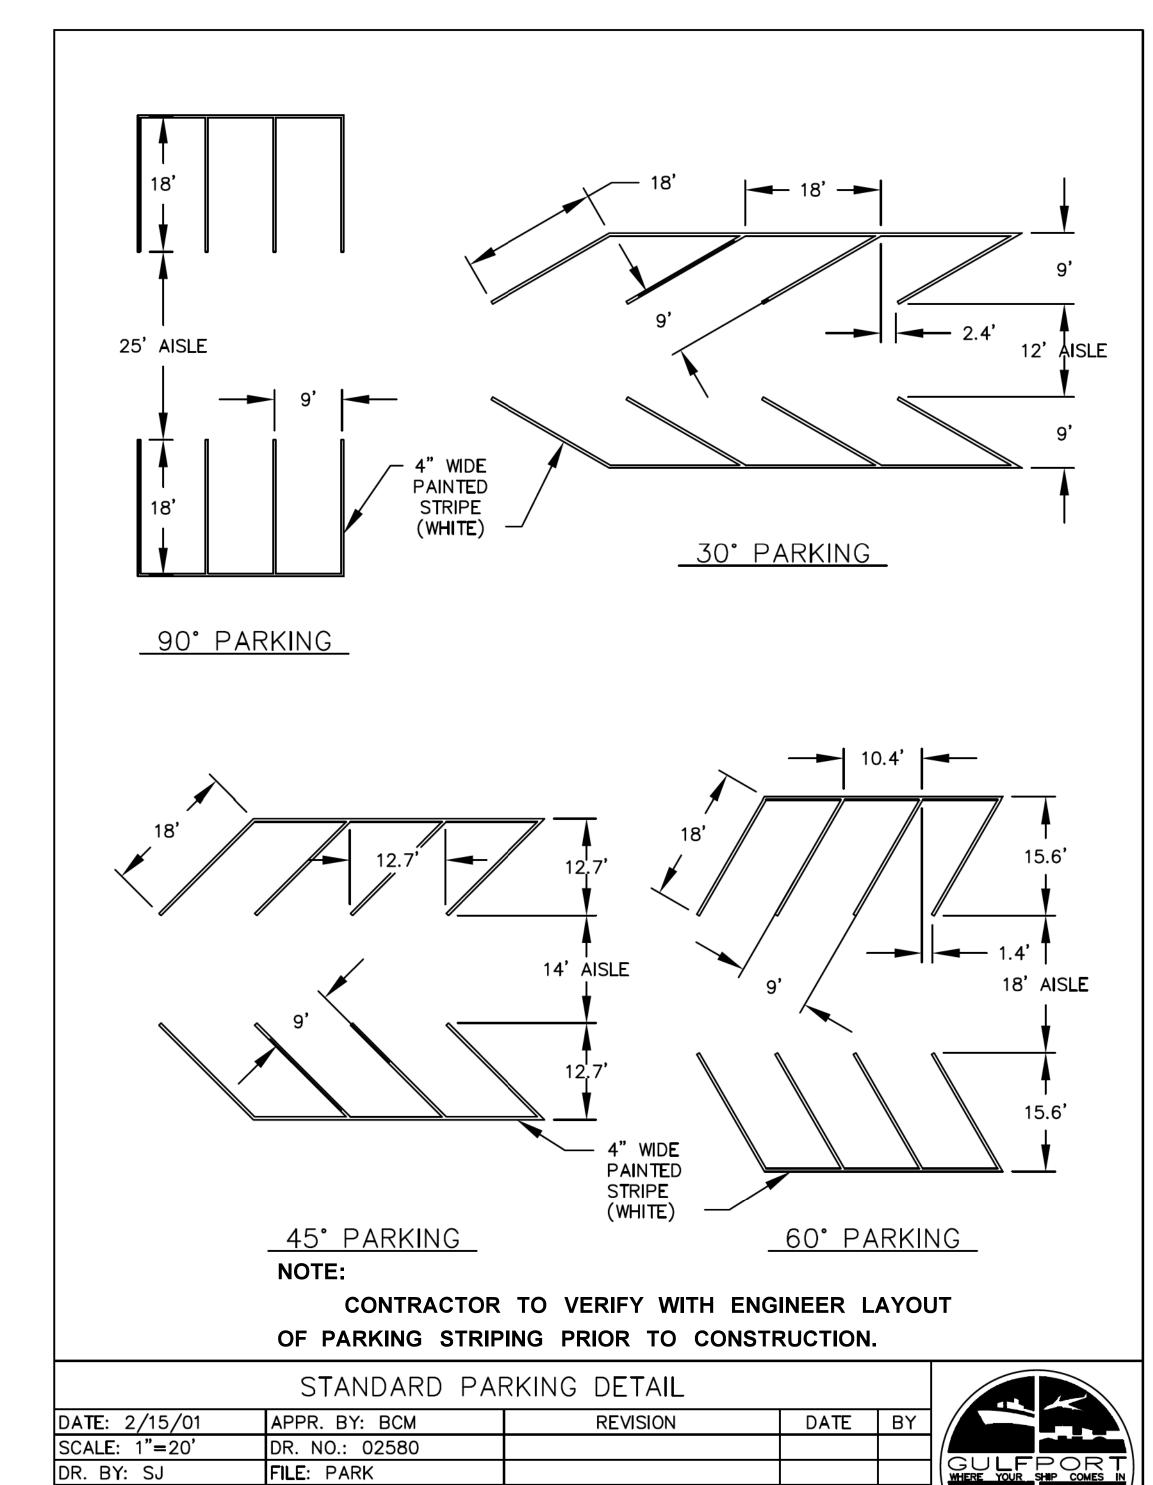



NOTICE TO DRAWING HOLDER
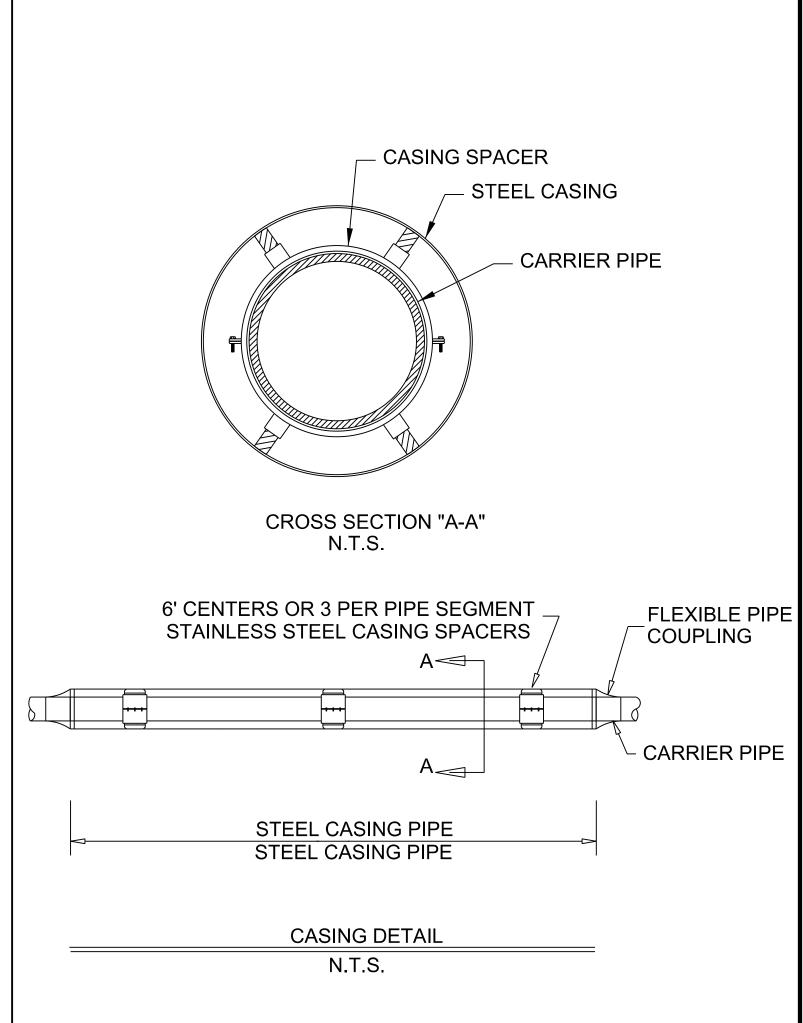
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				CHKD: JLD	DATE:				
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DRAINAGE IMPROVEMENTS ON 18TH STREET AT US49 TO BRICKYARD BAYOU


STANDARD CONSTRUCTION DETAILS


CITY OF GULFPORT GULFPORT, MISSISSIPPI



MISCELLANEOUS	DETAILS
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WORKING NUMBER:	DRAWING NUMBER:
DET-8	31



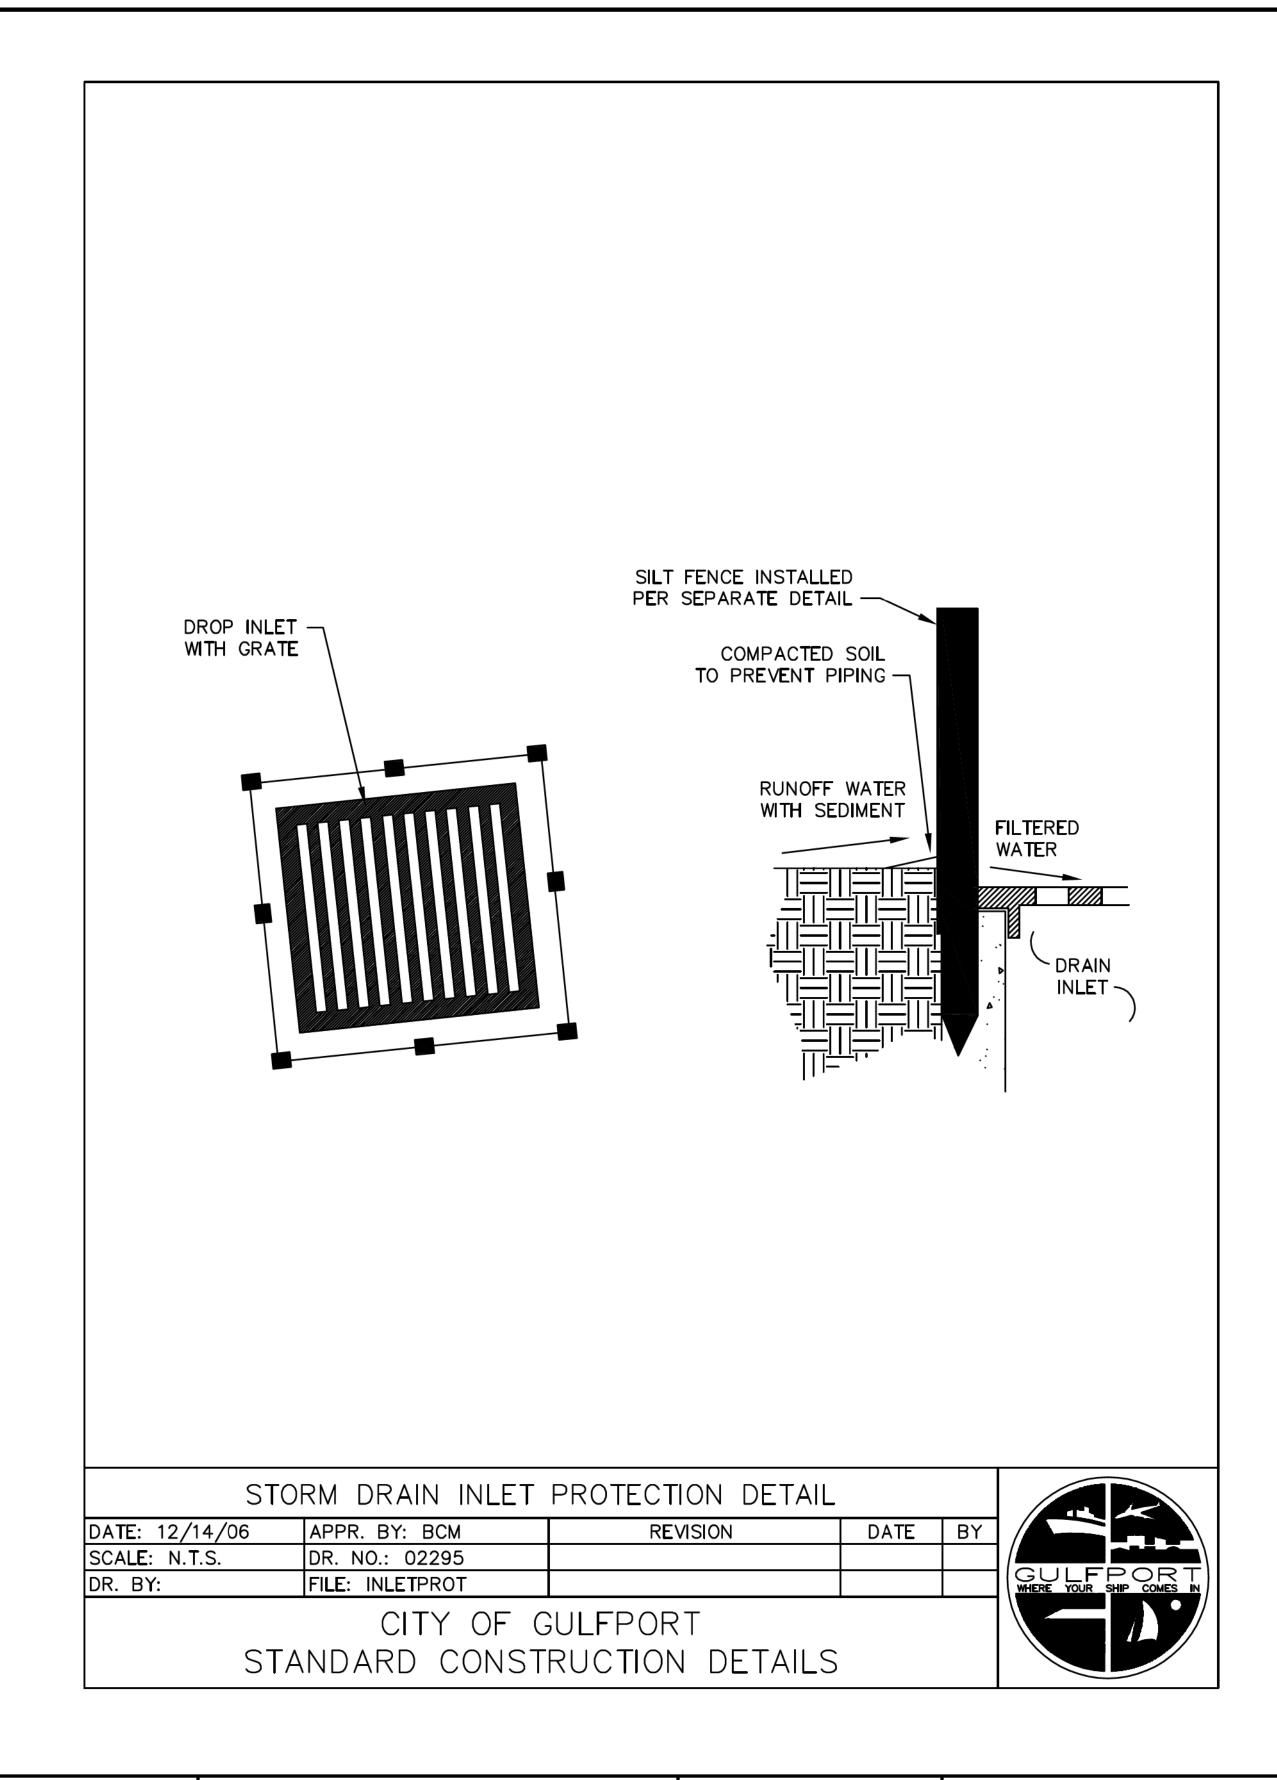

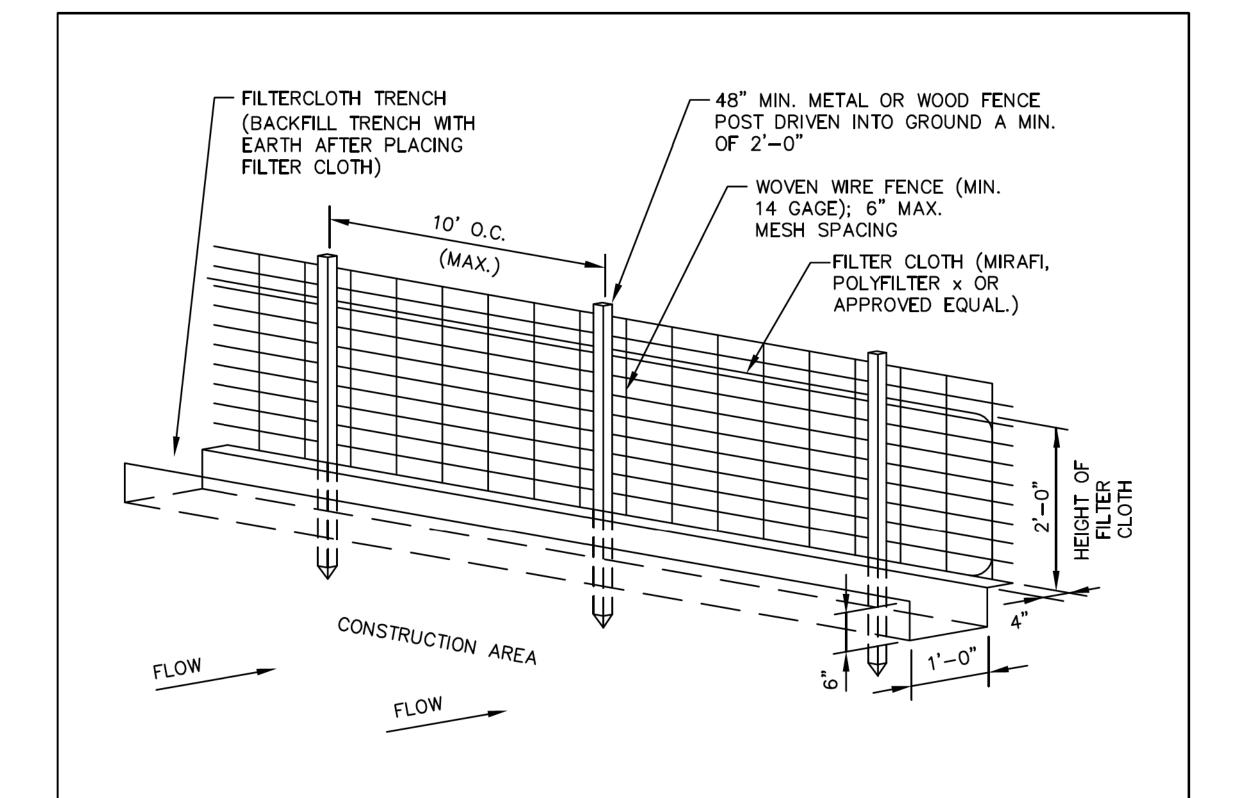CONSTRUCTION SPECIFICATIONS

- 1. WOVEN WIRE FENCE TO BE FASTENED SECURELY TO FENCE POSTS BY USE OF WIRE TIES.
- 2. FILTER CLOTH TO BE FASTENED SECURELY TO WOVEN WIRE FENCE BY USE OF WIRE TIES SPACED EVERY 24" X 24".
- SILT FENCES TO BE INSTALLED IN LOCATIONS AS SHOWN ON THIS EROSION AND SEDIMENT CONTROL PLAN PRIOR TO BEGINNING OF CONSTRUCTION TO CONTROL SEDIMENT.
- 4. SILT FENCES TO BE MAINTAINED AND CLEANED AS NECESSARY TO MAINTAIN IN FUNCTIONAL CONDITION.
- 5. SILT FENCES TO BE REMOVED AND THE AREA TO BE RESTORED TO ITS NATURAL CONDITION WHEN PERMANENT EROSION AND SEDIMENT CONTROL PROCEDURES ARE EFFECTIVE.

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DATE: 8/31/92	APPR. BY: BCM	REVISION	DATE	BY
SCALE: N.T.S.	DR. NO.: 02295-A			
DR. BY:	FILE: SILTFNC			

CITY OF GULFPORT STANDARD CONSTRUCTION DETAILS



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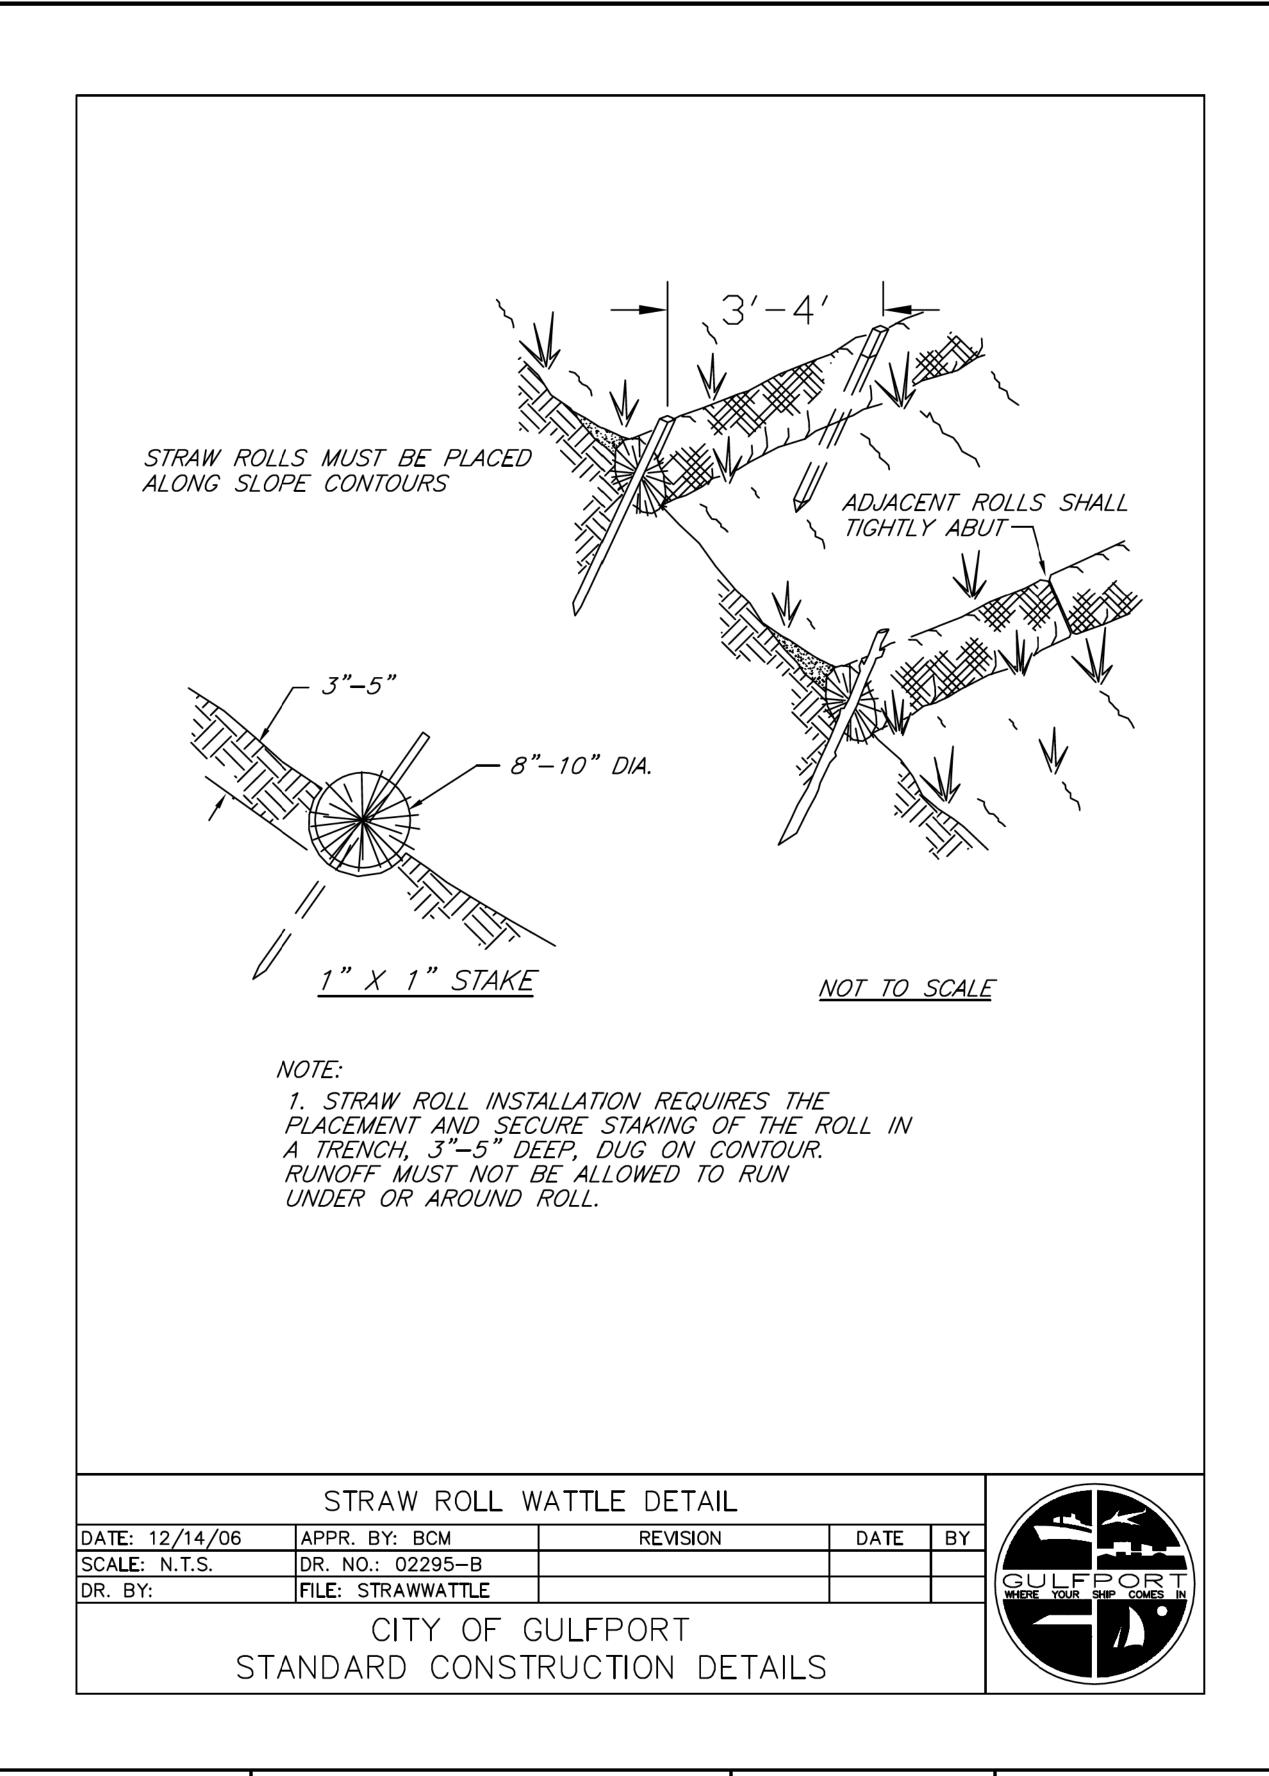
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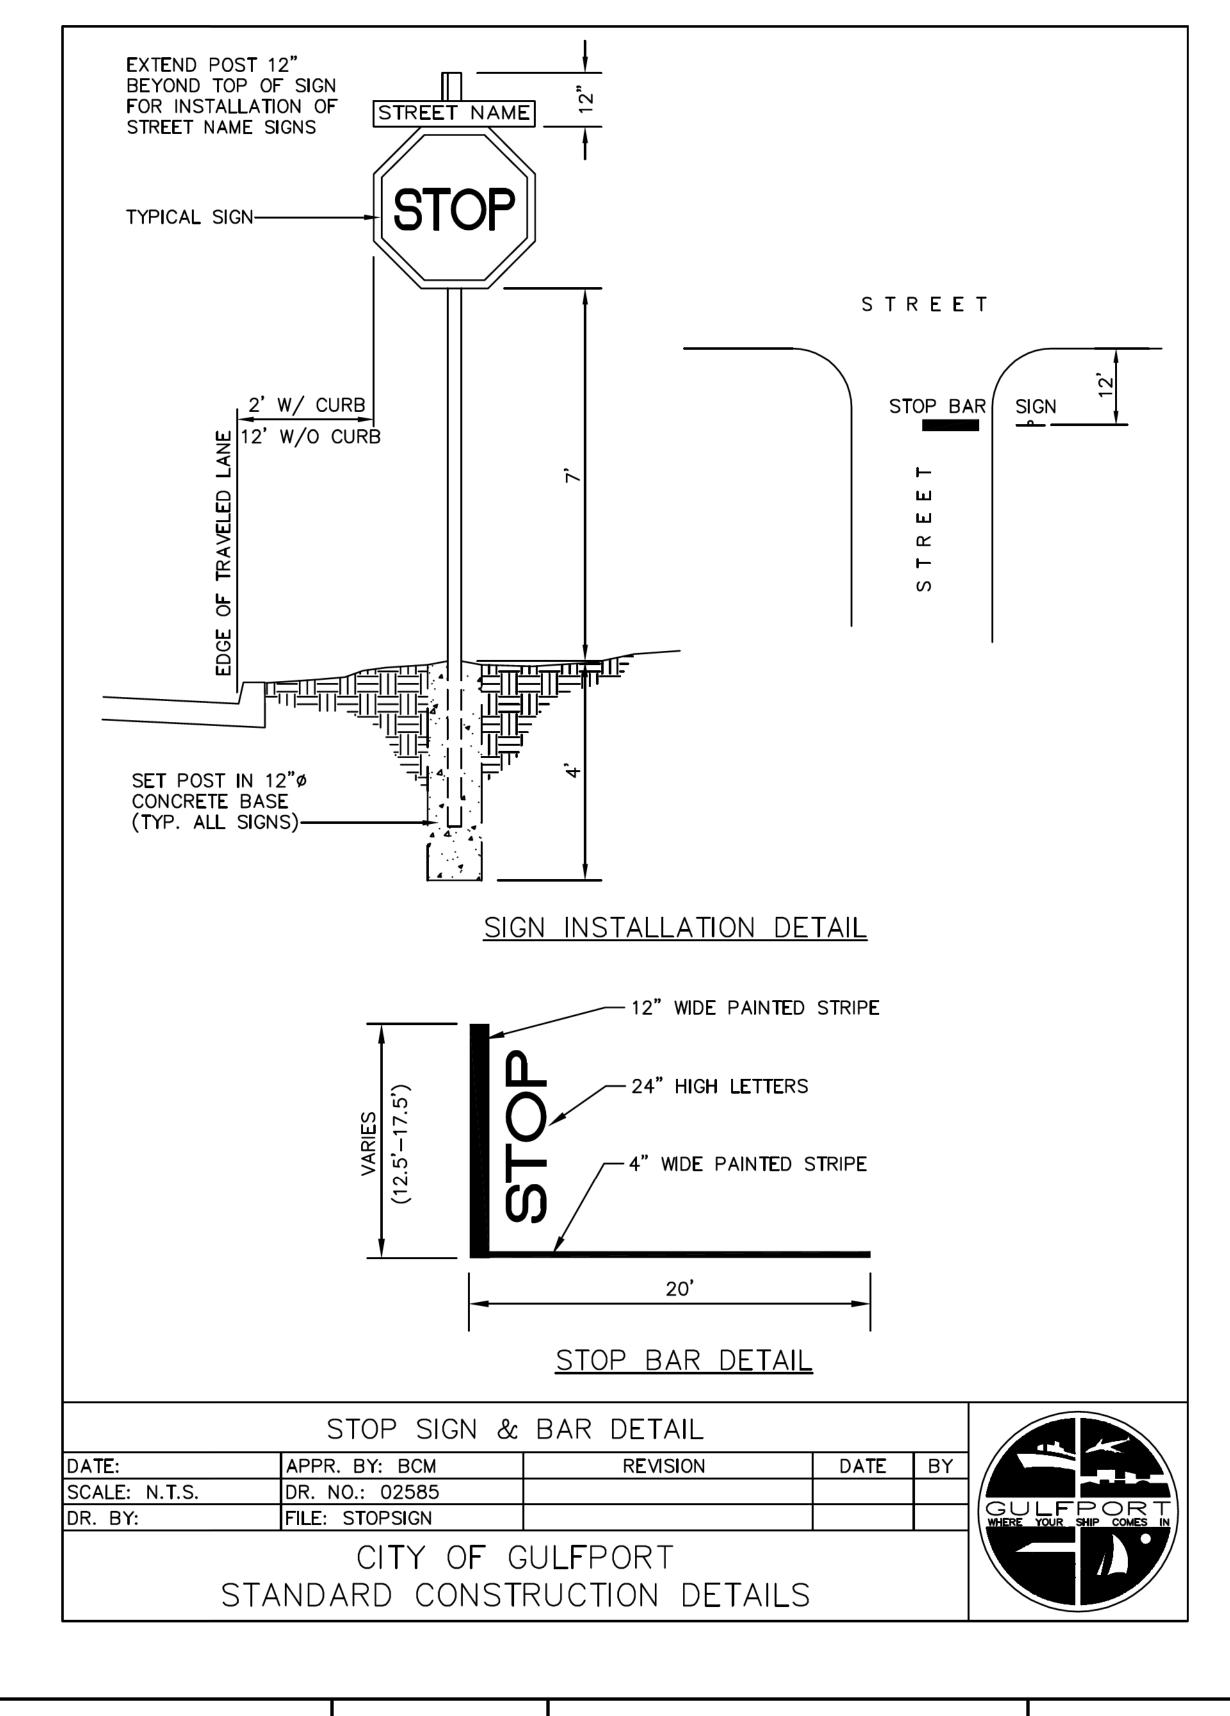
CITY OF GULFPORT GULFPORT, MISSISSIPPI



EROSION CONTROL

WORKING NUMBER:	DRAWING NUMBER:
DFT ₋ 9	32





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				DRWN: JTD	DATE:
				CHKD: JLD	DATE:
				QA/QC: DLS	DATE:


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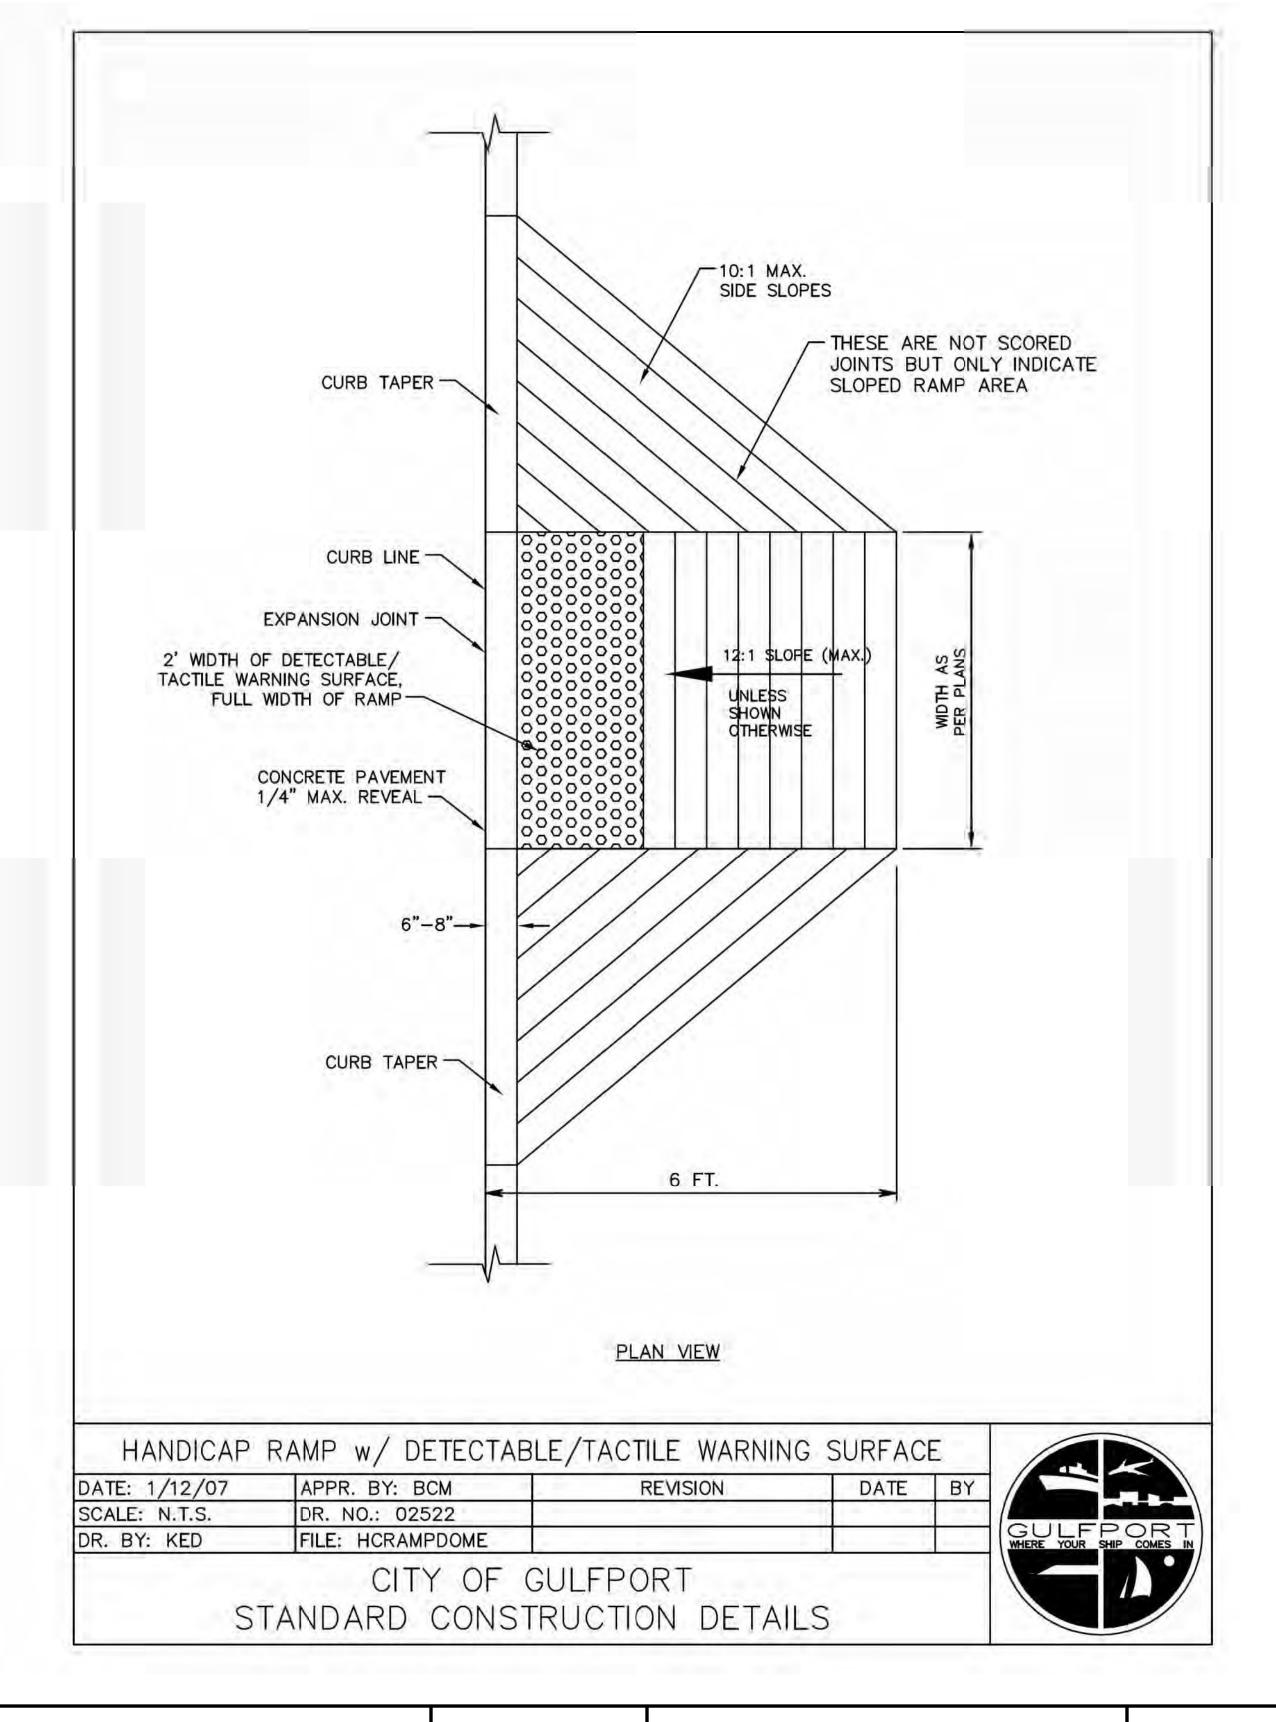
CITY OF GULFPORT GULFPORT, MISSISSIPPI



EROSION CONTROL STOP SIGN & BAR

working number: Drawing number: 33



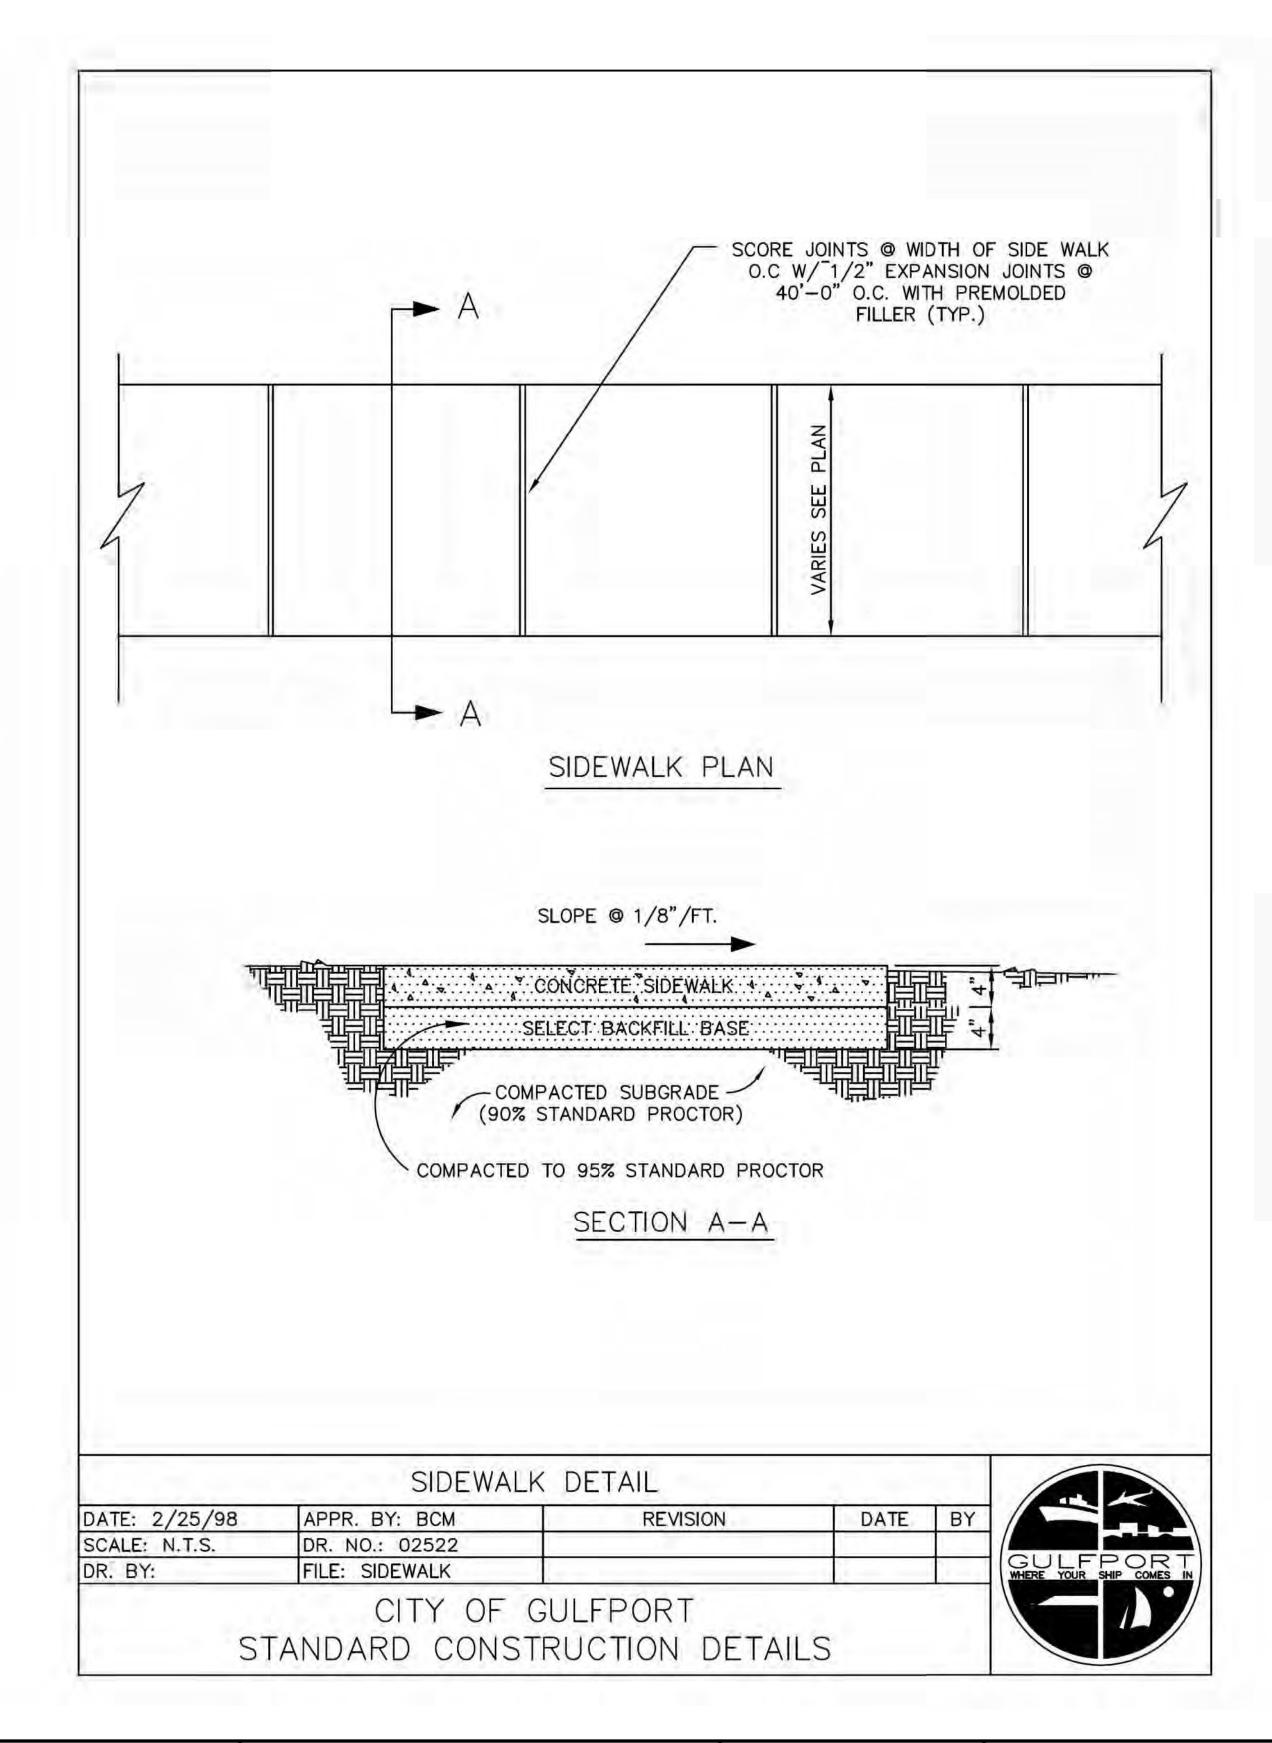

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DRAINAGE IMPROVEMENTS ON 18TH STREET AT US49 TO BRICKYARD BAYOU

CITY OF GULFPORT GULFPORT, MISSISSIPPI



SIDEWALK DETAILS

WORKING NUMBER:	DRAWING NUMBER:
DFT-11	34