


# HYATTOWN PUMP STATION IMPROVEMENTS

HAZEN CONTRACT No. 30961-010 MARCH 2016





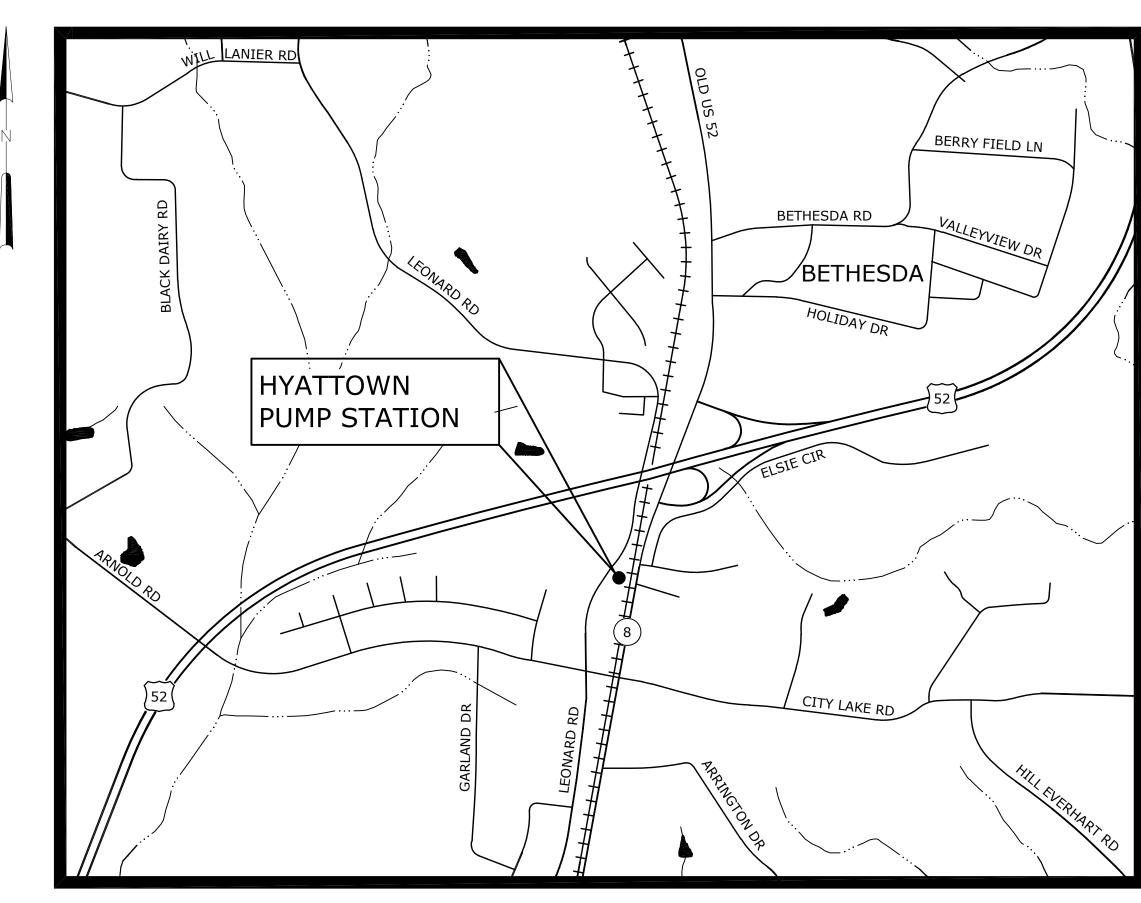





LOCATION MAP


NOT TO SCALE



HAZEN AND SAWYER
4944 PARKWAY PLAZA BLVD, SUITE 375
CHARLOTTE, NC 28217





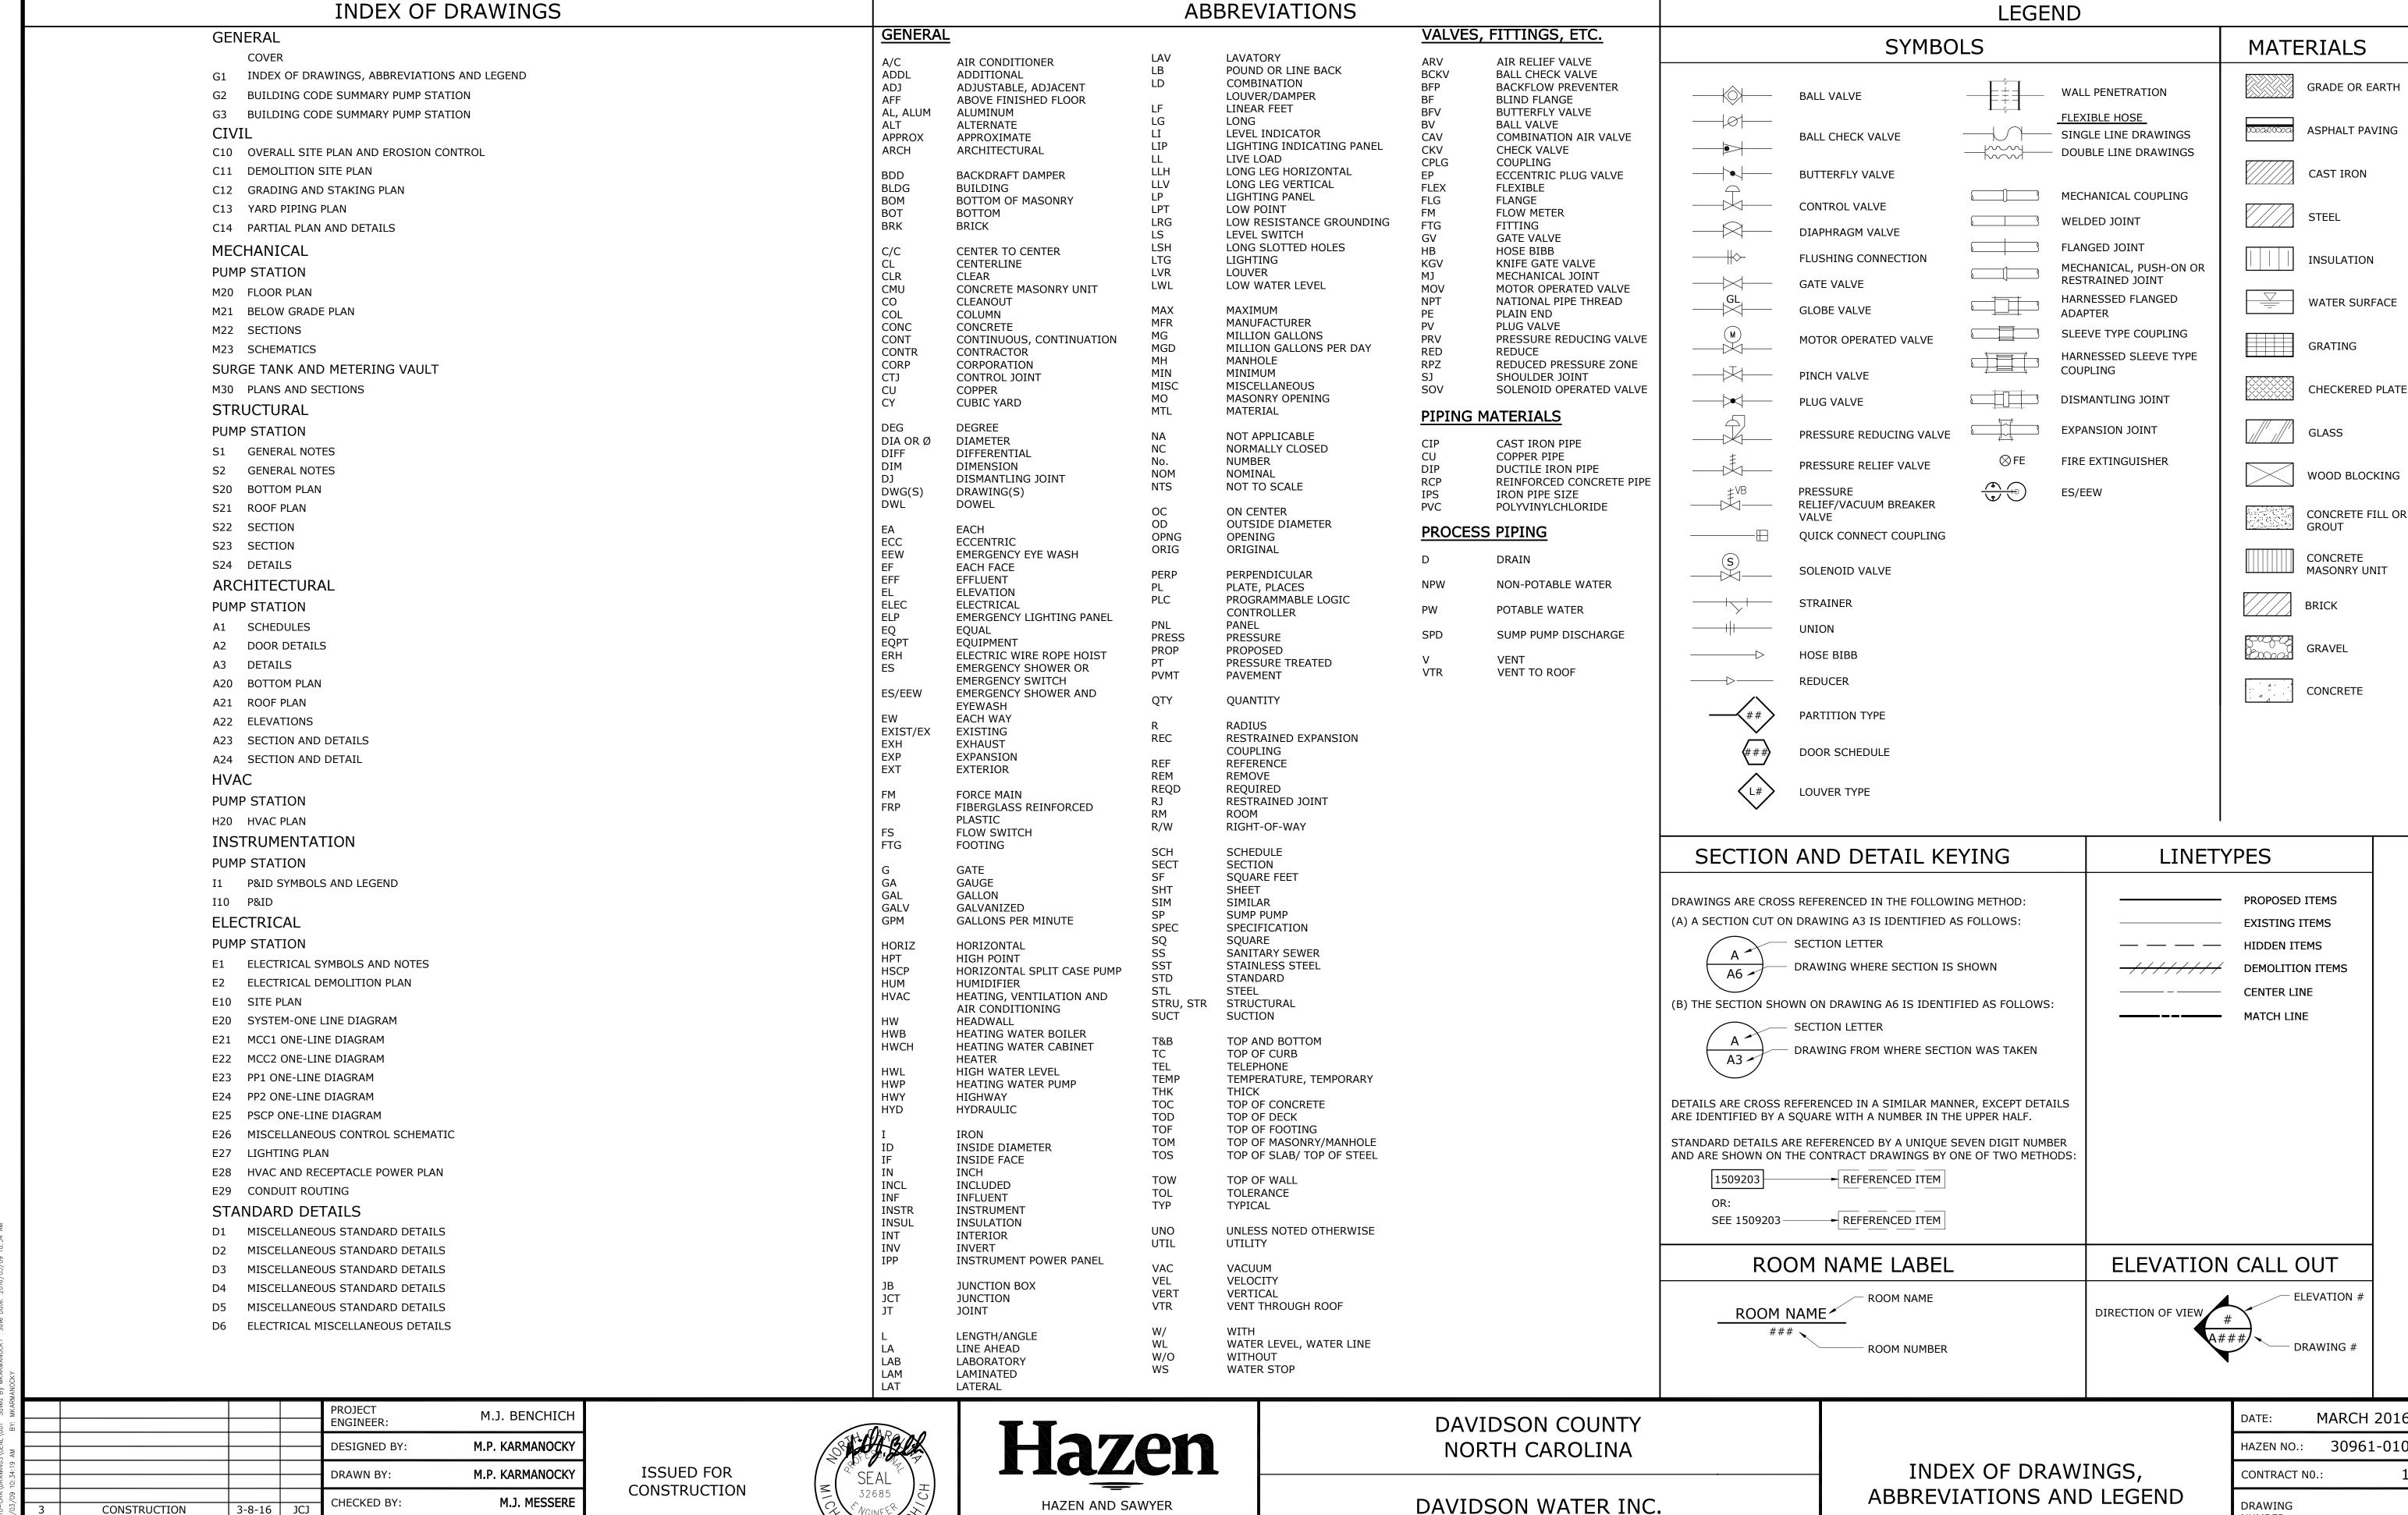

BUILDING PERMIT REVIEW | 2-26-16 | JCJ

1-20-16 JCJ

REGULATORY REVIEW

**ISSUED FOR** 

IF THIS BAR DOES NOT

IS NOT TO FULL SCALE

MEASURE 1" THEN DRAWING



4944 PARKWAY PLAZA BLVD, SUITE 375

CHARLOTTE, NORTH CAROLINA 28217

LICENSE NO.: C-0381

DAVIDSON WATER INC. HYATTOWN PUMP STATION IMPROVEMENTS

DATE:	MARCH 2016
HAZEN NO.:	30961-010
CONTRACT NO	).: 1
DRAWING NUMBER:	

G1

HAZEN AND SAWYER

4944 PARKWAY PLAZA BLVD, SUITE 375

CHARLOTTE, NORTH CAROLINA 28217

LICENSE NO.: C-0381

DAVIDSON WATER INC.

HYATTOWN PUMP STATION IMPROVEMENTS

NUMBER:

G2

W. RUSSSELI

0 1/2" 1

CHECKED BY:

F THIS BAR DOES NOT

IS NOT TO FULL SCALE

MEASURE 1" THEN DRAWING

3-08-16

2-26-16

1-20-16

DATE

CONSTRUCTION

BUILDING PERMIT REVIEW

REGULATORY REVIEW

**ISSUED FOR** 

# **ENERGY SUMMARY**

# BUILDING IS NOT CONDITIONED

# ENERGY REQUIREMENTS

The following data shall be considered minimum and any special attribute required to meet the energy code shall also be provided. Each Designer shall furnish the required portions of the project information for the plan data sheet. If performance method, state the annual energy cost for the standard reference design vs annual energy cost for the proposed design.

Climate Zone:	☐ 3	□ 4	5

## Method of Compliance:

Prescriptive (Energy Code)
Performance (Energy Code)
Prescriptive (ASHRAE 90.1))

# Performance (ASHRAE 90.1)

# THERMAL ENVELOPE

ROOF/CEILING ASSEMBLY							
description of assembly	u-value	r-value	skylights in each assembly				
	of total assembly	of insulation	u-value	total sq ft			

EXTERIOR WALLS							
description of assembly	openings (windows or doors with glazing)			door			
	of total assembly	of insulation	u-value	shgc	projection factor	low e required, if applicable	r-values

WALLS BELOW GRADE					
description of assembly	u-value of total assembly	r-value of insulation			

FLOORS OVER UNCONDITIONED SPACE				
description of assembly	u-value of total assembly	r-value of insulation		

FLOORS SLAB ON GRADE							
description of assembly	u-value of total assembly	r-value of insulation	horizontal requirement	vertical requirement	slab heated		

# MECHANICAL SUMMARY

# SEE ELECTRICAL DRAWINGS

# MECHANICAL SYSTEMS, SERVICE SYSTEMS AND EQUIPMENT

,	•
Thermal zone	
Winter dry bulb	
Summer dry bulb	
Interior design conditions	
Winter dry bulb	
Summer dry bulb	
Relative humidity	
Duilding hosting load	
Building heating load Building cooling load	
building cooling load	
Mechanical Spacing Conditioning System	
Unitary	
Description of unit	
Heating efficiency	
Cooling efficiency	
size category of unit	
Boiler	
Size category. If oversized, state reason:	
Chiller	
Size category. If oversized, state reason:	

List equipment efficiencies

# ELECTRICAL SUMMARY

# SEE ELECTRICAL DRAWINGS

# ELECTRICAL SYSTEM AND EQUIPMENT

Method of Compliance:  Energy Code:  Prescriptive	Performance
ASHRAE 90.1: Prescriptive	Performance
Lighting Schedule (each fixture type):  Lamp type required in fixture  Number of lamps in fixture  Ballast type used in the fixture  Number of ballasts in fixture  Total wattage per fixture  Total interior wattage specified vs  allowed  (whole building or space by space)  Total exterior wattage specified vs allowed	
Additional Prescriptive Compliance:  506.2.1 More Efficient Mechanical Equip 506.2.2 Reduced Lighting Power Density 506.2.3 Energy Recovery Ventilation Sy 506.2.4 Higher Efficiency Service Water	y vstems

506.2.5 On-Site Supply of Renewable Energy

506.2.2 Reduced Lighting Power Density

				PROJECT ENGINEER:	M.J. BENCHICH
				DESIGNED BY:	W. RUSSELL
				DRAWN BY:	E. CARROLL
				CHECKED DV.	W DUCCCELL
3	CONSTRUCTION	3-08-16	JCJ	CHECKED BY:	W. RUSSSELL
2	BUILDING PERMIT REVIEW	2-26-16	JCJ	IF THIS DAD DOES NOT	0 1/2" 1"
1	REGULATORY REVIEW	1-20-16	JCJ	IF THIS BAR DOES NOT MEASURE 1" THEN DRAWING	0 1/2" 1"
REV	ISSUED FOR	DATE	BY	IS NOT TO FULL SCALE	






Hazen HAZEN AND SAWYER 4944 PARKWAY PLAZA BLVD, SUITE 375 CHARLOTTE, NORTH CAROLINA 28217 LICENSE NO.: C-0381

DAVIDSON COUNTY NORTH CAROLINA

DAVIDSON WATER INC. HYATTOWN PUMP STATION IMPROVEMENTS BUILDING CODE SUMMARY PUMP STATION

MARCH 2016 30961-010 HAZEN NO.: CONTRACT NO.: DRAWING NUMBER: G3

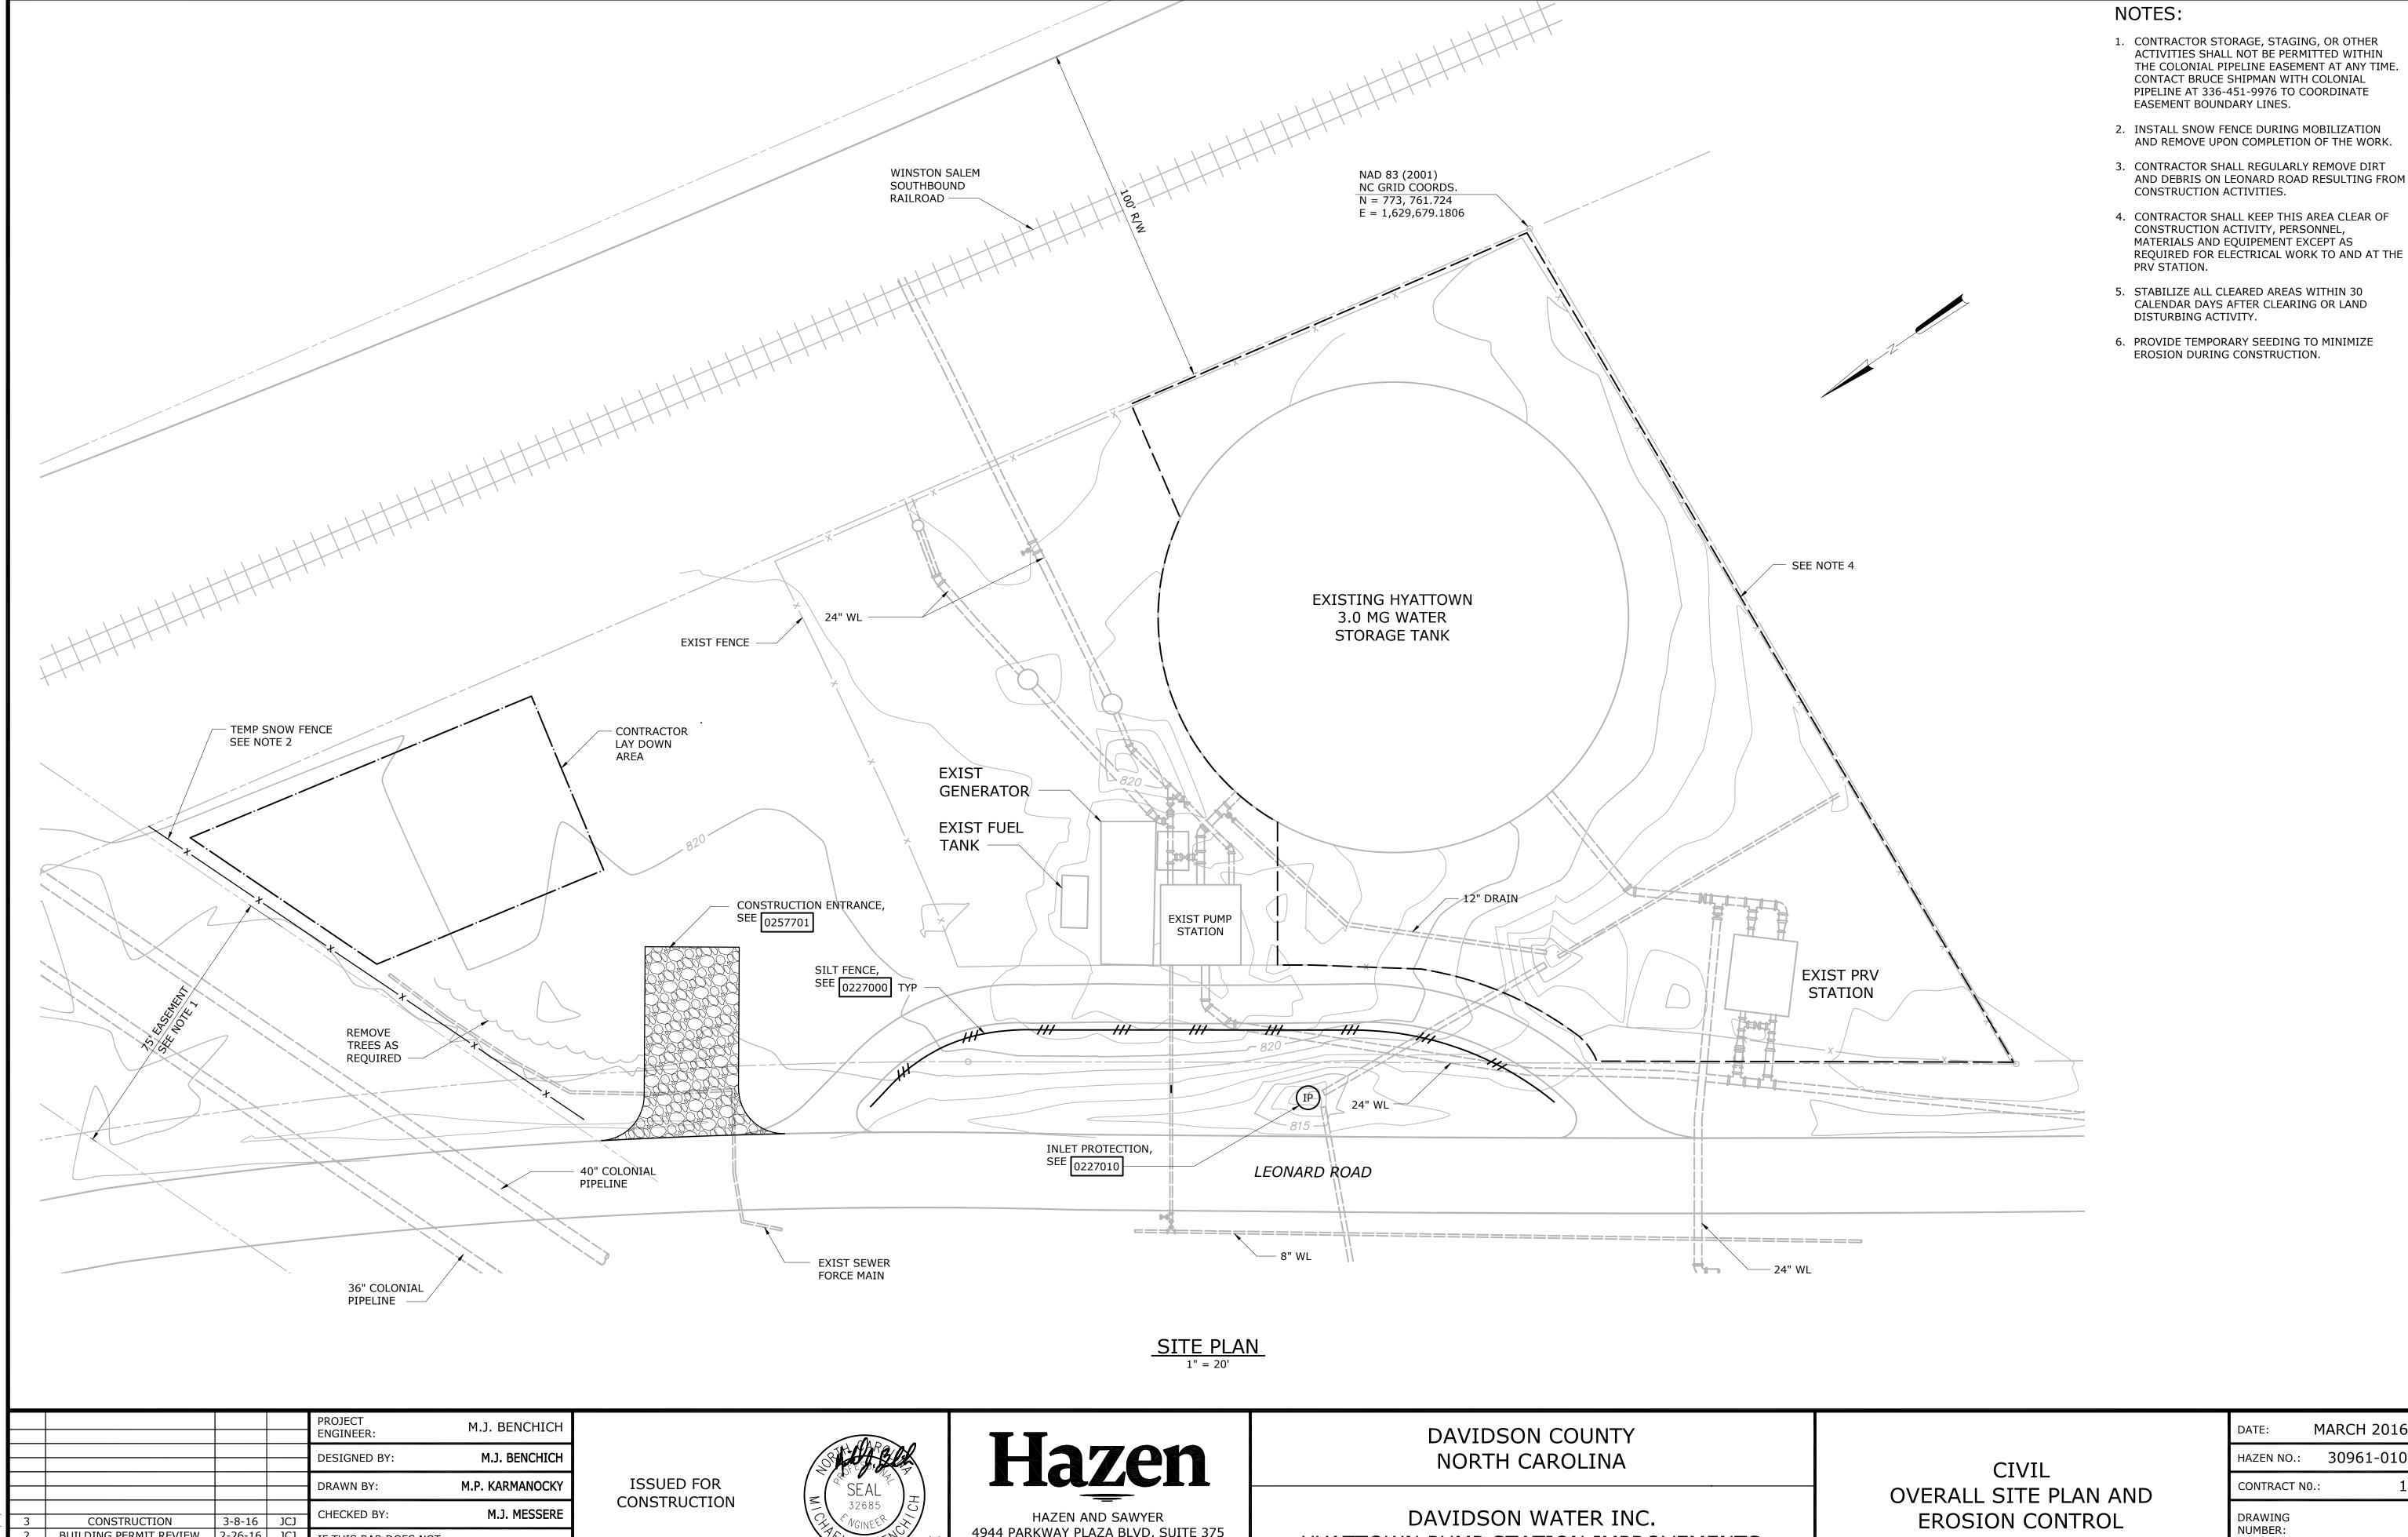

4944 PARKWAY PLAZA BLVD, SUITE 375 CHARLOTTE, NORTH CAROLINA 28217 LICENSE NO. : C-0381

HYATTOWN PUMP STATION IMPROVEMENTS

CONSTRUCTION

REGULATORY REVIEW

BUILDING PERMIT REVIEW 2-26-16 JCJ


3-8-16 JCJ


1-20-16 JCJ

IF THIS BAR DOES NOT
MEASURE 1" THEN DRAWING
IS NOT TO FULL SCALE

REQUIRED FOR ELECTRICAL WORK TO AND AT THE

C10

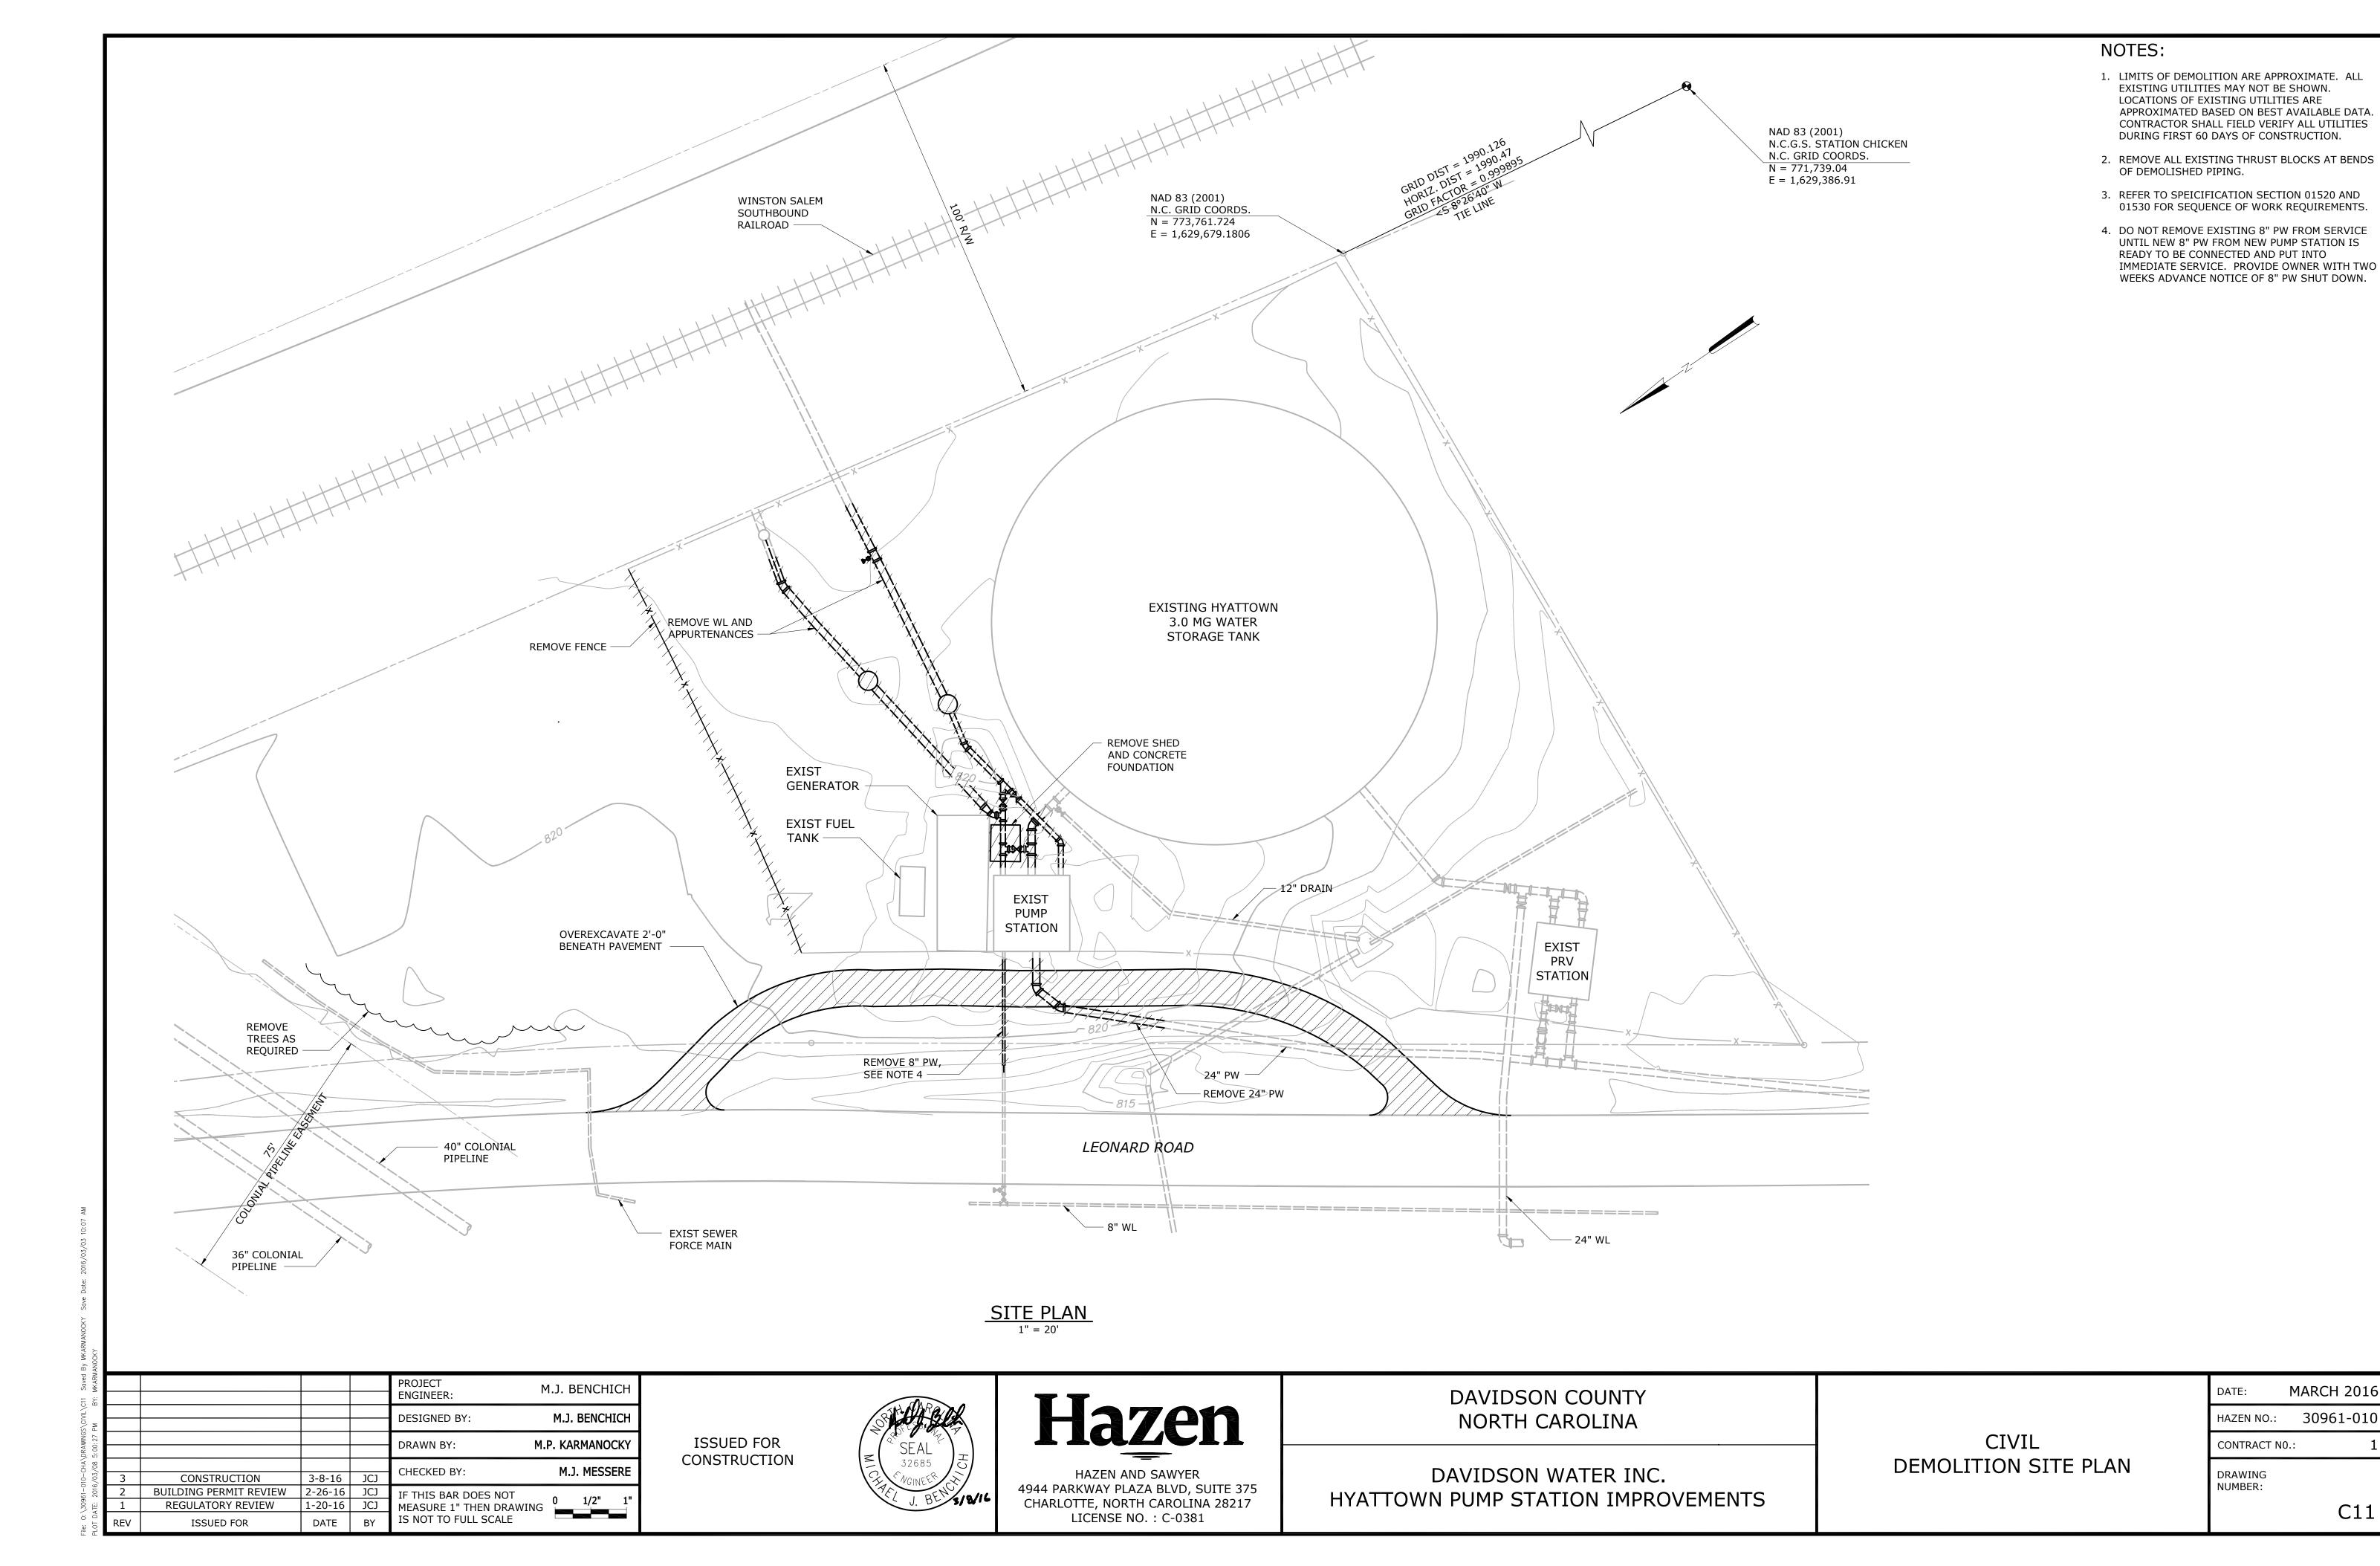

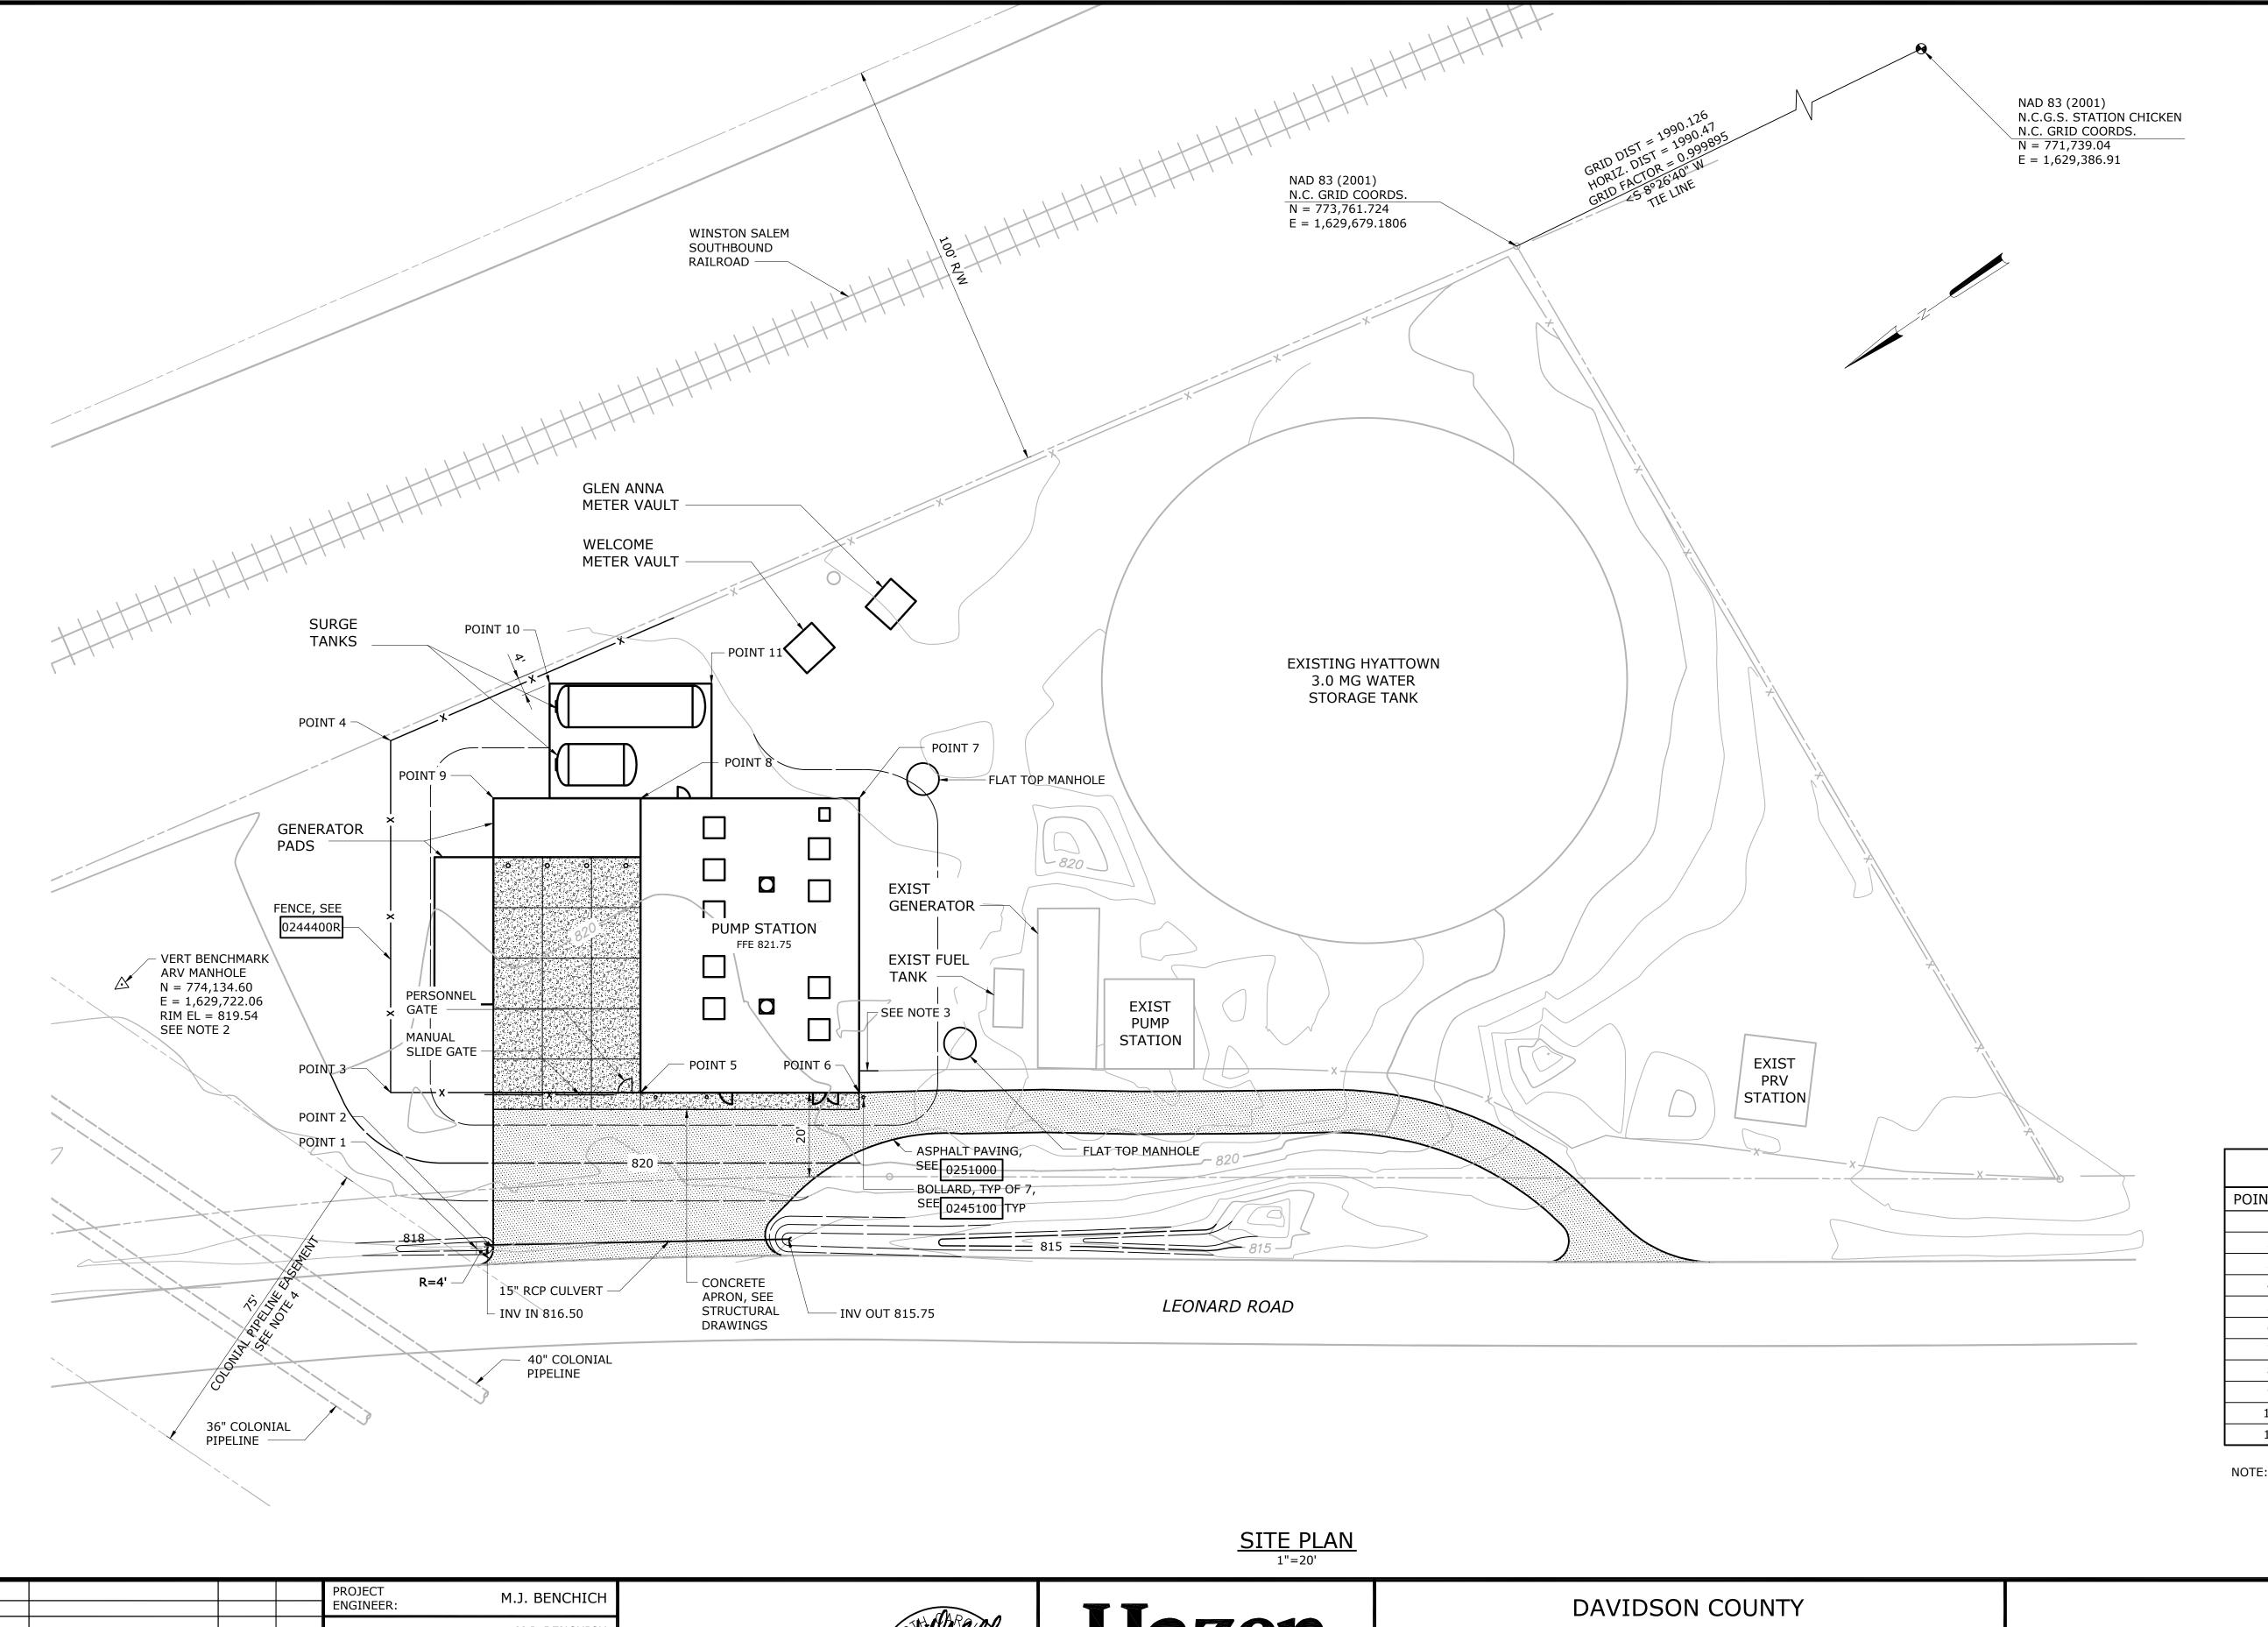


- 1. ALL EXISTING UTILITIES MAY NOT BE SHOWN. LOCATIONS OF EXISTING UTILITIES ARE APPROXIMATED FROM BEST AVAILABLE DATA. CONTRACTOR SHALL FIELD VERIFY ALL UTILITIES.
- 2. BASIS OF BEARING NC GRID NAD 83 (2001) ADJUSTMENT. THE PROJECT COORDINATES ARE GROUND BASED (LOCALIZED) COORDINATES DERIVED FROM REAL-TIME GPS OBSERVATIONS. THE VERTICAL DATUM IS NAVD 88. VERTICAL BENCHMARK, SHOWN ON THIS DRAWING, IS VERIFIED AGAINST NCGS STATION "WHISTLE".
- 3. TERMINATE FENCE AT BUILDING.
- 4. CONTRACTOR SHALL NOT PERFORM ANY GRADING ACTIVITIES WITHIN THE COLONIAL PIPELINE EASEMENT W/ OUT A COLONIAL PIPELINE REPRESENATIVE PRESENT, CONTACT BRUCE SHIPMAN AT 336-451-9976 FOR COORDINATION.

STAKING TABLE							
POINT NO.	DESCRIPTION	NORTHING	EASTING				
1	CENTER OF RADIUS	774,100.52	1,629,622.63				
2	POINT OF TANGENT	774,097.23	1,629,620.37				
3	CORNER OF FENCE	774,096.42	1,629,664.71				
4	CORNER OF FENCE	774,049.08	1,629,733.71				
5	CORNER OF BLDG	774,047.43	1,629,631.09				
6	CORNER OF BLDG	774,004.55	1,629,601.67				
7	CORNER OF BLDG	773,964.94	1,629,659.39				
8	CORNER OF BLDG	774,007.82	1,629,688.81				
9	CORNER OF PAD	774,036.68	1,629,708.61				
10	CORNER OF SLAB	774,010.23	1,629,723.52				
11	CORNER OF SLAB	773,978.49	1,629,701.74				

NOTE: COORDINATES PROVIDE FOR GENERAL ARRANGEMENT. CONTRACTOR SHALL FIELD VERIFY AND STAKE ALL STRUCTURE LOCATIONS. CONTRACTOR SHALL ADJUST EXACT COORDINATES BASED ON FINIAL CONSTRUCTED DIMENSIONS AND SUBMIT ADJUSTMENTS WITH RECORD DRAWINGS.

⋖							_
ST. MKAKM					PROJECT ENGINEER:	M.J. BENCHICH	
M.					DESIGNED BY:	M.J. BENCHICH	
0:00:31					DRAWN BY:	M.P. KARMANOCKY	
00/	4	CONSTRUCTION	3-8-16	JCJ	CHECKED BY:	M.J. MESSERE	
, US,	3	BUILDING PERMIT COMMENTS	3-3-16	JCJ	CHECKED BT.	MIJ. MESSERE	
701¢	2	BUILDING PERMIT REVIEW	2-26-16	JCJ	IF THIS BAR DOES NOT	0 1/2" 1"	
.: ::	1	REGULATORY REVIEW	1-20-16	JCJ	MEASURE 1" THEN DRAW	0 1// 1	
, 1	RFV	ISSUED FOR	DATE	BY	IS NOT TO FULL SCALE		

ISSUED FOR CONSTRUCTION

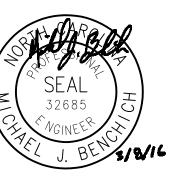


Hazen HAZEN AND SAWYER 4944 PARKWAY PLAZA BLVD, SUITE 375 CHARLOTTE, NORTH CAROLINA 28217 LICENSE NO. : C-0381


NORTH CAROLINA

DAVIDSON WATER INC. HYATTOWN PUMP STATION IMPROVEMENTS

CIVIL GRADING AND STAKING PLAN


DATE:	MARCH 2016
HAZEN NO.:	30961-010
CONTRACT NO	.: 1
DRAWING NUMBER:	C12

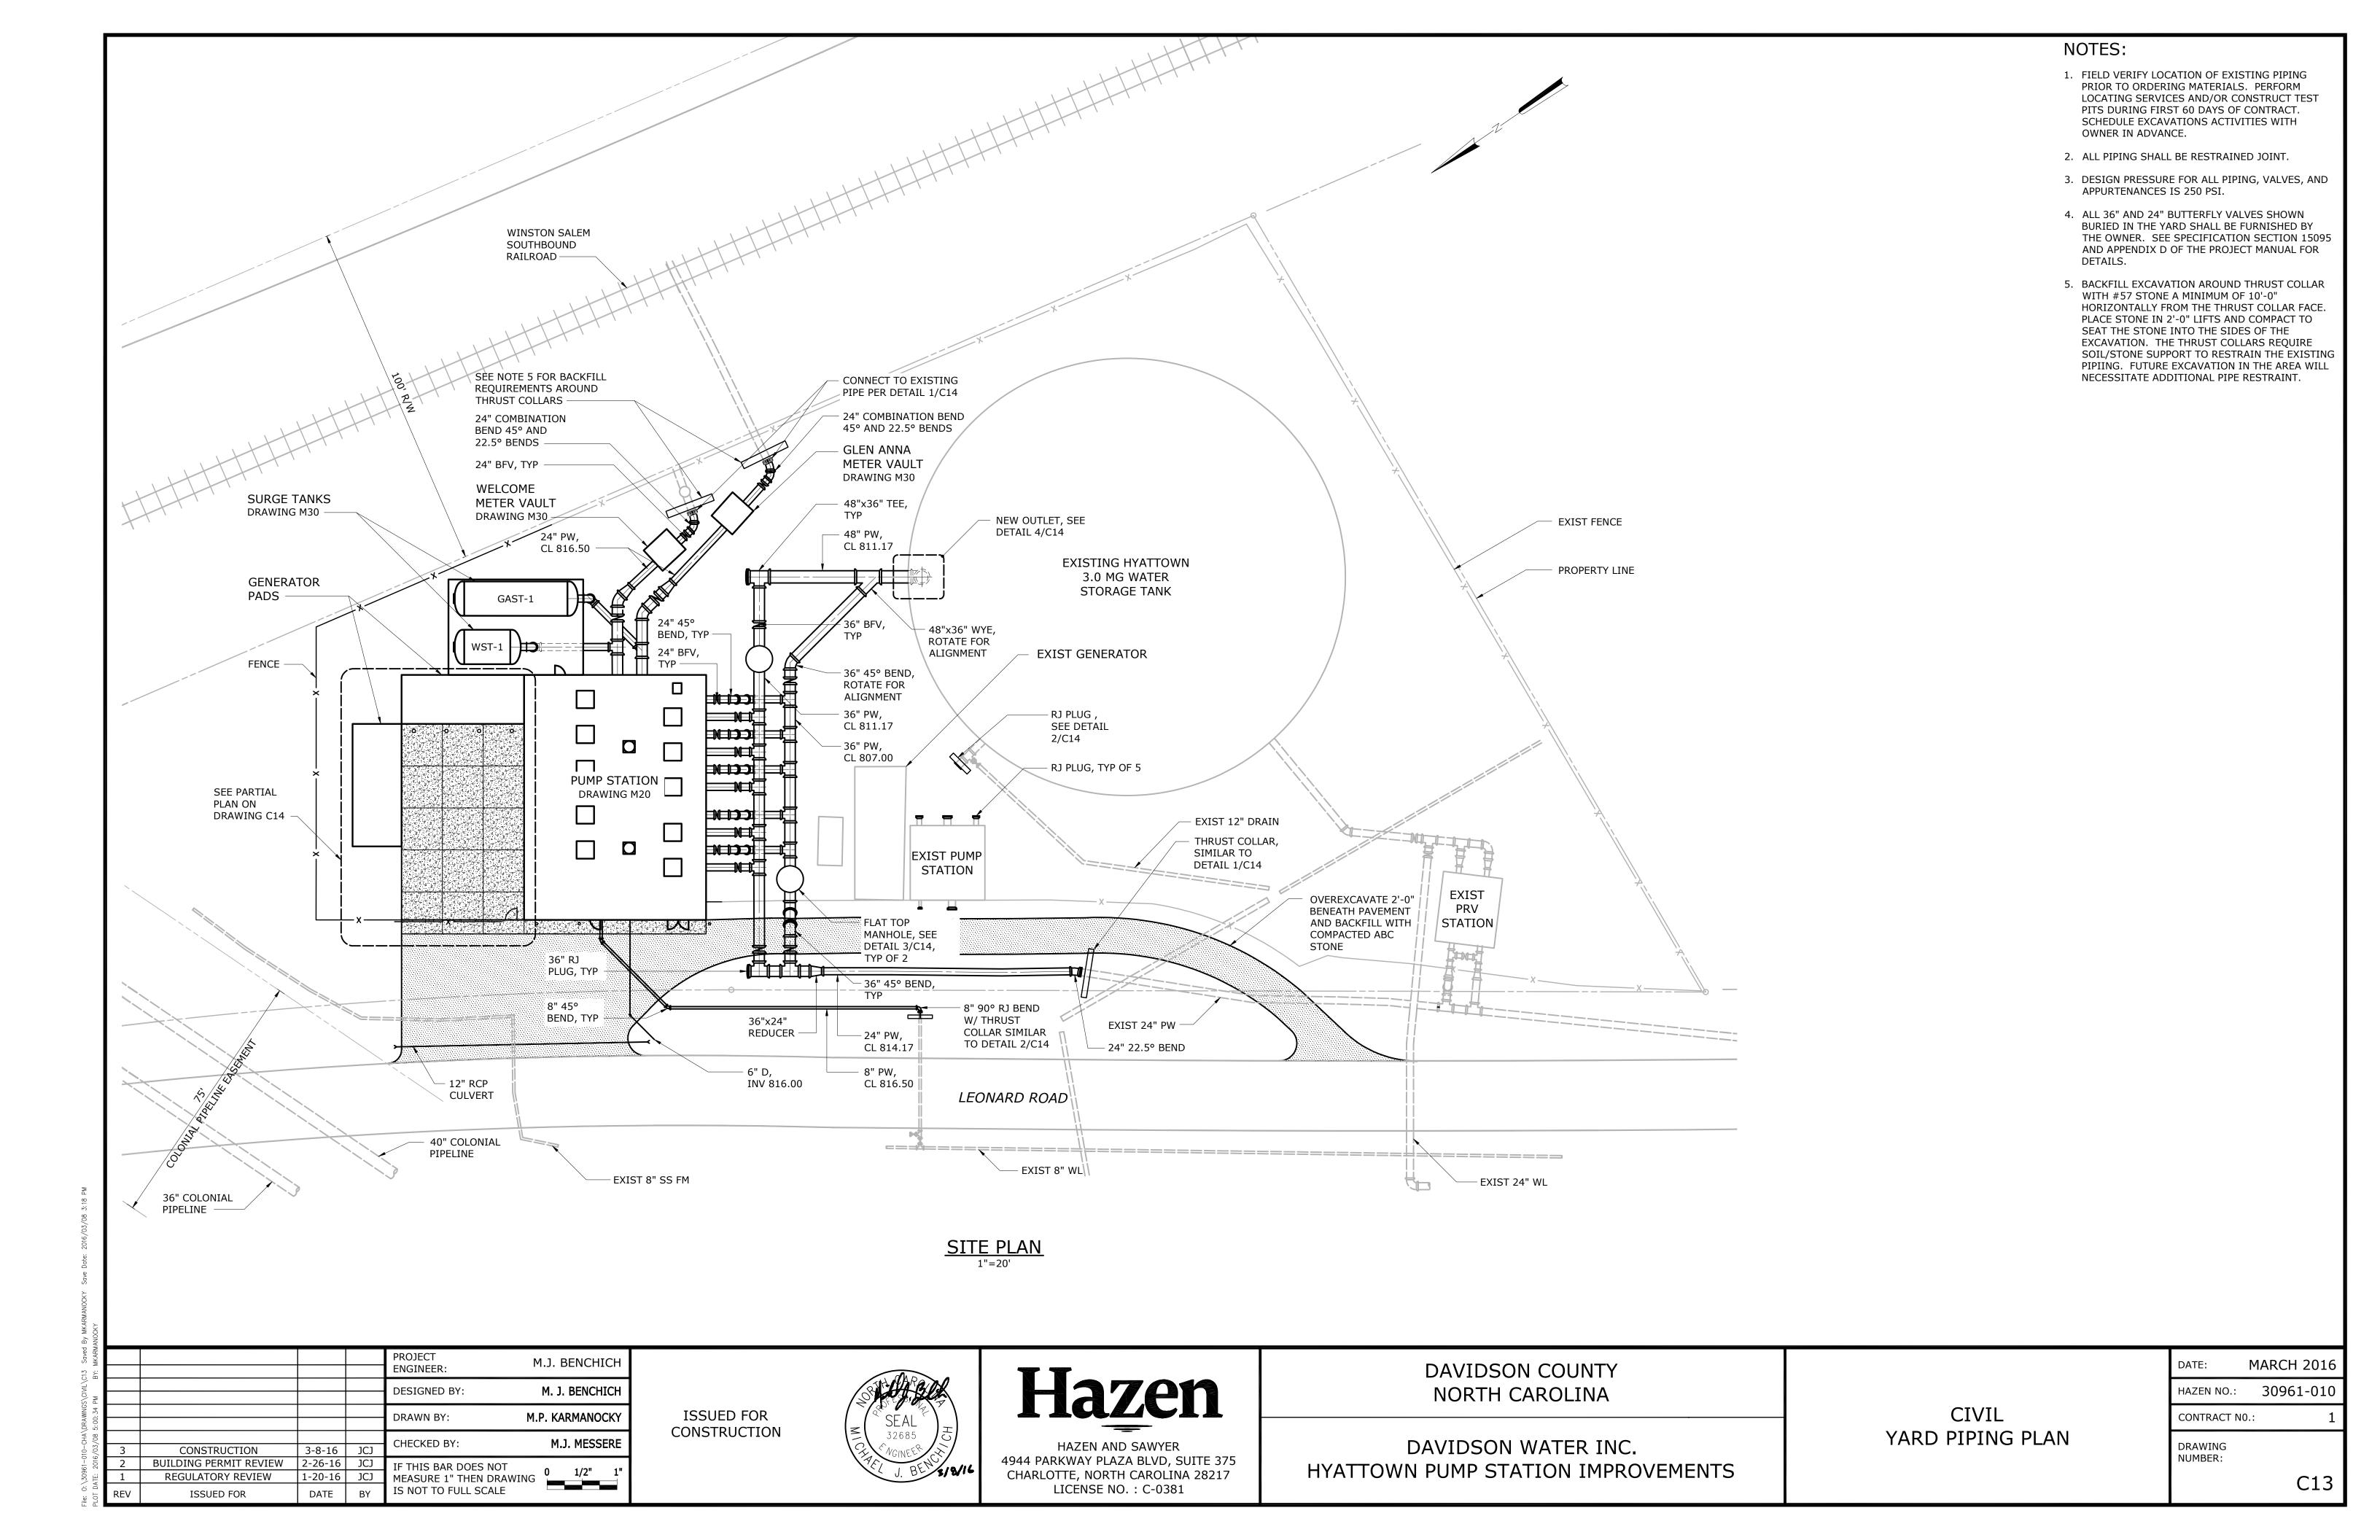

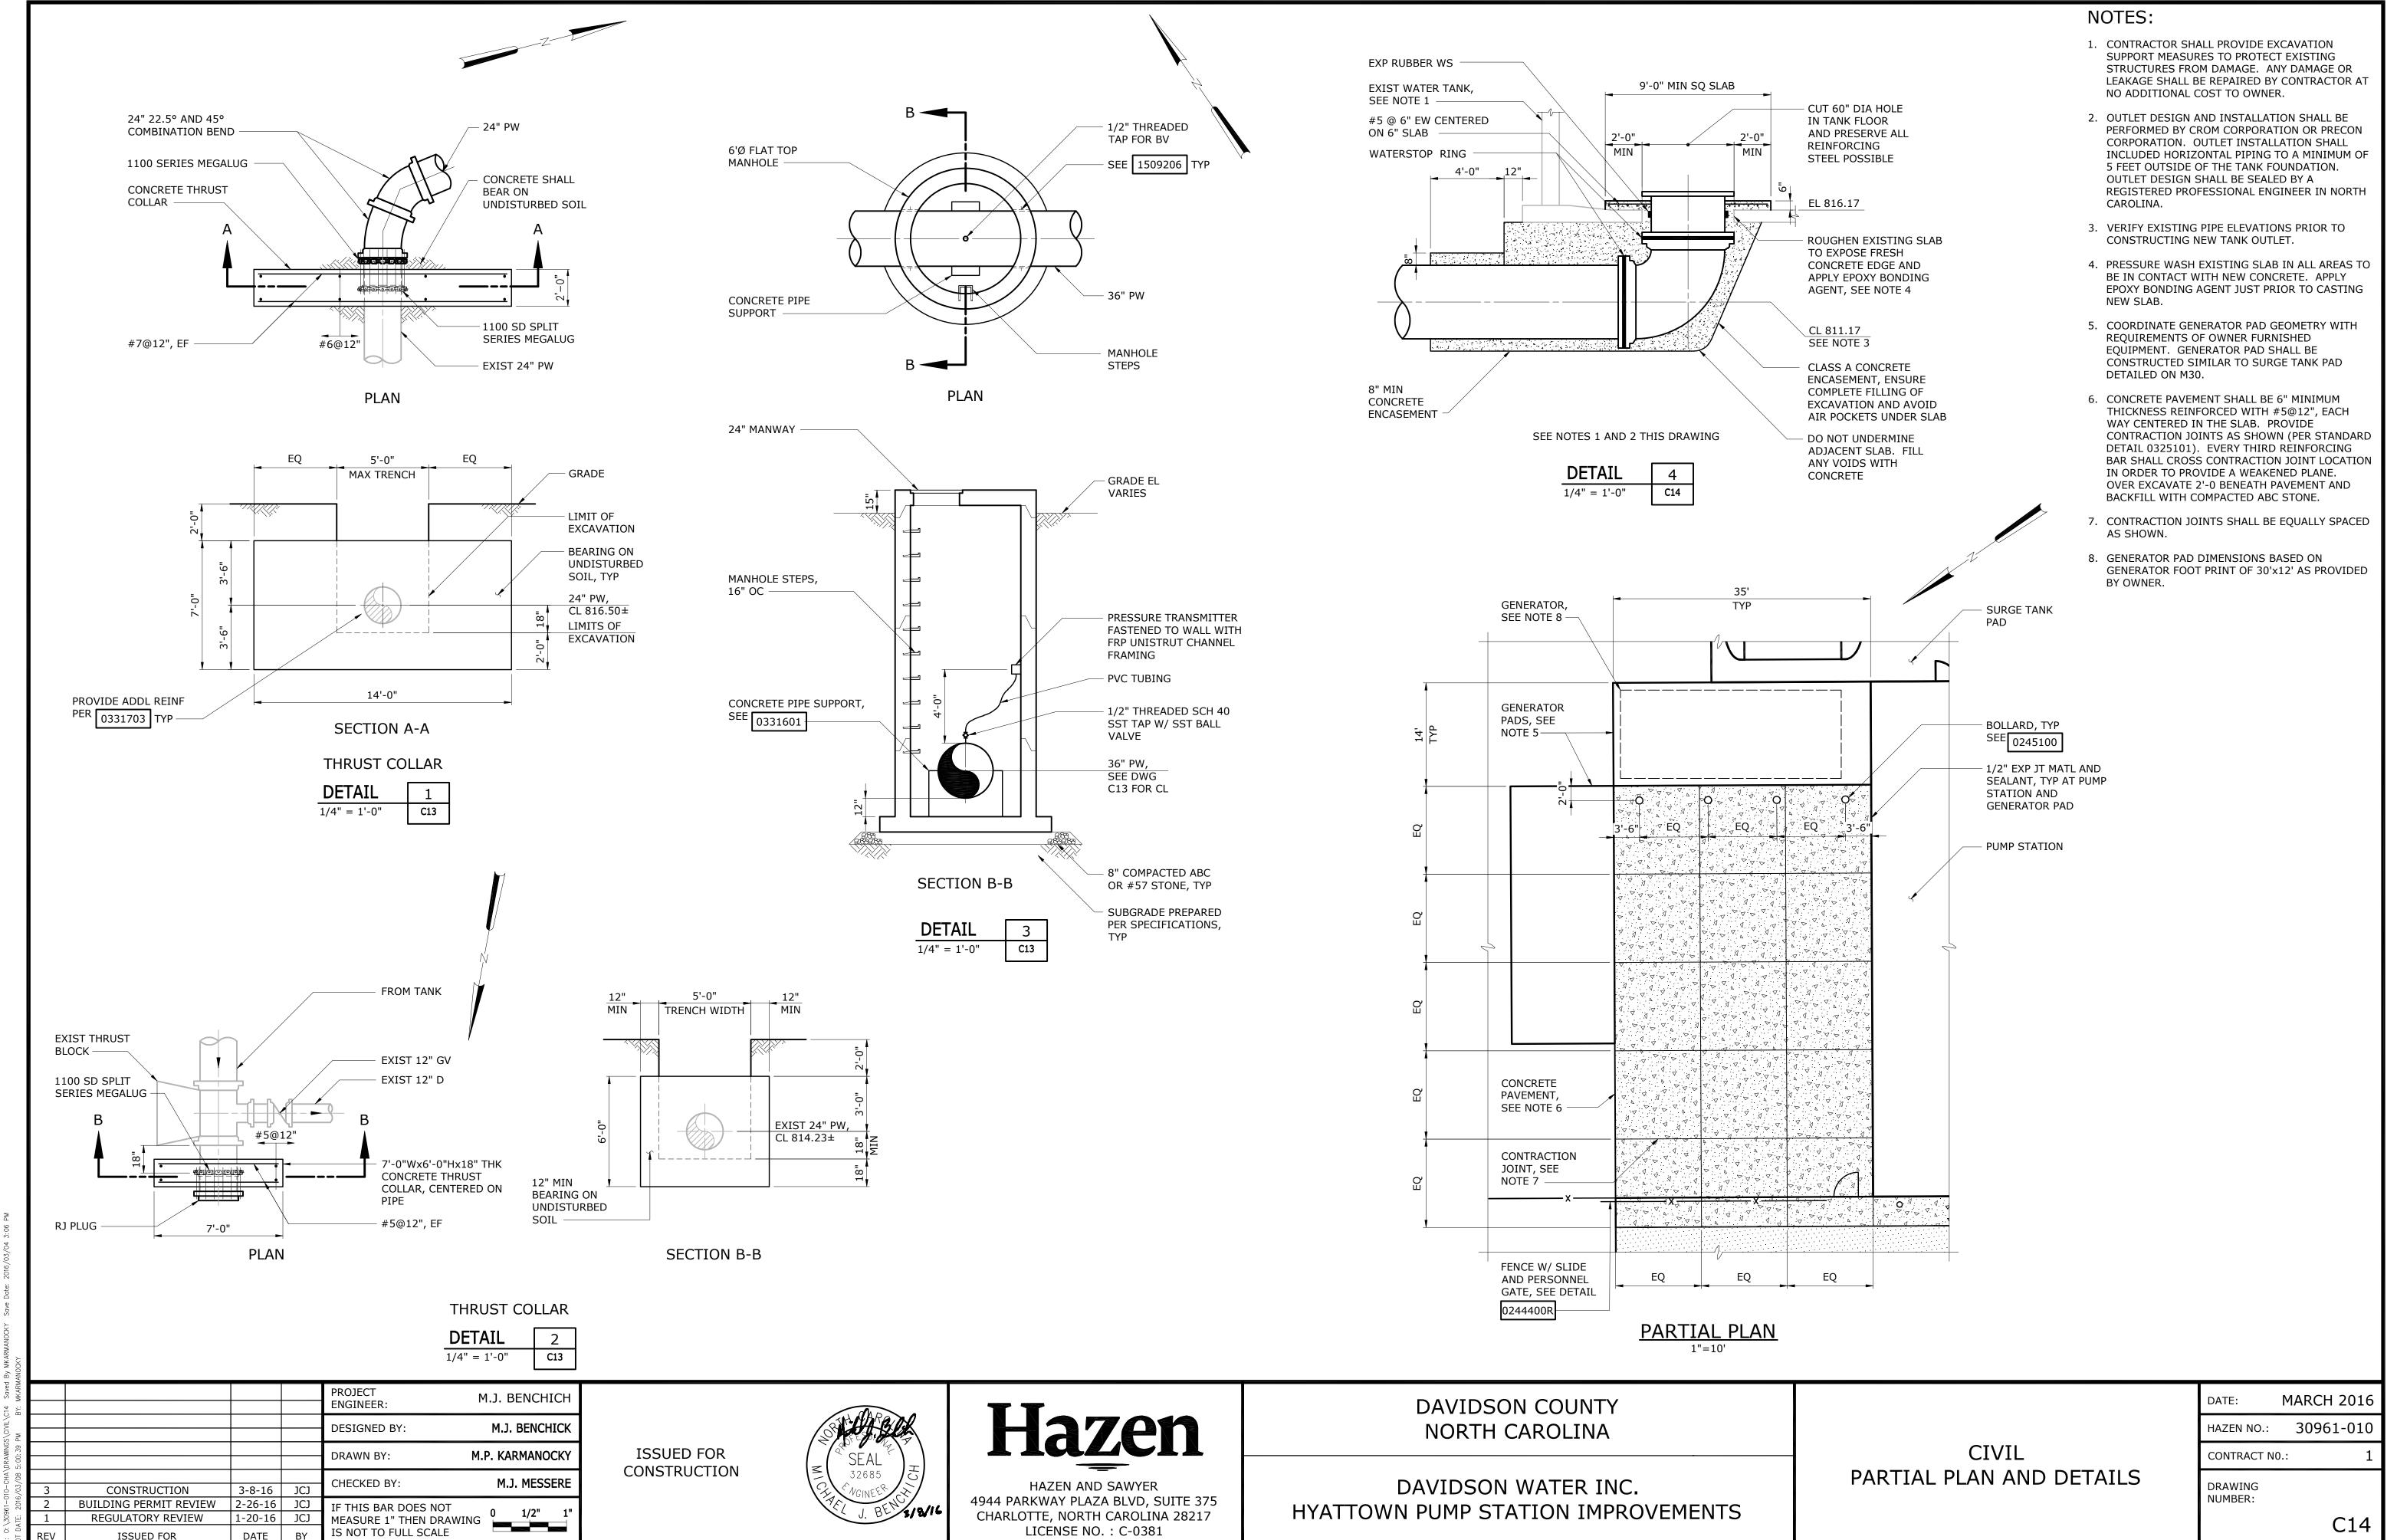


LICENSE NO.: C-0381

**ISSUED FOR** 

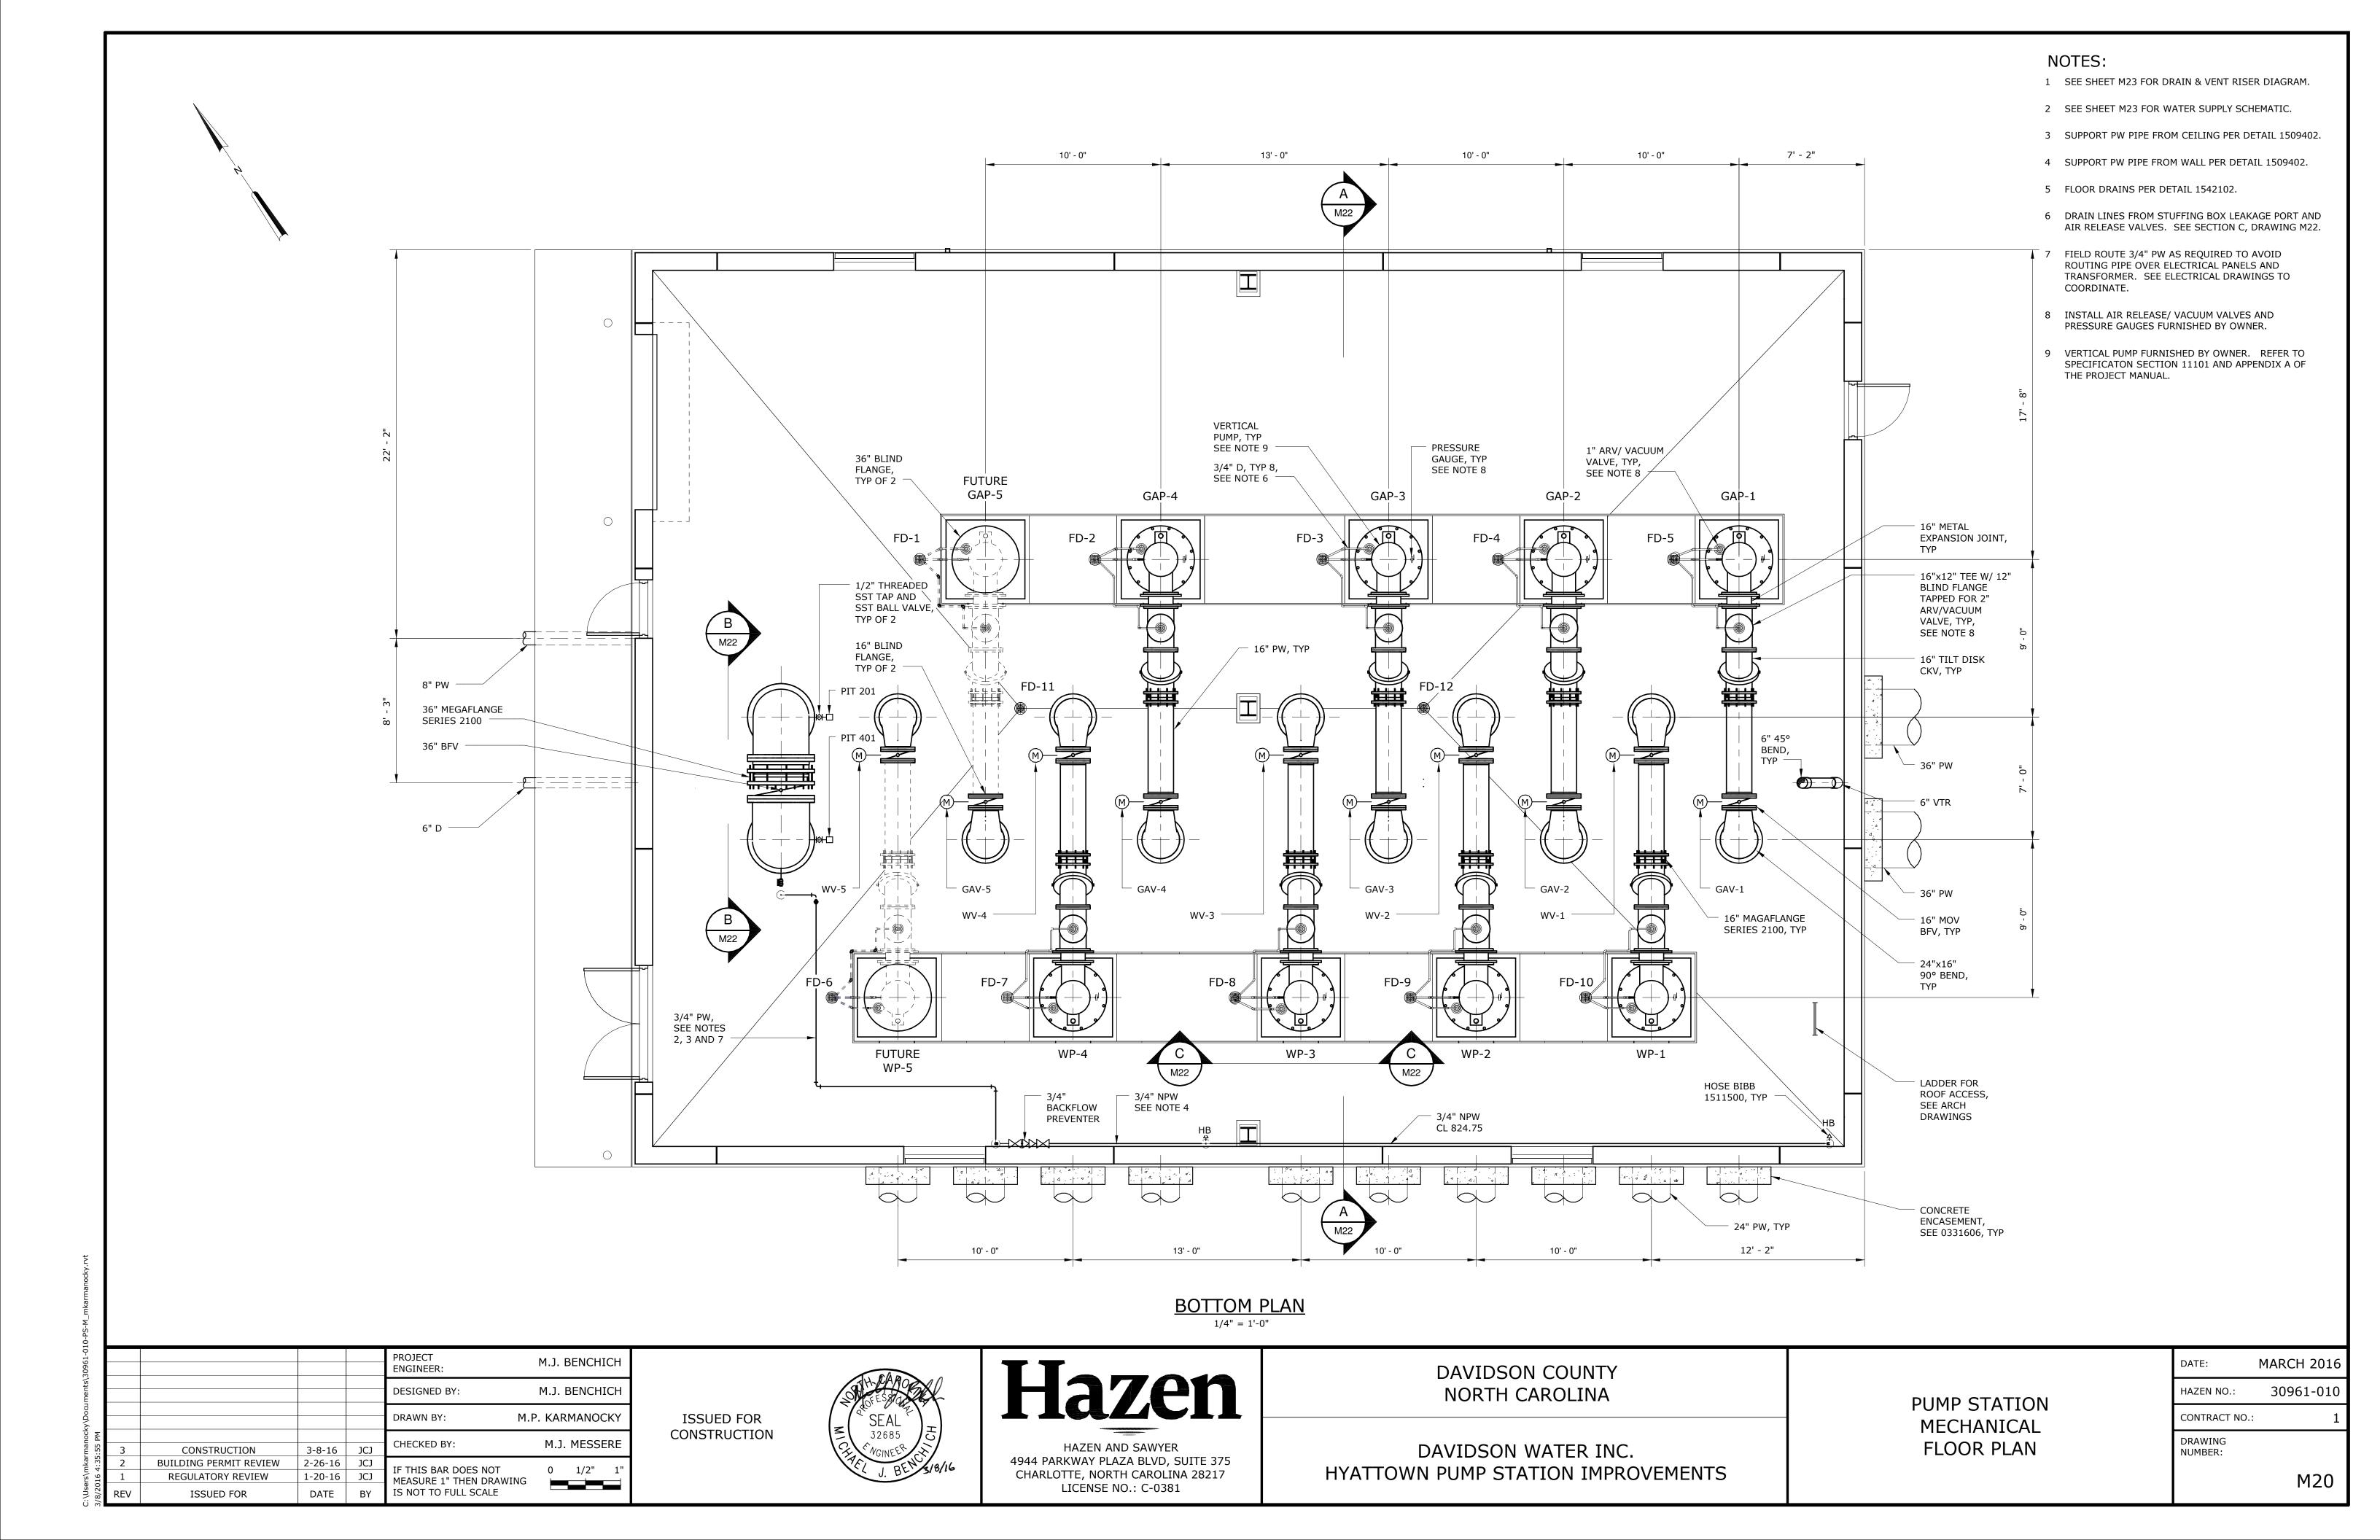

- 1 SLOPE HORIZONTAL DRAIN PIPING 1/8" PER FOOT MINIMUM OR AS OTHERWISE REQUIRED BY DAVIDSON COUNTY BUILDING INSPECTORS.
- 2 ALL PIPING BELOW FLOOR SHALL BE CONCRETE ENCASED PER DETAIL 0331606. EXCAVATION SHALL BE FILLED WITH #57 STONE OR FLOWABLE FILL.

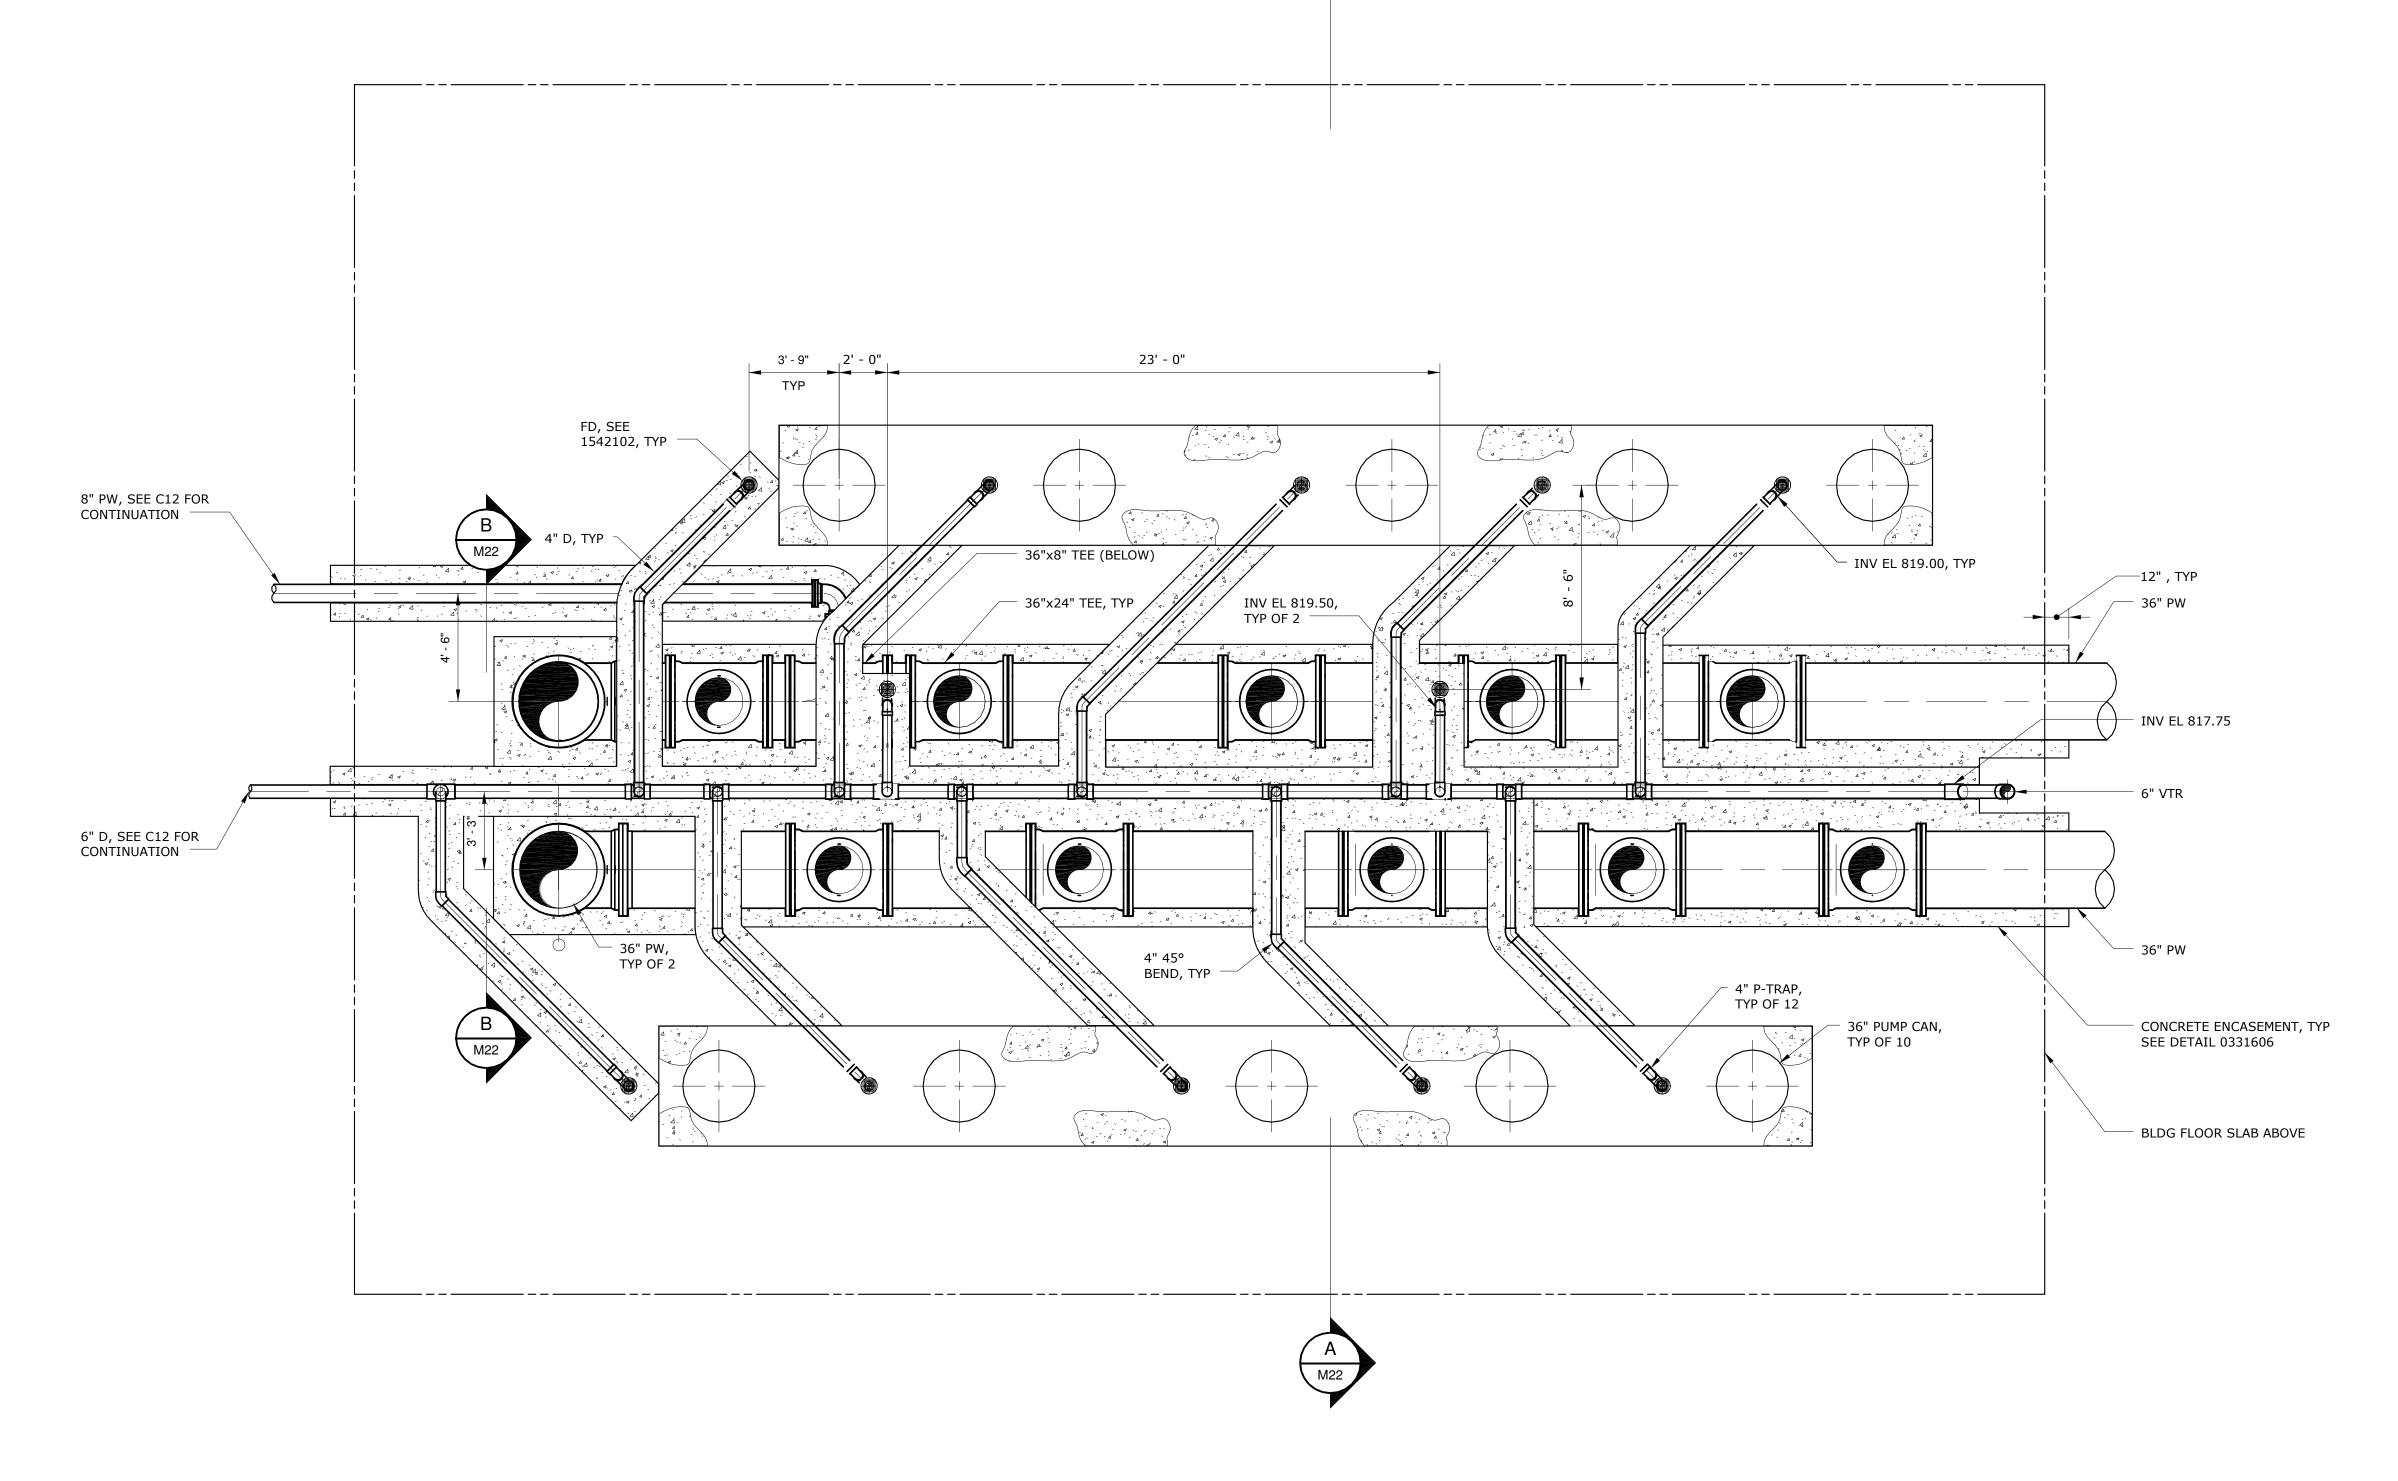

BELOW GRADE PLAN
1/4" = 1'-0"

					PROJECT ENGINEER:	M.J. BENCHICH	
					DESIGNED BY:	M.J. BENCHICH	
					DRAWN BY: M	1.P. KARMANOCKY	
:57 PM	3	CONSTRUCTION	3-8-16	JCJ	CHECKED BY:	M.J. MESSERE	
4:35	2	BUILDING PERMIT REVIEW	2-26-16	JCJ	IF THIS BAD DOES NOT	0 1/2" 1"	
2016	1	REGULATORY REVIEW	1-20-16	JCJ	IF THIS BAR DOES NOT MEASURE 1" THEN DRAWING	· -/	
8/20	REV	ISSUED FOR	DATE	BY	IS NOT TO FULL SCALE		

ISSUED FOR CONSTRUCTION



Hazen	


DAVIDSON WATER INC. HYATTOWN PUMP STATION IMPROVEMENTS

DAVIDSON COUNTY


NORTH CAROLINA


PUMP STATION MECHANICAL BELOW GRADE PLAN

DATE:	MARCH 2016
HAZEN NO.:	30961-010
CONTRACT NO.:	1
DRAWING NUMBER:	
	M21

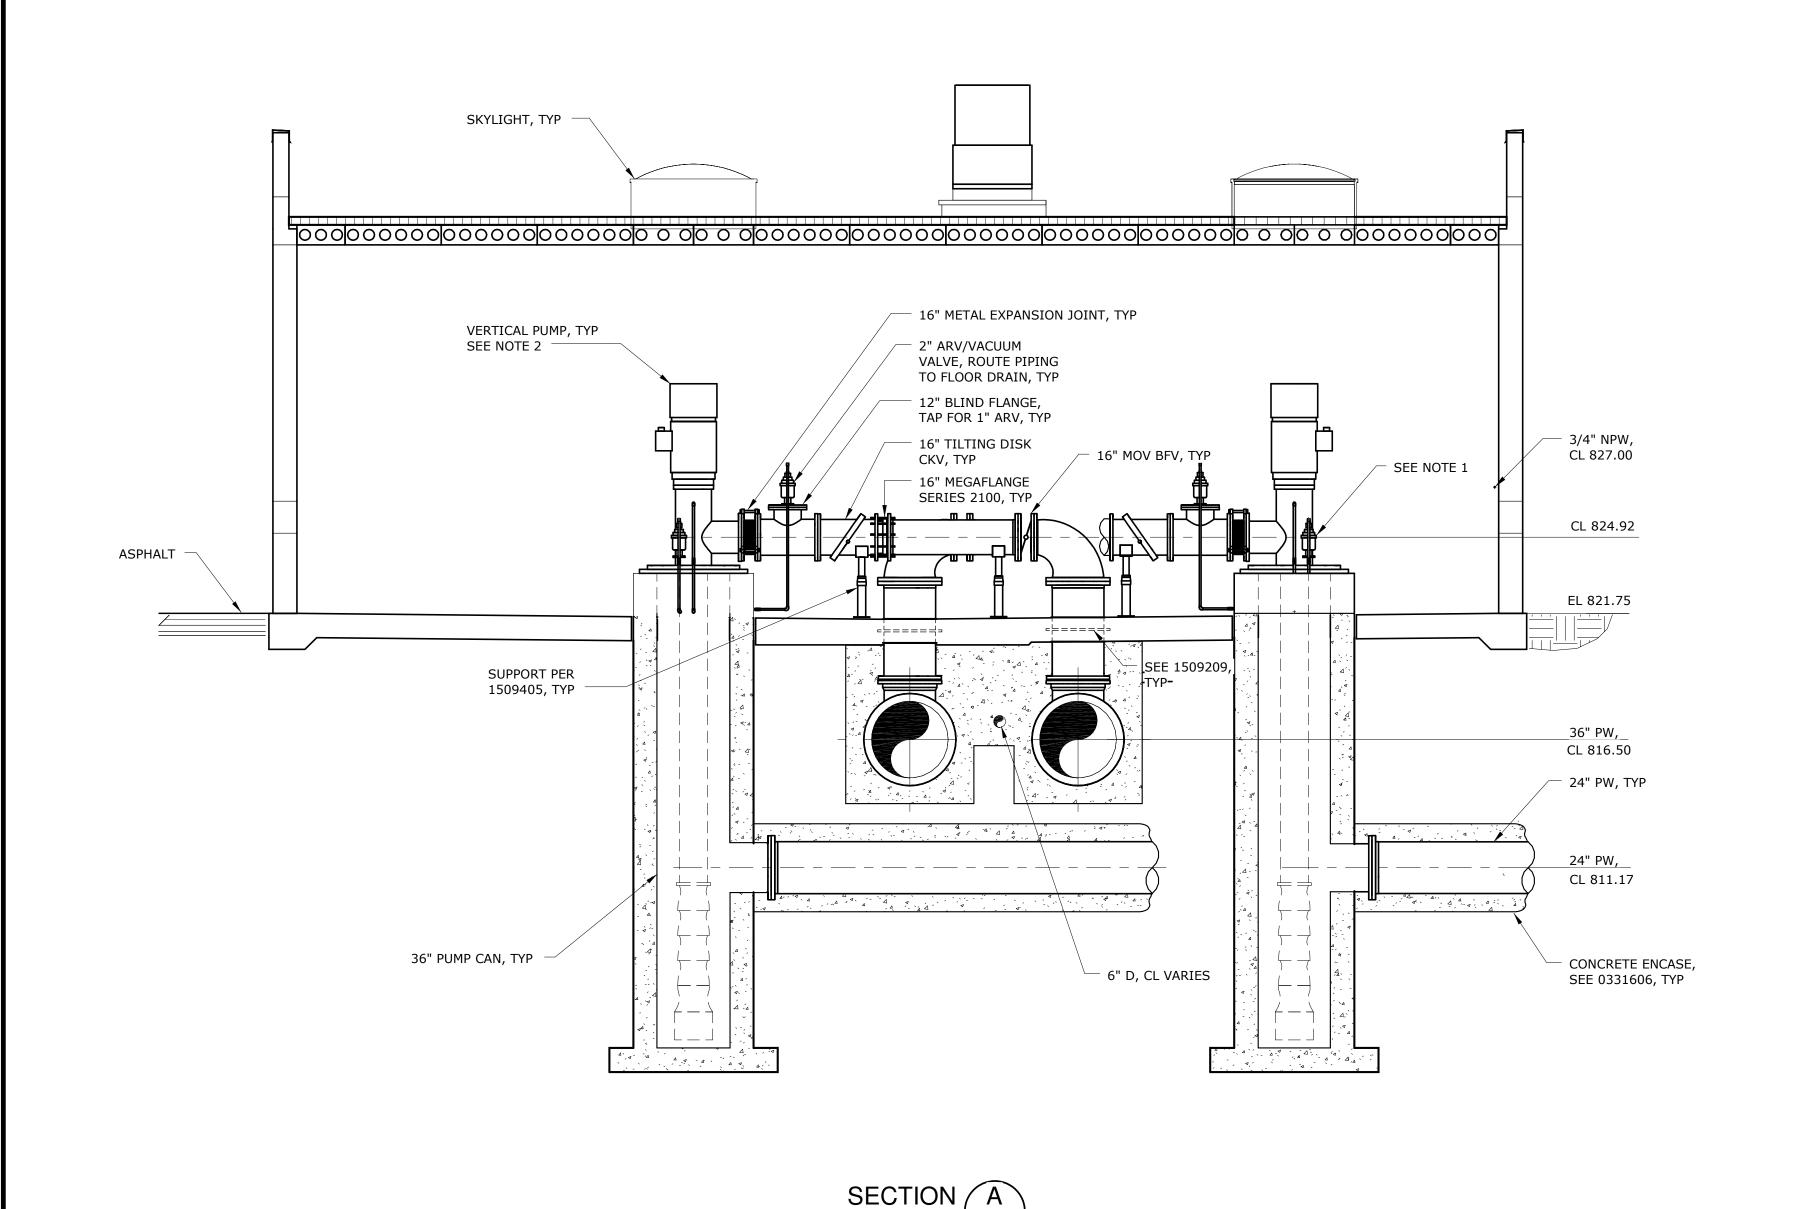

- 1 FURNISH AND INSTALL DEVICES AND INSTRUMENTATION ON DISCHARGE HEAD AND BASE AS INDICATED IN SPECIFICATION SECTION 11101 AND APPENDIX A OF PROJECT MANUAL.
- 2 ALL VERTICAL PUMPS ARE TO BE FURNISHED BY OWNER. COORDINATE INSTALLATION WITH PUMP MANUFACTURER.
- 3 SUPPORT FROM CEILING PER DETAIL 1509402.
- 3/4" PW PIPING SHALL BE SCHEDULE 40 SST FROM THREADED TAP TO FIRST PIPE SUPPORT ON CEILING. 3/4" PW PIPING SHALL BE SCH 80 PVC OTHERWISE.

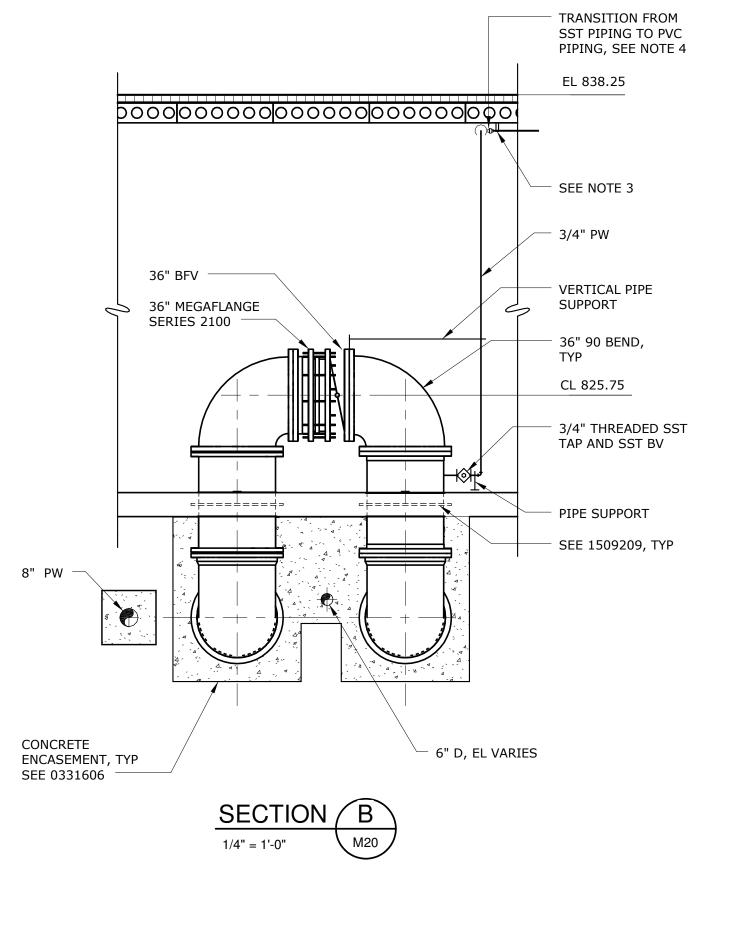

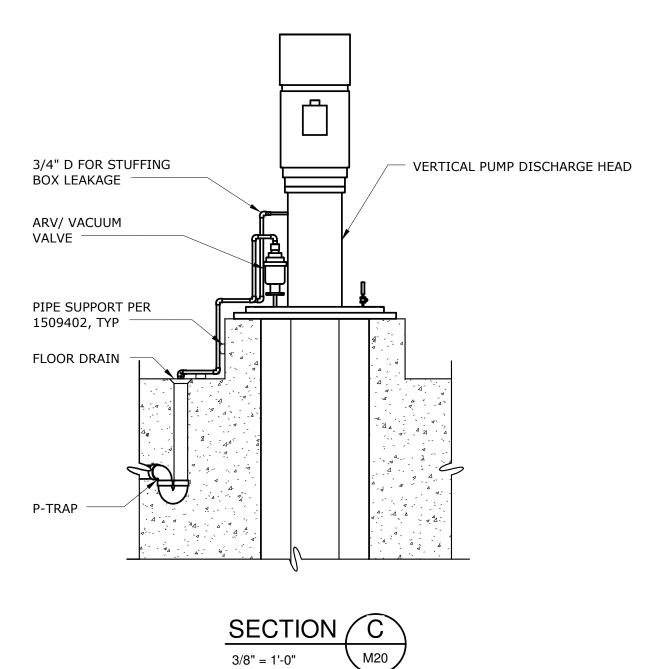


					PROJECT ENGINEER:	M.J. BENCHICH
					DESIGNED BY:	M.J. BENCHICH
					DRAWN BY: M.	P. KARMANOCKY
:59 PM	3	CONSTRUCTION	3-8-16	JCJ	CHECKED BY:	M.J. MESSERE
4:35:59	2	BUILDING PERMIT REVIEW	2-26-16	JCJ	IF THIS BAD DOES NOT	0 1/2" 1"
	1	REGULATORY REVIEW	1-20-16	JCJ	IF THIS BAR DOES NOT MEASURE 1" THEN DRAWING	0 1/2" 1"
/8/2016	REV	ISSUED FOR	DATE	BY	IS NOT TO FULL SCALE	

ISSUED FOR CONSTRUCTION 

S

CONSTRUCTION

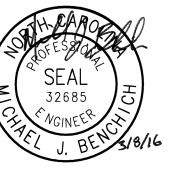



HAZEN AND SAWYER 4944 PARKWAY PLAZA BLVD, SUITE 375 CHARLOTTE, NORTH CAROLINA 28217 LICENSE NO.: C-0381 DAVIDSON COUNTY NORTH CAROLINA


DAVIDSON WATER INC.
HYATTOWN PUMP STATION IMPROVEMENTS


PUMP STATION MECHANICAL SECTIONS

DATE:	MARCH 2016
HAZEN NO.:	30961-010
CONTRACT NO.:	1
DRAWING NUMBER:	
	M22

SEE NOTE 2


- 1 ROUTE NPW PIPING AROUND LOUVERS AS REQUIRED.
- BEND AWAY FROM WALL NEAR CEILING AS REQUIRED TO CENTER RISER PIPE THROUGH CEILING PENETRATION.

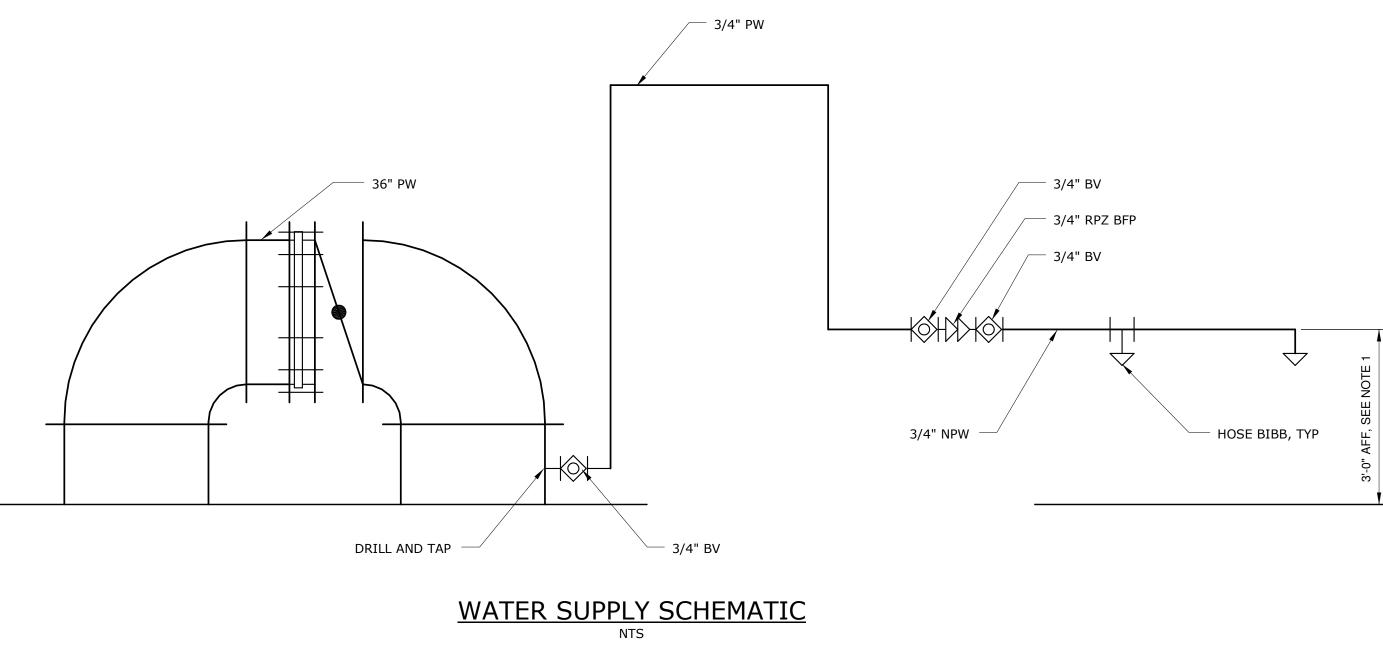

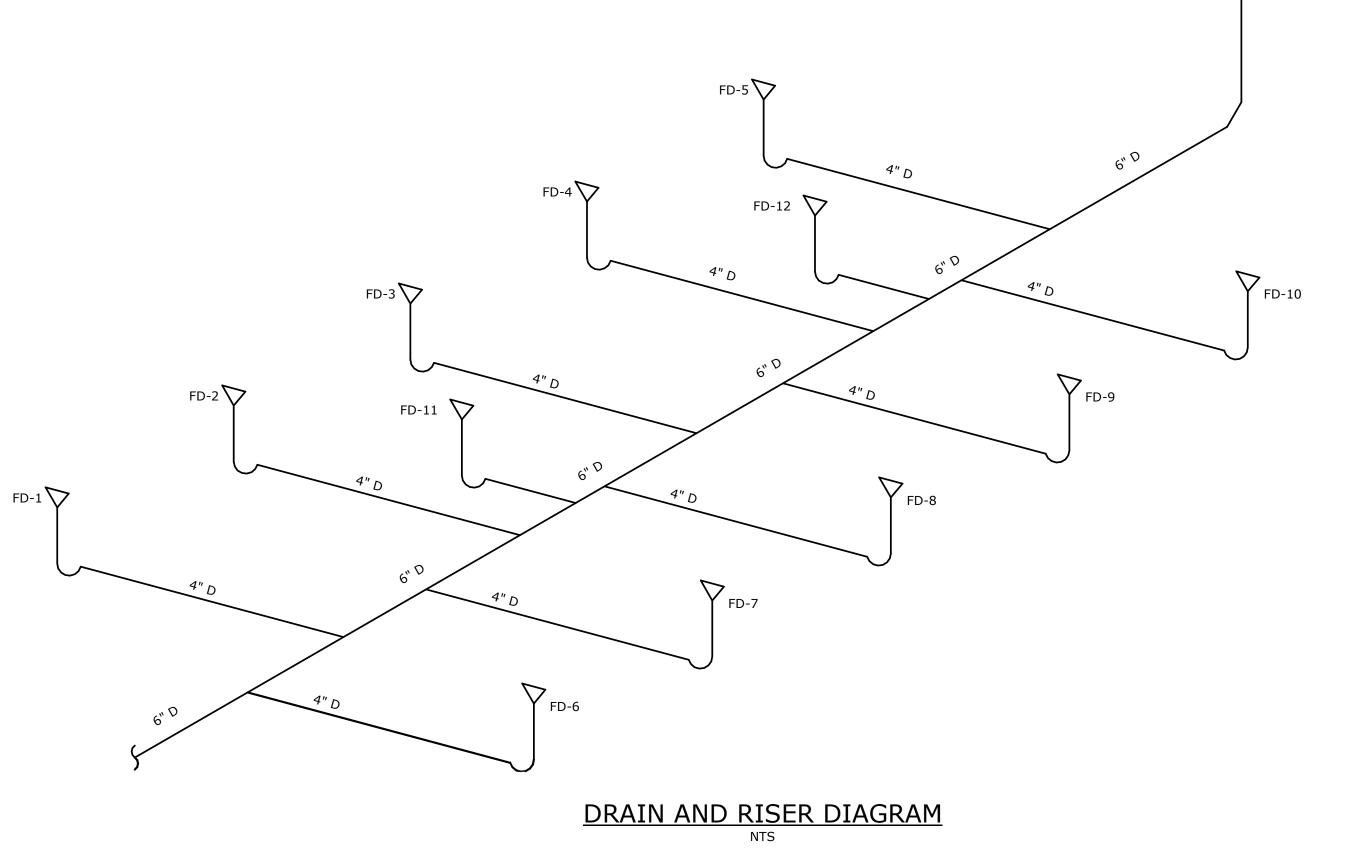

					PROJECT ENGINEER:	M.J. BENCHICH
					DESIGNED BY:	M.J. BENCHICH
					DRAWN BY:	W. MAXWELL
:59 PM	3	CONSTRUCTION	3-8-16	JCJ	CHECKED BY:	M.J. MESSERE
4:35:	2	BUILDING PERMIT REVIEW	2-26-16	JCJ	IF THIS BAD DOES NOT	0 1/2" 1"
16	1	REGULATORY REVIEW	1-20-16	JCJ	IF THIS BAR DOES NOT MEASURE 1" THEN DRAWING	0 1/2" 1"
8/2016	REV	ISSUED FOR	DATE	BY	IS NOT TO FULL SCALE	

ISSUED FOR SEA 326 CF NGIN

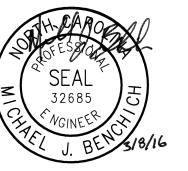


Hazen
HAZEN AND SAWYER 4944 PARKWAY PLAZA BLVD, SUITE 375 CHARLOTTE, NORTH CAROLINA 28217 LICENSE NO.: C-0381

DAVIDSON COUNTY
NORTH CAROLINA

DAVIDSON WATER INC.
HYATTOWN PUMP STATION IMPROVEMENTS

PUMP STATION
<b>MECHANICAL</b>
<b>SCHEMATICS</b>

DATE:	MARCH 2016
HAZEN NO.:	30961-010
CONTRACT NO.:	1
DRAWING NUMBER:	
	M23

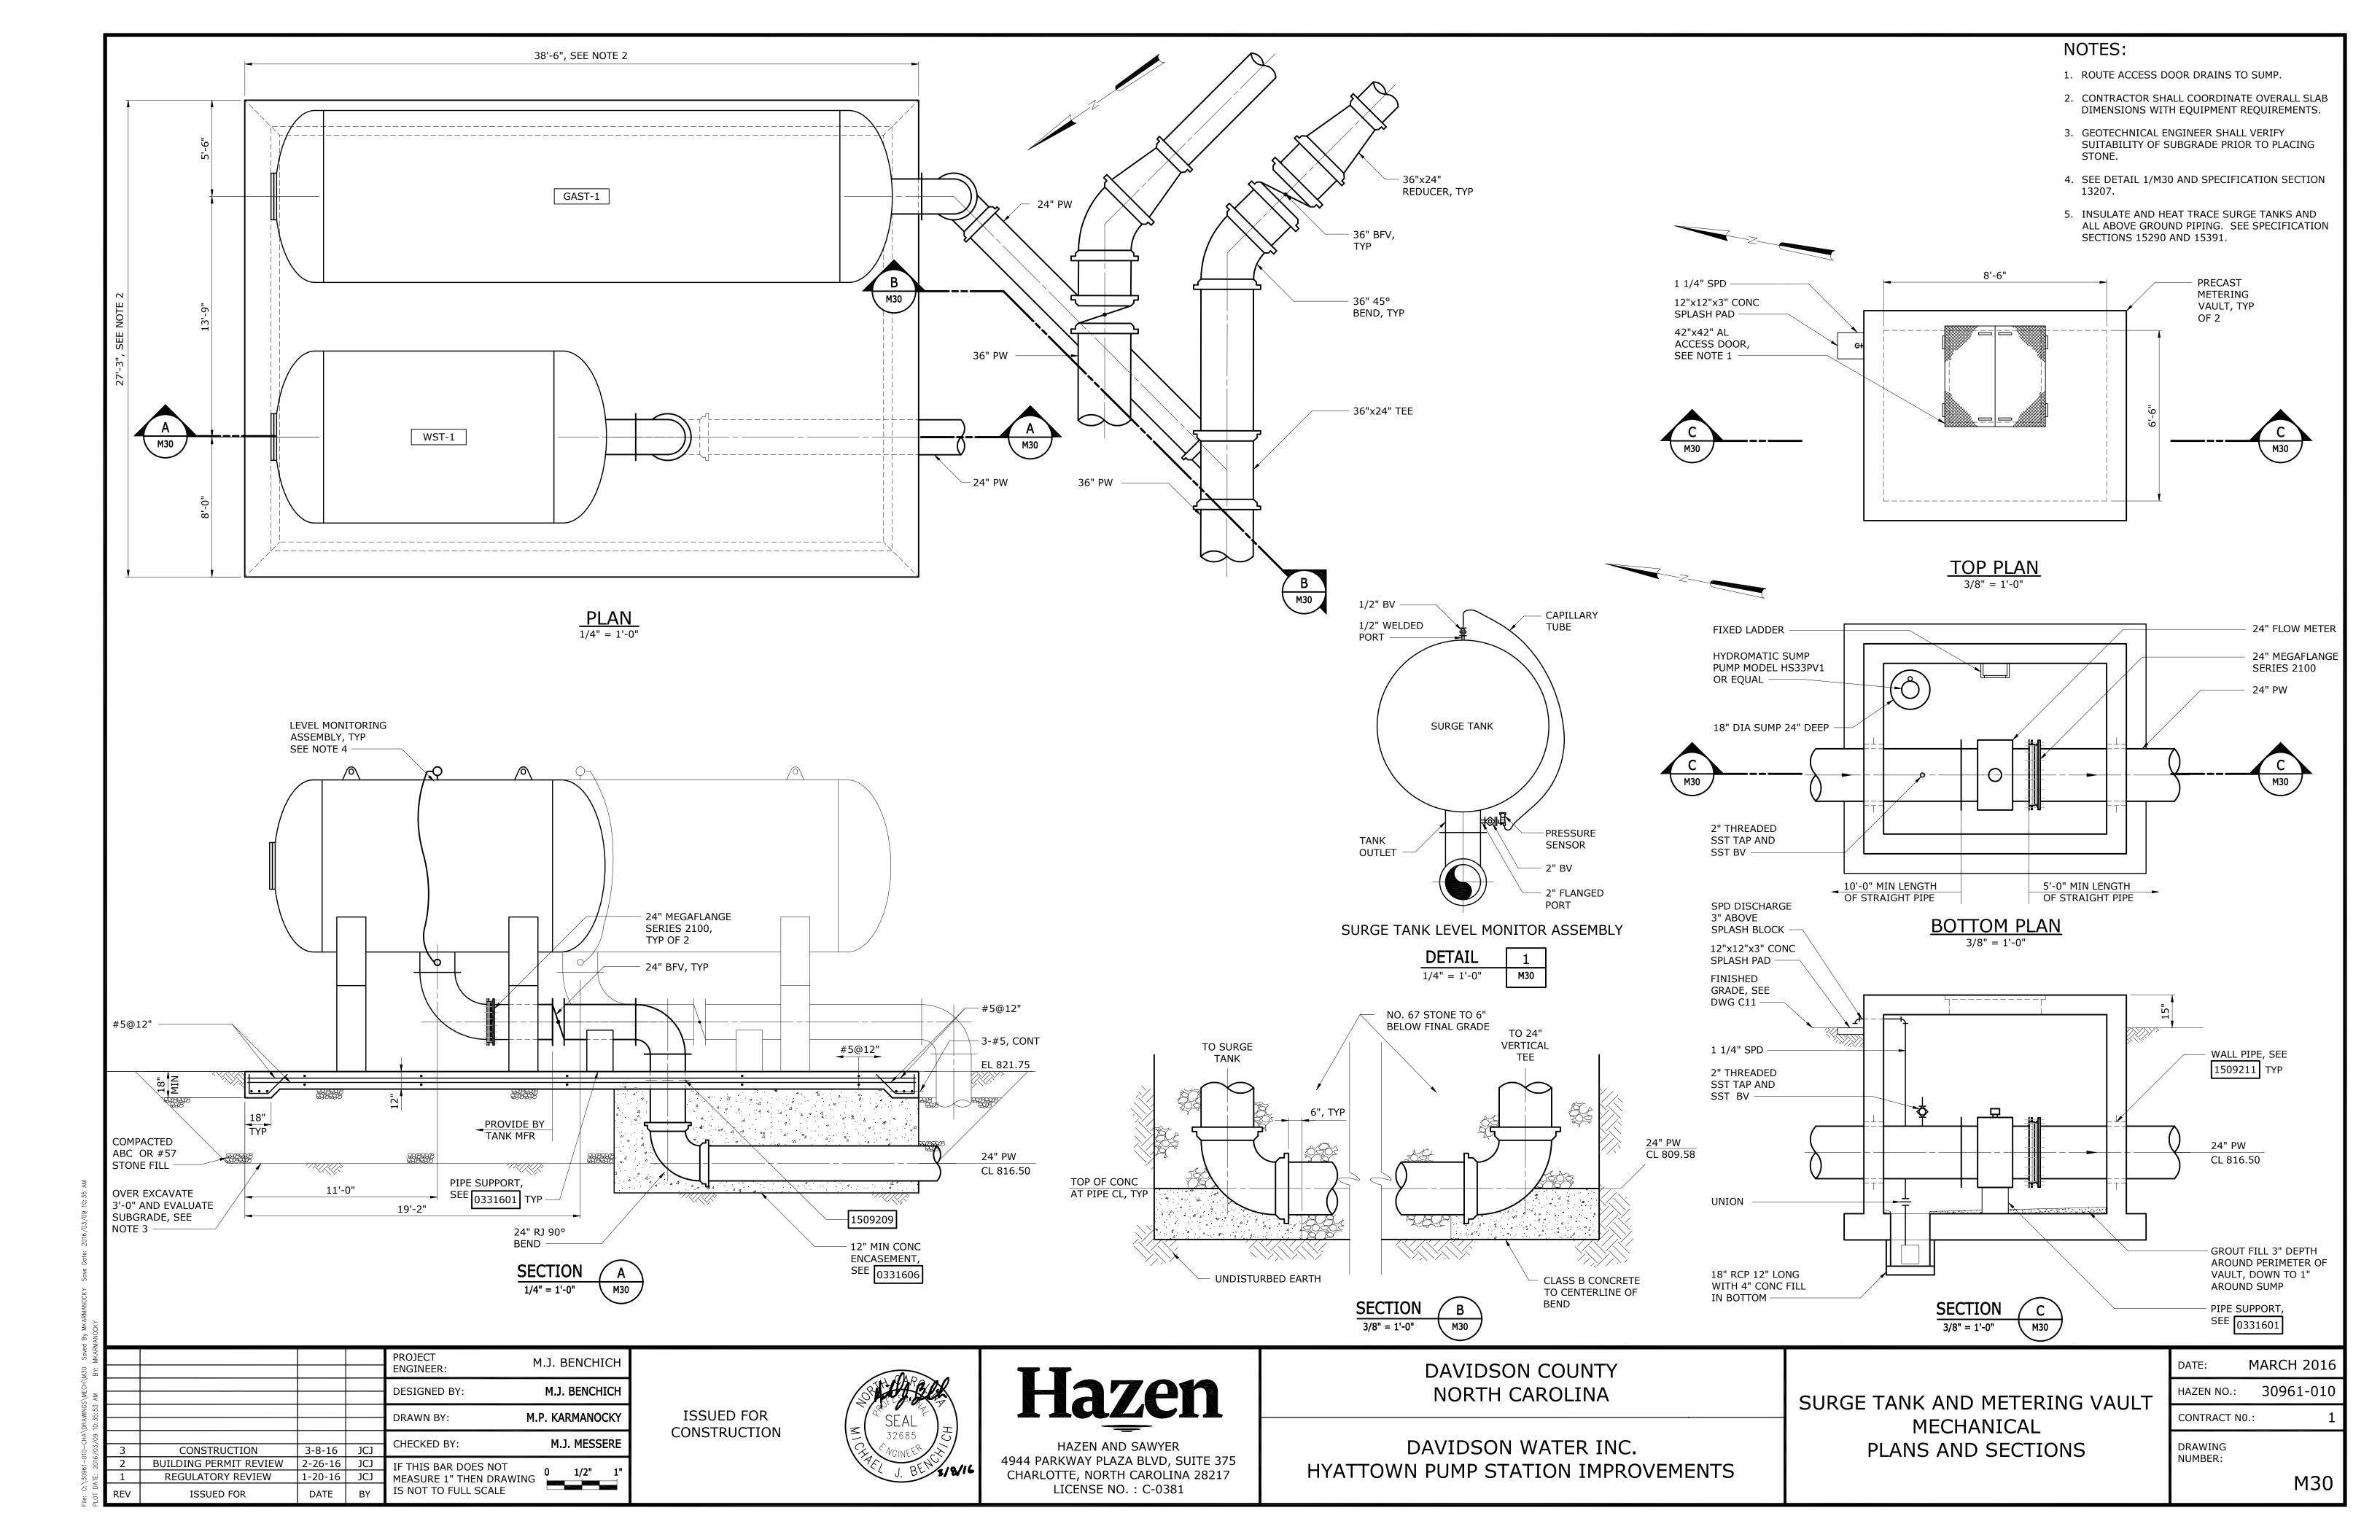

## **GENERAL STRUCTURAL NOTES**

- G-1 THESE NOTES ARE GENERAL AND SUPPLEMENT THE SPECIFICATIONS. THESE NOTES APPLY TO THE ENTIRE PROJECT UNLESS MODIFIED OR NOTED OTHERWISE IN THE CONTRACT DOCUMENTS.
- G-2 STANDARD DETAILS SHALL BE USED WHEN REFERRED TO OR WHEN NO MORE RESTRICTIVE OR DIFFERENT DETAILS ARE SHOWN ON THE
- G-3 DESIGN IS IN ACCORDANCE WITH AND CONSTRUCTION SHALL COMPLY WITH THE PROVISIONS OF THE [ STATE ] BUILDING CODE. THE DESIGN LOADS AND OTHER DESIGN VALUES GIVEN IN NOTES G-4 THROUGH G-7 WERE USED FOR DESIGN OF STRUCTURES UNLESS NOTED OTHERWISE

#### G-4 LIVE LOADS:

STRUCTURE	ROOF	BOTTOM / GROUND FLOOR
PUMP STATION	30 PSF	300 PSF

- ALL STAIRWAYS, LANDINGS AND PLATFORMS ARE DESIGNED FOR A LIVE LOAD = 100 PSF UNLESS NOTED OTHERWISE.

#### G-5 SNOW LOAD:

GROUND SNOW LOAD (Pg) = 15 PSFFLAT-ROOF SNOW LOAD (Pf) = 18 PSFSNOW EXPOSURE FACTOR (Ce) = 0.9SNOW LOAD IMPORTANCE FACTOR (Is) = 1.2THERMAL FACTOR (Ct) = 1.0

ROOF PLANKS SHALL BE DESIGNED FOR THE EFFECTS OF DRIFTING SNOW AS REQUIRED BY THE NORTH CAROLINA BUILDING CODE. IT SHALL ALSO BE PERMISSIBLE TO DESIGN ALL PLANKS FOR A UNIFORM EQUIVALENT TO THE MAXIMUM ROOF SNOW LOAD OF 48 PSF.

#### G-6 WIND DESIGN CRITERIA:

BASIC WIND SPEED = 90 MPH WIND IMPORTANCE FACTOR (Iw) = 1.15WIND EXPOSURE = C

PARAMETER STRUCTURE	PRESSURE COEFFICIENT GCpi	WIND DESIGN PRESSURE	COMPONENTS AND CLADDING	LATERAL LOAD RESISTING SYSTEM
PUMP STATION	+/- 0.18	20 PSF	27 PSF	MASONRY SHEAR WALL

### G-7 SEISMIC LOAD:

OCCUPANCY CATEGORY = IV SEISMIC IMPORTANCE FACTOR (Ie) = 1.50 SITE CLASS = DMAPPED SPECTRAL RESPONSE ACCELERATIONS (Ss/S1) = 0.241/0.090SPECTRAL RESPONSE ACCELERATIONS (SMS/SM1) = 0.386/0.215 SPECTRAL RESPONSE COEFFICIENTS (SDS/SD1) = 0.257/0.143 SEISMIC DESIGN CATEGORY = D

PARAMETER STRUCTURE	BASIC STRUCTURAL SYSTEM	DESIGN BASE SHEAR	SEISMIC RESPONSE COEFFICIENT Cs	RESPONSE MODIFICATION COEFFICIENT R	ANALYSIS PROCEDURE
PUMP STATION	MASONRY SHEAR WALL	43.5 KIPS	0.0771	5.0	EQUIVALENT LATERAL FORCE

- G-8 ALL DIMENSIONS INDICATED (\*) SHALL BE VERIFIED EITHER BY FIELD MEASUREMENTS FOR EXISTING STRUCTURES OR BY SHOP DRAWINGS FOR EQUIPMENT FURNISHED. STRUCTURAL DIMENSIONS NOT SHOWN BUT CONTROLLED BY OR RELATED TO EQUIPMENT SHALL BE VERIFIED BY THE CONTRACTOR WITH THE MANUFACTURER PRIOR TO CONSTRUCTION.
- G-9 THE CONTRACTOR IS RESPONSIBLE FOR VERIFYING ALL EXISTING INFORMATION IN THE FIELD AS REQUIRED FOR NEW WORK.
- G-10 IF A CONFLICT IS FOUND BETWEEN DIFFERENT PORTIONS OF THE CONTRACT DOCUMENTS, THE CONTRACTOR SHALL NOTIFY THE ENGINEER IMMEDIATELY. CONTINUED CONSTRUCTION OF THE AREA IN CONFLICT SHALL BE AT THE CONTRACTOR'S OWN RISK UNTIL THE CONFLICT IS
- G-11 EQUIPMENT ANCHOR BOLT SIZES, TYPES, EMBEDMENT AND PATTERNS SHALL BE VERIFIED WITH THE MANUFACTURER. ALL BOLT PATTERNS SHALL BE TEMPLATED TO INSURE ACCURACY OF PLACEMENT.
- G-12 STRUCTURAL DRAWINGS SHALL BE USED IN COORDINATION WITH THE DRAWINGS OF ALL OTHER DISCIPLINES AND MANUFACTURER'S SHOP DRAWINGS.
- G-13 STRUCTURES HAVE BEEN DESIGNED FOR OPERATIONAL LOADS ON THE COMPLETED STRUCTURE. DURING CONSTRUCTION, THE STRUCTURES SHALL BE PROTECTED BY BRACING AND TEMPORARY SUPPORTS WHEREVER EXCESSIVE CONSTRUCTION LOADS MAY OCCUR. OVERSTRESSING OF ANY STRUCTURAL ELEMENT IS PROHIBITED.
- G-14 IF CONTRACTOR DESIRES TO TEMPORARILY PLACE OR MOVE LOADS ON OR ADJACENT TO EXISTING STRUCTURES OR UTILITIES DURING CONSTRUCTION PROCESS. CONTRACTOR IS EXCLUSIVELY RESPONSIBLE FOR MAINTAINING STRUCTURAL INTEGRITY AND AVOIDING OVERSTRESSING AND DAMAGING EXISTING STRUCTURES AND UTILITIES. CONTRACTOR SHALL SUBMIT STRUCTURAL CALCULATIONS AND DRAWINGS VERIFYING PROPOSED CONSTRUCTION INCLUDING APPLICATION OF TEMPORARY CONSTRUCTION LOADS WILL NOT OVERSTRESS OR DAMAGE EXISTING STRUCTURES AND UTILITIES. DRAWINGS AND CALCULATIONS SHALL BE SEALED BY A PROFESSIONAL ENGINEER CURRENTLY REGISTERED IN THE STATE OF NORTH CAROLINA.
- G-15 NO BACKFILL SHALL BE PLACED AGAINST ANY SUBSTRUCTURE WALLS UNLESS ALL ADJACENT SUPPORTING ELEMENTS HAVE ACHIEVED DESIGN STRENGTH, OR WALLS HAVE BEEN PROPERLY BRACED, AND IN ANY CASE NOT SOONER THAN 28 DAYS AFTER THE PLACING OF CONCRETE UNLESS APPROVED BY THE ENGINEER. SUPPORTING ELEMENTS SHALL INCLUDE ADJACENT WALLS, SLABS, BEAMS AND COLUMNS.

## STRUCTURAL METALS

- M-1 DETAIL, FABRICATE, AND ERECT STRUCTURAL STEEL IN ACCORDANCE WITH AISC SPECIFICATION FOR STRUCTURAL STEEL BUILDINGS, ALLOWABLE STRESS DESIGN AND PLASTIC DESIGN, LATEST EDITION.
- M-2 STEEL MATERIAL
  - A) STRUCTURAL HSS:
  - B) STRUCTURAL PIPE: C) PLATES, BARS AND ANGLES:
  - D) STRUCTURAL W SHAPES:

  - E) STRUCTURAL S, M, C & MC SHAPES: F) STRUCTURAL HP
- ASTM A53, GRADE B (35 KSI) ASTM A36 UNO (36 KSI) ASTM A992 (50 KSI) ASTM A36 (36 KSI)

ASTM A500, GRADE C (46/50 KSI) OR A1085 (50 KSI)

- G) RODS ASTM F1554 GRADE 36 (36 KSI) M-3 PROVIDE MINIMUM 3/4" DIAMETER ASTM A325 HIGH STRENGTH BOLTS WITH SNUG TIGHTENED TYPE N CONNECTIONS FOR STRUCTURAL
- M-4 PROVIDE TYPICAL STEEL BEAM CONNECTIONS FOR A CAPACITY OF NOT LESS THAN THE TOTAL UNIFORM LOAD CAPACITY TABULATED IN THE AISC TABLES FOR ALLOWABLE LOADS OF BEAMS UNLESS NOTED OTHERWISE.

ASTM A572 GRADE 50 (50 KSI)

M-5 DO NOT PAINT STEEL SURFACES WHICH ARE TO BE WELDED OR ARE TO BE ENCASED IN CONCRETE.

STEEL UNLESS NOTED OTHERWISE. HOLES FOR BOLTS SHALL BE STANDARD SIZE UNLESS NOTED OTHERWISE.

- M-6 ALL STAINLESS STEEL FABRICATIONS EXPOSED TO UNDERWATER SERVICE SHALL BE TYPE 316. ALL OTHER STAINLESS STEEL FABRICATIONS SHALL BE TYPE 304 UNLESS NOTED OTHERWISE.
- M-7 ALUMINUM SHALL BE ALLOY 6061-T6 UNLESS NOTED OTHERWISE.
- M-8 ALL BOLTS, ANCHOR BOLTS, AND CONCRETE ANCHORS CONNECTING ALUMINUM SHALL BE STAINLESS STEEL TYPE 316 FOR UNDERWATER APPLICATIONS AND TYPE 304 FOR ALL OTHER APPLICATIONS.
- M-9 DETAIL, FABRICATE, AND ERECT ALUMINUM IN ACCORDANCE WITH THE LATEST EDITION OF THE ALUMINUM ASSOCIATION ALUMINUM DESIGN MANUAL.
- M-10 ALUMINUM SHALL BE ISOLATED FROM CONTACT WITH CONCRETE AND DISSIMILAR METALS.
- M-11 ALL GROOVE AND BUTT WELDS SHALL BE FULL PENETRATION.
- M-12 FILLET WELD SIZES SHALL NOT BE LESS THAN THE MINIMUM SIZE REQUIRED BY AISC CODE FOR PLATE SIZES TO BE CONNECTED AND SHALL BE APPLIED TO THE ENTIRE JOINT CONTACT LENGTH, AND NOT LESS THAN 3/16".
- M-13 BOTTOM SURFACES OF BASE PLATES SHALL BE GROUTED TO ENSURE FULL BEARING CONTACT WITH CONCRETE SLAB.
- M-14 WHENEVER ONE MEMBER IS FASTENED TO ANOTHER WITH FASTENINGS (BOLTS, WELDS, ETC.) SET AT A UNIFORM SPACING, THERE SHALL BE A MINIMUM OF TWO FASTENINGS PER PIECE CONNECTED AND THE FIRST AND LAST FASTENINGS SHALL BE LOCATED NOT TO EXCEED 0.25 OF FASTENER SPACING FROM EACH END.
- M-15 BOLTED CONNECTIONS FOR STRUCTURAL STEEL SHALL BE ASSEMBLED AND INSPECTED IN ACCORDANCE WITH RCSC (SPECIFICATIONS FOR STRUCTURAL JOINTS USING ASTM A325 OR ASTM A490 BOLTS).
- M-16 STRUCTURAL WELDED JOINTS SHALL CONFORM TO THE PROVISIONS OF AWS D1.1, STRUCTURAL WELDING CODE BY AMERICAN WELDING SOCIETY. PROOF OF WELDER CERTIFICATION SHALL BE AVAILABLE AT THE JOB SITE DURING TIMES OF INSPECTION.

## NONSTRUCTURAL COMPONENT ANCHORAGE

- A-1 ALL ARCHITECTURAL, MECHANICAL, AND ELECTRICAL COMPONENTS SHALL BE DESIGNED AND INSTALLED TO RESIST THE CONTROLLING CONDITION OF OPERATIONAL FORCES OR SEISMIC FORCES IN ACCORDANCE WITH THE GOVERNING BUILDING CODE. SEISMIC FORCES SHALL ALSO BE AS PER ASCE 7. COMPONENT SEISMIC ATTACHMENTS SHALL BE BOLTED, WELDED, OR OTHERWISE POSITIVELY FASTENED WITHOUT CONSIDERATION OF FRICTIONAL RESISTANCE PRODUCED BY THE EFFECTS OF GRAVITY. A CONTINUOUS LOAD PATH OF SUFFICIENT STRENGTH AND STIFFNESS BETWEEN THE COMPONENT AND THE SUPPORTING STRUCTURE SHALL BE PROVIDED. CONNECTIONS FOR BOTH ORTHOGONAL DIRECTIONS (TRANSVERSE AND LONGITUDINAL) SHALL BE DESIGNED BY THE CONTRACTOR'S ENGINEER CURRENTLY REGISTERED IN THE STATE OF NORTH CAROLINA.
- A-2 COMPONENT REACTION FORCES AT THE POINT OF ATTACHMENT TO THE STRUCTURE SHALL BE SUBMITTED TO AND COORDINATED WITH THE ENGINEER FOR CONFIRMATION SUPPORTING STRUCTURE CAN WITHSTAND REACTION FORCES.
- A-3 CONTRACTOR SHALL PROVIDE SPECIAL SEISMIC CERTIFICATION (SSC) FROM MANUFACTURER OF EQUIPMENT FOR ALL SYSTEMS DEEMED NECESSARY BY SPECIFICATIONS. SPECIAL SEISMIC CERTIFICATION SHALL BE IN COMPLIANCE WITH ASCE 7.

# **FOUNDATIONS**

- F-1 CONCRETE (CAST-IN-PLACE) NOTES APPLY TO FOUNDATIONS.
- F-2 ALLOWABLE SOIL BEARING PRESSURE

STRUCTURE	PARAMETER	ALLOWABLE SOIL BEARING PRESSURE
PUMP STATION		2500 PSF

F-3 MINIMUM DEPTH FROM ADJACENT FINISHED GRADE TO BOTTOM OF FOUNDATION = 18 INCHES.

# PRECAST CONCRETE

- PC-1 PRECAST PLANKS SHALL BE DESIGNED BY A PROFESSIONAL ENGINEER REGISTERED IN THE STATE OF NORTH CAROLINA. PLANKS SHALL PROVIDE OPENINGS TO ALLOW VENT PIPES, STRUCTURAL STEEL BRACING AND COLUMNS TO PASS THROUGH. PLANK INTERIOR ENDS SHALL BE GROUT FILLED TO PROVIDE A SMOOTH FINISH.
- PC-2 PRECAST VAULTS AND MANHOLES SHALL BE DESIGNED BY A PROFESSIONAL ENGINEER REGISTERED IN THE STATE OF NORTH CAROLINA. STRUCTURAL DRAWINGS SHALL INDICATE DESIGN IS IN COMPLIANCE WITH THE NORTH CAROLINA BUILDING CODE.

## CONCRETE (CAST-IN-PLACE)

- C-1 DESIGN OF CONCRETE ELEMENTS INCLUDING WALLS, FORMED SLABS, BEAMS, AND COLUMNS IS IN ACCORDANCE WITH ACI 318 (CODE REQUIREMENTS FOR STRUCTURAL CONCRETE) AND 350 (CODE REQUIREMENTS FOR ENVIRONMENTAL ENGINEERING CONCRETE STRUCTURES)
- C-2 FOR CONCRETE MIX DESIGN SEE SPECIFICATION SECTION 03300.
- C-3 CONCRETE STRENGTH CLASSES (28-DAY COMPRESSIVE STRENGTH):
- A) CLASS A1 CONCRETE (4,500 PSI): NORMAL WEIGHT CONCRETE SHALL BE USED IN ALL STRUCTURES, SIDEWALKS, PAVEMENTS, EXCEPT WHERE NOTED OTHERWISE IN CONTRACT DOCUMENTS. ALL CONCRETE SHALL BE CLASS A1 CONCRETE UNLESS ANOTHER CLASS IS SPECIFICALLY CALLED FOR ON CONTRACT DOCUMENTS OR SPECIFIED HEREIN.
- B) CLASS A2 CONCRETE (4,500 PSI): NORMAL WEIGHT CONCRETE TO BE USED FOR INTERIOR SLABS WHERE A CONCRETE HARDENER IS REQUIRED FOR APPLICATION AFTER PLACEMENT OF SLABS OR WHERE A STEEL TROWEL FINISH IS REQUIRED.
- C) CLASS A3 CONCRETE (4,500 PSI): NORMAL WEIGHT STRUCTURAL CONCRETE TO BE USED WHERE SPECIFICALLY CALLED FOR ON CONTRACT DRAWINGS OR WHERE SPECIFICALLY REQUESTED BY CONTRACTOR AND APPROVED BY ENGINEER. CLASS A3 CONCRETE SHALL BE SIMILAR TO CLASS A1 EXCEPT CLASS A3 CONCRETE SHALL CONTAIN A MANDATORY ADDITION OF HIGH RANGE WATER REDUCER TO AID IN PLACEMENT OF CONCRETE.
- D) CLASS A4 CONCRETE (4,500 PSI): NORMAL WEIGHT STRUCTURAL CONCRETE TO BE USED WHERE SPECIFICALLY CALLED FOR ON CONTRACT DRAWINGS OR AREAS WHERE SPECIFICALLY REQUESTED BY CONTRACTOR AND APPROVED ENGINEER. CLASS A4 CONCRETE IS IDENTICAL TO CLASS A1 CONCRETE EXCEPT THAT COARSE AGGREGATE SHALL BE SIZE #8M IN ACCORDANCE WITH ASTM C33. CLASS A4 CONCRETE MAY ALSO REQUIRE A MANDATORY ADDITION OF HIGH RANGE WATER REDUCER TO AID IN PLACEMENT OF CONCRETE.
- E) CLASS A6 CONCRETE (4,500 PSI): NORMAL WEIGHT STRUCTURAL CONCRETE USED WHERE CONCRETE IS PLACED UNDER PRESSURE (PUMPED). CLASS A6 CONCRETE SHALL BE USED ONLY WHERE SPECIFICALLY APPROVED BY ENGINEER.
- F) CLASS B CONCRETE (3,000 PSI): NORMAL WEIGHT STRUCTURAL CONCRETE USED FOR DUCT BANK ENCASEMENTS, CATCH BASINS, FENCE AND GUARD POST EMBEDMENT, CONCRETE FILL AND OTHER AREAS WHERE SPECIFICALLY NOTED ON CONTRACT DRAWINGS.
- C-4 ALL BAR REINFORCING SHALL CONFORM TO ASTM A615, GRADE 60. WHERE REINFORCEMENT IS TO BE WELDED IN ACCORDANCE WITH AWS D1.4, ASTM A706 GRADE 60 SHALL BE USED. WELDED WIRE FABRIC SHALL CONFORM TO ASTM A185.
- C-5 CONCRETE COVER FOR REINFORCING (UNLESS NOTED OTHERWISE ON THE DRAWINGS)

A)	CONCRETE DEPOSITED DIRECTLY AGAINST SOIL:	3"
В)	CONCRETE EXPOSED TO WEATHER (#5 OR SMALLER):	1 1/2"
	CONCRETE EXPOSED TO WEATHER (#6 OR LARGER):	2"
C)	SLABS:	1 1/2"
	AT SURFACES CONTACTING FLUID:	2"
D)	BEAMS AND COLUMNS (TO MAIN REINFORCEMENT):	2"
	BEAMS AND COLUMNS (TO COLUMN TIES OR STIRRUPS):	1 1/2"
E)	WALLS 12" OR MORE:	2"
	WALLS LESS THAN 12" (#5 OR SMALLER):	1 1/2"
	WALLS LESS THAN 12" (#6 OR LARGER):	2"
F)	FOR SURFACES EXPOSED TO FLUID IN BEAMS, COLUMNS AND WALLS:	ADD 1/2" TO ABOVE VALUES

- C-6 SPLICES SHALL BE CLASS "B" CONFORMING TO THE PROVISIONS OF ACI 318 UNLESS NOTED OTHERWISE. SPLICE LENGTH FOR TWO DIFFERENT SIZED BARS TO BE LAP SPLICED TOGETHER SHALL BE THE LENGTH OF THE LARGER BAR UNLESS NOTED OTHERWISE.
- C-7 CONSTRUCTION JOINTS SHALL BE LOCATED AS SHOWN ON THE DRAWINGS. CONSTRUCTION JOINTS NOT SHOWN SHALL BE SUBMITTED BY THE CONTRACTOR FOR THE APPROVAL OF THE ENGINEER PRIOR TO SUBMITTING REBAR SHOP DRAWINGS. VERTICAL CONSTRUCTION JOINTS IN WALLS AND HORIZONTAL JOINTS IN SLABS SHALL BE PROVIDED AT A SPACING NOT GREATER THAN 45 FEET ON CENTER. EXPOSED WALLS WITH FLUID OR EARTH ON THE OPPOSITE SIDE, THE SPACING BETWEEN VERTICAL AND HORIZONTAL JOINTS SHALL BE A MAXIMUM OF 25 FEET.
- C-8 WHERE HORIZONTAL CONSTRUCTION JOINTS, LOCATED ABOVE THE FOUNDATION SLAB, EXTEND BEYOND WHERE NEEDED, THEY SHALL BE TERMINATED AT A VERTICAL CONSTRUCTION JOINT APPROVED BY THE ENGINEER.
- C-9 ALL JOINTS WHICH ARE IN MEMBERS IN CONTACT WITH LIQUID OR BELOW GRADE SHALL HAVE A WATERSTOP. CONSTRUCTION JOINTS SHALL HAVE A 6" PVC RIBBED WATERSTOP. EXPANSION JOINTS SHALL HAVE A 9" PVC CENTER BULB RIBBED WATERSTOP. IN VERTICAL JOINTS, WATERSTOPS SHALL TERMINATE NO LESS THAN 18" ABOVE THE MAXIMUM WATER SURFACE OR 18" ABOVE GRADE, WHICHEVER IS HIGHER.
- C-10 SLABS WITH SLOPING SURFACES SHALL HAVE THE INDICATED SLAB THICKNESS MAINTAINED AS THE MINIMUM. SLAB BOTTOMS CAN EITHER SLOPE WITH THE TOP SURFACE OR BE LEVEL. REINFORCEMENT IN SLABS WITH SLOPING SURFACES SHALL BE PLACED AT THE REQUIRED CLEARANCE FROM THE SLAB SURFACE.
- C-11 ALL EXPOSED CORNERS SHALL HAVE A 3/4" CHAMFER OR A 1/2" RADIUS TOOLED CORNER.
- C-12 EQUIPMENT SUPPORTS, ANCHORAGES, OPENINGS, RECESSES AND REVEALS NOT SHOWN ON THE STRUCTURAL DRAWINGS BUT REQUIRED BY OTHER CONTRACT DOCUMENTS, SHALL BE PROVIDED FOR PRIOR TO PLACING CONCRETE.
- C-13 REINFORCING BARS AND ACCESSORIES SHALL NOT BE IN CONTACT WITH ANY METAL PIPE, PIPE FLANGE, METAL CONDUIT, OR OTHER METAL PARTS EMBEDDED IN CONCRETE. A MINIMUM CLEARANCE OF 2" SHALL BE PROVIDED.
- C-14 DOWELS, ANCHOR BOLTS, PIPES, WATERSTOPS AND OTHER EMBEDDED ITEMS SHALL BE HELD SECURELY IN POSITION WHILE CONCRETE IS BEING PLACED.
- C-15 CONDUITS AND OTHER SIMILAR ITEMS EMBEDDED IN OR PENETRATING THROUGH CONCRETE SHALL BE SPACED ON CENTER NOT LESS THAN 3 TIMES THEIR OUTSIDE DIMENSION, BUT NOT LESS THAN 2 1/2" CLEAR. WHEN SUCH ITEMS ARE EMBEDDED IN WALLS OR SLABS, THEY SHALL NOT OCCUPY MORE THAN 1/3 OF THE MEMBER THICKNESS.
- C-16 AT ALL TYPICAL CURBS, EQUIPMENT PADS, AND PIPE SUPPORT PIERS, REINFORCING DOWELS SHOWN MAY BE REPLACED WITH MATCHING DOWELS SET IN EPOXY IN DRILLED HOLES AS SPECIFIED. DOWELS LOCATED CLOSER THAN 3" FROM ANY EDGE OF CONCRETE SHALL NOT BE REPLACED WITH DRILLED DOWELS.
- C-17 DRILLED ADHESIVE DOWELS (WHERE DOWELS ARE SHOWN TO BE PLACED INTO HARDENED CONCRETE):
  - A) THE HOLE DIAMETER SHALL BE NO LARGER THAN 1/8" GREATER THAN THE DIAMETER OF THE REINFORCING BAR AT THE DEFORMATIONS.
  - B) THE DEPTH OF EMBEDMENT SHALL BE 12 BAR DIAMETERS, UNLESS NOTED OTHERWISE.
  - C) ADJUST THE DOWEL LOCATIONS AS NEEDED TO AVOID DRILLING THROUGH ANY REINFORCING BARS. IF THE LOCATION NEEDS TO BE MODIFIED, CONTACT THE ENGINEER. CONTRACTOR SHALL USE NON-DESTRUCTIVE MEANS TO FIELD LOCATE REINFORCEMENT PRIOR TO DRILLING HOLES FOR DOWELS.
- C-18 CLEAR DISTANCE FROM ANCHOR BOLTS TO ANY CONCRETE EDGE SHALL BE 4" MINIMUM UNLESS NOTED OTHERWISE
- C-19 CONCRETE COMPRESSIVE STRENGTH TESTS SHALL BE AVAILABLE ON THE JOB SITE FOR REVIEW BY THE ENGINEER.

					PROJECT ENGINEER:	M.J.BENCHICH
					DESIGNED BY:	A.D. OVERBAY
					DRAWN BY:	E.M. CARROLL
:28 PM	3	CONSTRUCTION	3-8-16	JCJ	CHECKED BY:	C.T. PHILLIPS
1:39	2	BUILDING PERMIT REVIEW	2-26-16	JCJ	TE THIS DAD DOES NOT	0 1/2" 1"
9 1	1	REGULATORY REVIEW	1-20-16	JCJ	IF THIS BAR DOES NOT MEASURE 1" THEN DRAWING	0 1/2" 1"
8/2016	REV	ISSUED FOR	DATE	BY	IS NOT TO FULL SCALE	

**ISSUED FOR** CONSTRUCTION



HAZEN AND SAWYER

4944 PARKWAY PLAZA BLVD, SUITE 375

CHARLOTTE, NORTH CAROLINA 28217

LICENSE NO.: C-0381

DAVIDSON COUNTY NORTH CAROLINA

DAVIDSON WATER INC. HYATTOWN PUMP STATION IMPROVEMENTS

PUMP STATION STRUCTURAL **GENERAL NOTES** 

**MARCH 2016** HAZEN NO.: 30961-010 CONTRACT NO.: DRAWING

NUMBER:

S1

## **MASONRY**


- M-1 MASONRY MORTAR SHALL BE ASTM C 270 TYPE "S" AND MASONRY GROUT SHALL CONFORM TO REQUIREMENTS OF ASTM C 476.
- M-2 CONCRETE MASONRY UNIT NET AREA COMPRESSIVE STRENGTH SHALL BE 3000 PSI WHEN TESTED IN ACCORDANCE WITH ASTM C 140. COMPLETE TEST REPORTS SHALL BE SUBMITTED TO THE BUILDING INSPECTOR.
- M-3 MASONRY TRUSS TYPE REINFORCEMENT SHALL CONFORM TO ASTM A 951 AND REINFORCEMENT STEEL SHALL CONFORM TO REQUIREMENTS OF ASTM A 615 FOR GRADE 60 BILLET STEEL.
- M-4 MASONRY REINFORCEMENT BAR SPLICES SHALL BE CONTACT SPLICES. UNLESS NOTED OTHERWISE, LENGTH OF SPLICE FOR SINGLE BARS IN CENTER OF CELLS OF 8" OR LARGER CMU SHALL BE A MINIMUM OF 25 INCHES FOR #4 BARS AND 32 INCHES FOR #5 BARS. LENGTH OF SPLICE FOR OTHER CONDITIONS SHALL BE AS SHOWN ON THE DRAWINGS
- M-5 BOND BEAM REINFORCEMENT SHALL BE PROVIDED WITH STD 90° HOOKS AT ALL WALL INTERSECTIONS. WHERE BOND BEAM REINFORCEMENT IS INTERRUPTED BY OPENINGS REINFORCEMENT SHALL BE PROVIDED WITH STD 180° HOOKS AT ENDS. SEE ARCHITECTURAL DRAWINGS FOR DETAILS.
- M-6 DOWELS SHALL BE EITHER CAST INTO WALL OR INSTALLED WITH A DOWEL ADHESIVE SYSTEM. IF CAST, DOWELS SHALL BE EMBEDDED IN STEM WALL OR FOUNDATION SLAB A MINIMUM 9" AND SHALL HAVE A STD 90° HOOK. IF INSTALLED WITH A DOWEL ADHESIVE SYSTEM DOWELS SHALL BE STRAIGHT BARS EMBEDDED A MINIMUM OF 10" INTO STEM WALL. DOWEL ADHESIVE SHALL BE QUALIFIED FOR USE UNDER SEISMIC LOADING IN BOTH CRACKED AND UNCRACKED CONDITIONS FOR ALL SEISMIC DESIGN CATEGORIES IN ACCORDANCE WITH SPECIFICATION 03200. INSTALLATION OF ALL DOWELS SHALL BE PER MANUFACTURERS RECOMMENDATIONS. AS A MINIMUM THE FOLLOWING INSTALLATION REQUIREMENTS SHALL BE MET:
  - A) HOLES SHOULD BE DRILLED WITH CARBIDE BIT UNLESS OTHERWISE RECOMMENDED BY THE MANUFACTURER.
  - B) ALL HOLES SHALL BE CLEANED USING COMPRESSED AIR AND A PROPERLY SIZED NYLON OR WIRE BRUSH.
  - C) ADHESIVE SHALL BE INJECTED USING A DISPENSER, STATIC MIXING NOZZLE AND A PISTON PLUG TO MINIMIZE THE FORMATION OF AIR POCKETS PROVIDED BY THE MANUFACTURER. IF DEPTH OF HOLE IS DEEPER THAN THE STATIC MIXING NOZZLE A PLASTIC EXTENSION TUBE SUPPLIED BY THE MANUFACTURER SHALL BE USED FOR PLACING ADHESIVE.

## SPECIAL INSPECTIONS

SI-1 SPECIAL PERIODIC AND CONTINUOUS INSPECTIONS SHALL BE IN ACCORDANCE WITH THE NORTH CAROLINA BUILDING CODE.

					PROJECT ENGINEER:	M.J.BENCHICH
					DESIGNED BY:	A.D. OVERBAY
					DRAWN BY:	E.M. CARROLL
:28 PM	3	CONSTRUCTION	3-8-16	JCJ	CHECKED BY:	C.T. PHILLIPS
4:39	2	BUILDING PERMIT REVIEW	2-26-16	JCJ	IF THIS DAD DOES NOT	0 1/2" 1"
16	1	REGULATORY REVIEW	1-20-16	JCJ	IF THIS BAR DOES NOT MEASURE 1" THEN DRAWING	0 1/2" 1"
/8/2016	REV	ISSUED FOR	DATE	BY	IS NOT TO FULL SCALE	

ISSUED FOR CONSTRUCTION

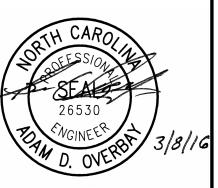



LICENSE NO.: C-0381

DAVIDSON COUNTY NORTH CAROLINA


DAVIDSON WATER INC.
HYATTOWN PUMP STATION IMPROVEMENTS


PUMP STATION STRUCTURAL GENERAL NOTES

DATE:	MARCH 2016	
HAZEN NO.:	30961-010	
CONTRACT N	IO.:	1
DRAWING NUMBER:		


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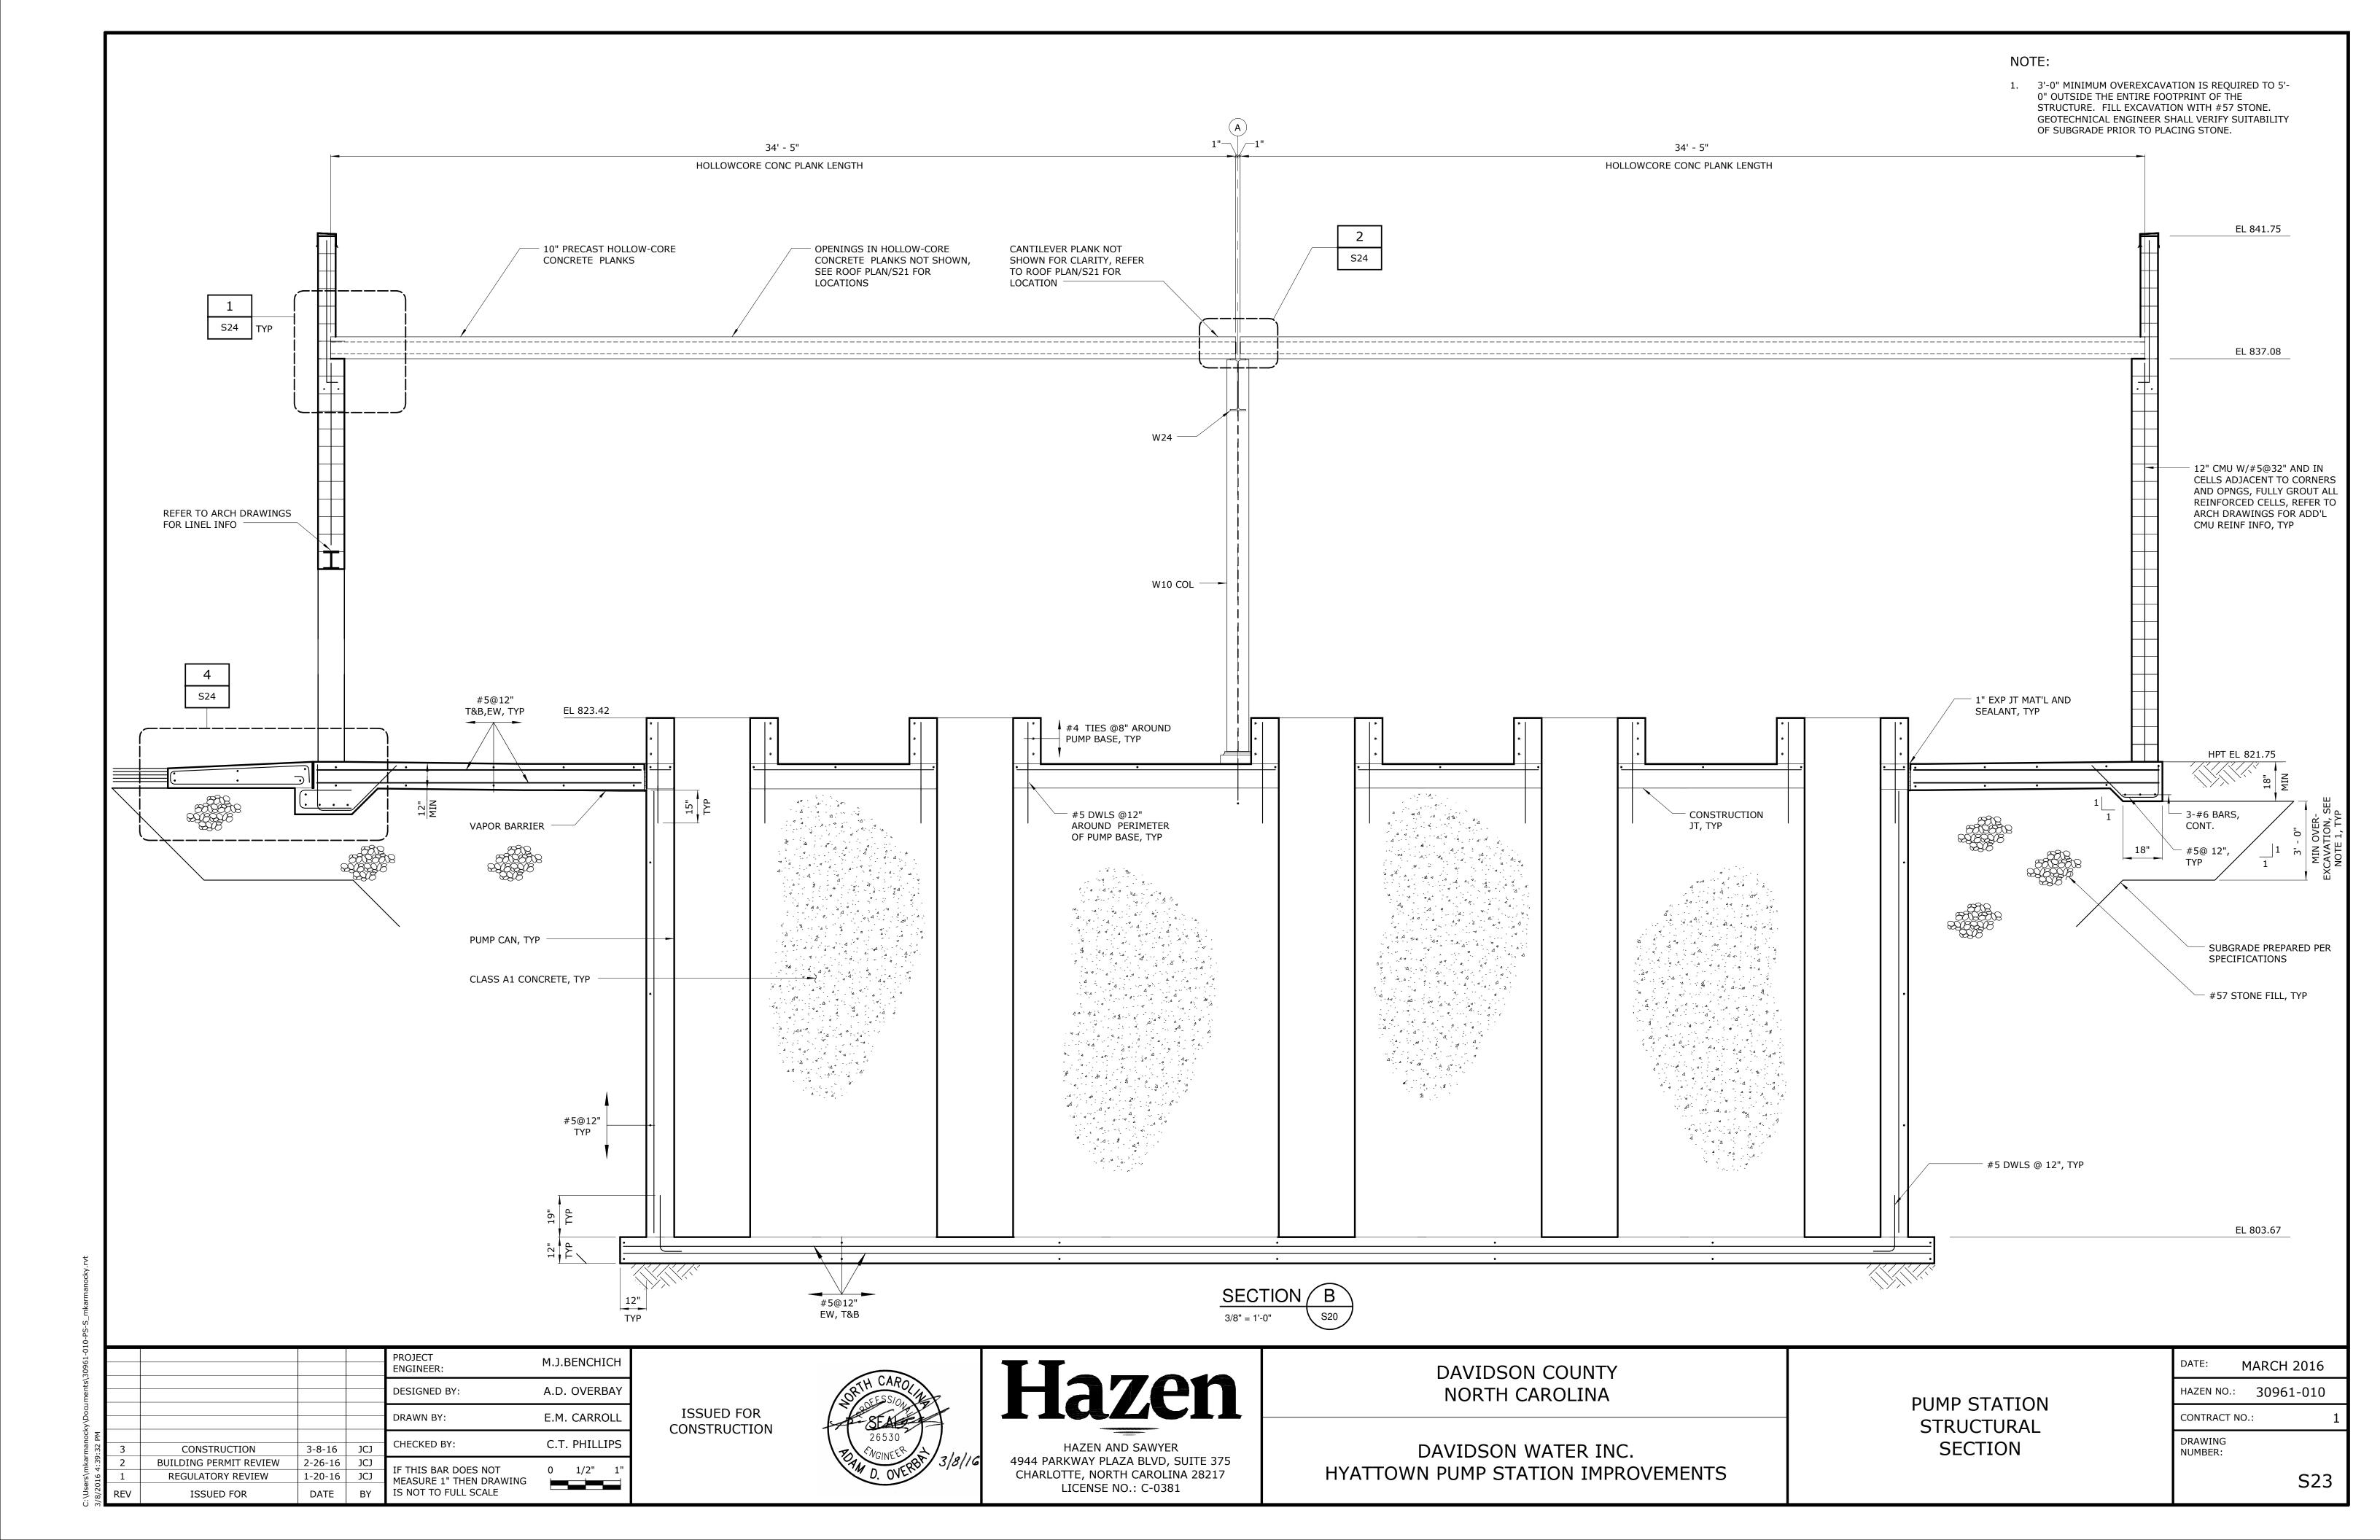
S2




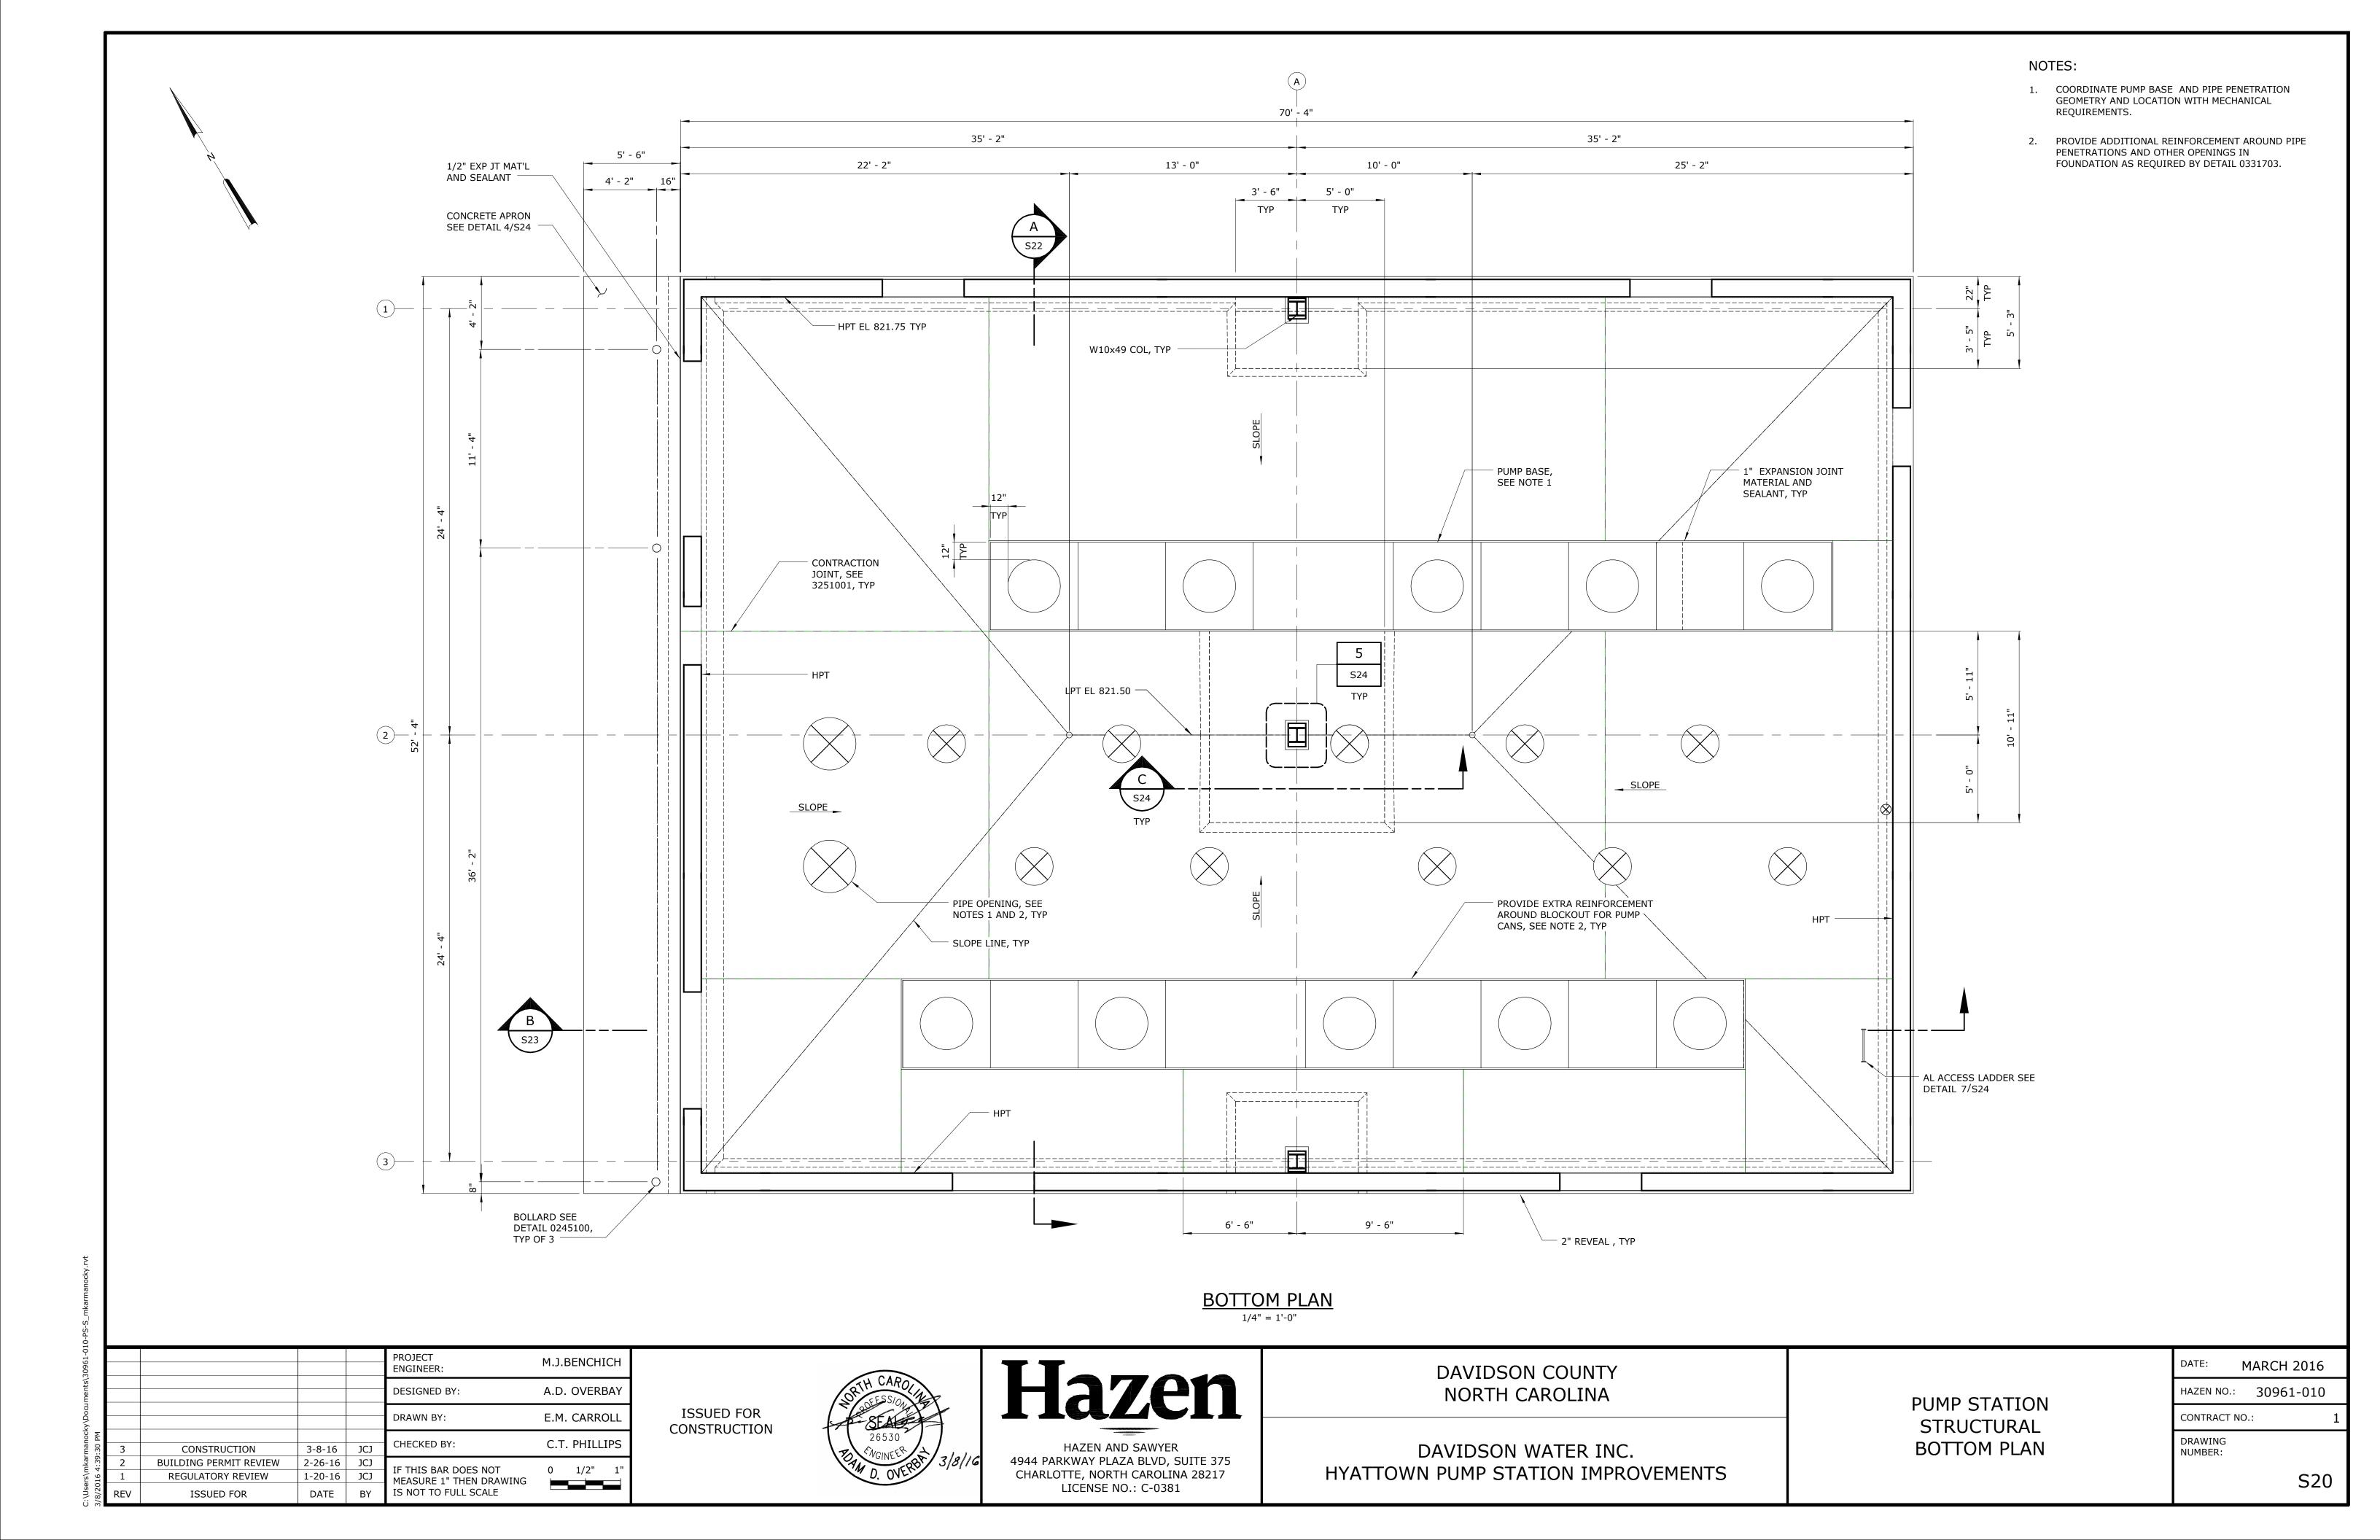


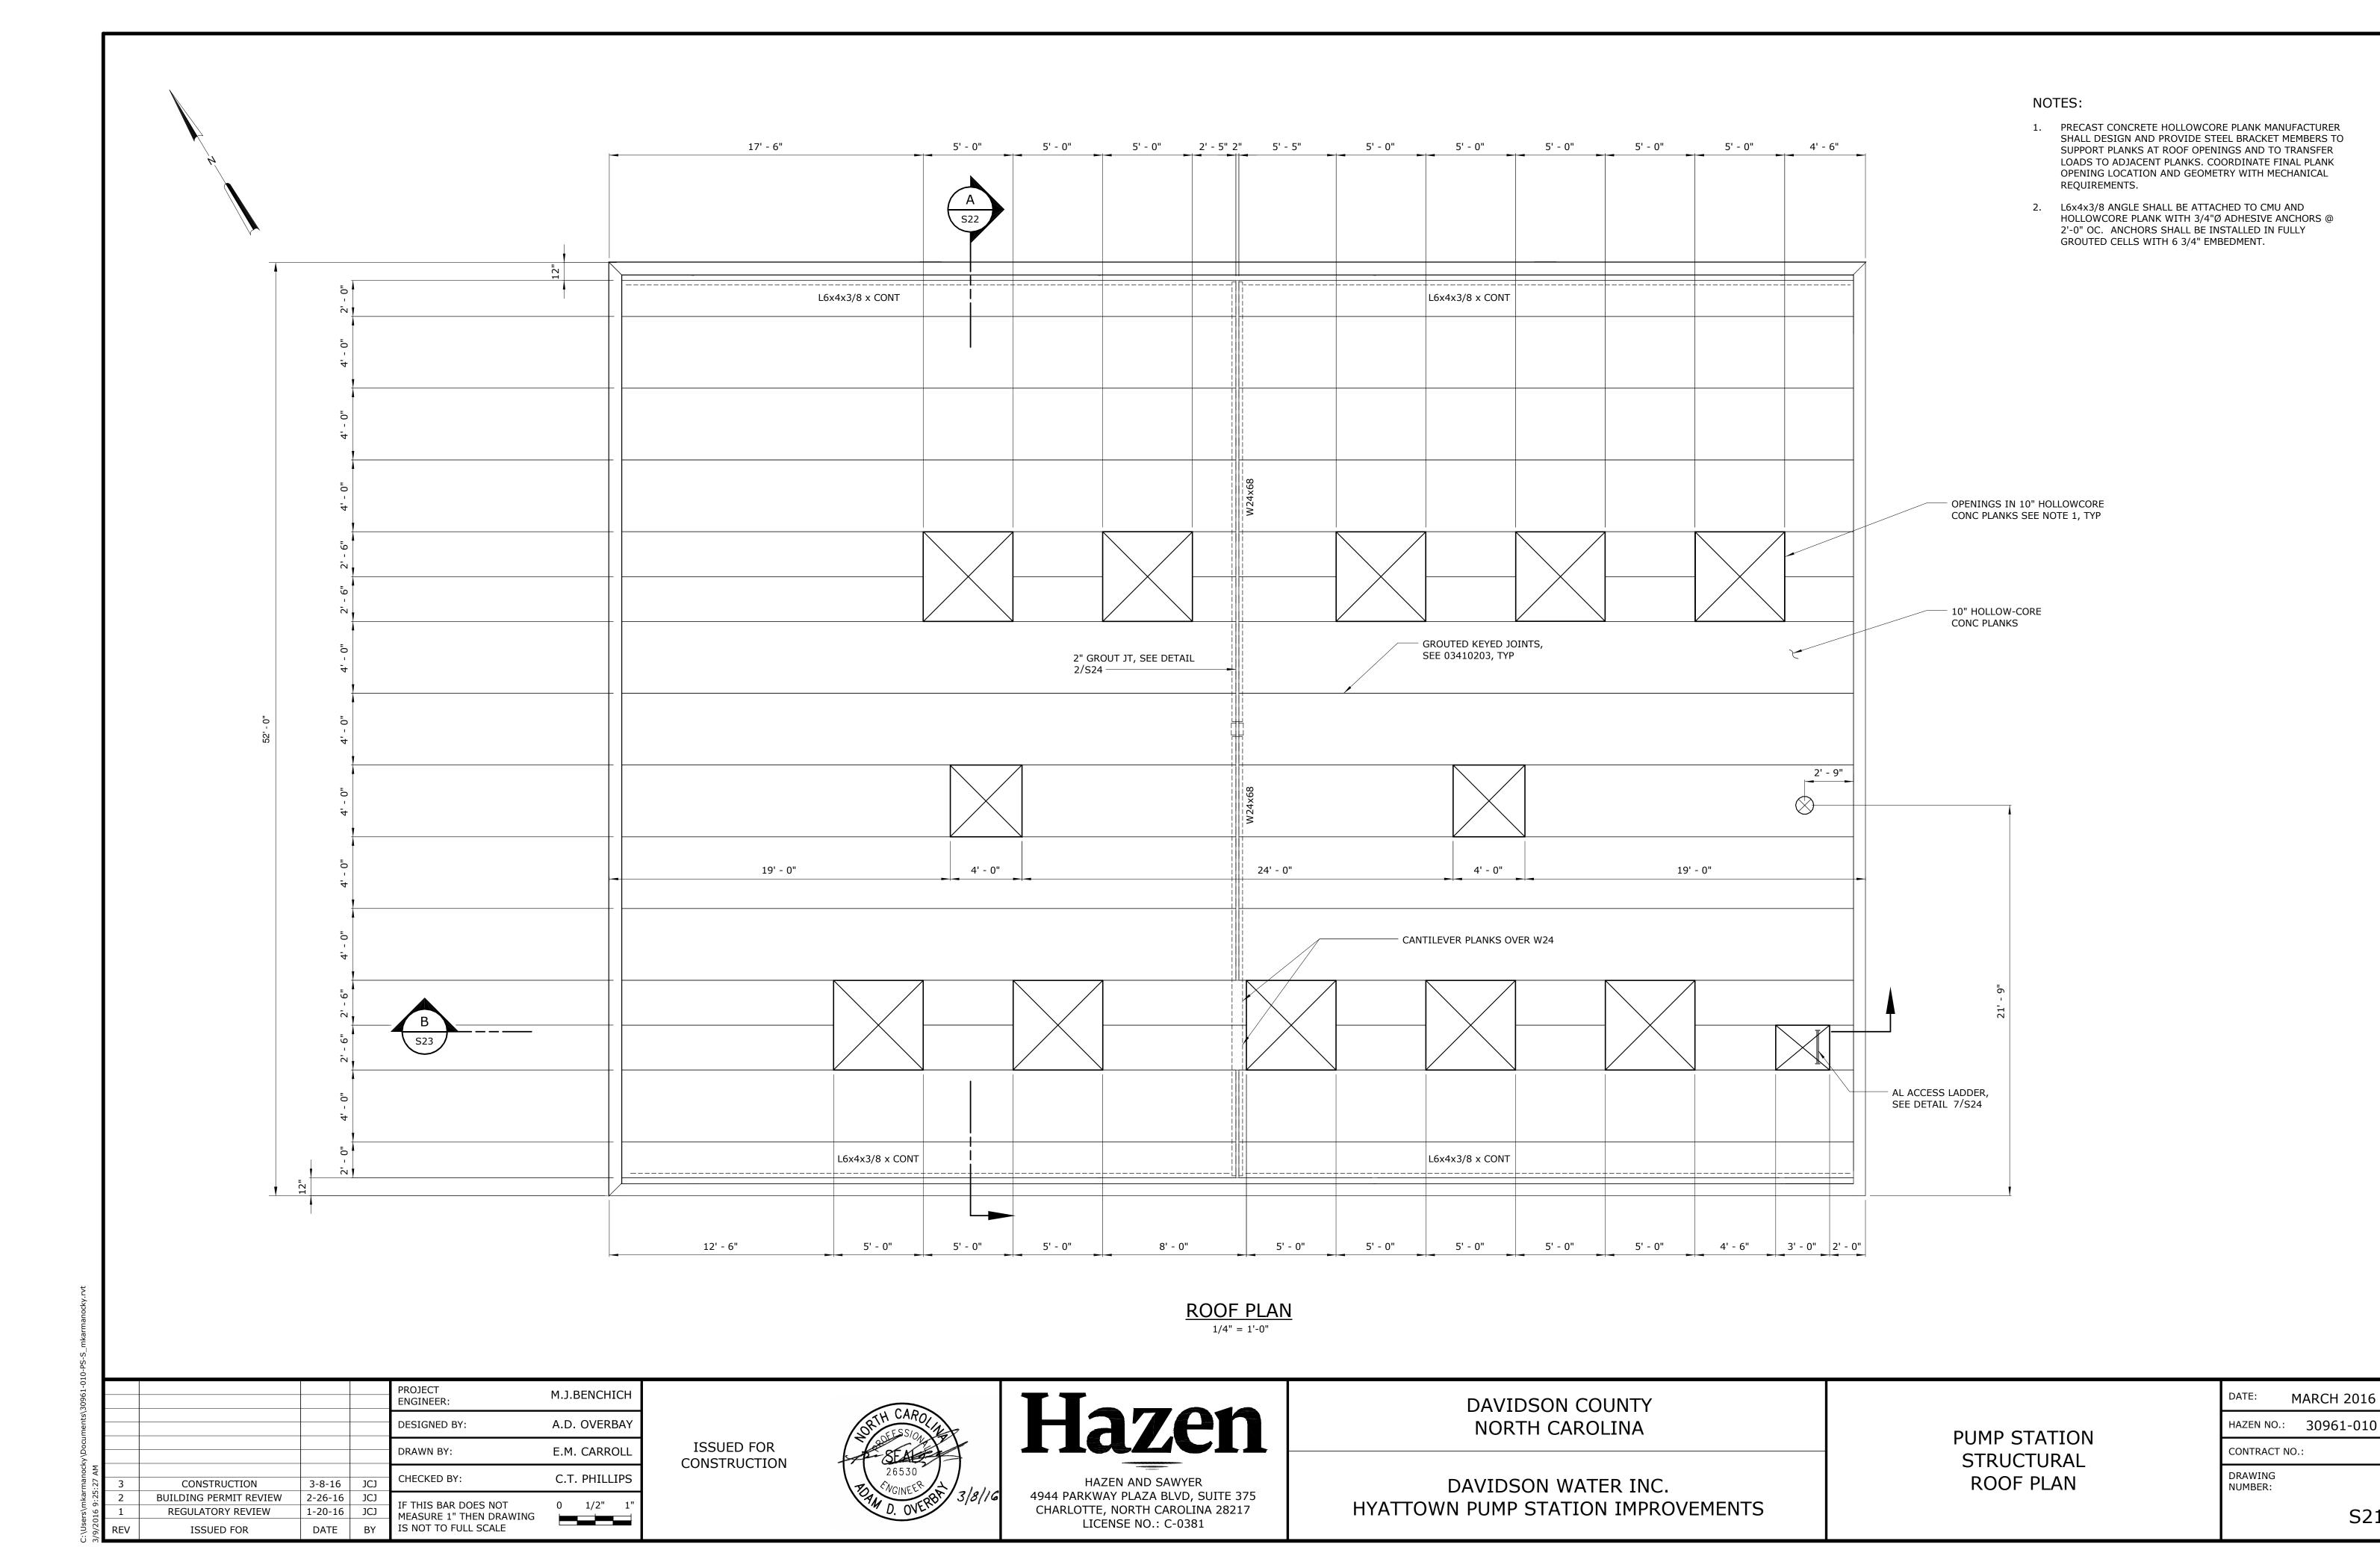S21



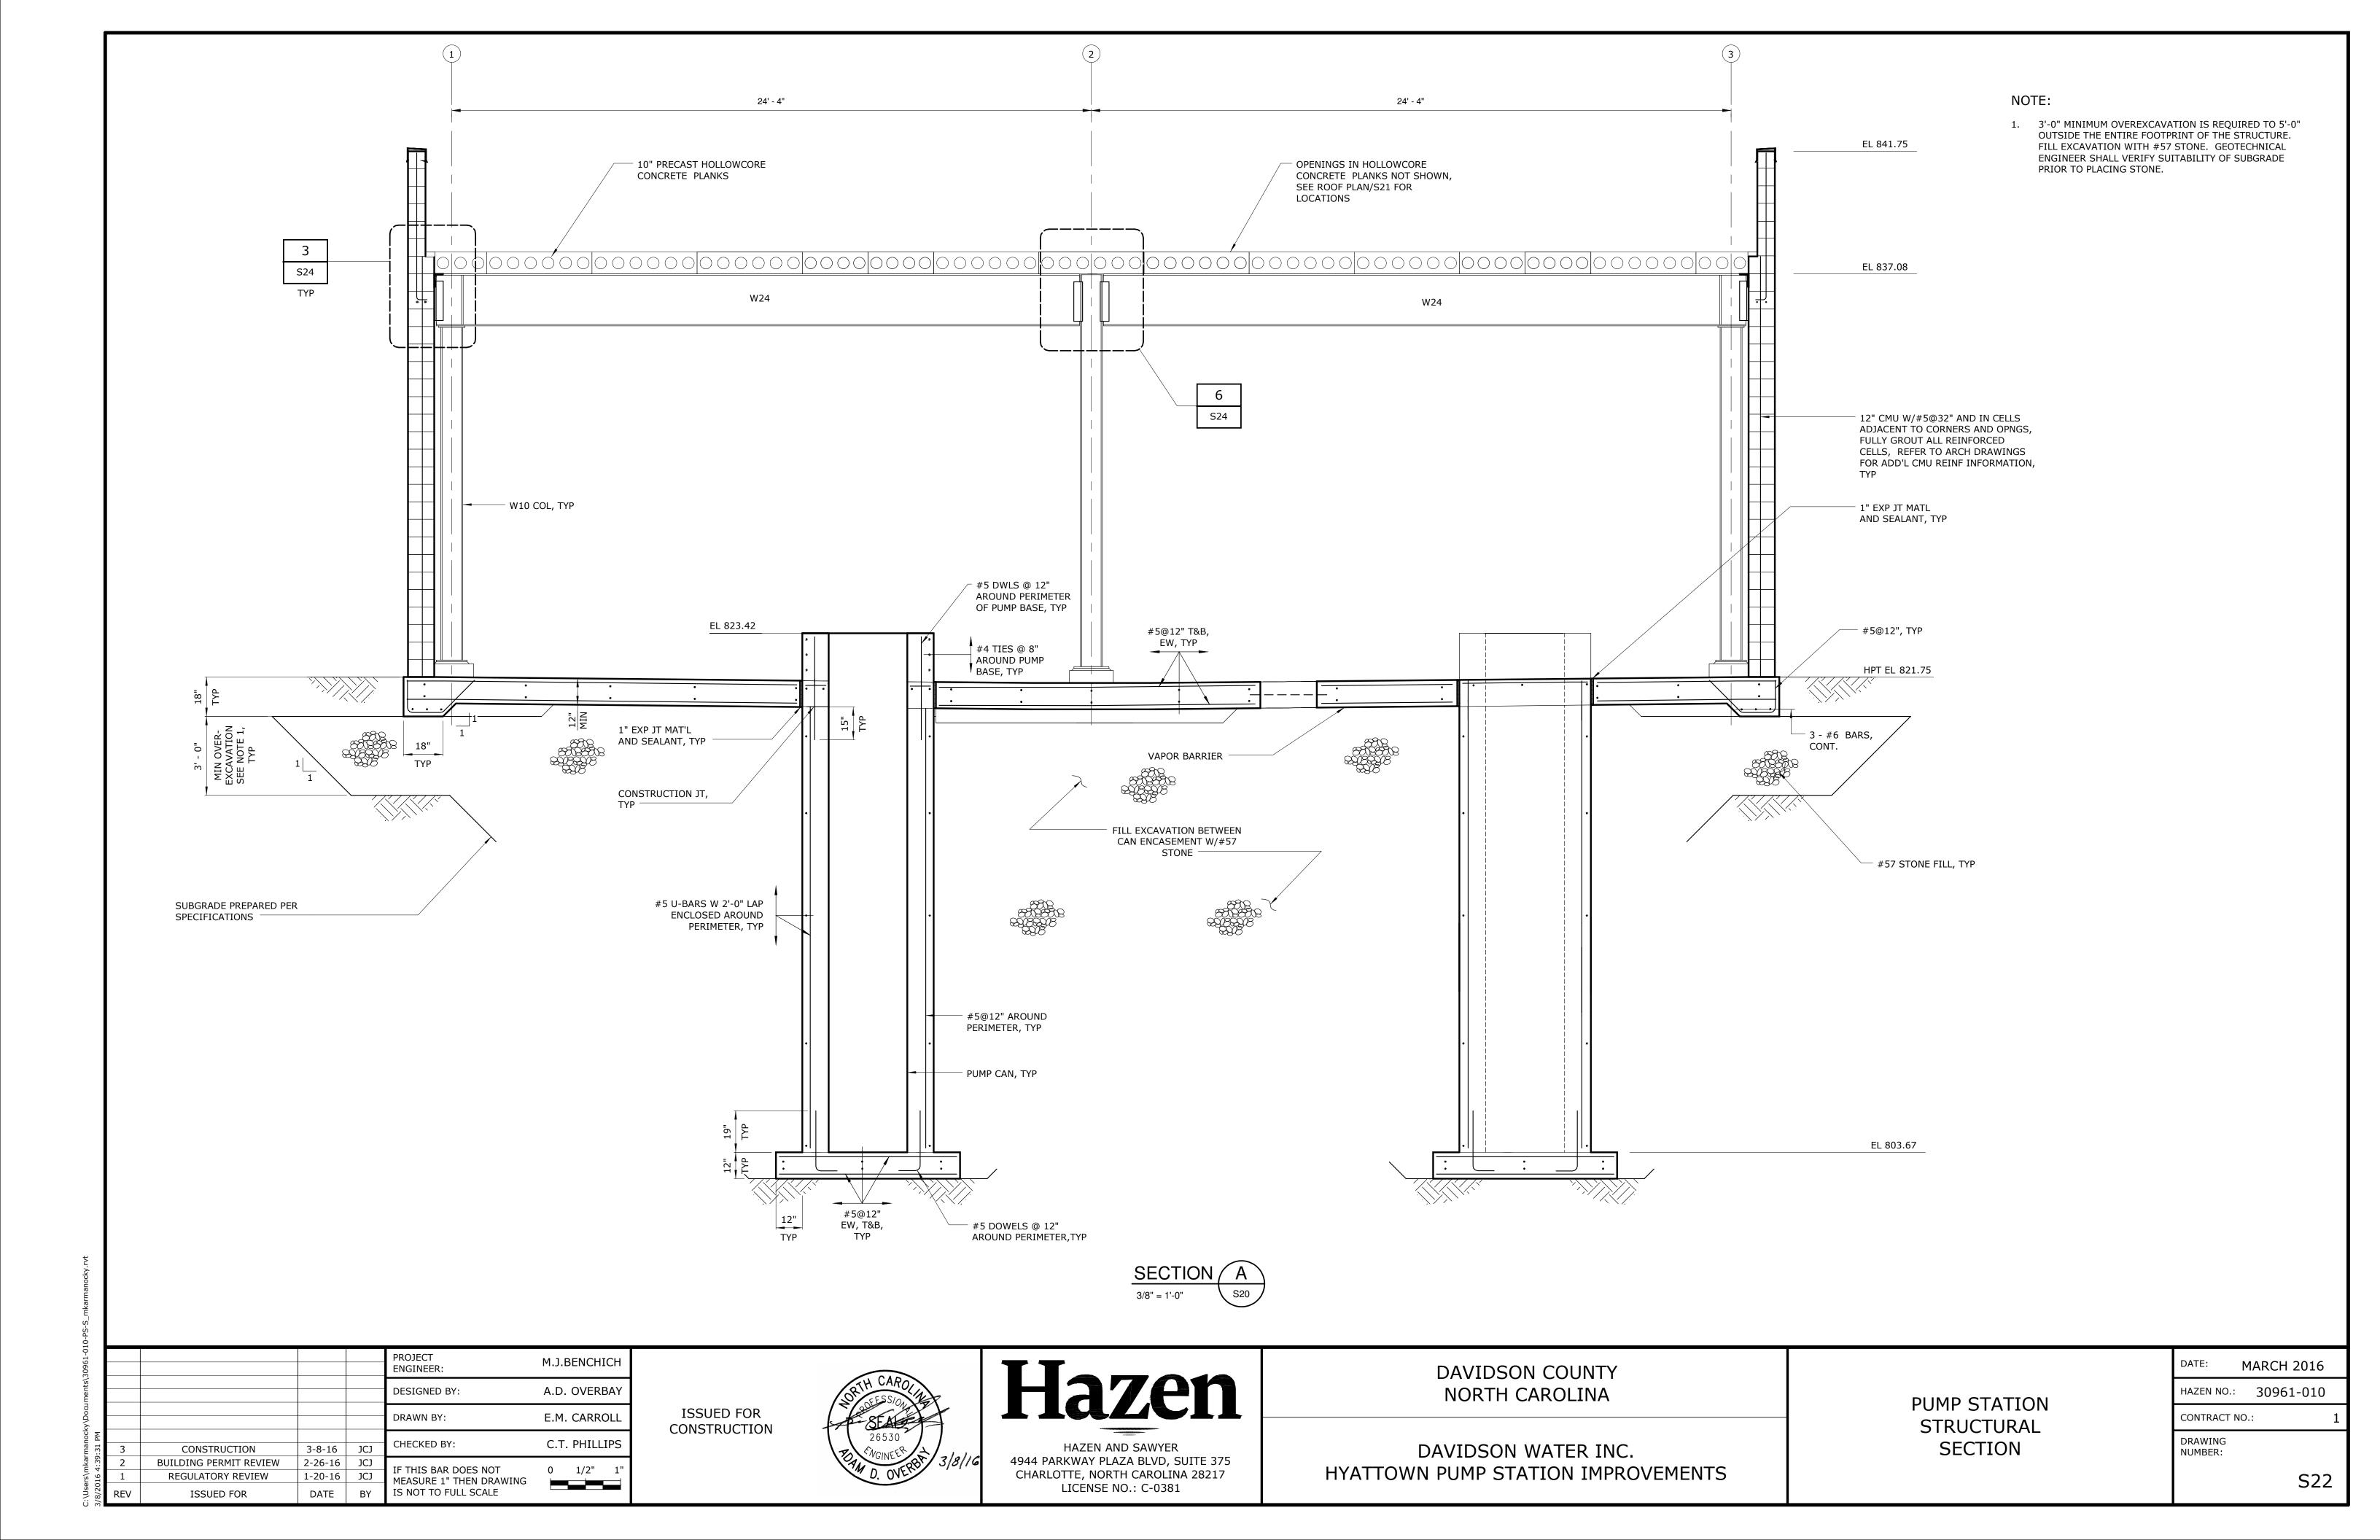

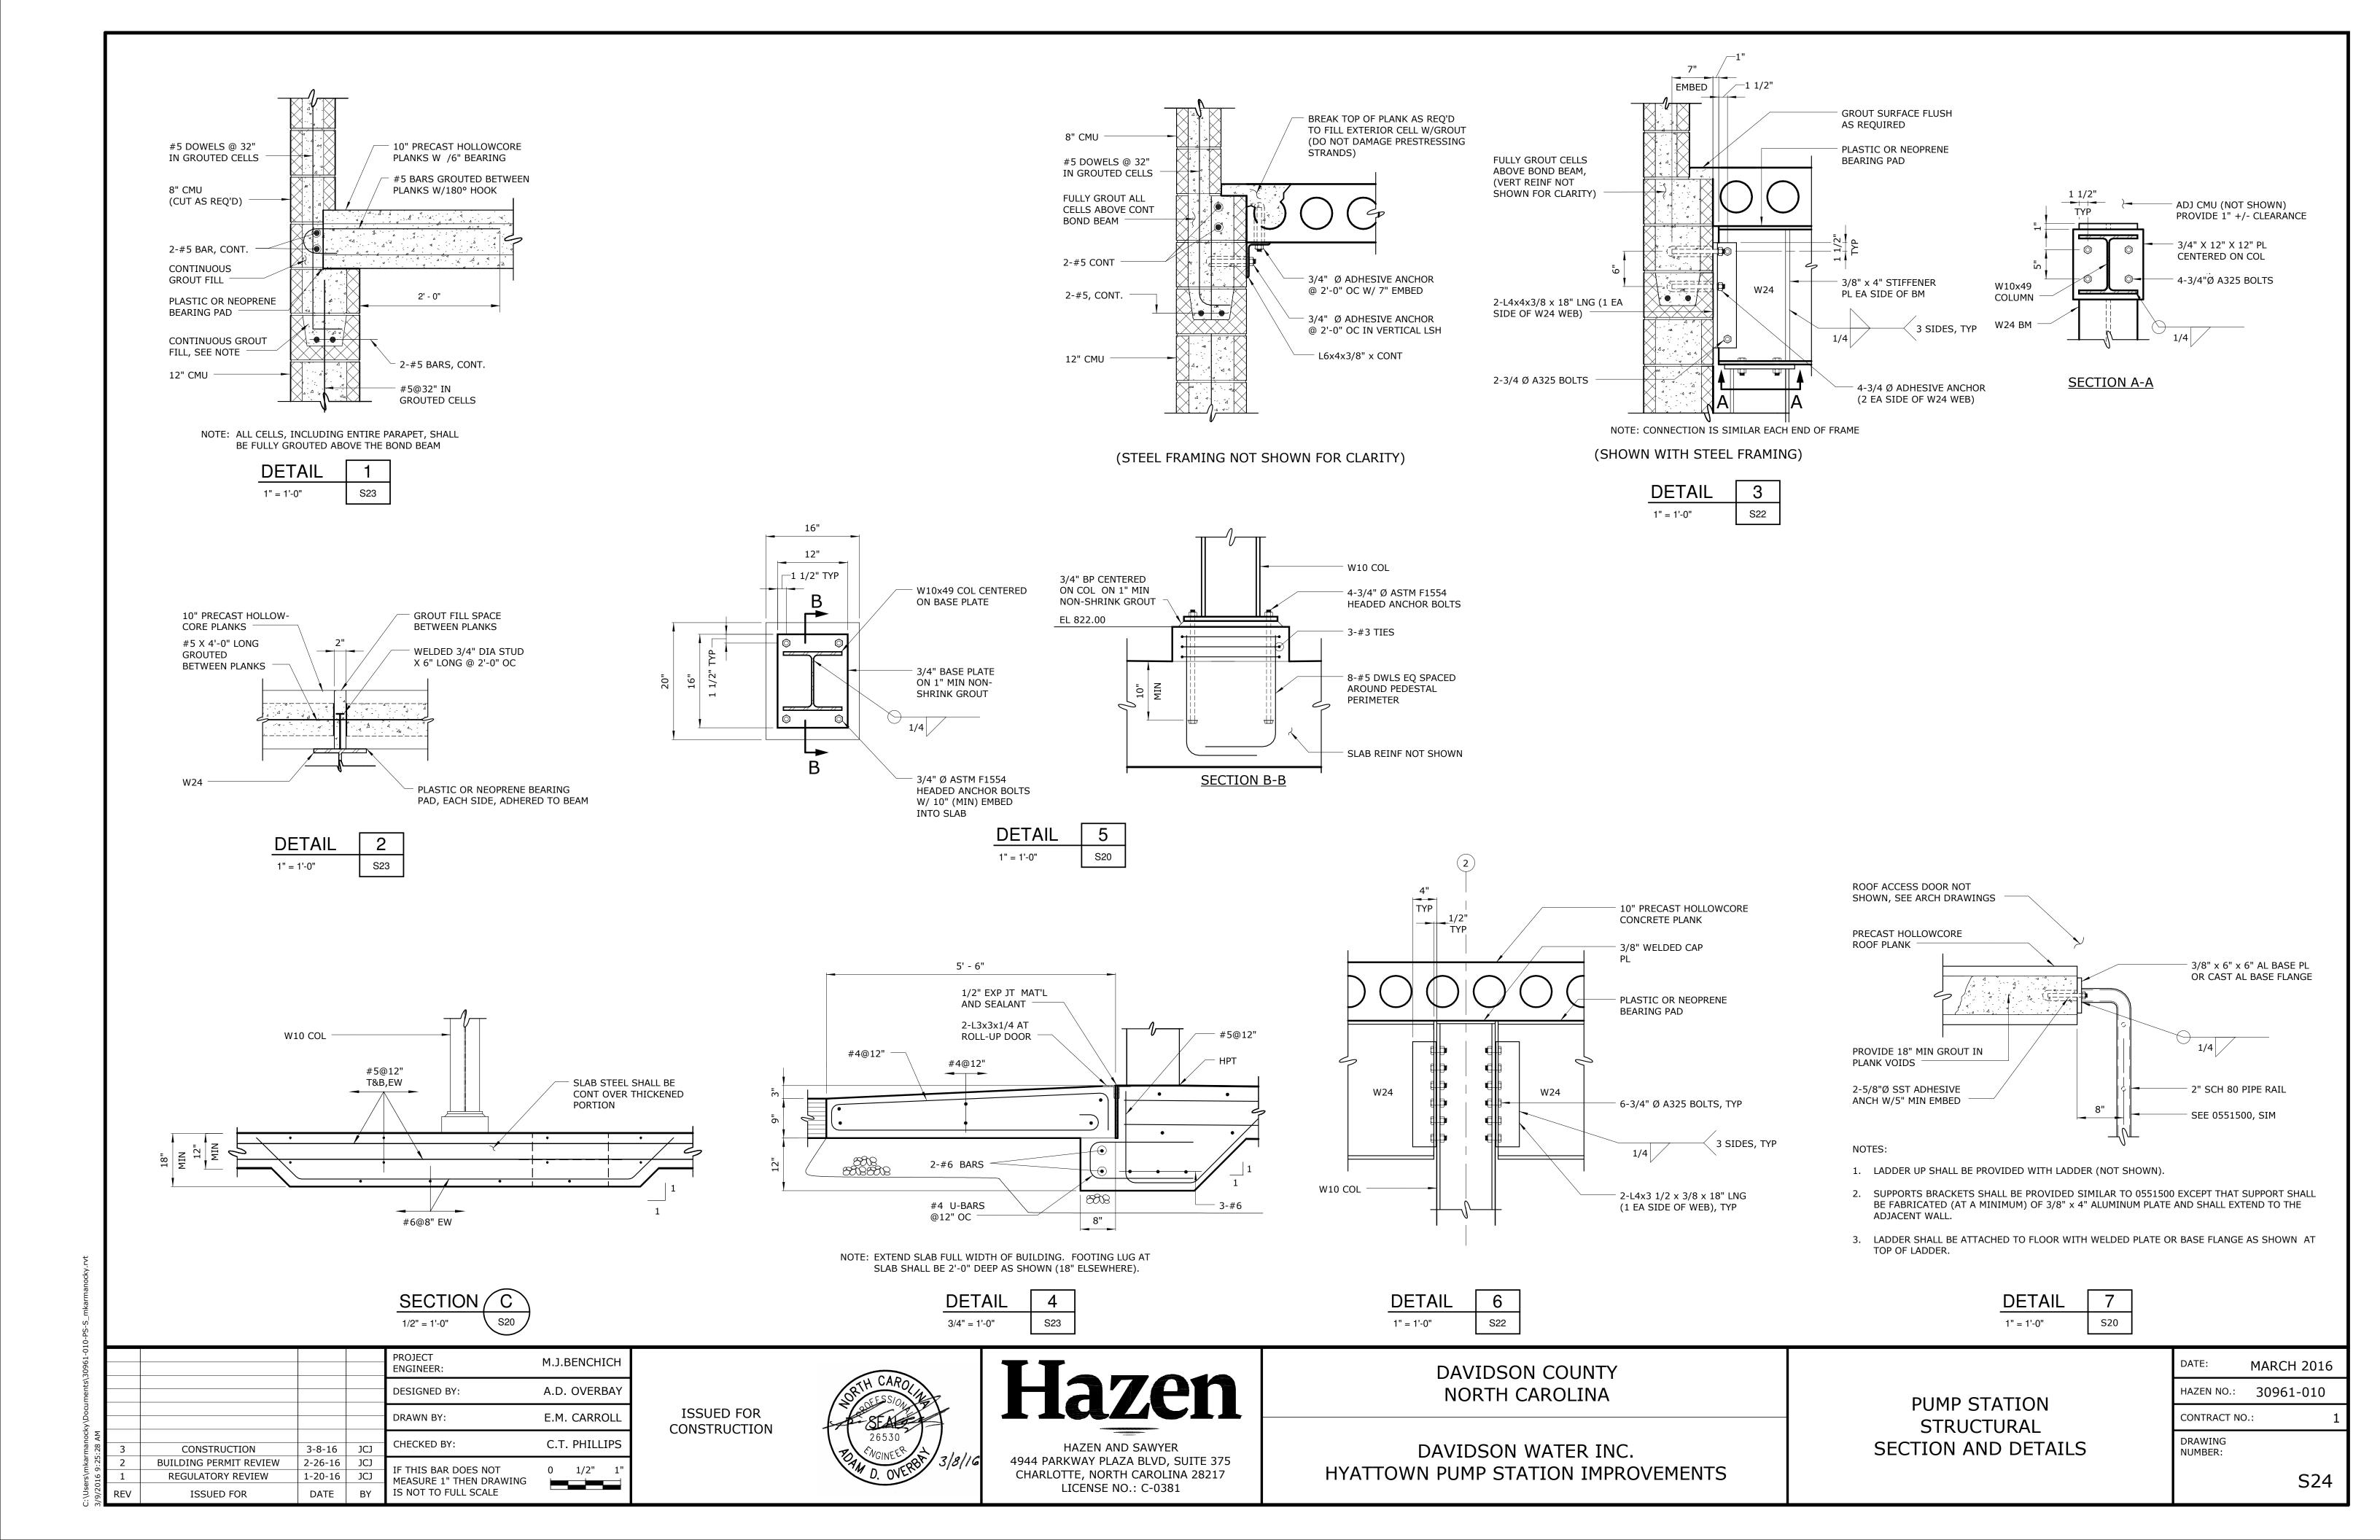

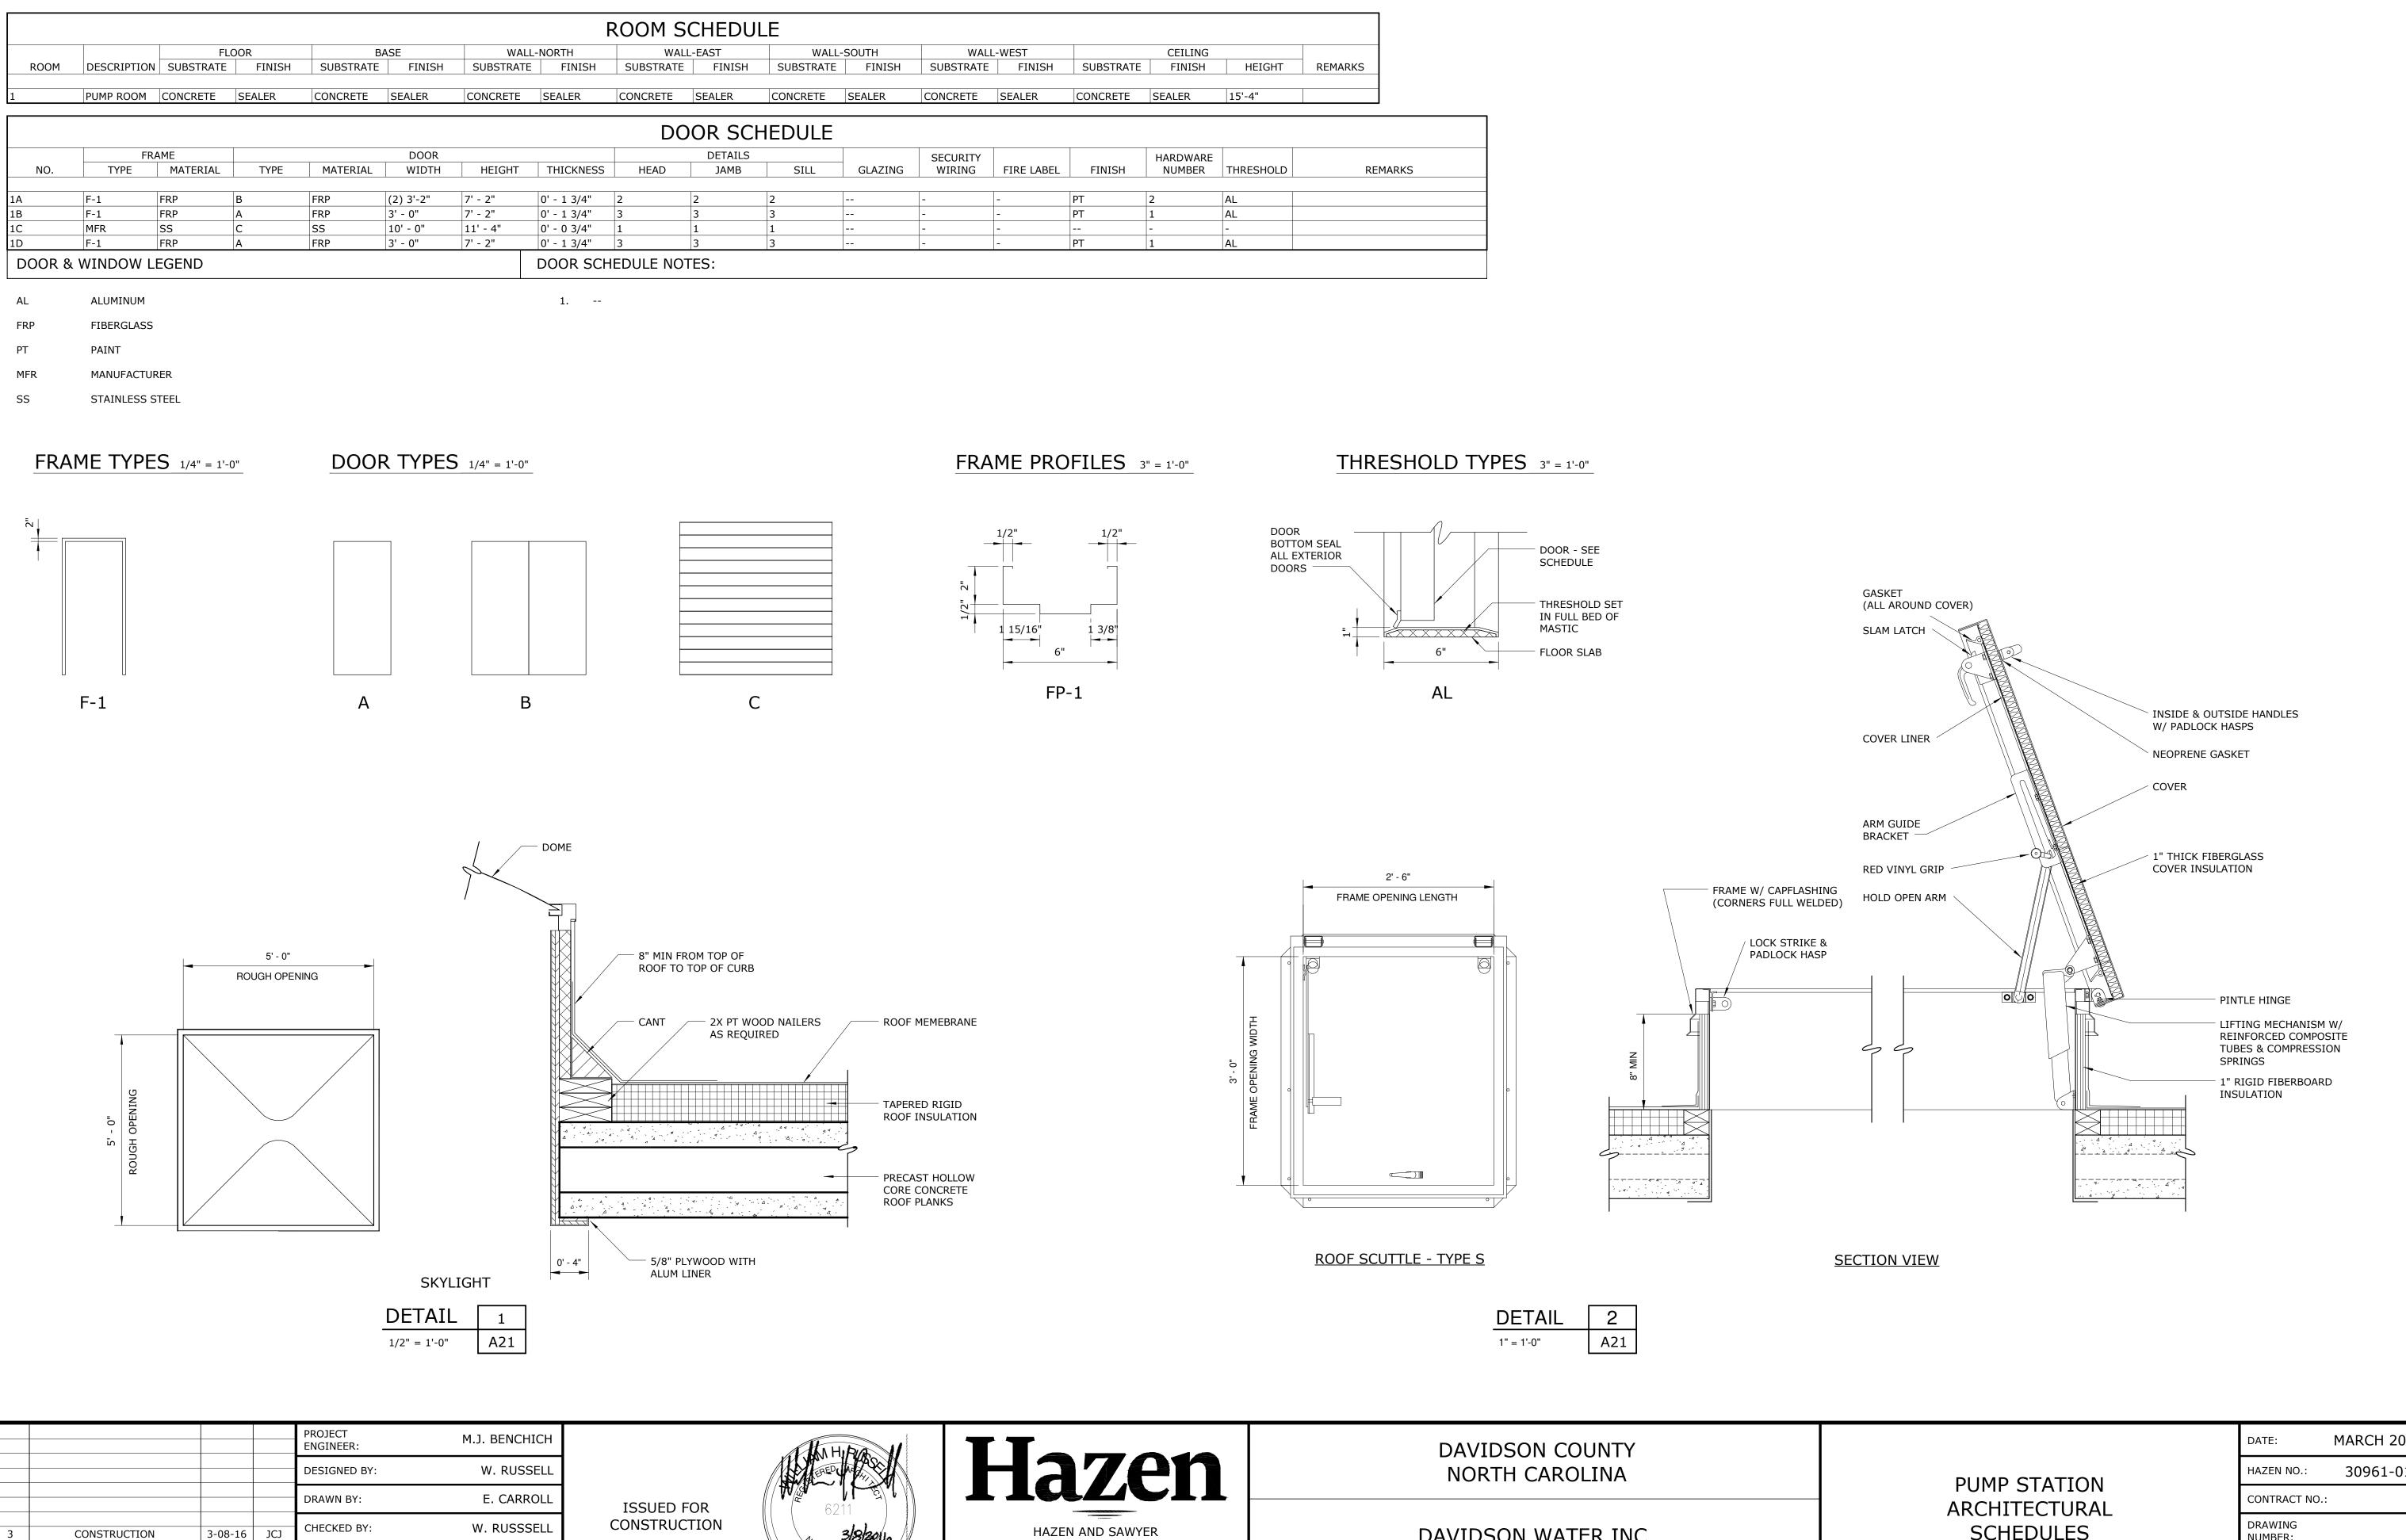

2-26-16

1-20-16

DATE

IF THIS BAR DOES NOT

IS NOT TO FULL SCALE

MEASURE 1" THEN DRAWING

BUILDING PERMIT REVIEW

REGULATORY REVIEW

ISSUED FOR

0 1/2" 1



HAZEN AND SAWYER 4944 PARKWAY PLAZA BLVD, SUITE 375


CHARLOTTE, NORTH CAROLINA 28217

LICENSE NO.: C-0381

DAVIDSON WATER INC. HYATTOWN PUMP STATION IMPROVEMENTS SCHEDULES

DATE:	MARCH 2016
HAZEN NO.:	30961-010
CONTRACT NO.:	1
DRAWING NUMBER:	
	A1

1. WHERE CMU IS INDICATED IN DETAIL, SEE ELEVATIONS FOR FINISH TYPE AND COLOR.

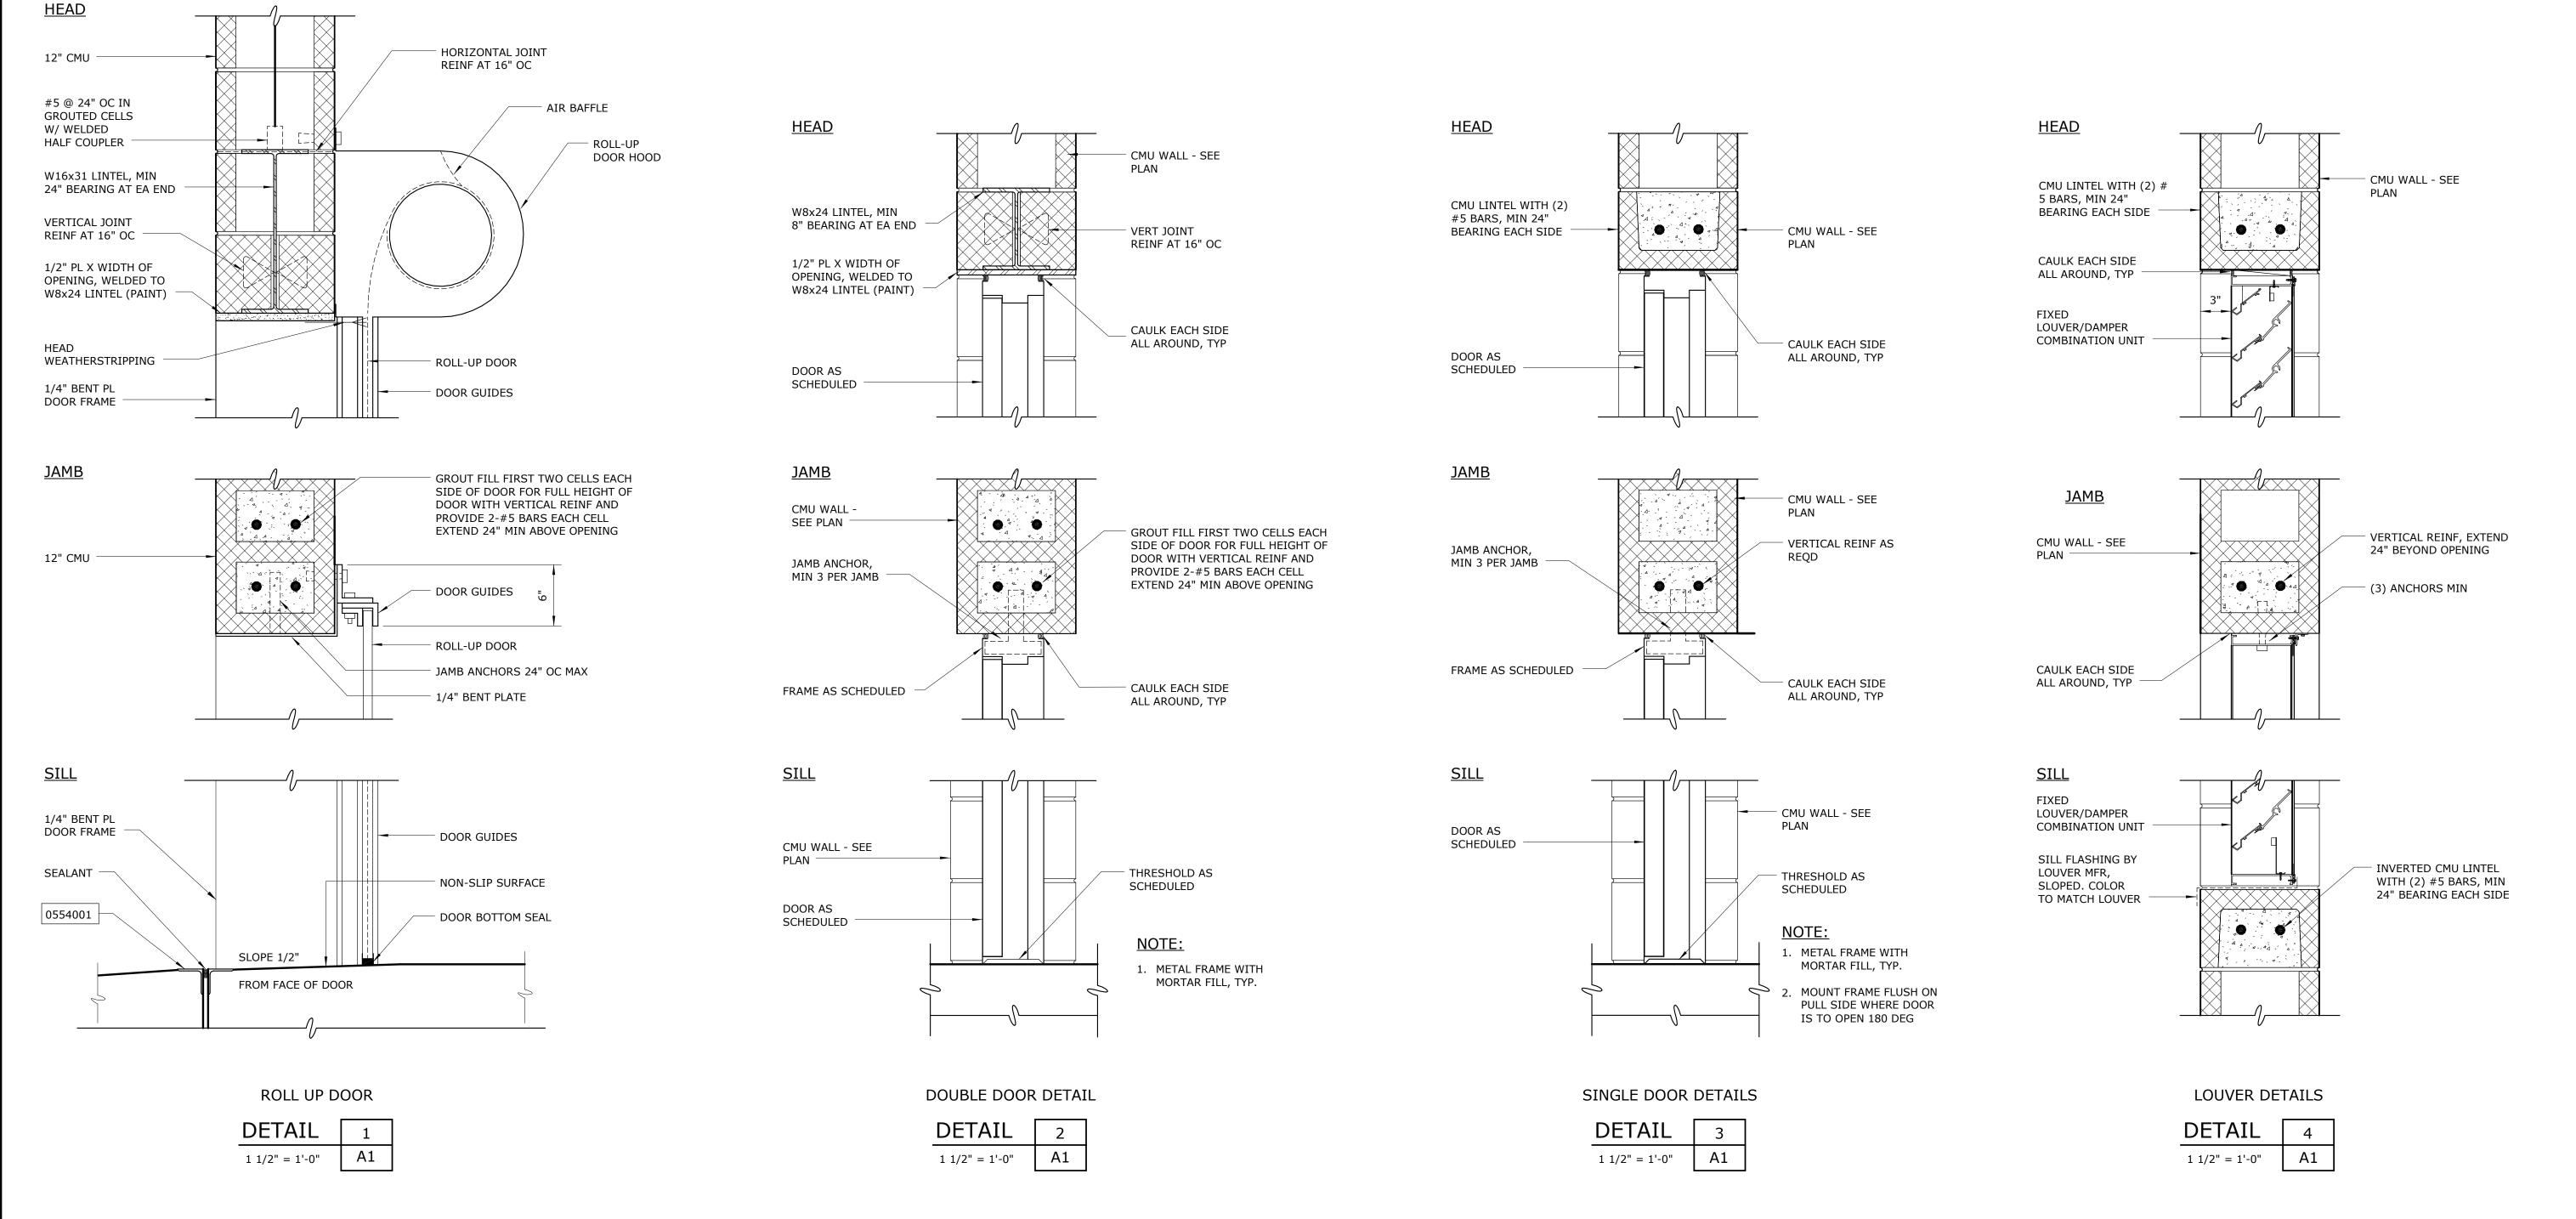

M.J. BENCHICH ENGINEER: W. RUSSELL DESIGNED BY: E. CARROLL DRAWN BY: CHECKED BY: W. RUSSSELL CONSTRUCTION 3-08-16 2-26-16 BUILDING PERMIT REVIEW IF THIS BAR DOES NOT 0 1/2" 1 REGULATORY REVIEW 1-20-16 MEASURE 1" THEN DRAWING

DATE

ISSUED FOR

PROJECT

IS NOT TO FULL SCALE

ISSUED FOR CONSTRUCTION



Hazen

HAZEN AND SAWYER 4944 PARKWAY PLAZA BLVD, SUITE 375 CHARLOTTE, NORTH CAROLINA 28217 LICENSE NO.: C-0381


DAVIDSON COUNTY NORTH CAROLINA

DAVIDSON WATER INC. HYATTOWN PUMP STATION IMPROVEMENTS

**PUMP STATION ARCHITECTURAL** DOOR DETAILS

DATE:	MARCH 2016
HAZEN NO.:	30961-010
CONTRACT NO.:	1
DRAWING NUMBER:	


A2

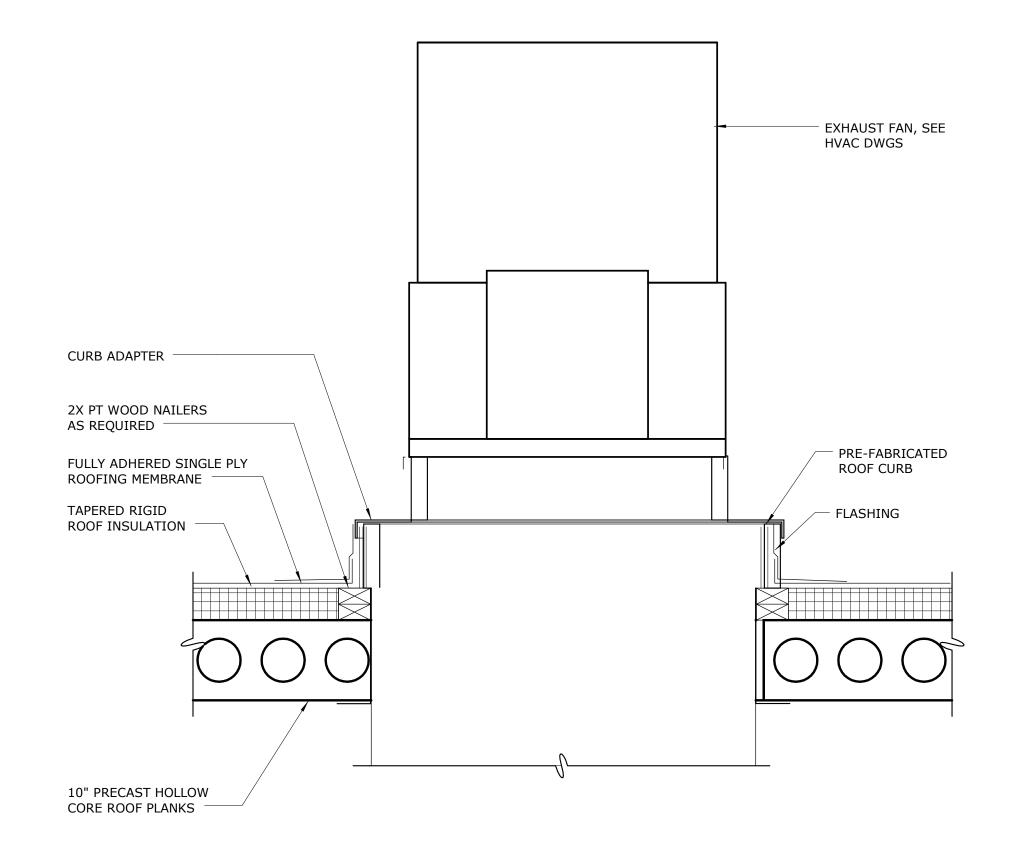

EXHAUST FAN

DETAIL 1

1" = 1'-0" A21

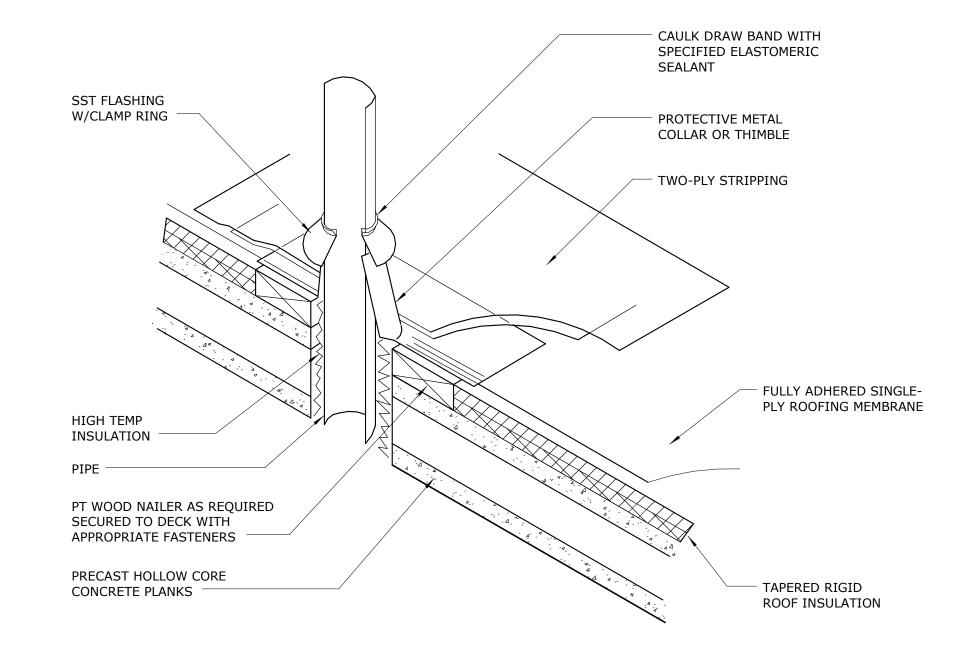

RISER VENT

DETAIL 2

NTS A21

				PROJECT ENGINEER:	M.J. BENCHICH
				DESIGNED BY:	W. RUSSELL
				DRAWN BY:	E. CARROLL
3	CONSTRUCTION	3-08-16	JCJ	CHECKED BY:	W. RUSSSELL
2	BUILDING PERMIT REVIEW	2-26-16	JCJ	IF THIS BAD DOES NOT	0 1/2" 1"
	REGULATORY REVIEW	1-20-16	JCJ	IF THIS BAR DOES NOT MEASURE 1" THEN DRAWING	0 1/2" 1"
REV	ISSUED FOR	DATE	BY	IS NOT TO FULL SCALE	






DAVIDSON COUNTY NORTH CAROLINA

DAVIDSON WATER INC.
HYATTOWN PUMP STATION IMPROVEMENTS

PUMP STATION ARCHITECTURAL DETAILS

DATE:	MARCH 2016
HAZEN NO.:	30961-010
CONTRACT NO.:	1
DRAWING NUMBER:	
	A3

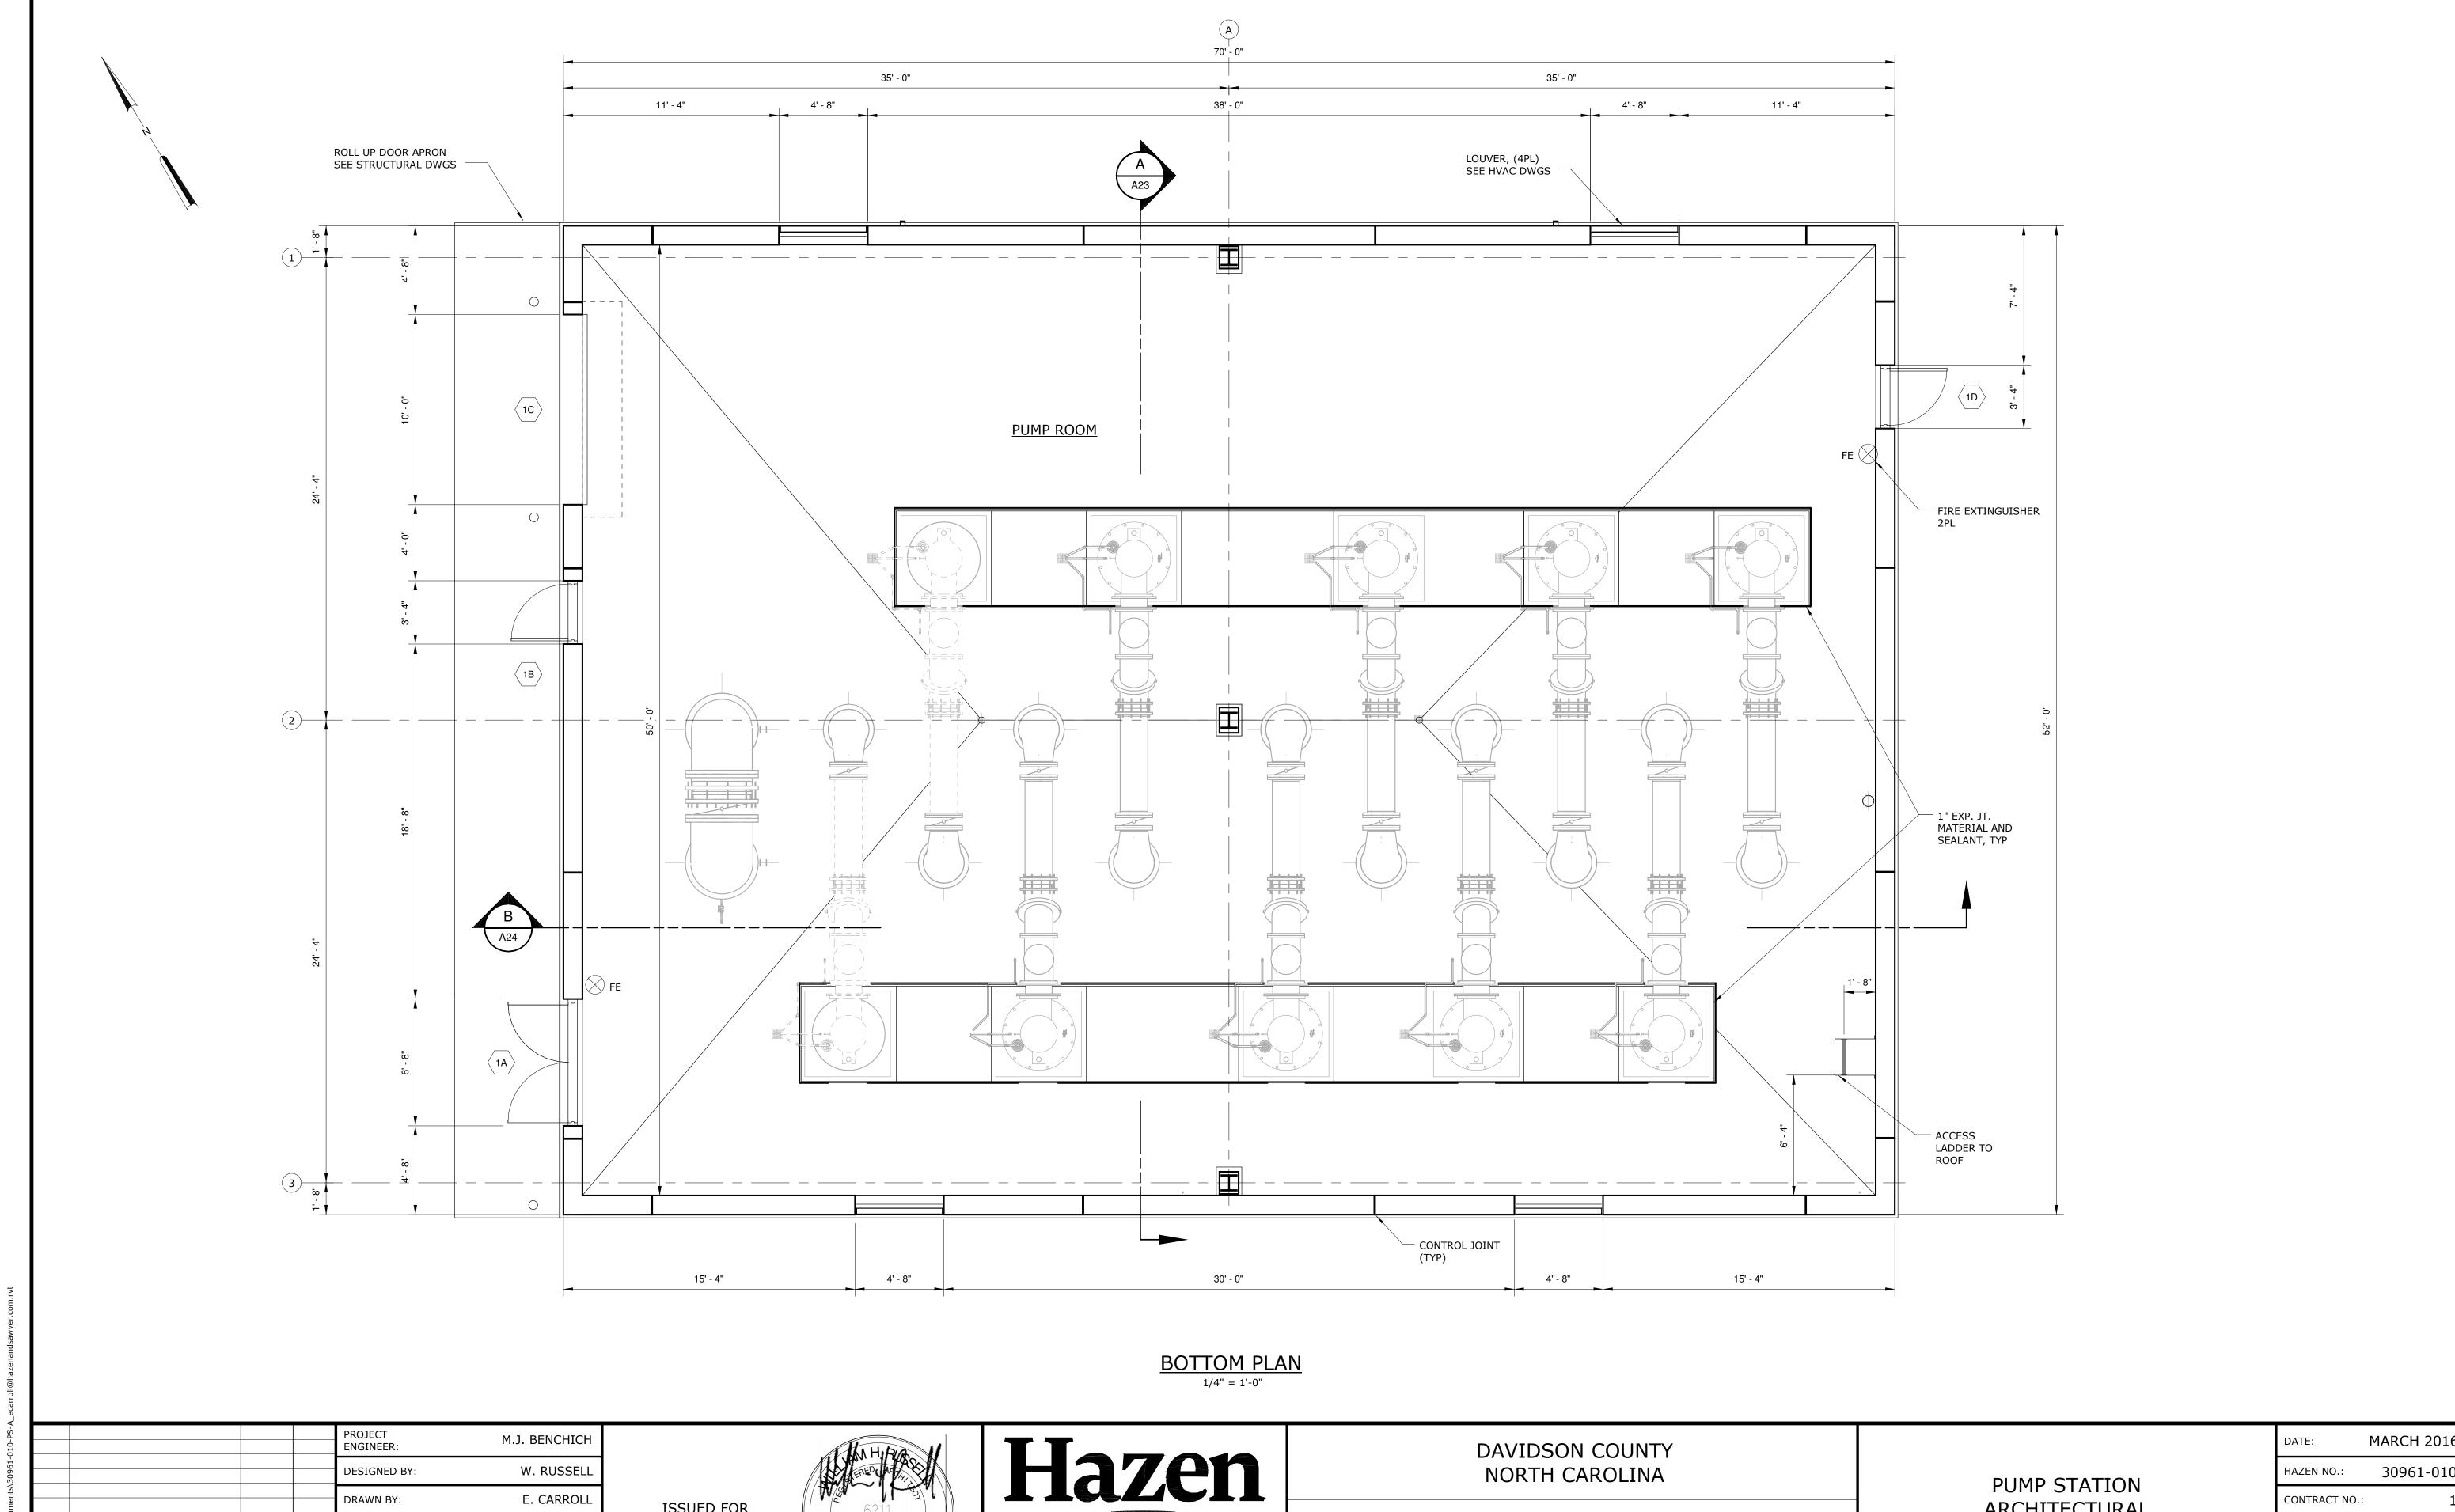

HAZEN AND SAWYER

4944 PARKWAY PLAZA BLVD, SUITE 375

CHARLOTTE, NORTH CAROLINA 28217 LICENSE NO.: C-0381

CONTRACT NO.:

A20

DRAWING NUMBER:

ARCHITECTURAL

**BOTTOM PLAN** 

DAVIDSON WATER INC.

HYATTOWN PUMP STATION IMPROVEMENTS

E. CARROLL

W. RUSSSELL

0 1/2" 1'

ISSUED FOR

CONSTRUCTION

DRAWN BY:

CHECKED BY:

IF THIS BAR DOES NOT MEASURE 1" THEN DRAWING IS NOT TO FULL SCALE

3-08-16

2-26-16

1-20-16


DATE

CONSTRUCTION

BUILDING PERMIT REVIEW

REGULATORY REVIEW

ISSUED FOR

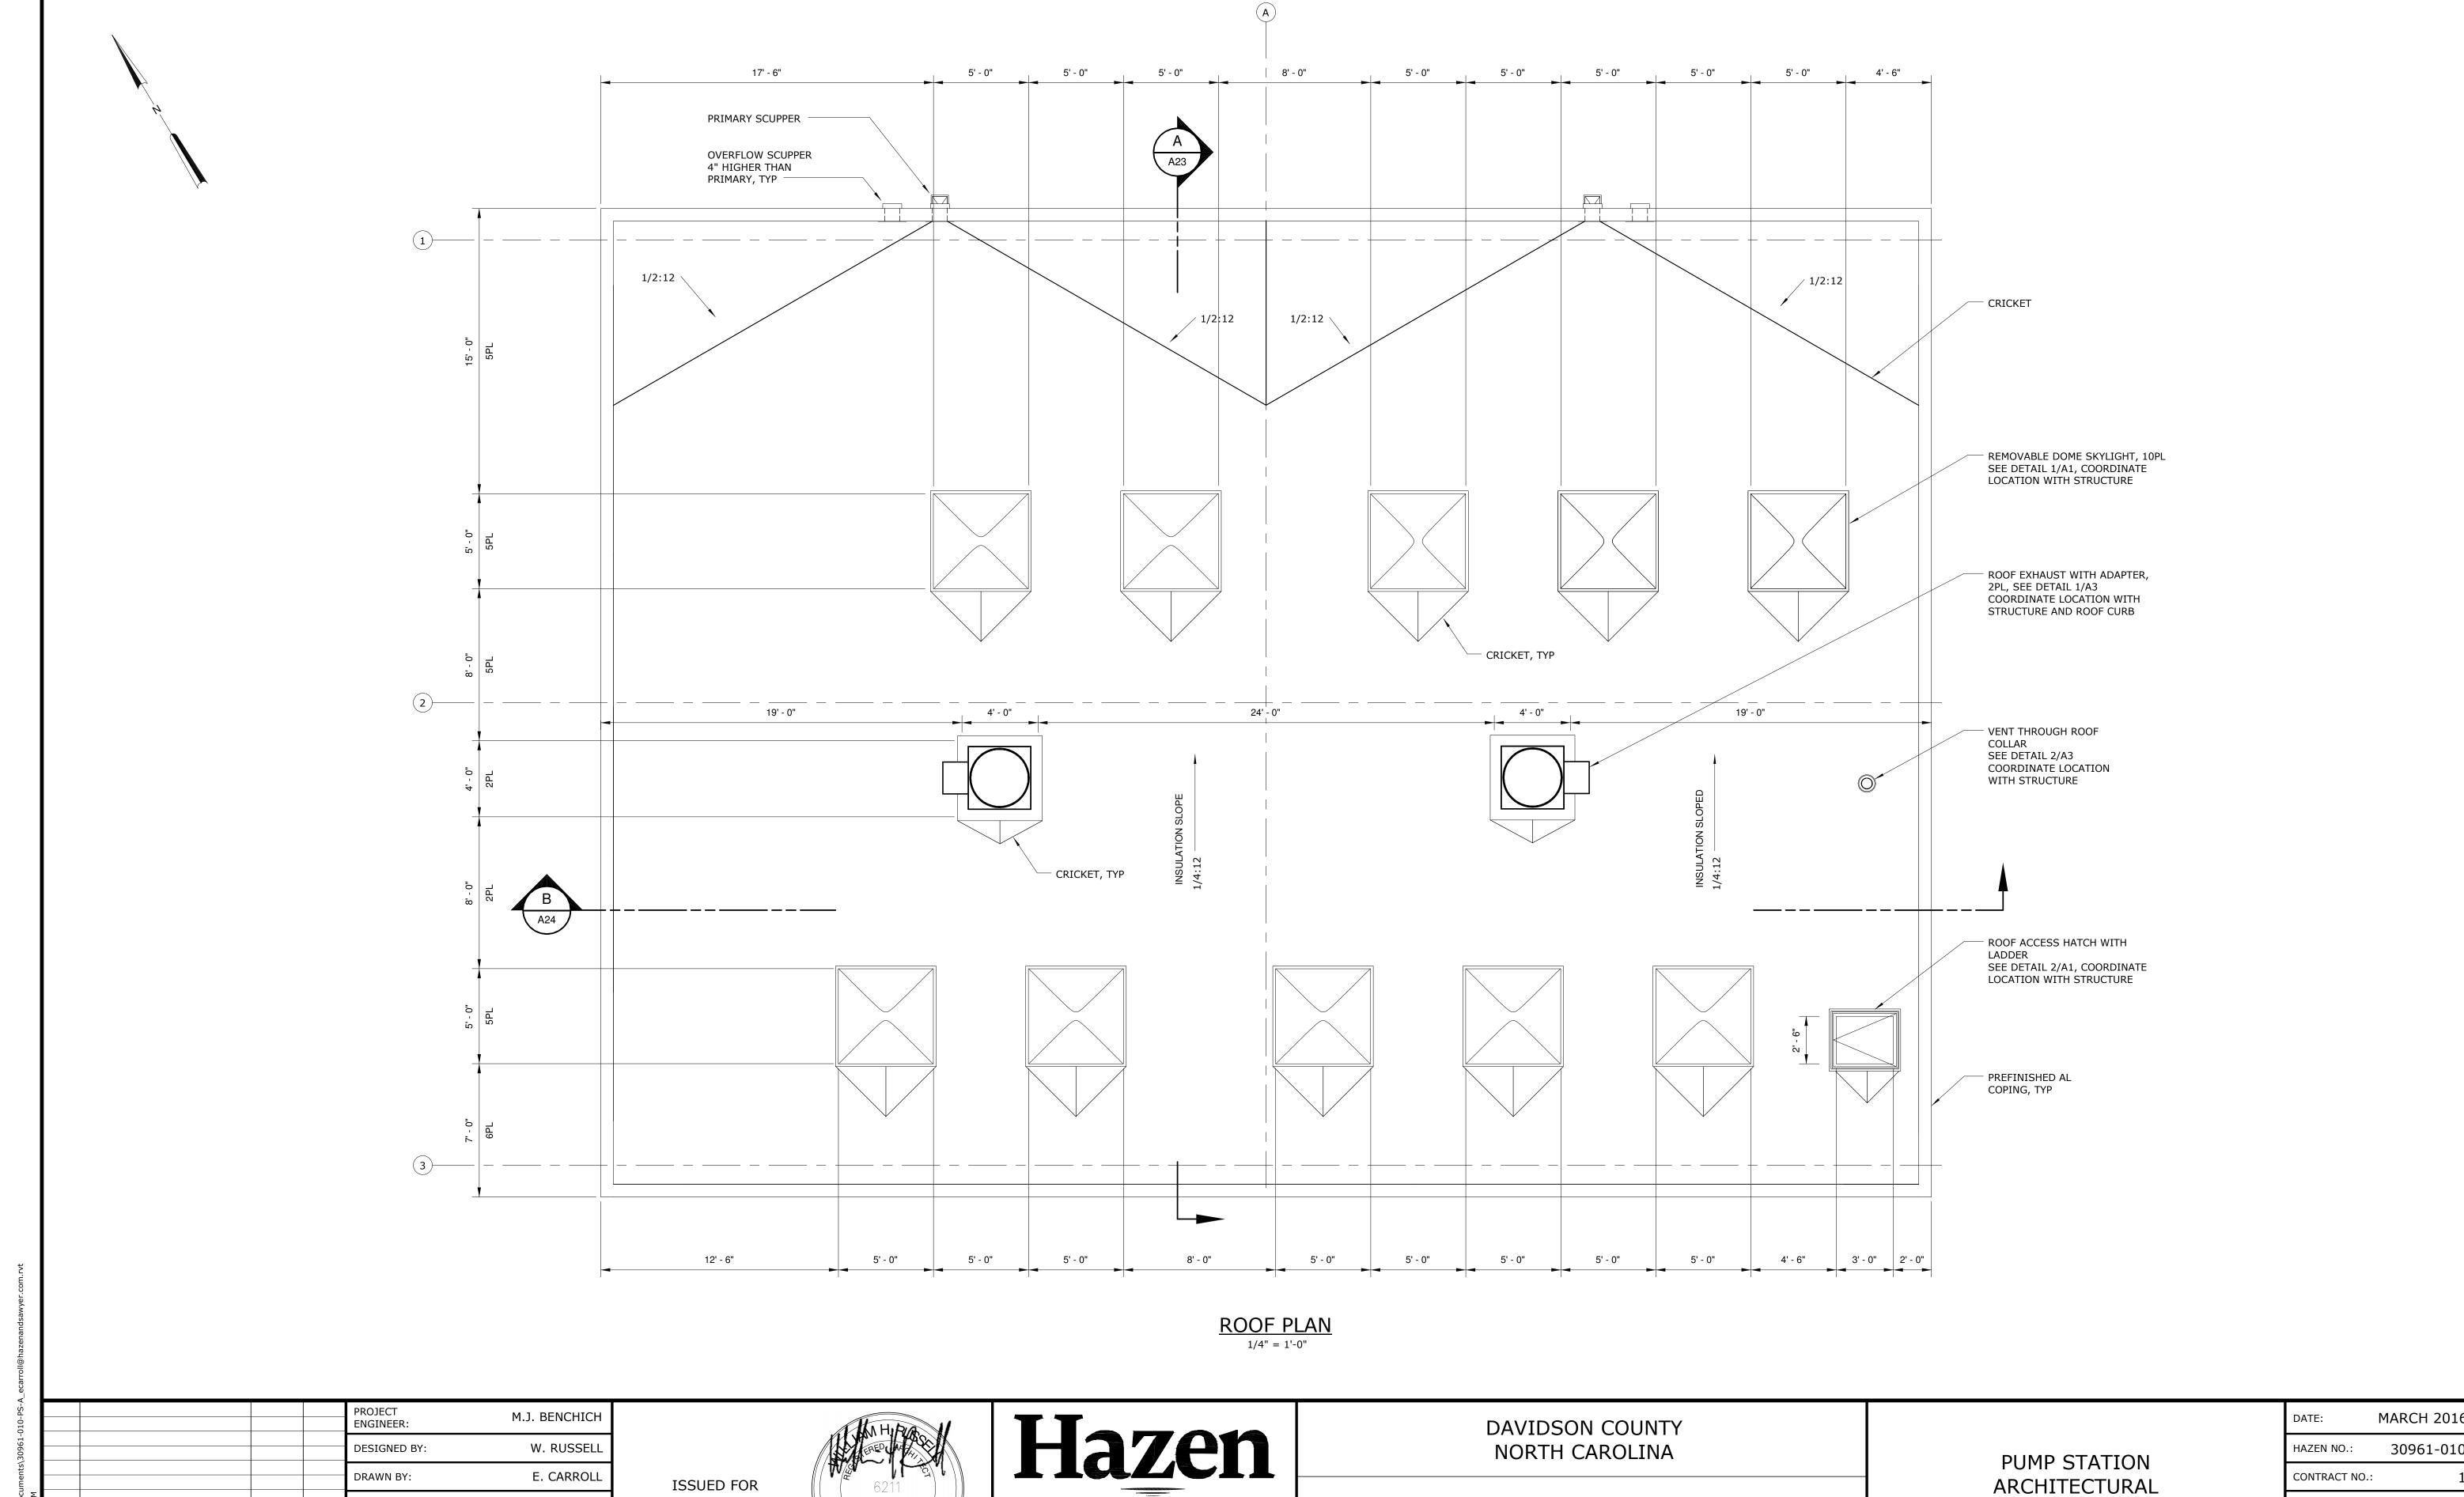

HAZEN AND SAWYER

4944 PARKWAY PLAZA BLVD, SUITE 375

CHARLOTTE, NORTH CAROLINA 28217

LICENSE NO.: C-0381

DRAWING NUMBER:

A21

**ROOF PLAN** 

DAVIDSON WATER INC.

HYATTOWN PUMP STATION IMPROVEMENTS

CONSTRUCTION

W. RUSSSELL

0 1/2" 1

CHECKED BY:

IF THIS BAR DOES NOT MEASURE 1" THEN DRAWING IS NOT TO FULL SCALE

3-08-16

2-26-16

1-20-16

DATE

C:\Users\ecarroll\Documents\30961-010-PS-,

CONSTRUCTION


BUILDING PERMIT REVIEW

REGULATORY REVIEW

ISSUED FOR


# — CONTROL JOINT (TYP) OVERFLOW SCUPPER, 2PL EL 841.75 EL 837.08 EL 821.75 LOUVER (4PL) - PRIMARY SCUPPER, 2PL SEE HVAC DWGS 4' - 8" 2PL 4' - 8" 22' - 8" 15' - 4" 2PL

# NORTH ELEVATION 1/8" = 1'-0"

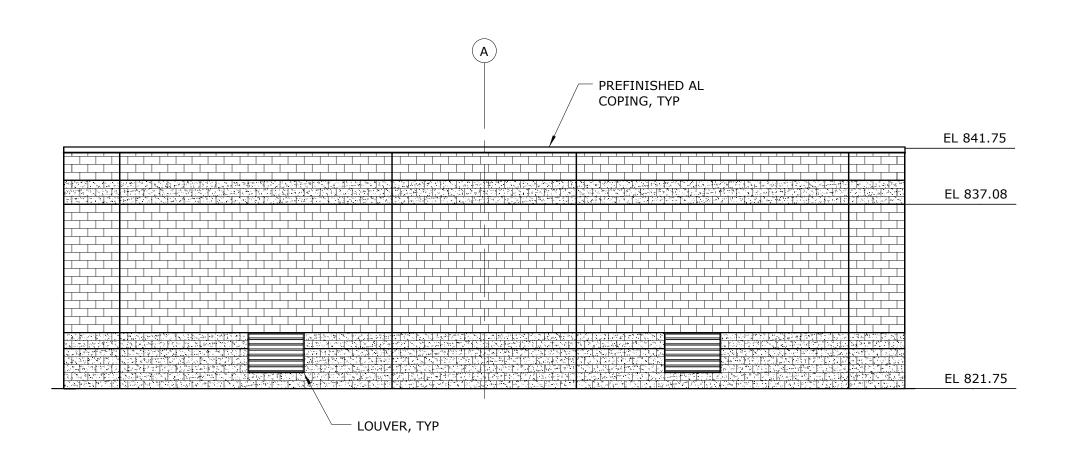


SOUTH ELEVATION

1/8" = 1'-0"

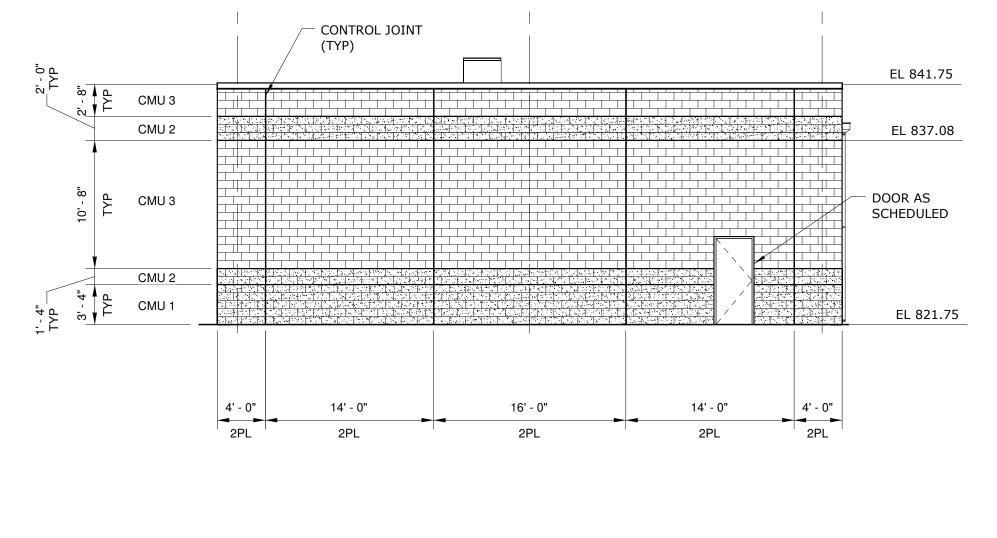

EAST ELEVATION

1/8" = 1'-0"

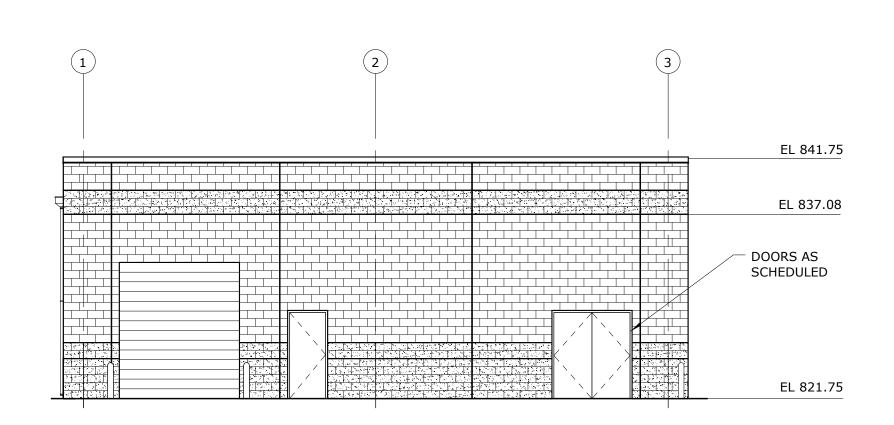

WEST ELEVATION

1/8" = 1'-0"

				PROJECT ENGINEER:	M.J. BENCHICH
				DESIGNED BY:	W. RUSSELL
				DRAWN BY:	E. CARROLL
3	CONSTRUCTION	3-08-16	JCJ	CHECKED BY:	W. RUSSSELL
2	BUILDING PERMIT REVIEW	2-26-16	JCJ	IF THIS BAD DOES NOT	0 1/2" 1"
1	REGULATORY REVIEW	1-20-16	JCJ	IF THIS BAR DOES NOT 0 1/2"  MEASURE 1" THEN DRAWING	0 1/2 1
REV	ISSUED FOR	DATE	BY	IS NOT TO FULL SCALE	

ISSUED FOR CONSTRUCTION

6211

CAROLE SHELL INC.



DAVIDSON COUNTY NORTH CAROLINA

DAVIDSON WATER INC.
HYATTOWN PUMP STATION IMPROVEMENTS

PUMP STATION ARCHITECTURAL ELEVATIONS

NOTES:

COATING.

1. CMU COLOR SHALL BE SELECTED BY OWNER. SUGGESTED COLORS ARE AS FOLLOWS:

 DOOR, LOUVER, DOWNSPOUT AND METAL COPING CAP COLOR SHALL BE AS SELECTED BY OWNER. SUGGESTED FINISH IS FLUORPOLYMER DARK GRAY

CMU 1 SPLIT FACE LIGHT GRAY
CMU 2 SPLIT FACE DARK GRAY
CMU 3 SMOOTH YELLOW TAN

DATE: MARCH 2016


HAZEN NO.: 30961-010

CONTRACT NO.: 1

DRAWING NUMBER: A22



1. WHERE CMU IS INDICATED IN DETAIL, SEE ELEVATIONS FOR FINISH TYPE AND COLOR.

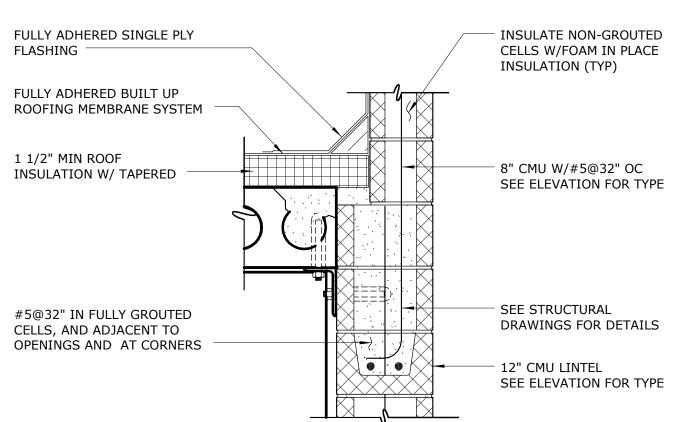

## SCUPPER THRU PARAPET

8" CMU W/#5 DOWELS @32" OC IN GROUTED CELLS SEE ELEVATION FOR TYPE

WELD WATERTIGHT

AL, SCUPPER SET IN

FLASHING CEMENT

SCUPPER -

CUT BLOCK

FULLY GROUT ALL

12" CMU LINTEL

CELLS ABOVE CONT BOND BEAM -

SEE ELEVATION FOR TYPE

INSULATE NON-GROUTED

CELLS W/FOAM IN PLACE

INSULATION (TYP)

PREFINISHED AL COPING

FLASHING

FASTENERS APPROX 3" OC

PT WOOD BLOCKING

FULLY ADHERED SINGLE

PLY ROOF MEMBRANE

1 1/2" MIN ROOF

10" HOLLOW CORE

CONCRETE PLANKS

GROUT FILL AS REQ'D


#5@32" IN FULLY GROUTED

CELLS, AND ADJACENT TO

INSULATION

W/TAPERED


**DETAIL** 

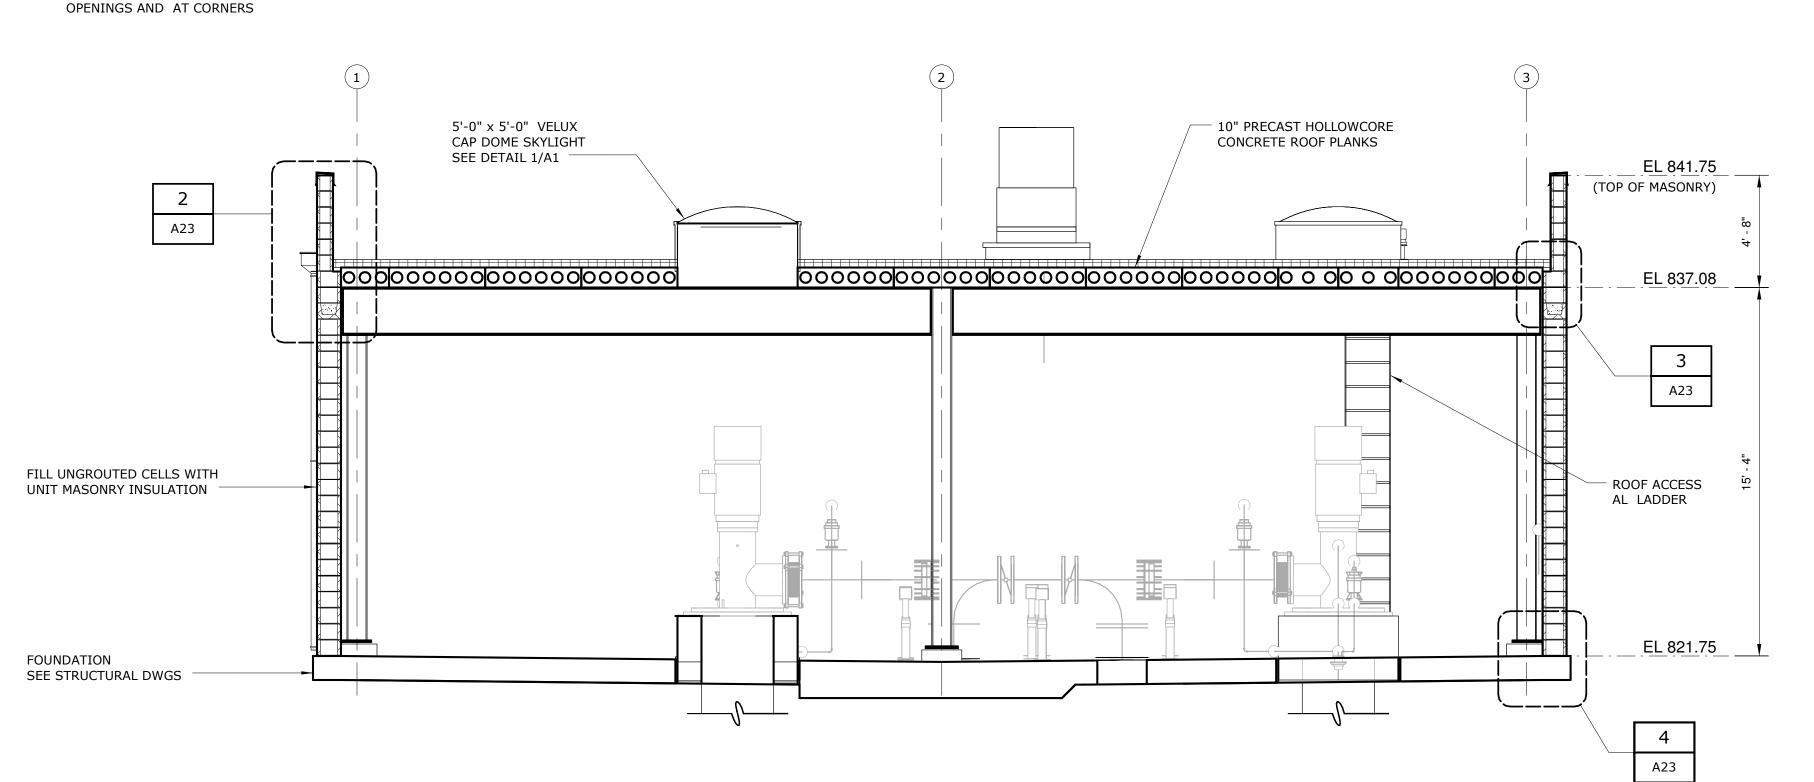



# CMU WALL AT HOLLOW-CORE ROOF PLANKS

DETAIL	3
1" = 1'-0"	A23

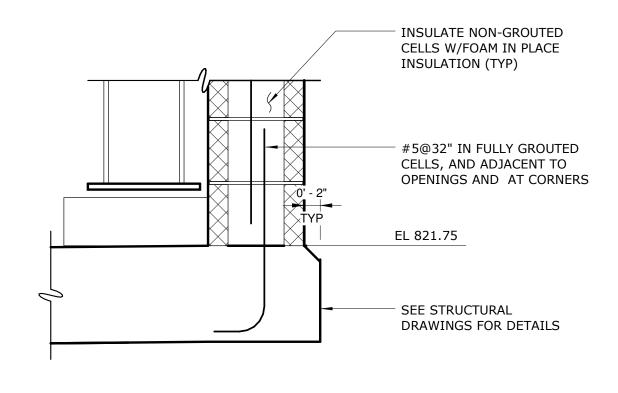

# CMU WALL AT FOUNDATION

DETAIL	4
1" = 1'-0"	A23

				PROJECT ENGINEER:	M.J. BENCHICH
				DESIGNED BY:	W. RUSSELL
				DRAWN BY:	E. CARROLL
3	CONSTRUCTION	3-08-16	JCJ	CHECKED BY:	W. RUSSSELL
2	BUILDING PERMIT REVIEW	2-26-16	JCJ	TE THIC DAD DOES NOT	0 1/2" 1"
1	REGULATORY REVIEW	1-20-16	JCJ	IF THIS BAR DOES NOT 0 1/2"  MEASURE 1" THEN DRAWING	0 1/2" 1"
REV	ISSUED FOR	DATE	BY	IS NOT TO FULL SCALE	



Hazen HAZEN AND SAWYER 4944 PARKWAY PLAZA BLVD, SUITE 375

CHARLOTTE, NORTH CAROLINA 28217 LICENSE NO.: C-0381

DAVIDSON COUNTY NORTH CAROLINA


DAVIDSON WATER INC. HYATTOWN PUMP STATION IMPROVEMENTS

**PUMP STATION** ARCHITECTURAL SECTION AND DETAILS

DATE:	MARCH 2016
HAZEN NO.:	30961-010
CONTRACT NO.:	1
DRAWING NUMBER:	
	A23




 WHERE CMU IS INDICATED IN DETAIL, SEE ELEVATIONS FOR FINISH TYPE AND COLOR.

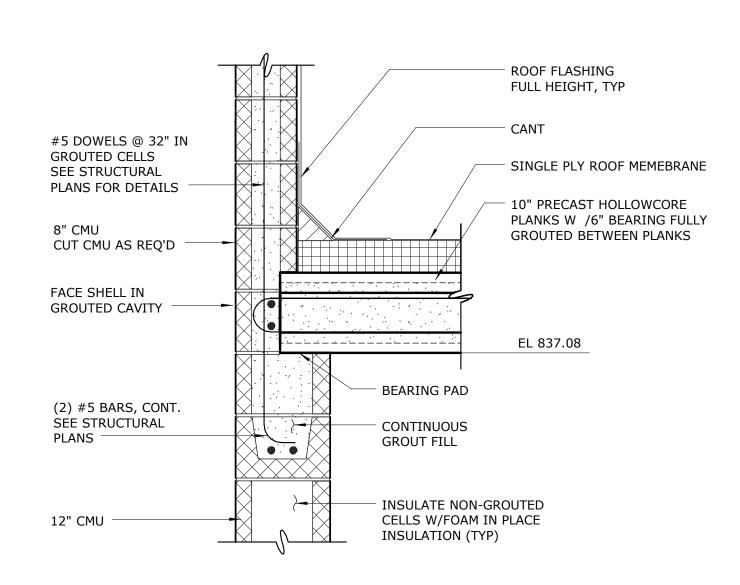

DETAIL 5

1" = 1'-0" A24

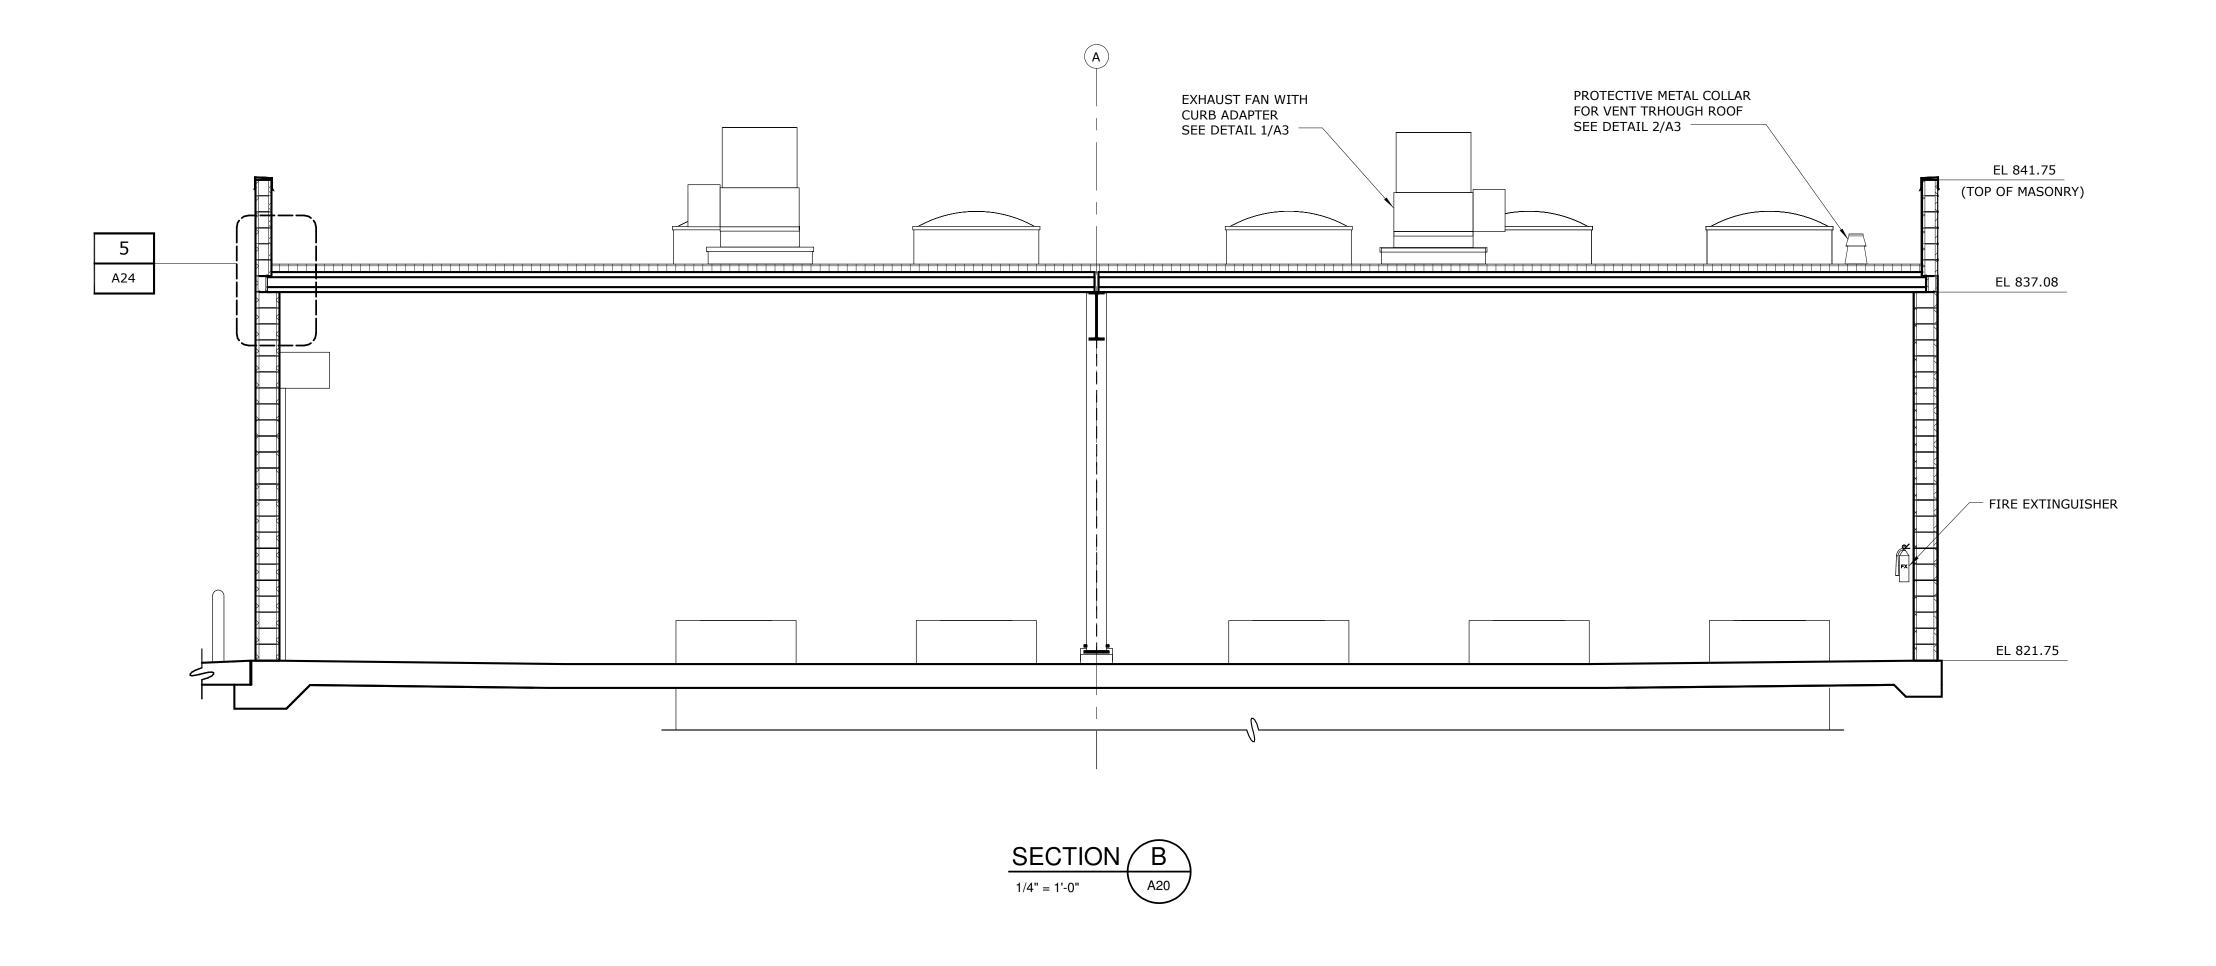

					PROJECT ENGINEER:	M.J. BENCHICH	
					DESIGNED BY:	W. RUSSELL	
					DRAWN BY:	E. CARROLL	
:46 AM	3	CONSTRUCTION	3-08-16	JCJ	CHECKED BY:	W. RUSSSELL	
9:21:46	2	BUILDING PERMIT REVIEW	2-26-16	JCJ	TE THIS DAD DOES NOT	0 1/2" 1"	
16 9	1	REGULATORY REVIEW	1-20-16	JCJ	IF THIS BAR DOES NOT 0 1/2"  MEASURE 1" THEN DRAWING	0 1/2 1	
9/2016	REV	ISSUED FOR	DATE	BY	IS NOT TO FULL SCALE		




HAZEN AND SAWYER
4944 PARKWAY PLAZA BLVD, SUITE 375

CHARLOTTE, NORTH CAROLINA 28217 LICENSE NO.: C-0381 DAVIDSON COUNTY NORTH CAROLINA

DAVIDSON WATER INC.
HYATTOWN PUMP STATION IMPROVEMENTS


PUMP STATION
ARCHITECTURAL
SECTION AND DETAIL

DATE:	MARCH 2016
HAZEN NO.:	30961-010
CONTRACT NO.:	1
DRAWING NUMBER:	
	A24

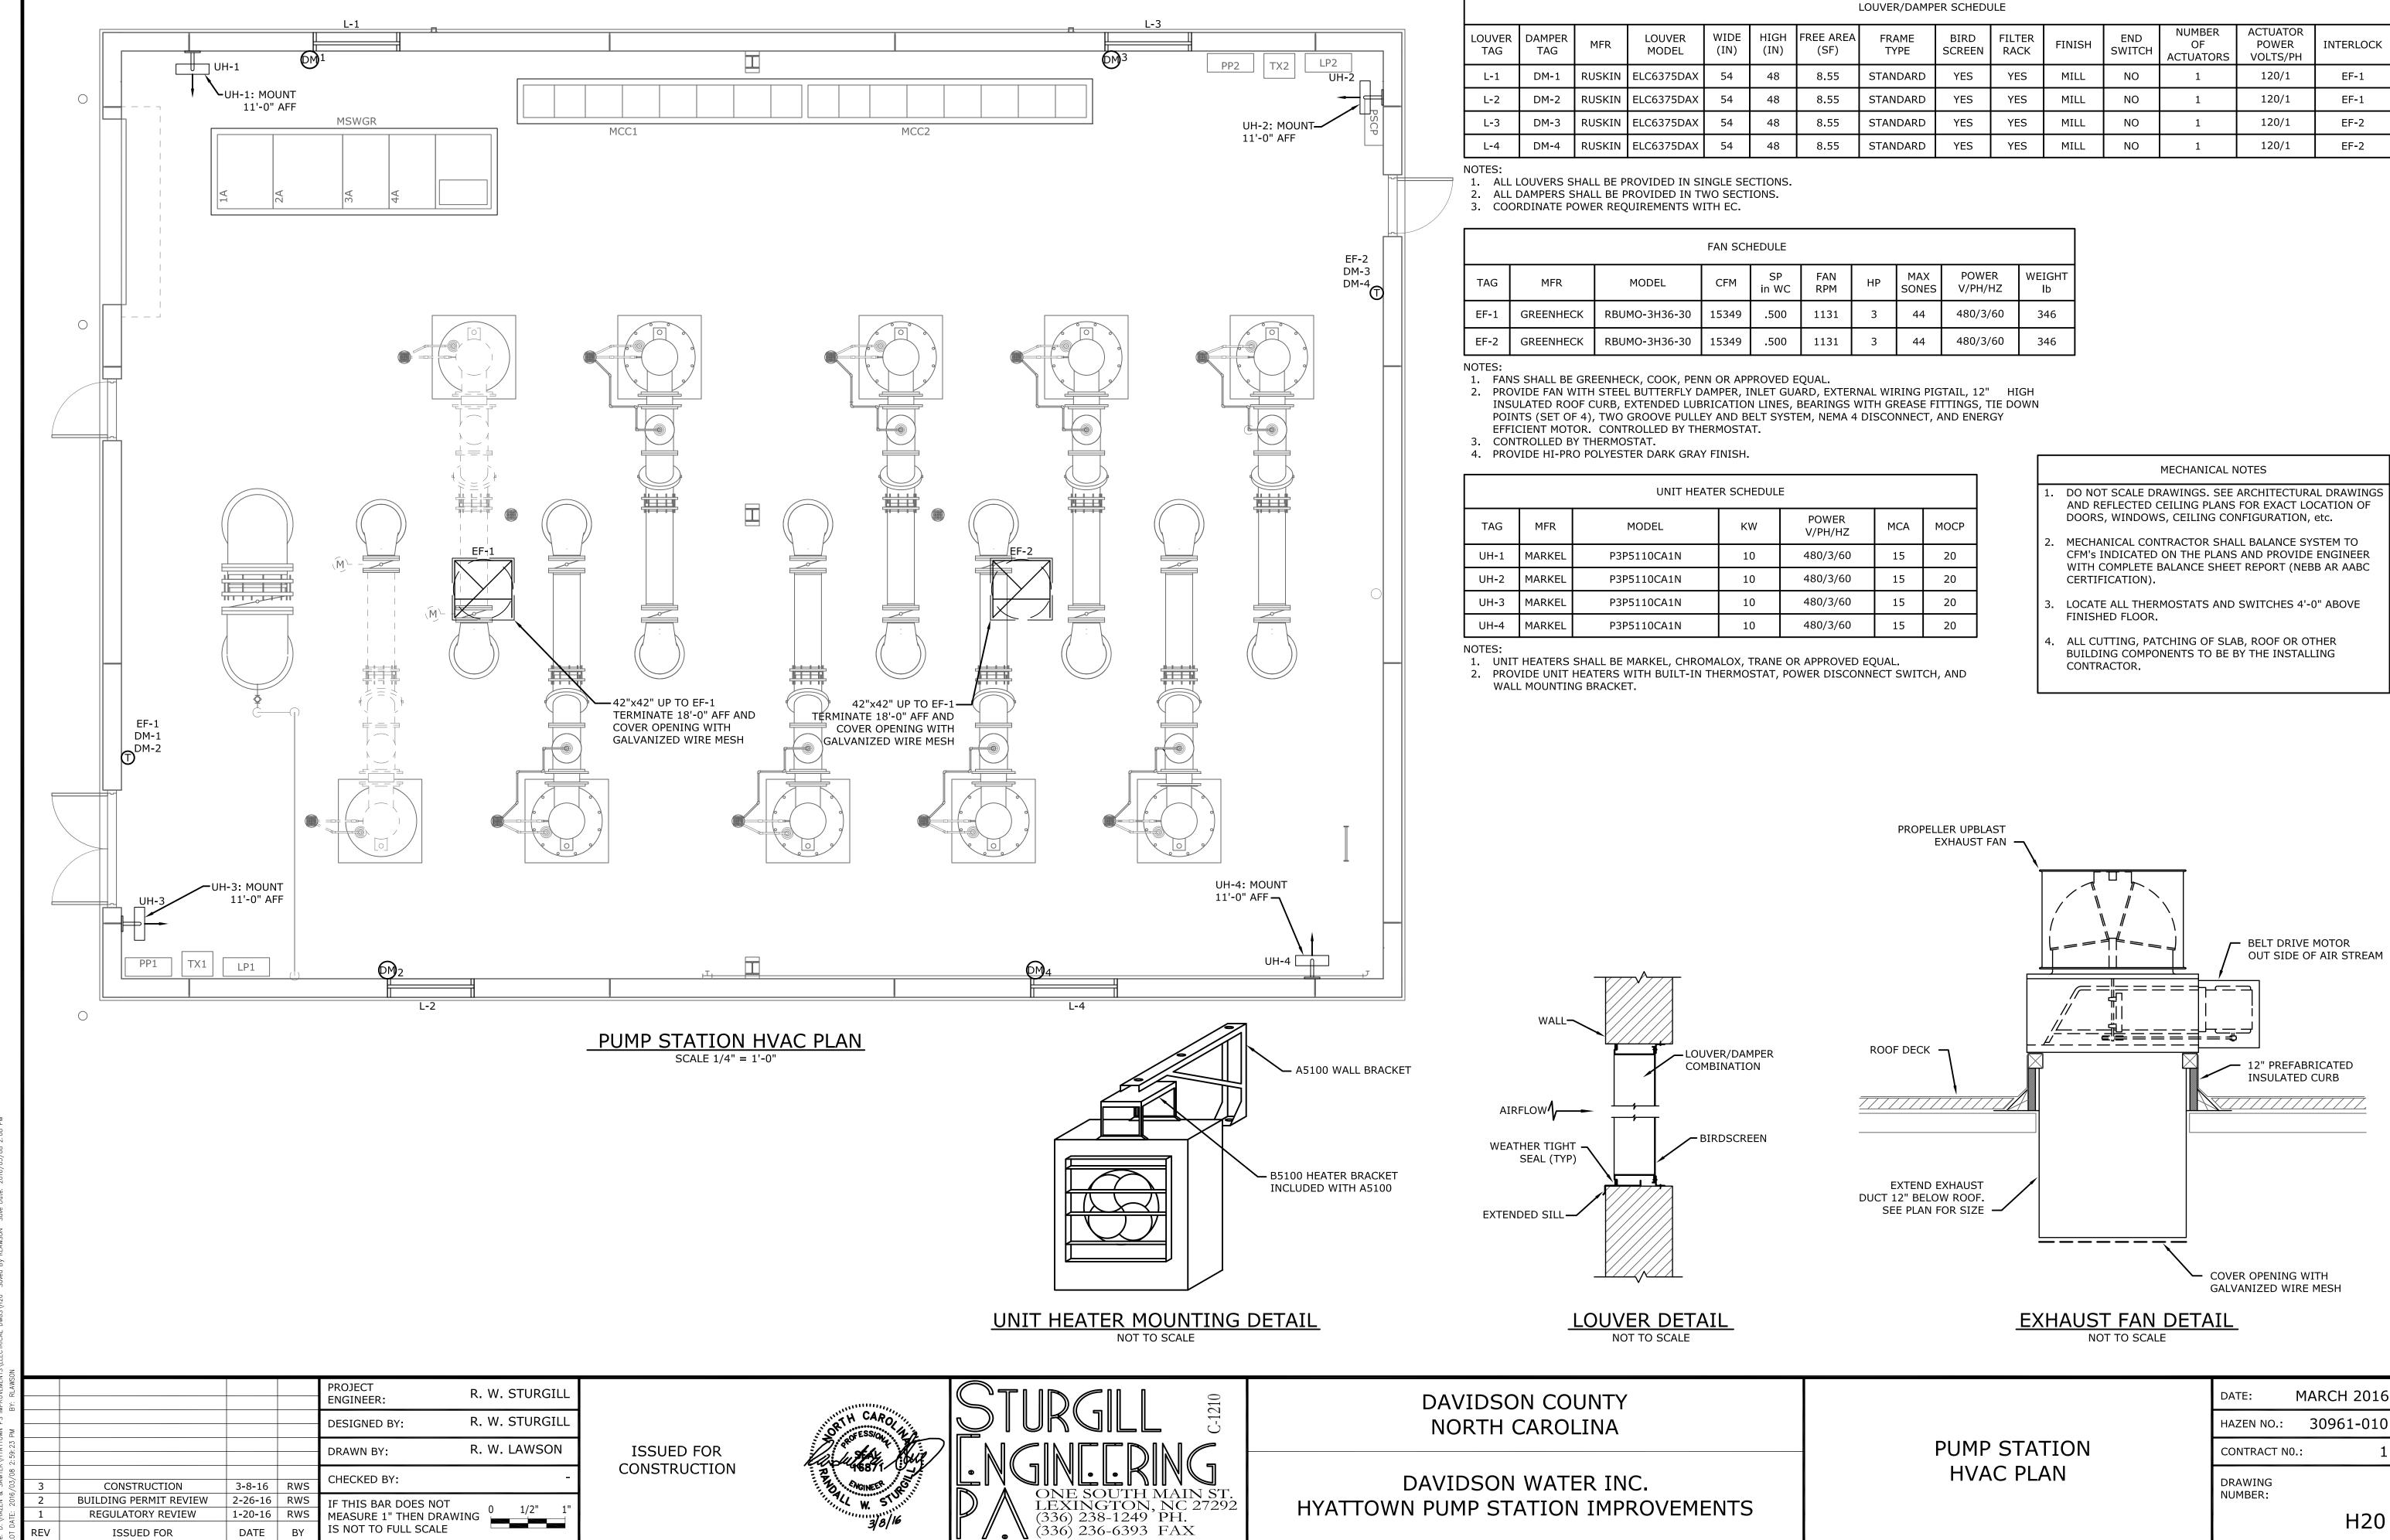

**ISSUED FOR** 

IS NOT TO FULL SCALE

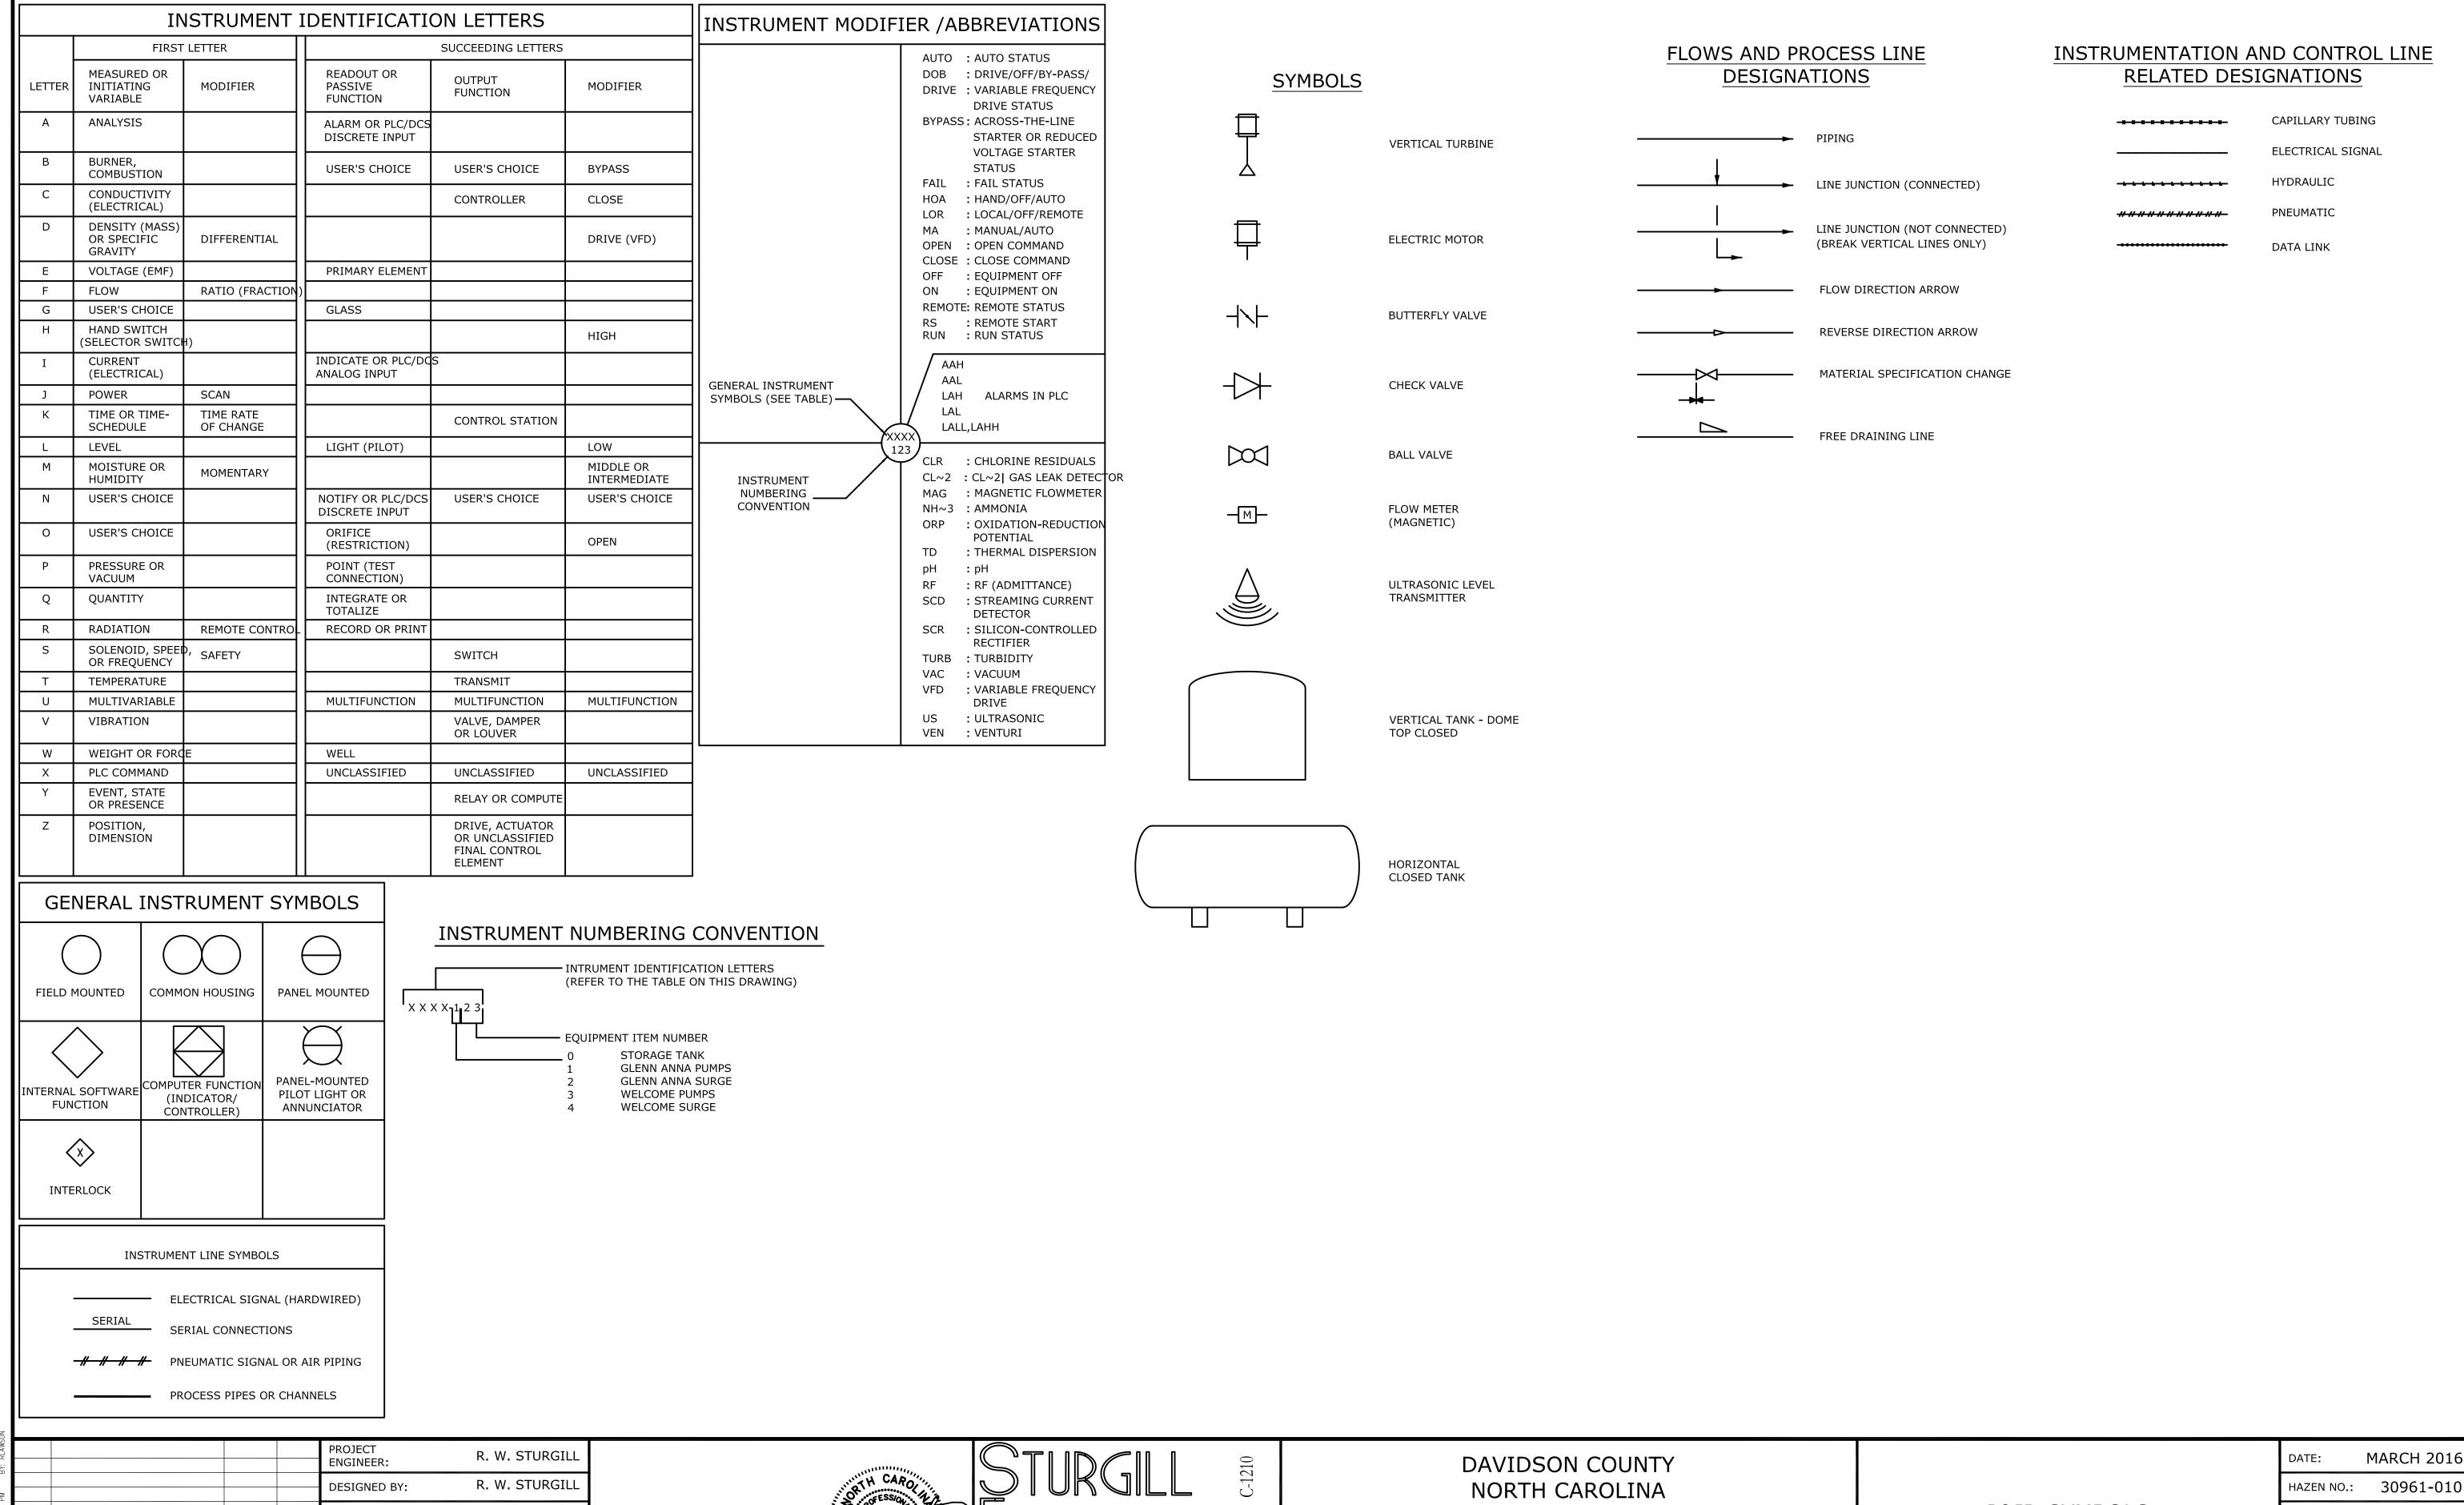

CONSTRUCTION

BUILDING PERMIT REVIEW

REGULATORY REVIEW

**ISSUED FOR** 

ISSUED FOR CONSTRUCTION

R. W. LAWSON

DRAWN BY:

CHECKED BY:

IF THIS BAR DOES NOT

IS NOT TO FULL SCALE

MEASURE 1" THEN DRAWING

3-8-16 RWS

2-26-16 RWS

1-20-16 RWS








DAVIDSON WATER INC. HYATTOWN PUMP STATION IMPROVEMENTS P&ID SYMBOLS AND LEGEND

30961-010 CONTRACT NO.: DRAWING

NUMBER:

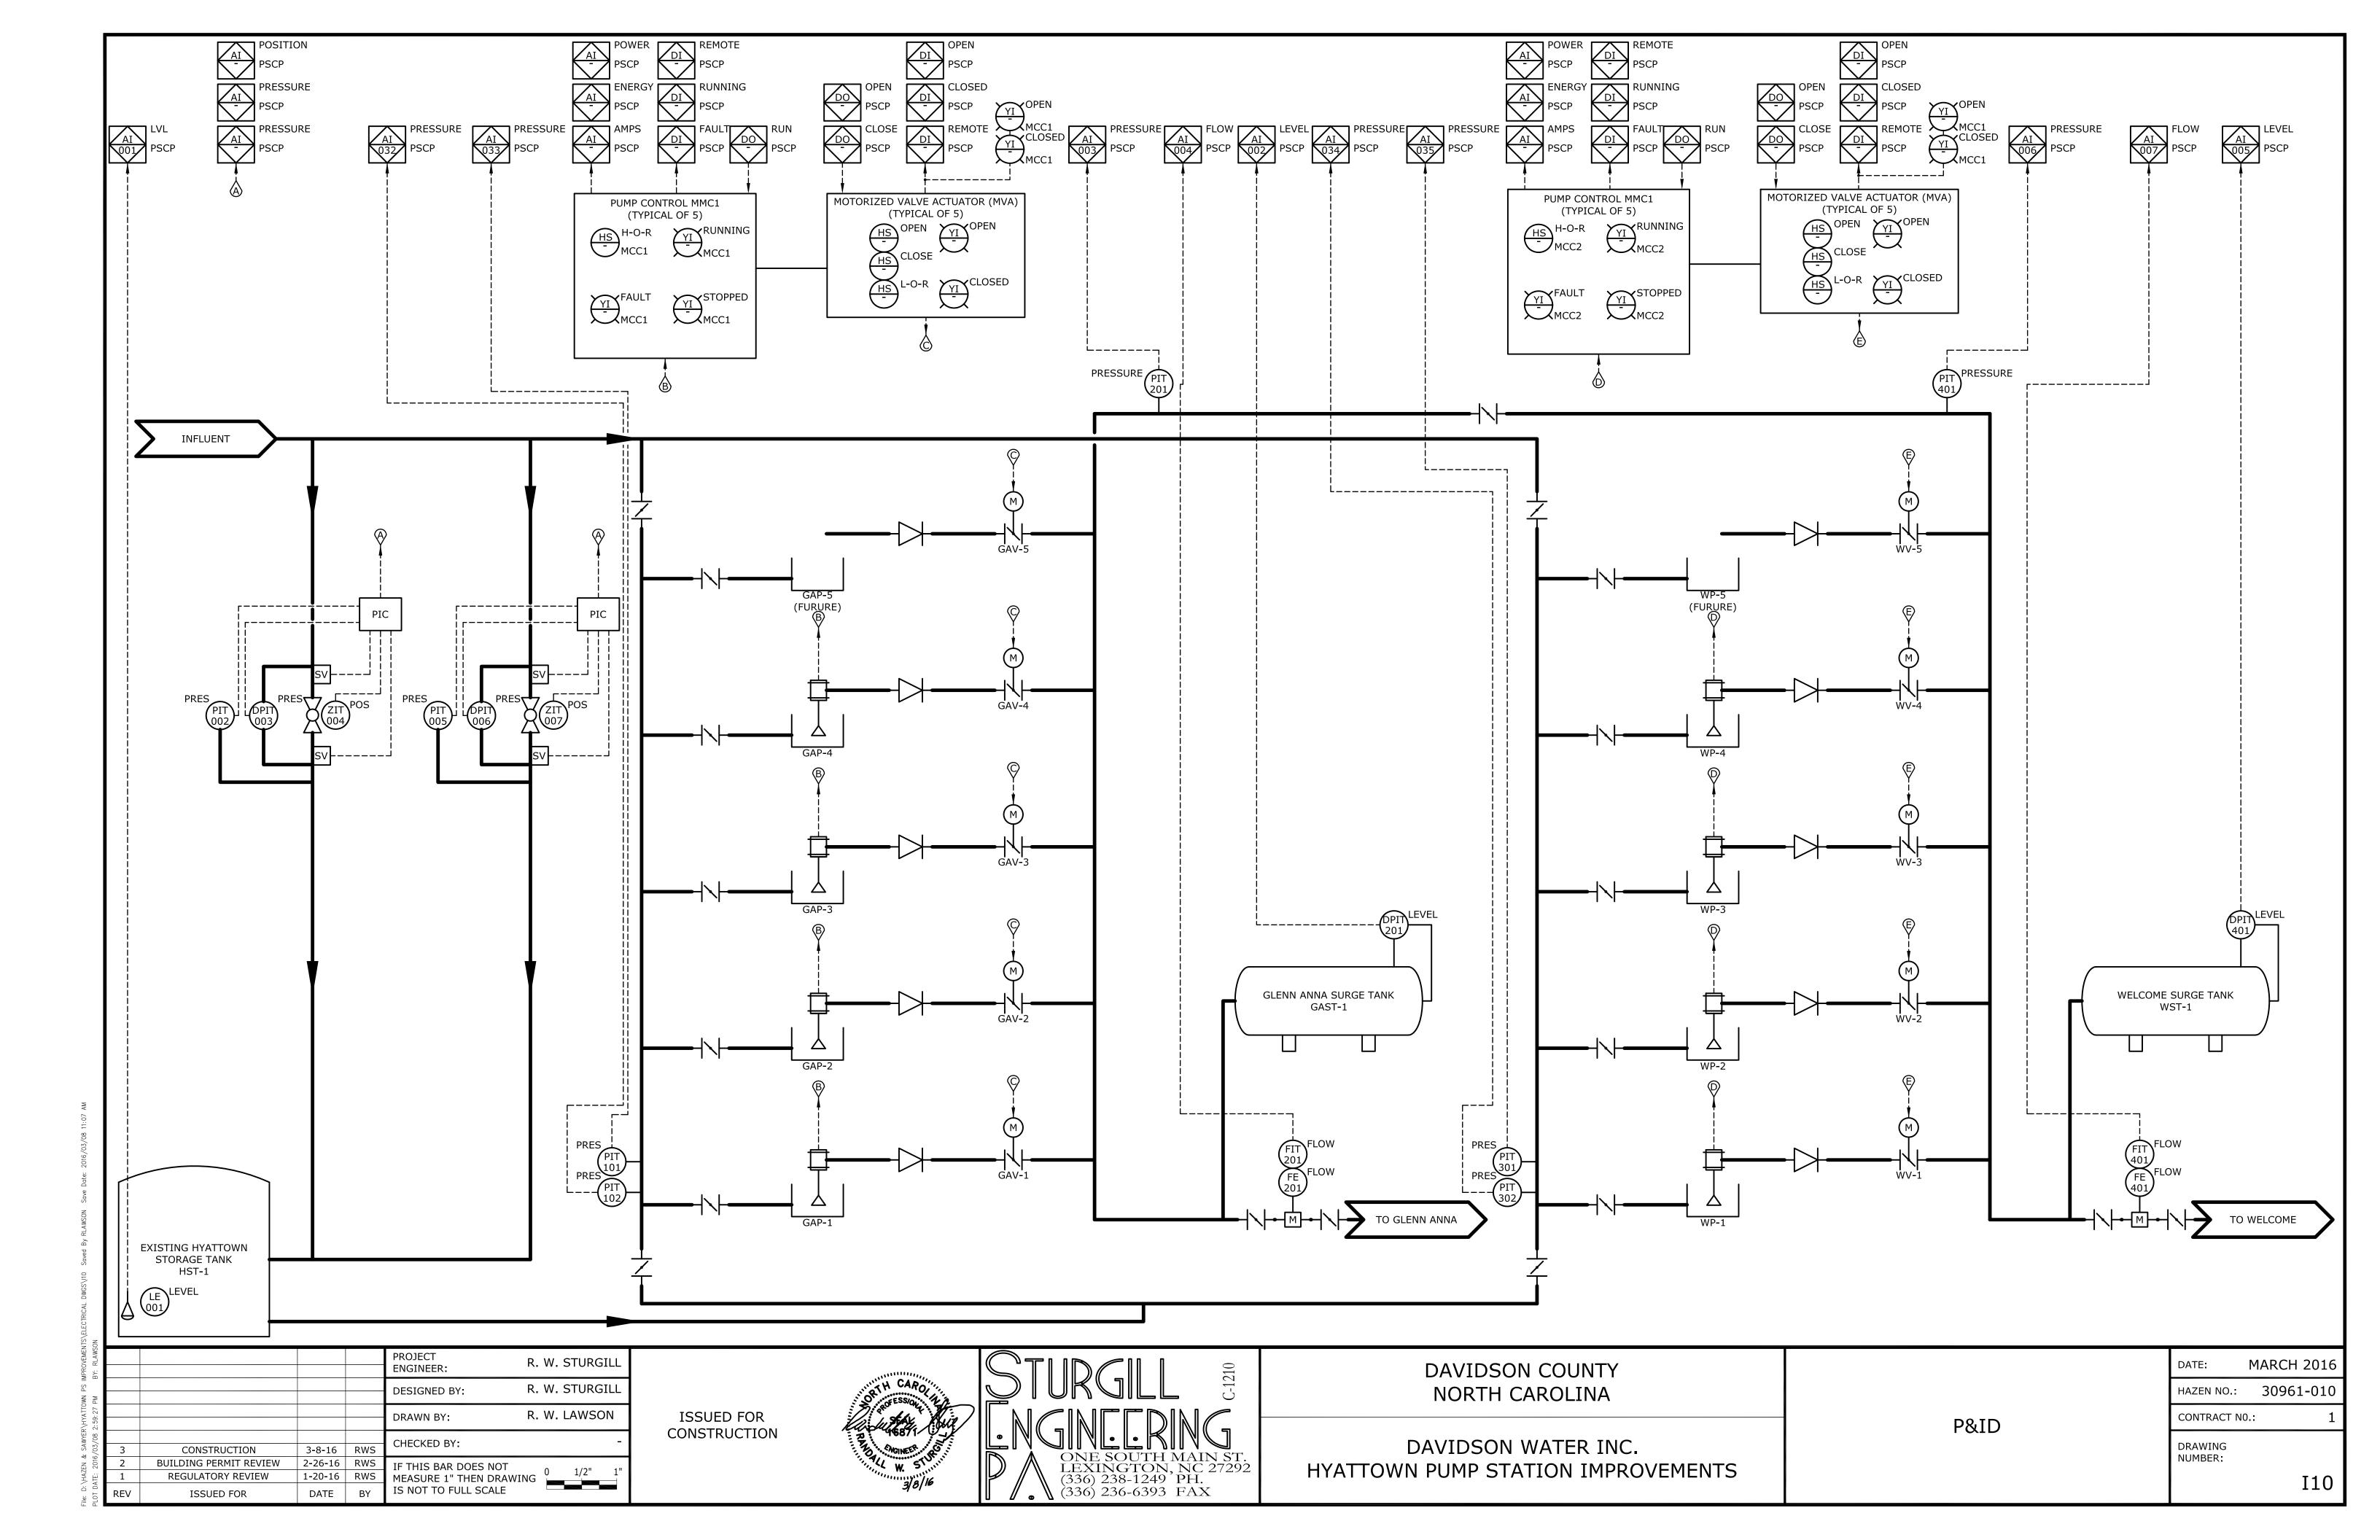

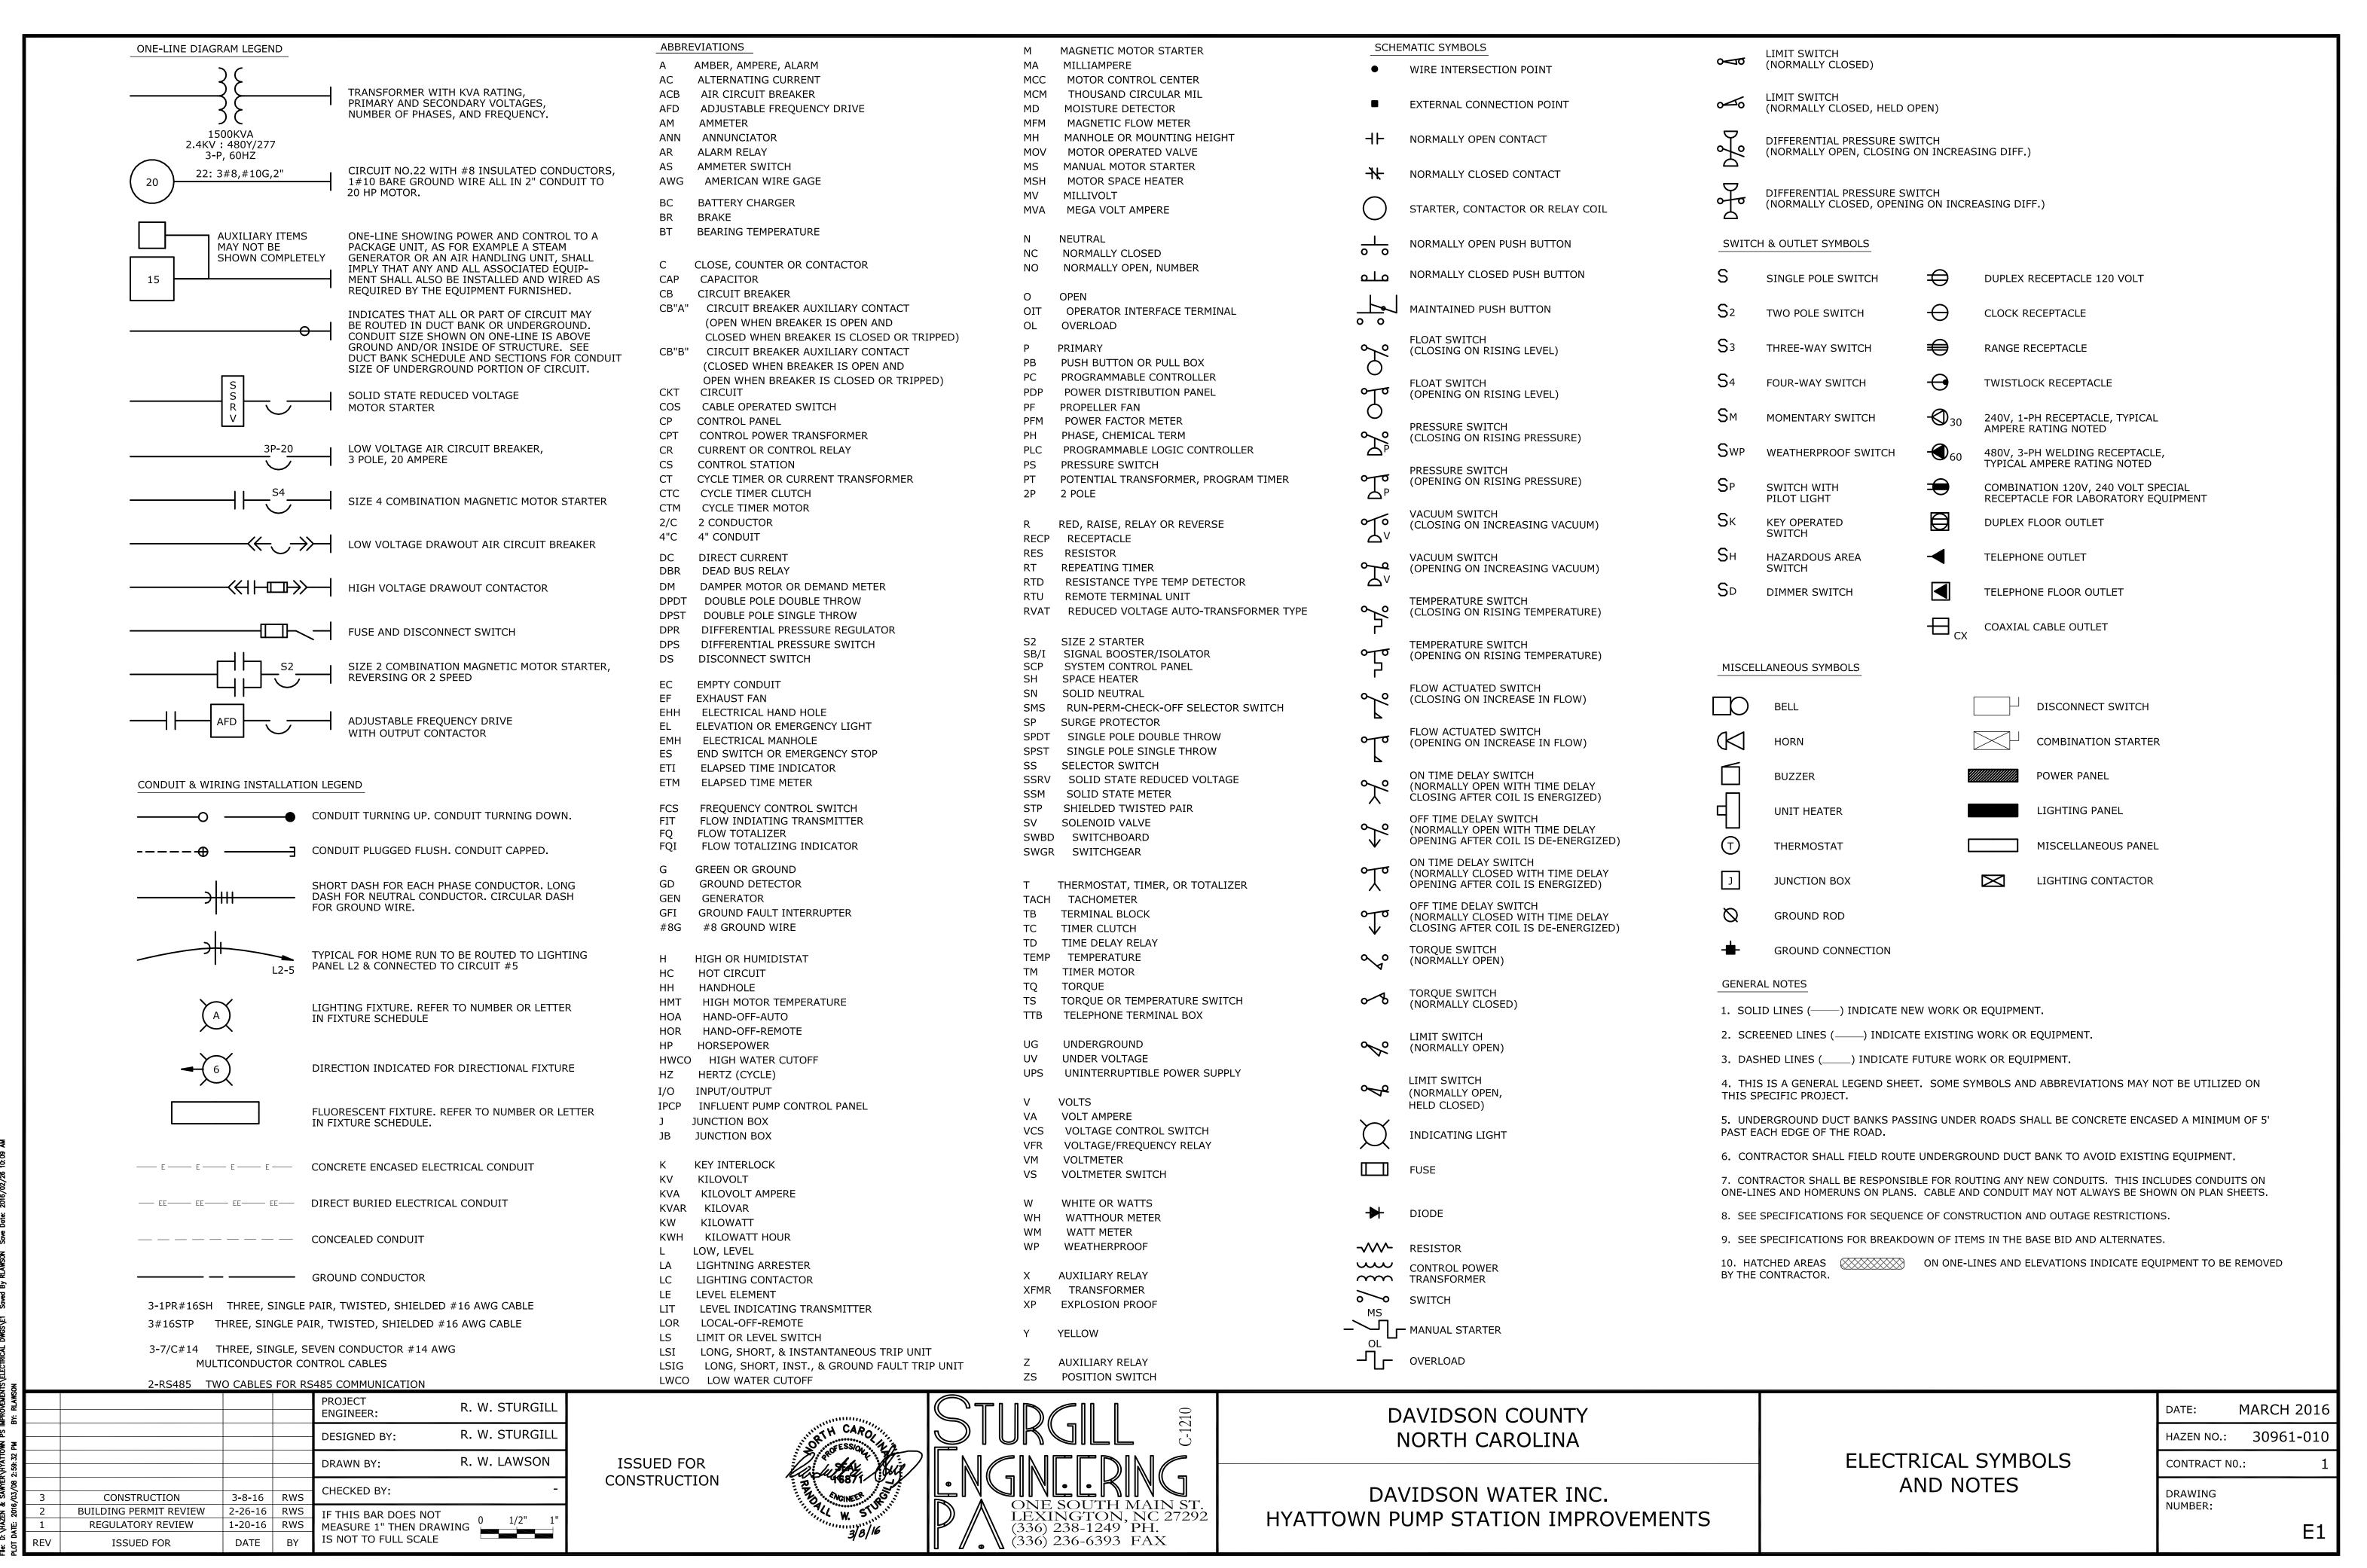

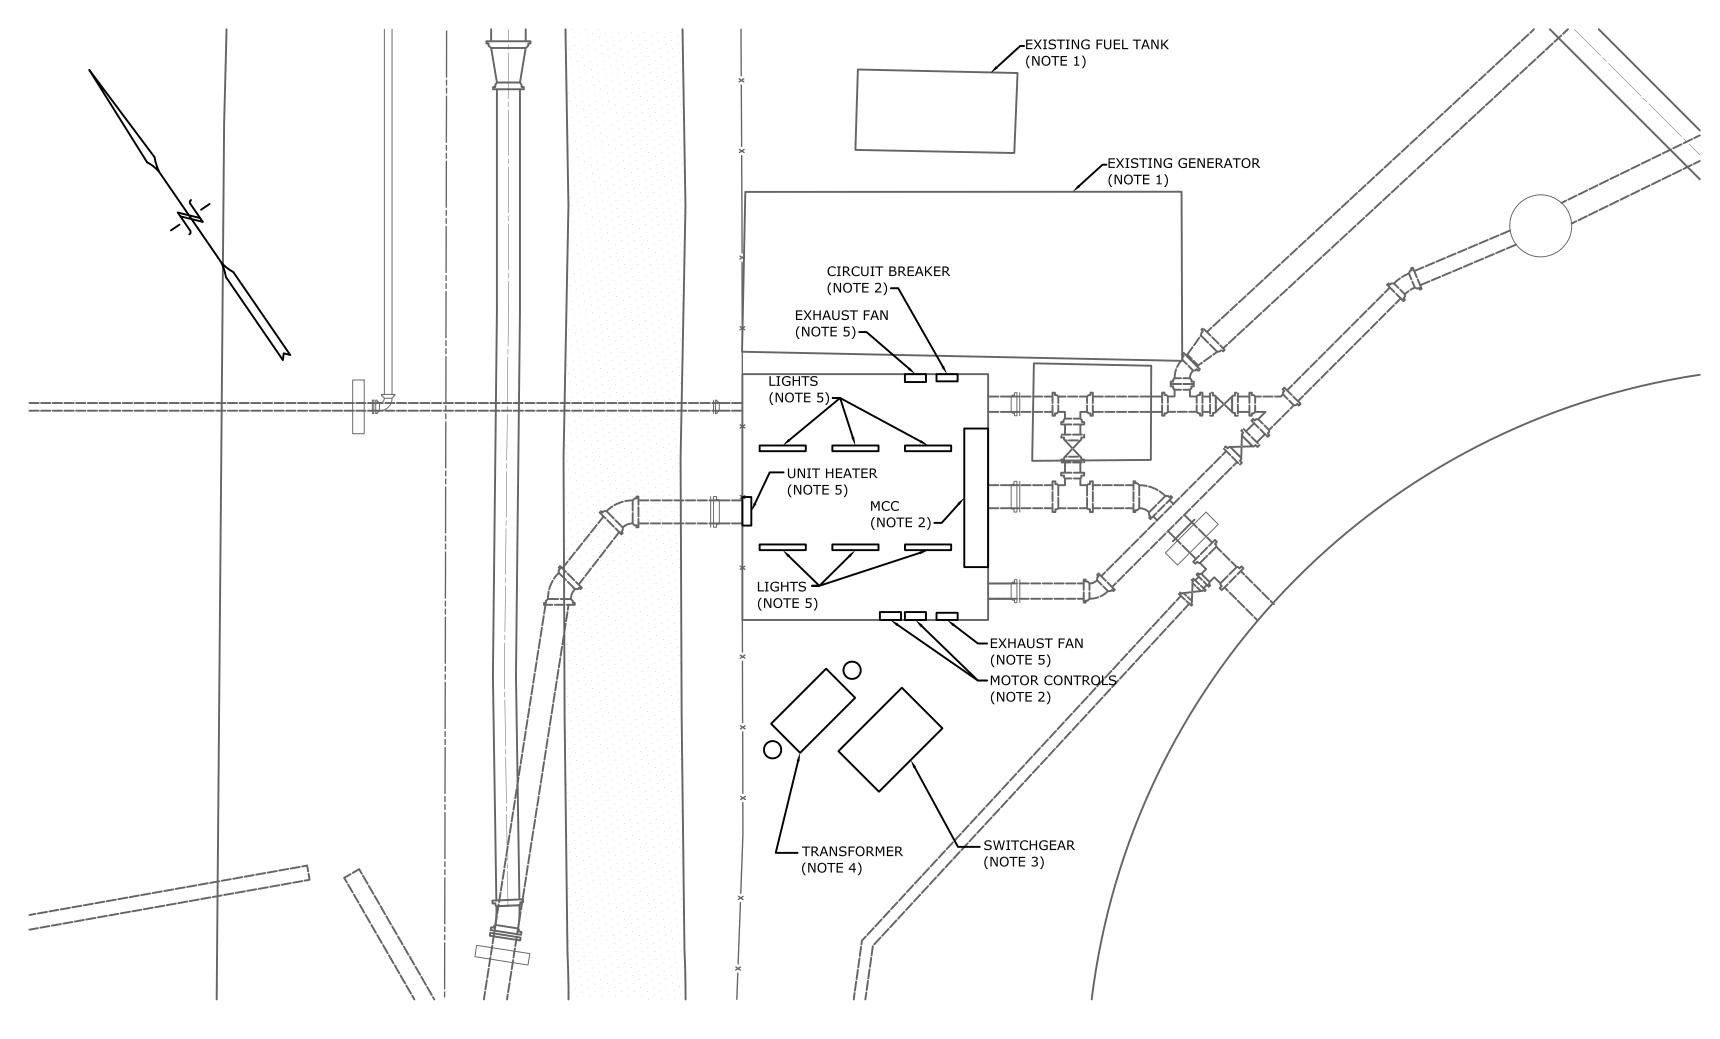

ELECTRICAL DEMOLITION PLAN

SCALE 1' = 100'

# NOTES:

- 1. ENGINE GENERATOR & FUEL TANK REMOVED BY OWNER.
- 2. EQUIPMENT TO BE REMOVED BY OWNER.
- SWITCHGEAR, PAD, AND ASSOCIATED CABLE AND CONDUIT DEMOLISHED BY CONTRACTOR. CUT CONDUIT BELOW GRADE.
- 4. TRANSFORMER AND STRUCTURE REMOVED BY DUKE ENERGY. CONDUITS BY CONTRACTOR.
- CONTRACTOR TO REFEED EXHAUST FAN, LOUVERS, RECEPTACLES, UNIT HEATER, AND LIGHTS FROM NEW PANEL.

				PROJECT R. W. STURGILL ENGINEER:
				DESIGNED BY: R. W. STURGILL
				DRAWN BY: R. W. LAWSON
				CHECKED BY: -
3	CONSTRUCTION	3-8-16	RWS	CHECKED DT:
2	BUILDING PERMIT REVIEW	2-26-16	RWS	IF THIS BAR DOES NOT 0 1/3" 1"
1	REGULATORY REVIEW	1-20-16	RWS	MEASURE 1" THEN DRAWING 0 1/2" 1"
REV	ISSUED FOR	DATE	BY	IS NOT TO FULL SCALE

ISSUED FOR CONSTRUCTION





DAVIDSON COUNTY NORTH CAROLINA

DAVIDSON WATER INC. HYATTOWN PUMP STATION IMPROVEMENTS ELECTRICAL DEMOLITION PLAN


DATE:	MARCH 2016
HAZEN NO.:	30961-010
CONTRACT N	0.: 1
DRAWING NUMBER:	

E2

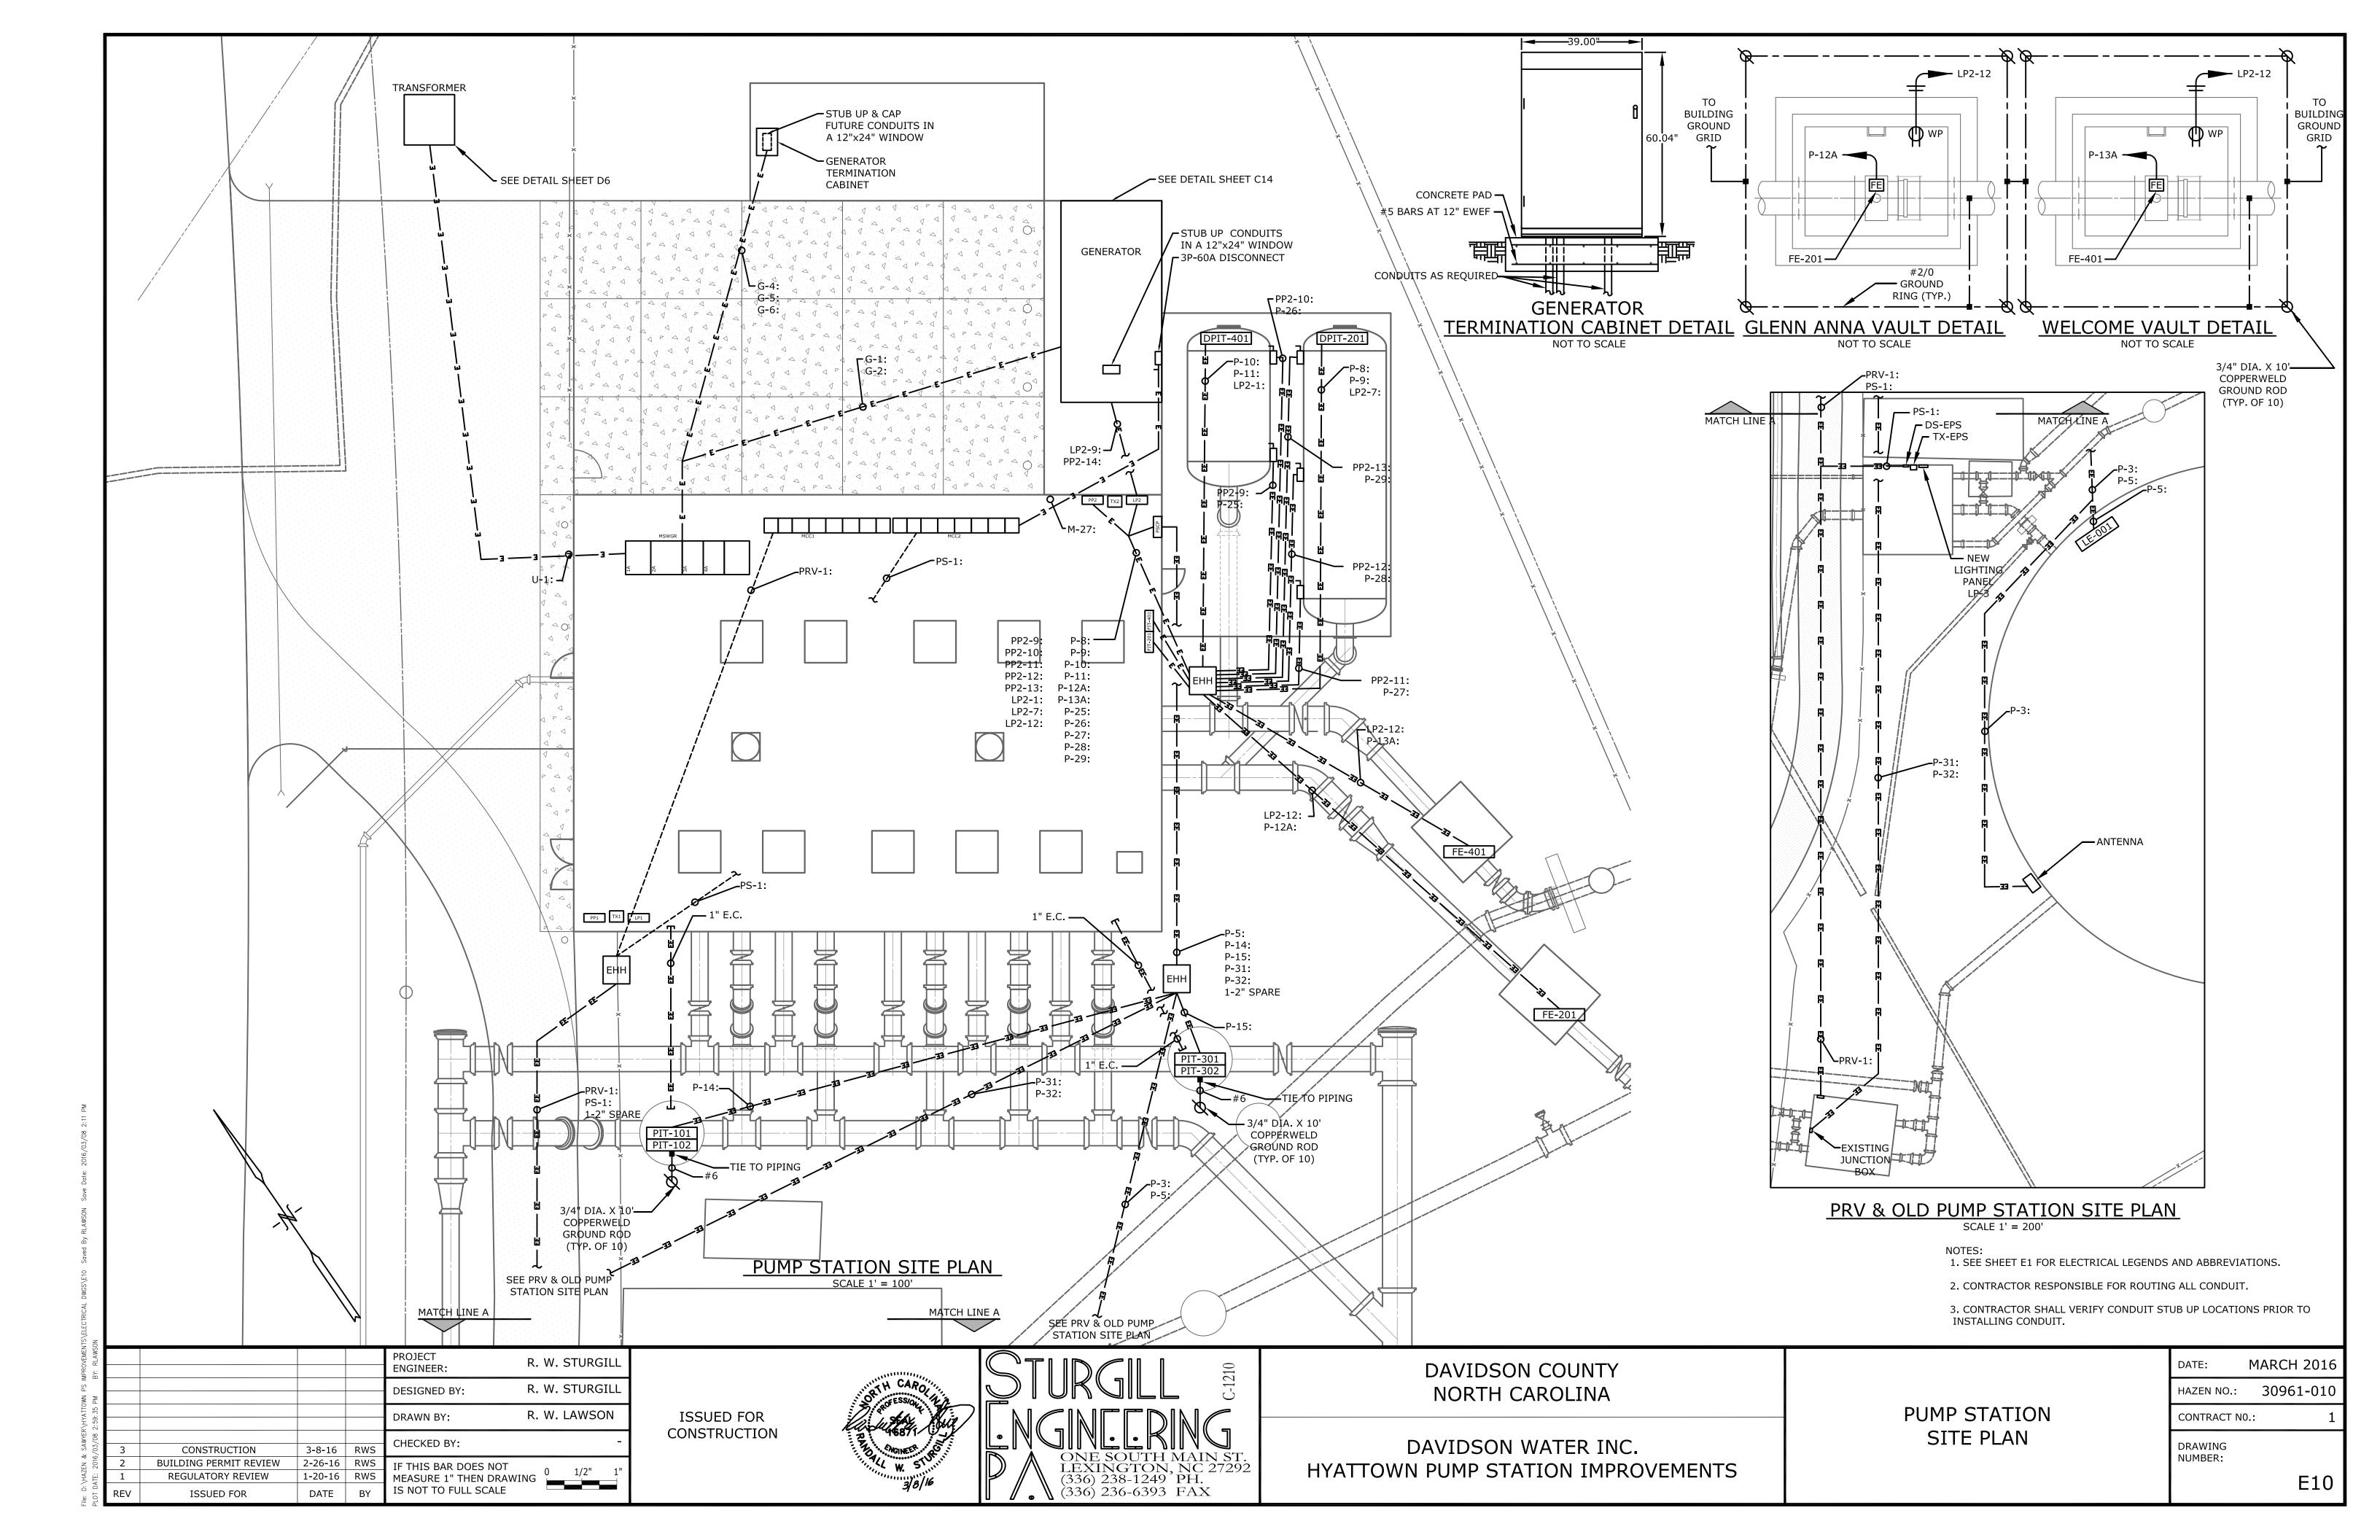

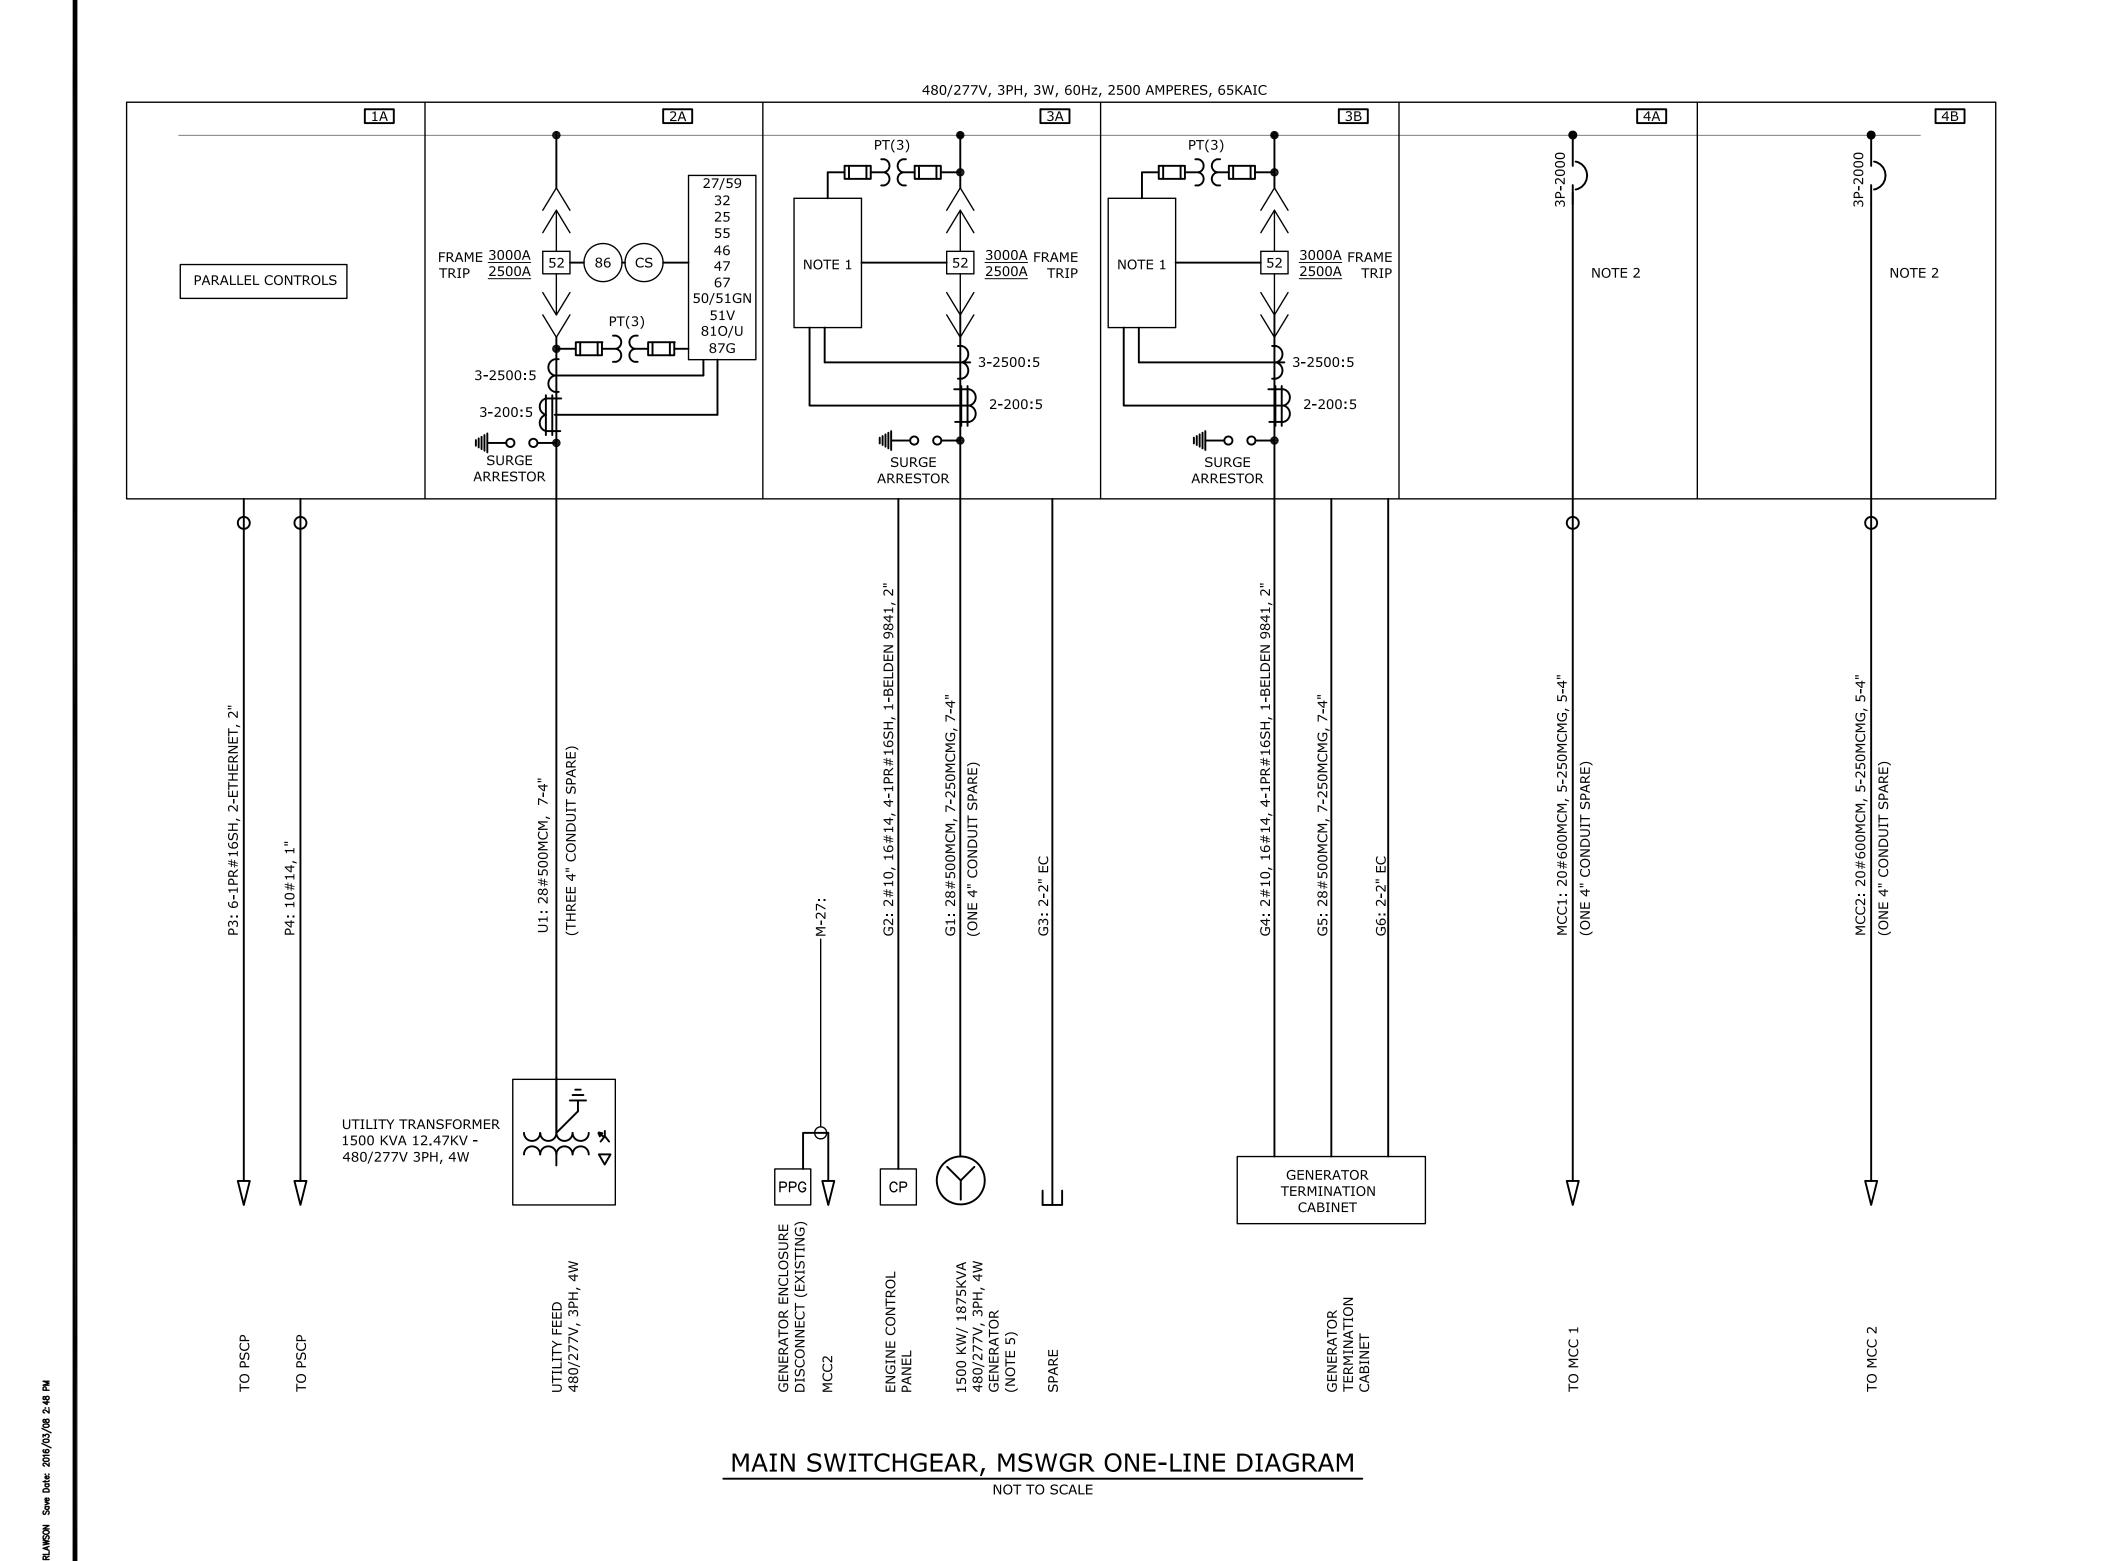

- 1. MSWGR FURNISHED UNDER SEPARATE CONTRACT, INSTALLED UNDER THIS CONTRACT.
- 2. MCC1 AND MCC2 FURNISHED UNDER SEPARATE CONTRACT, INSTALLED UNDER THIS CONTRACT.
- 3. MSWGR FURNISHED UNDER SEPARATE CONTRACT AND INSTALLED UNDER THIS CONTRACT.
- 4. UTILITY TRANSFORMER PROVIDED BY DUKE ENERGY. PAD GROUNDING & SECONDARY CABLE & CONDUIT UNDER THIS CONTRACT.
- 5. GENERATOR SYSTEM FURNISHED BY OWNER, CONTRACTOR SHALL PROVIDE GENERATOR PAD, CABLE AND CONDUIT AS INDICATED.
- 6. CONTRACTOR RESPONSIBLE FOR ALL CABLE TERMINATIONS.
- 7. GENERATOR TERMINATION CABINET CONDUITS SHALL STUB UP IN A 12" X 24" AREA.

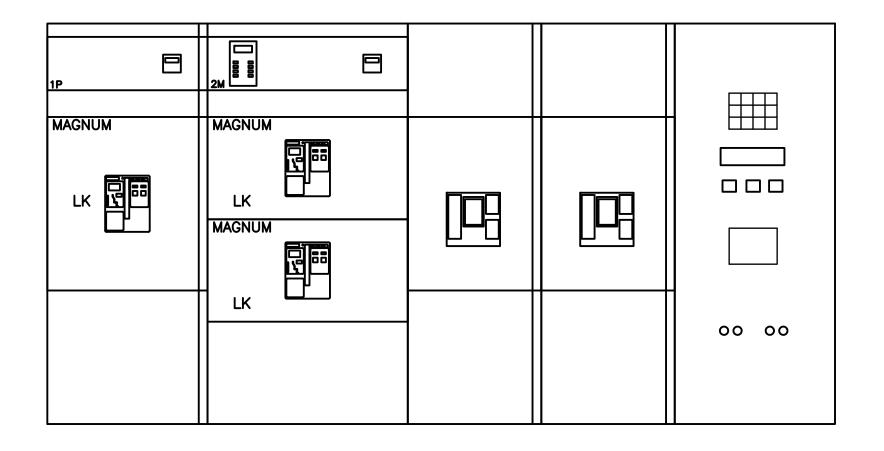


MSWGR FRONT ELEVATION

NOT TO SCALE

				PROJECT R. W. STURGILL ENGINEER:
				DESIGNED BY: R. W. STURGILL
				DRAWN BY: R. W. LAWSON
3				CHECKED BY:
3	CONSTRUCTION	3-8-16	RWS	CHECKED DI.
2	BUILDING PERMIT REVIEW	2-26-16	RWS	IF THIS BAR DOES NOT 0 1/2" 1"
1	REGULATORY REVIEW	1-20-16	RWS	MEASURE 1" THEN DRAWING 0 1/2" 1"
REV	ISSUED FOR	DATE	BY	IS NOT TO FULL SCALE

ISSUED FOR CONSTRUCTION

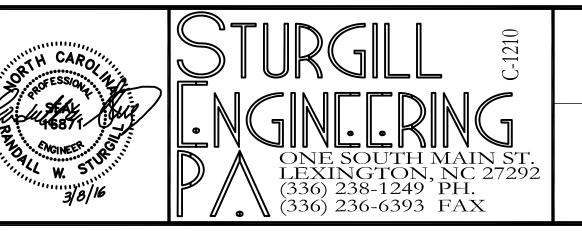

DAVIDSON COUNTY NORTH CAROLINA

DAVIDSON WATER INC.
HYATTOWN PUMP STATION IMPROVEMENTS


SYSTEM ONE-LINE DIAGRAM DATE: MARCH 2016

HAZEN NO.: 30961-010

CONTRACT NO.: 1

DRAWING NUMBER:

E20

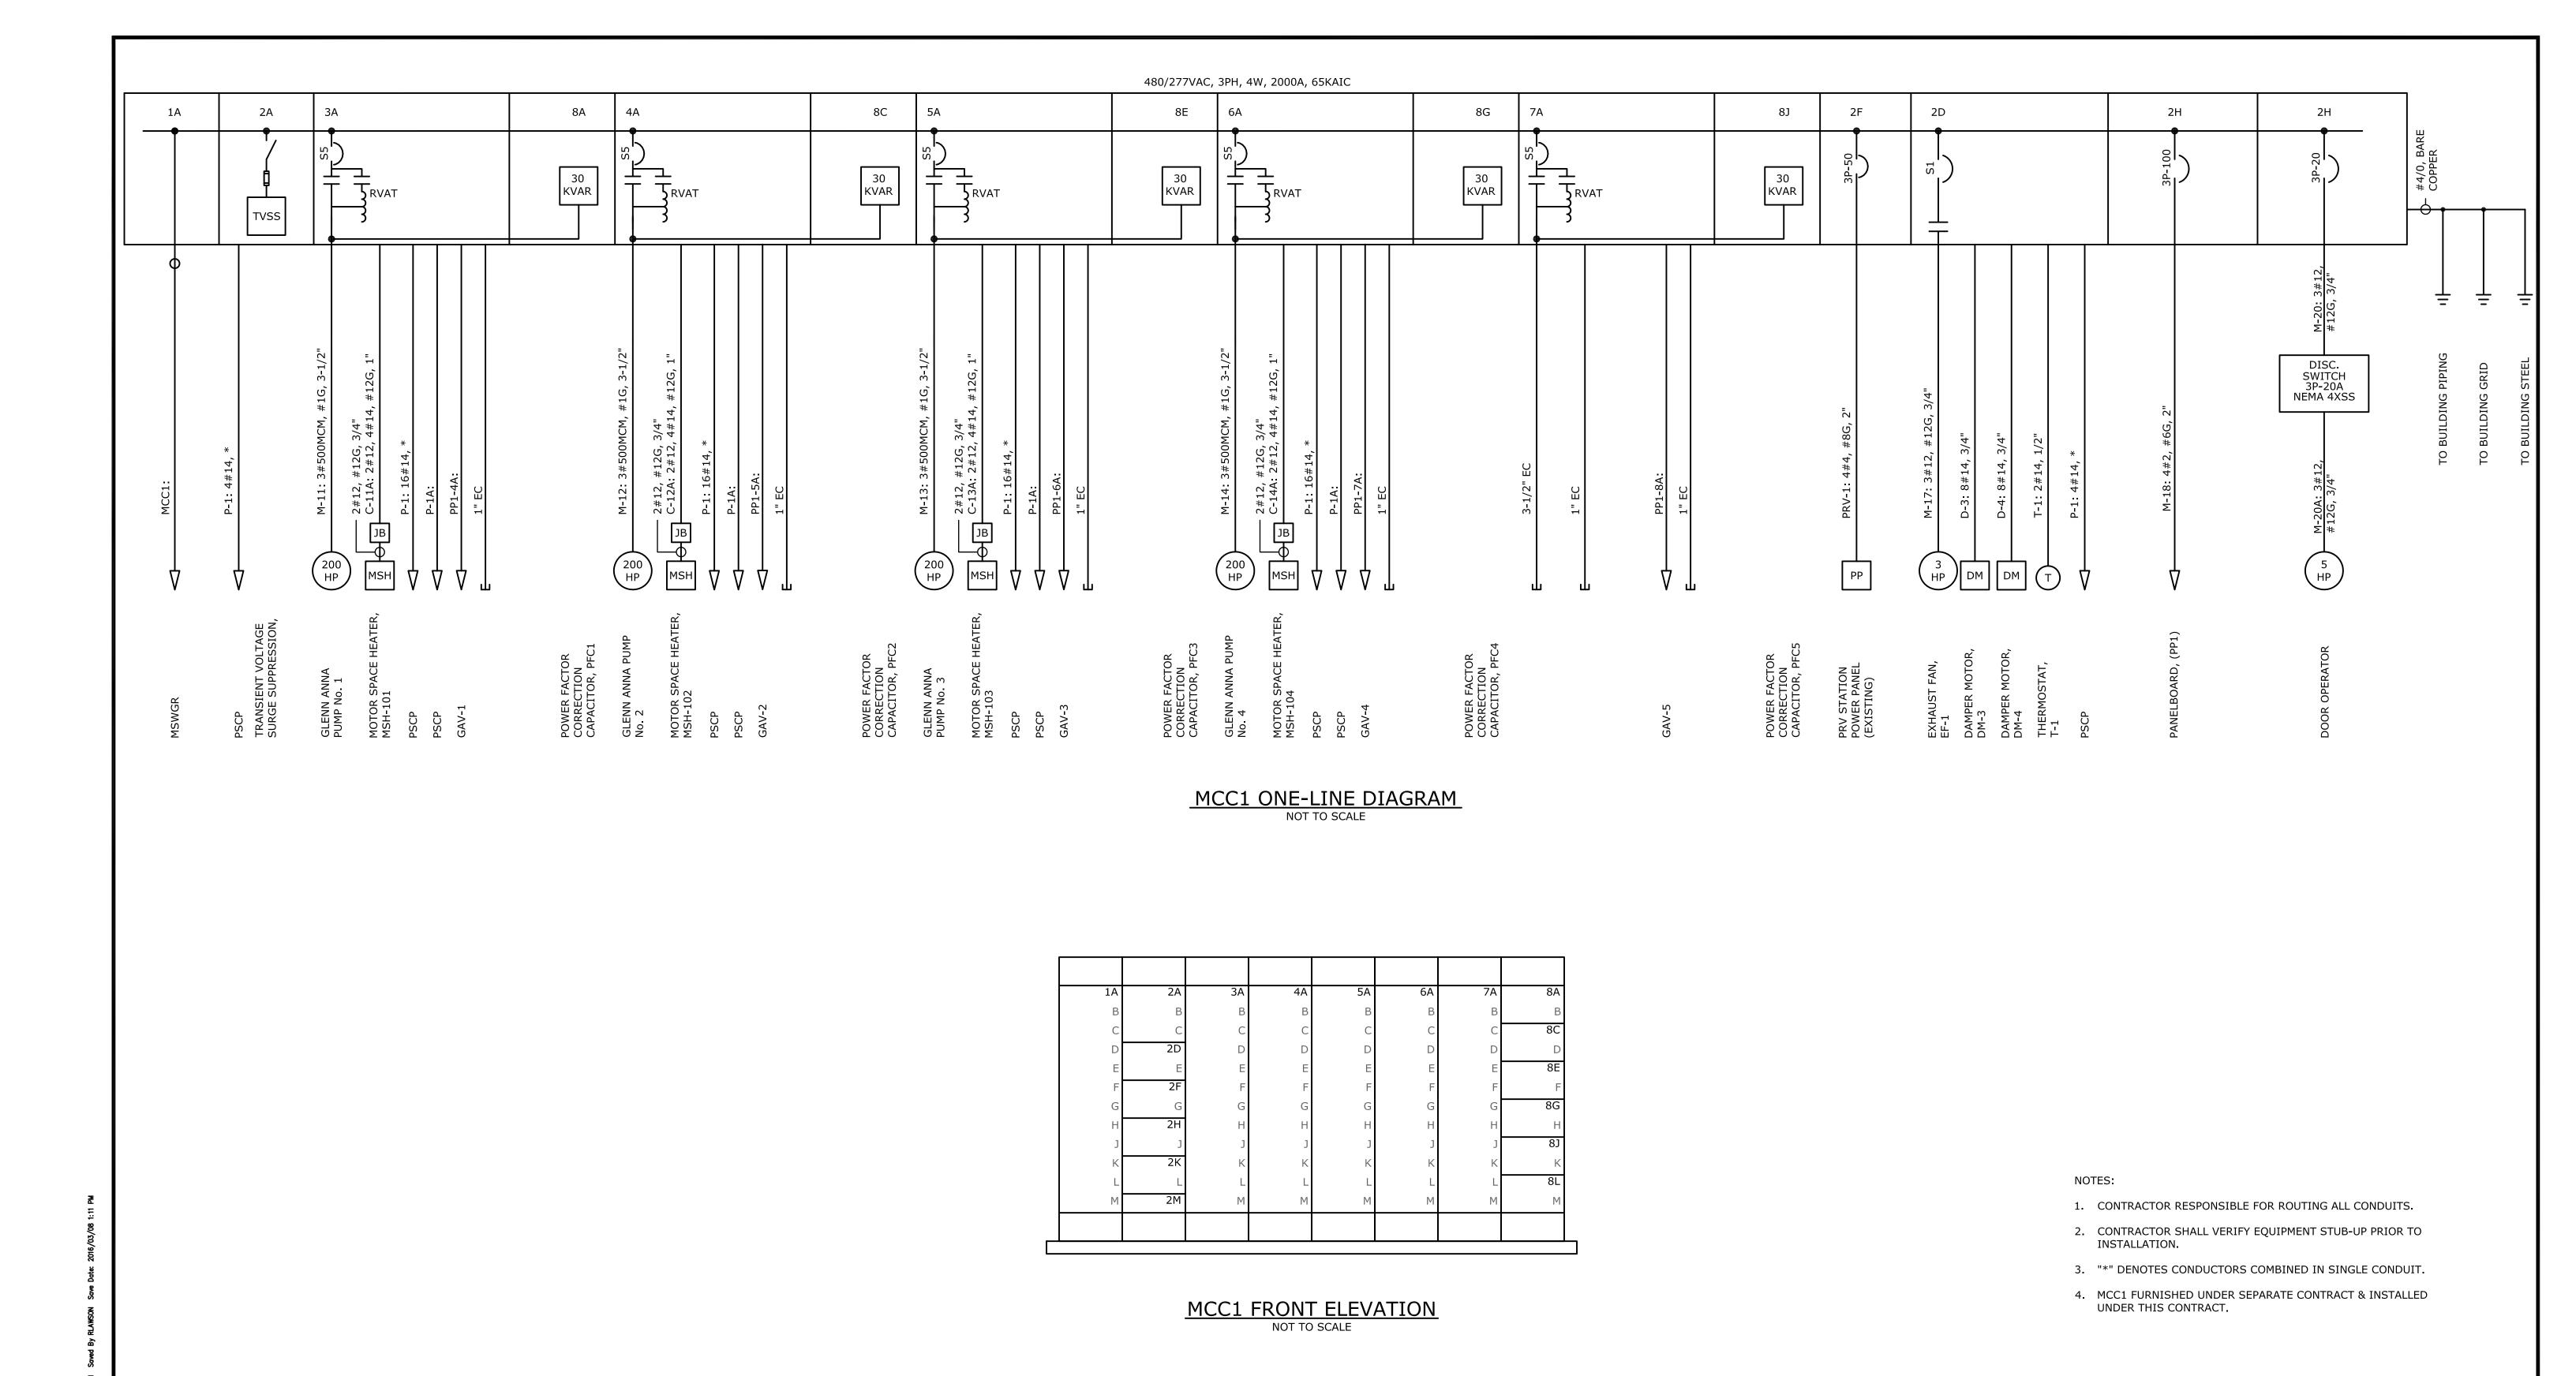


PROJECT ENGINEER: R. W. STURGILL R. W. STURGILL DESIGNED BY: R. W. LAWSON DRAWN BY: CHECKED BY: CONSTRUCTION 3-8-16 RWS 2-26-16 RWS IF THIS BAR DOES NOT
MEASURE 1" THEN DRAWING
IS NOT TO FULL SCALE BUILDING PERMIT REVIEW

1-20-16 RWS

REGULATORY REVIEW

**ISSUED FOR** 

ISSUED FOR CONSTRUCTION

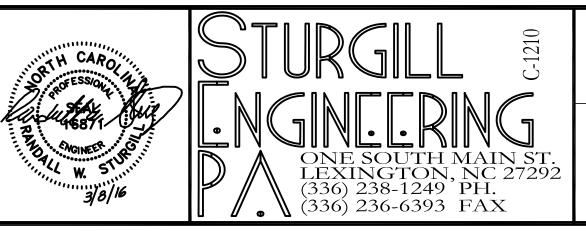


## DAVIDSON COUNTY NORTH CAROLINA

## DAVIDSON WATER INC. HYATTOWN PUMP STATION IMPROVEMENTS

MCC1 ONE-LINE DIAGRAM

DATE:	MARCH 2016
HAZEN NO.:	30961-010
CONTRACT NO	.: 1

DRAWING NUMBER:

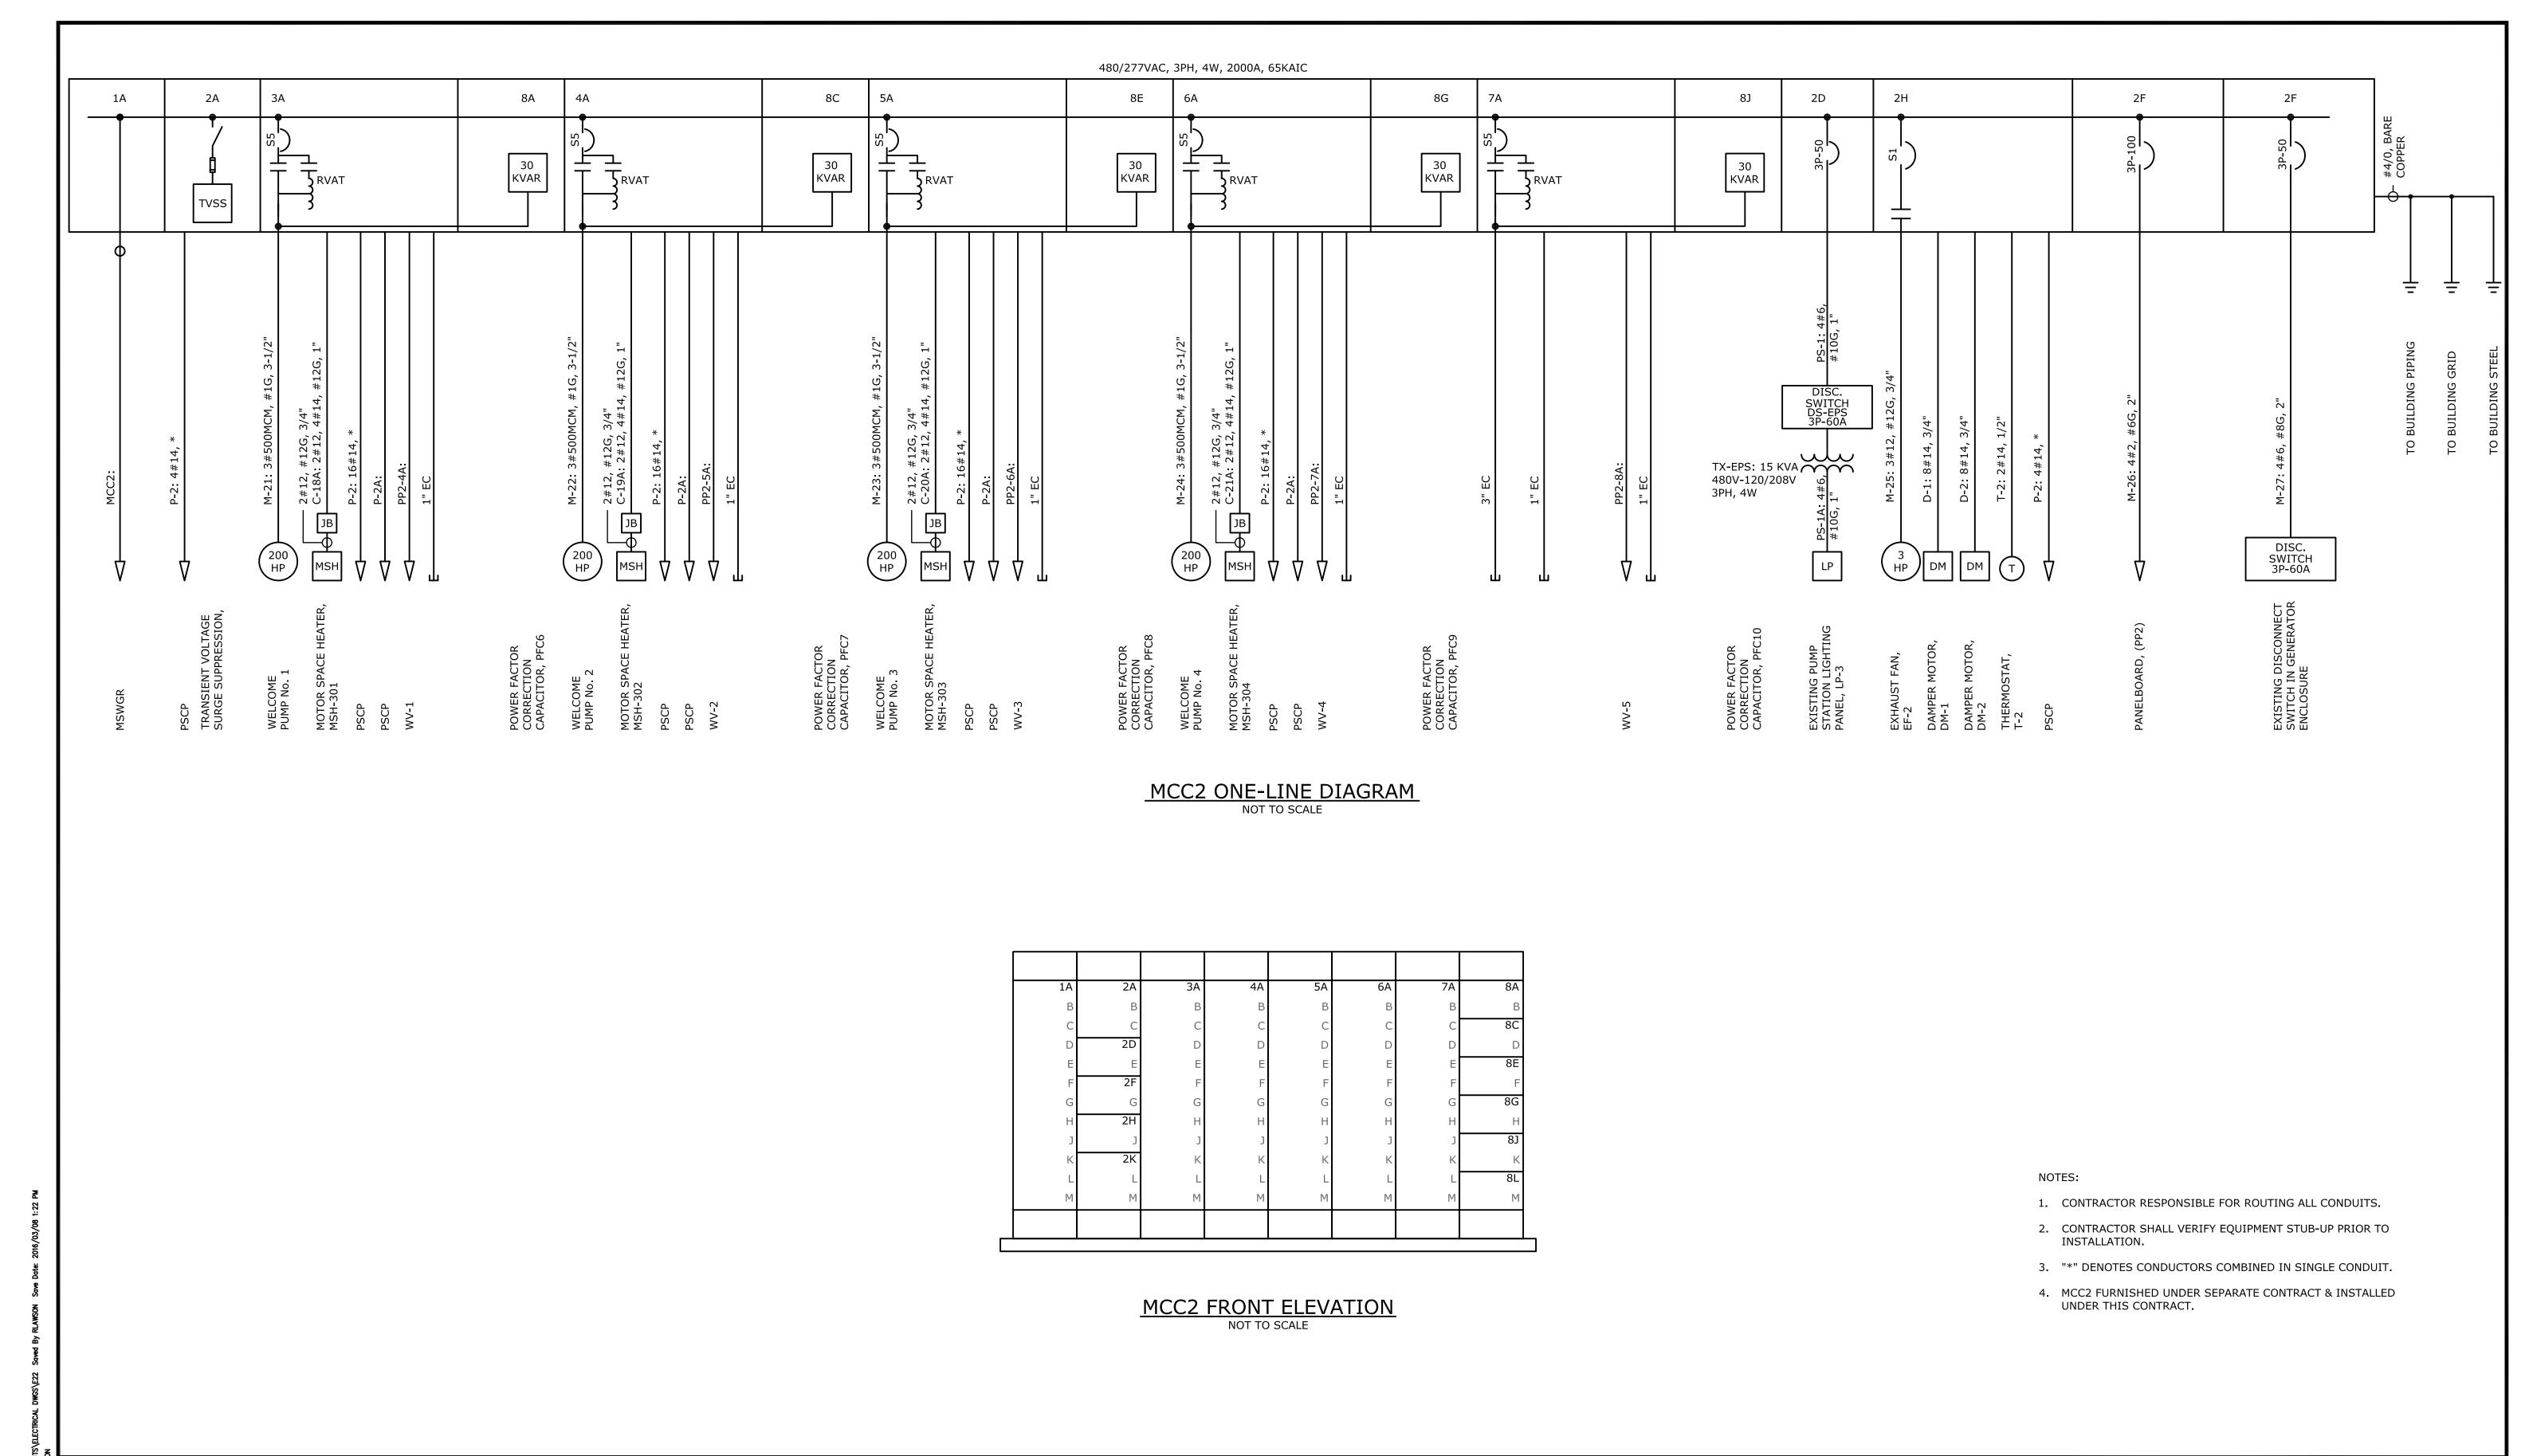

					PROJECT R. W. STURGILL ENGINEER:
Ŀ					DESIGNED BY: R. W. STURGILL
					DRAWN BY: R. W. LAWSON
					CHECKED BY: -
	3	CONSTRUCTION	3-8-16	RWS	CHECKED B1.
I	2	BUILDING PERMIT REVIEW	2-26-16	RWS	IF THIS BAR DOES NOT 0 1/2" 1"
	1	REGULATORY REVIEW	1-20-16	RWS	MEASURE 1" THEN DRAWING 1/2" 1"
	REV	ISSUED FOR	DATE	BY	IS NOT TO FULL SCALE

ISSUED FOR CONSTRUCTION



DAVIDSON COUNTY NORTH CAROLINA

DAVIDSON WATER INC.
HYATTOWN PUMP STATION IMPROVEMENTS


MCC2 ONE-LINE DIAGRAM 

 DATE:
 MARCH 2016

 HAZEN NO.:
 30961-010

 CONTRACT NO.:
 1

DRAWING NUMBER:

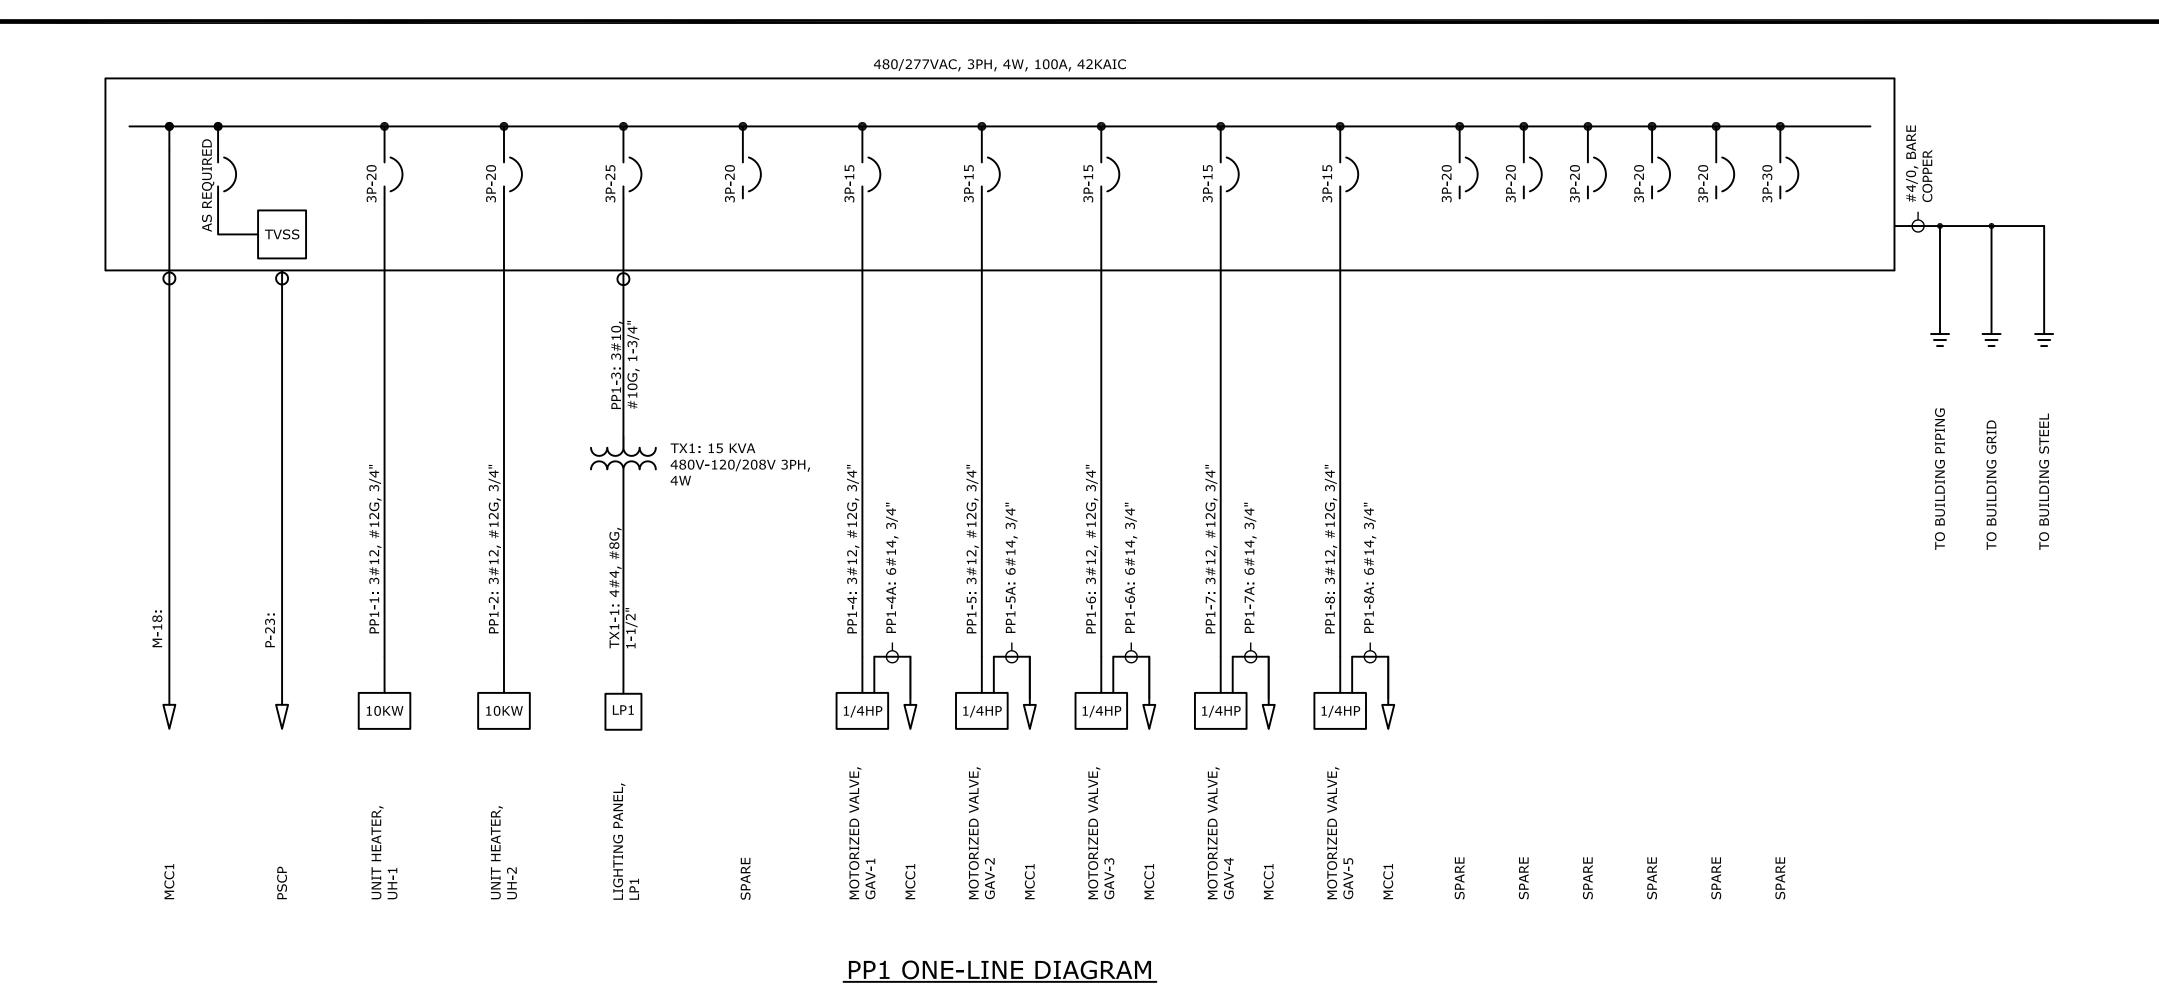

NOT TO SCALE

NOTES:

- 1. CONTRACTOR RESPONSIBLE FOR ROUTING ALL CONDUITS.
- CONTRACTOR SHALL VERIFY EQUIPMENT STUB-UP PRIOR TO INSTALLATION.
   "\*" DENOTES CONDUCTORS COMBINED IN SINGLE CONDUIT.

				PROJECT R. W. STURGILL ENGINEER:
				DESIGNED BY: R. W. STURGILL
				DRAWN BY: R. W. LAWSON
				CHECKED BY: -
3	CONSTRUCTION	3-8-16	RWS	31123123 B11
2	BUILDING PERMIT REVIEW	2-26-16	RWS	IF THIS BAR DOES NOT
1	REGULATORY REVIEW	1-20-16	RWS	MEASURE 1" THEN DRAWING 1/2" 1"
REV	ISSUED FOR	DATE	BY	IS NOT TO FULL SCALE

ISSUED FOR CONSTRUCTION




DAVIDSON COUNTY NORTH CAROLINA

DAVIDSON WATER INC. HYATTOWN PUMP STATION IMPROVEMENTS

PP1 ONE-LINE DIAGRAM

MARCH 2016 HAZEN NO.: 30961-010 CONTRACT NO.: DRAWING NUMBER:

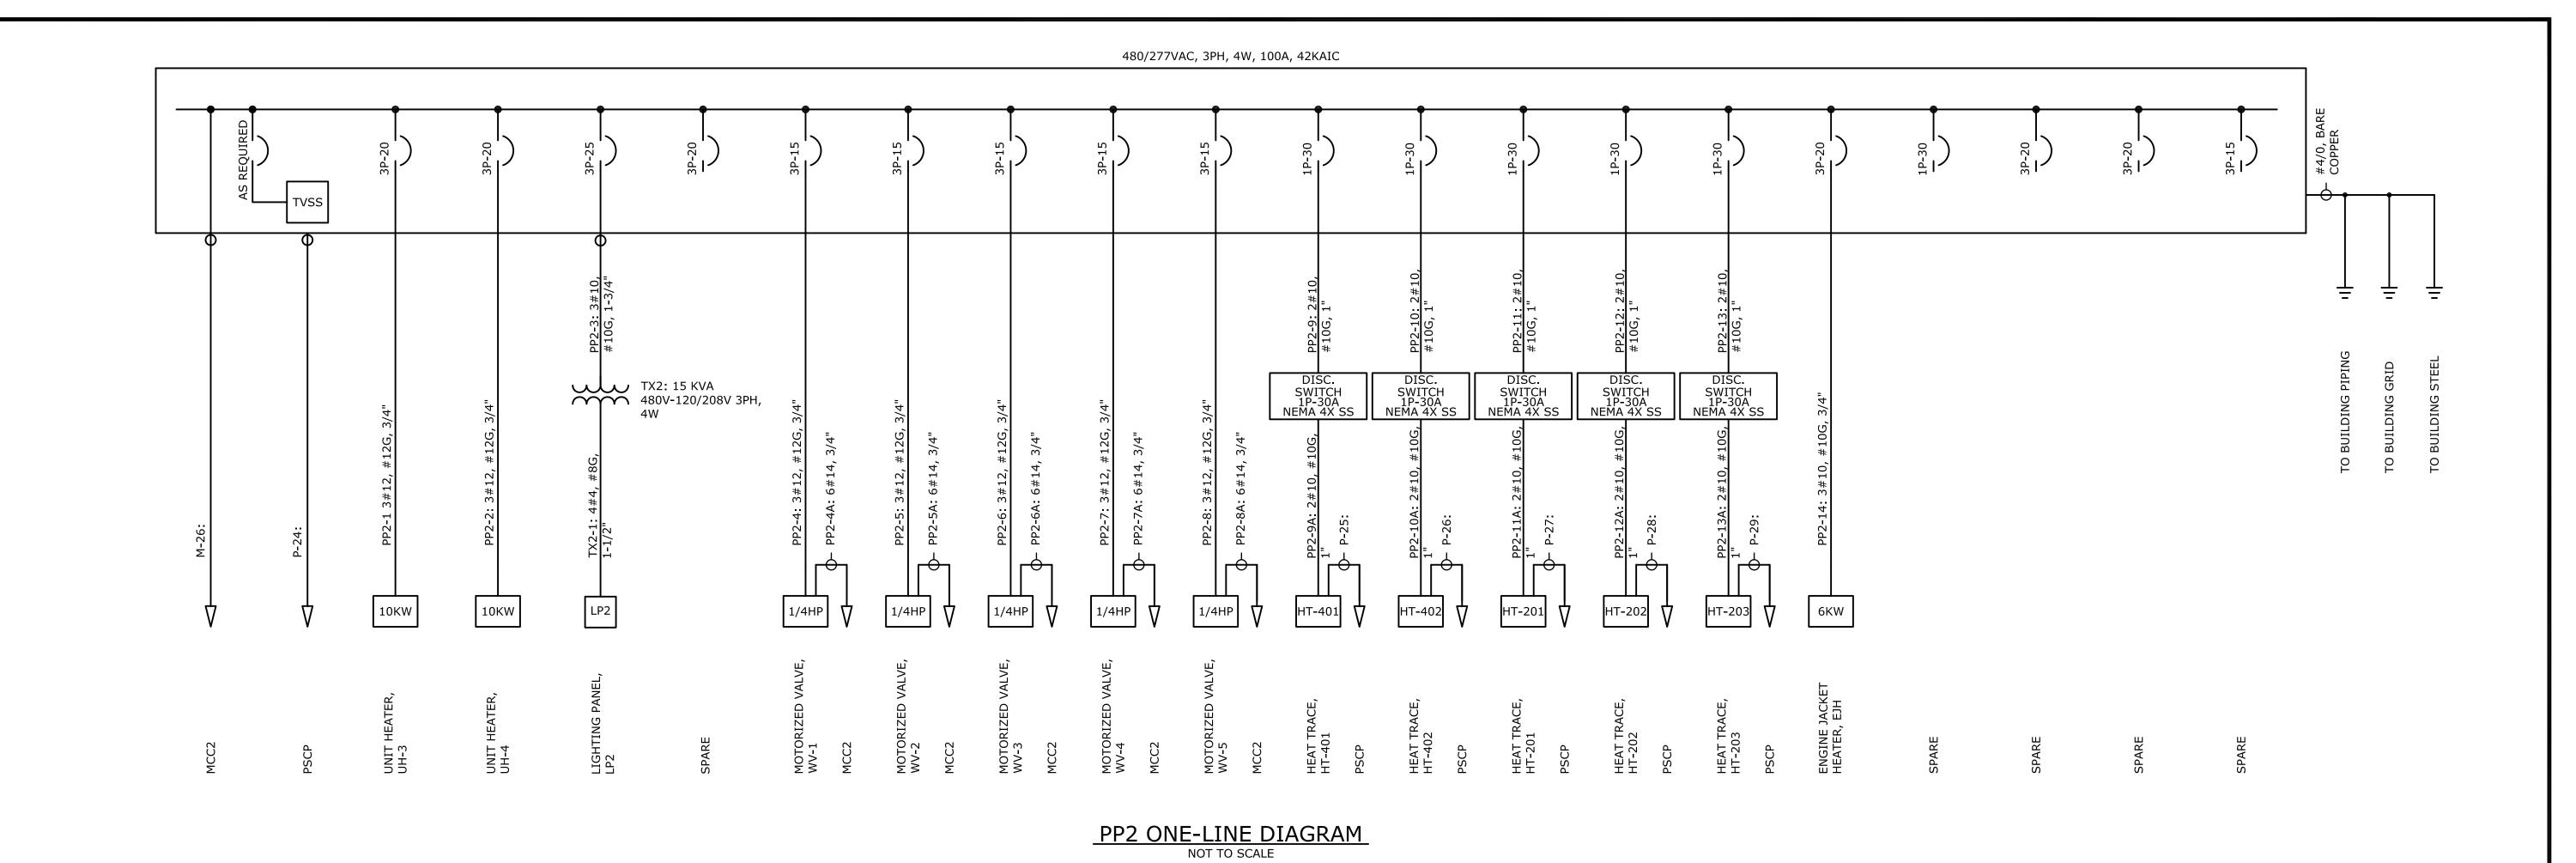


NOTES:

- 1. CONTRACTOR RESPONSIBLE FOR ROUTING ALL CONDUITS.
- 2. CONTRACTOR SHALL VERIFY EQUIPMENT STUB-UP PRIOR TO INSTALLATION.
- 3. "\*" DENOTES CONDUCTORS COMBINED IN SINGLE CONDUIT.

				PROJECT ENGINEER:	R. W. STURGILL
				DESIGNED BY:	R. W. STURGILL
				DRAWN BY:	R. W. LAWSON
3				CHECKED BY:	-
3	CONSTRUCTION	3-8-16	RWS	CHECKED BY:	
2	BUILDING PERMIT REVIEW	2-26-16	RWS	IF THIS BAR DOES NO	Γ ο 1/2" 1"
1	REGULATORY REVIEW	1-20-16	RWS	MEASURE 1" THEN DRAWING 0 1/2"	
1 REV	ISSUED FOR	DATE	BY	IS NOT TO FULL SCALE	

ISSUED FOR CONSTRUCTION

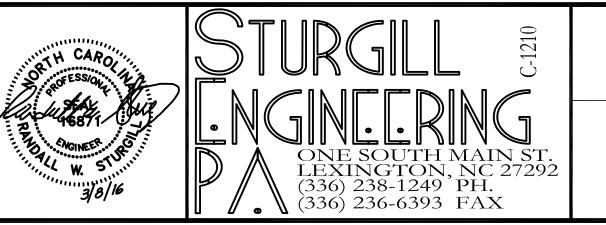

DAVIDSON COUNTY NORTH CAROLINA


DAVIDSON WATER INC. HYATTOWN PUMP STATION IMPROVEMENTS PP2 ONE-LINE DIAGRAM 

 DATE:
 MARCH 2016

 HAZEN NO.:
 30961-010

 CONTRACT NO.:
 1

DRAWING NUMBER:

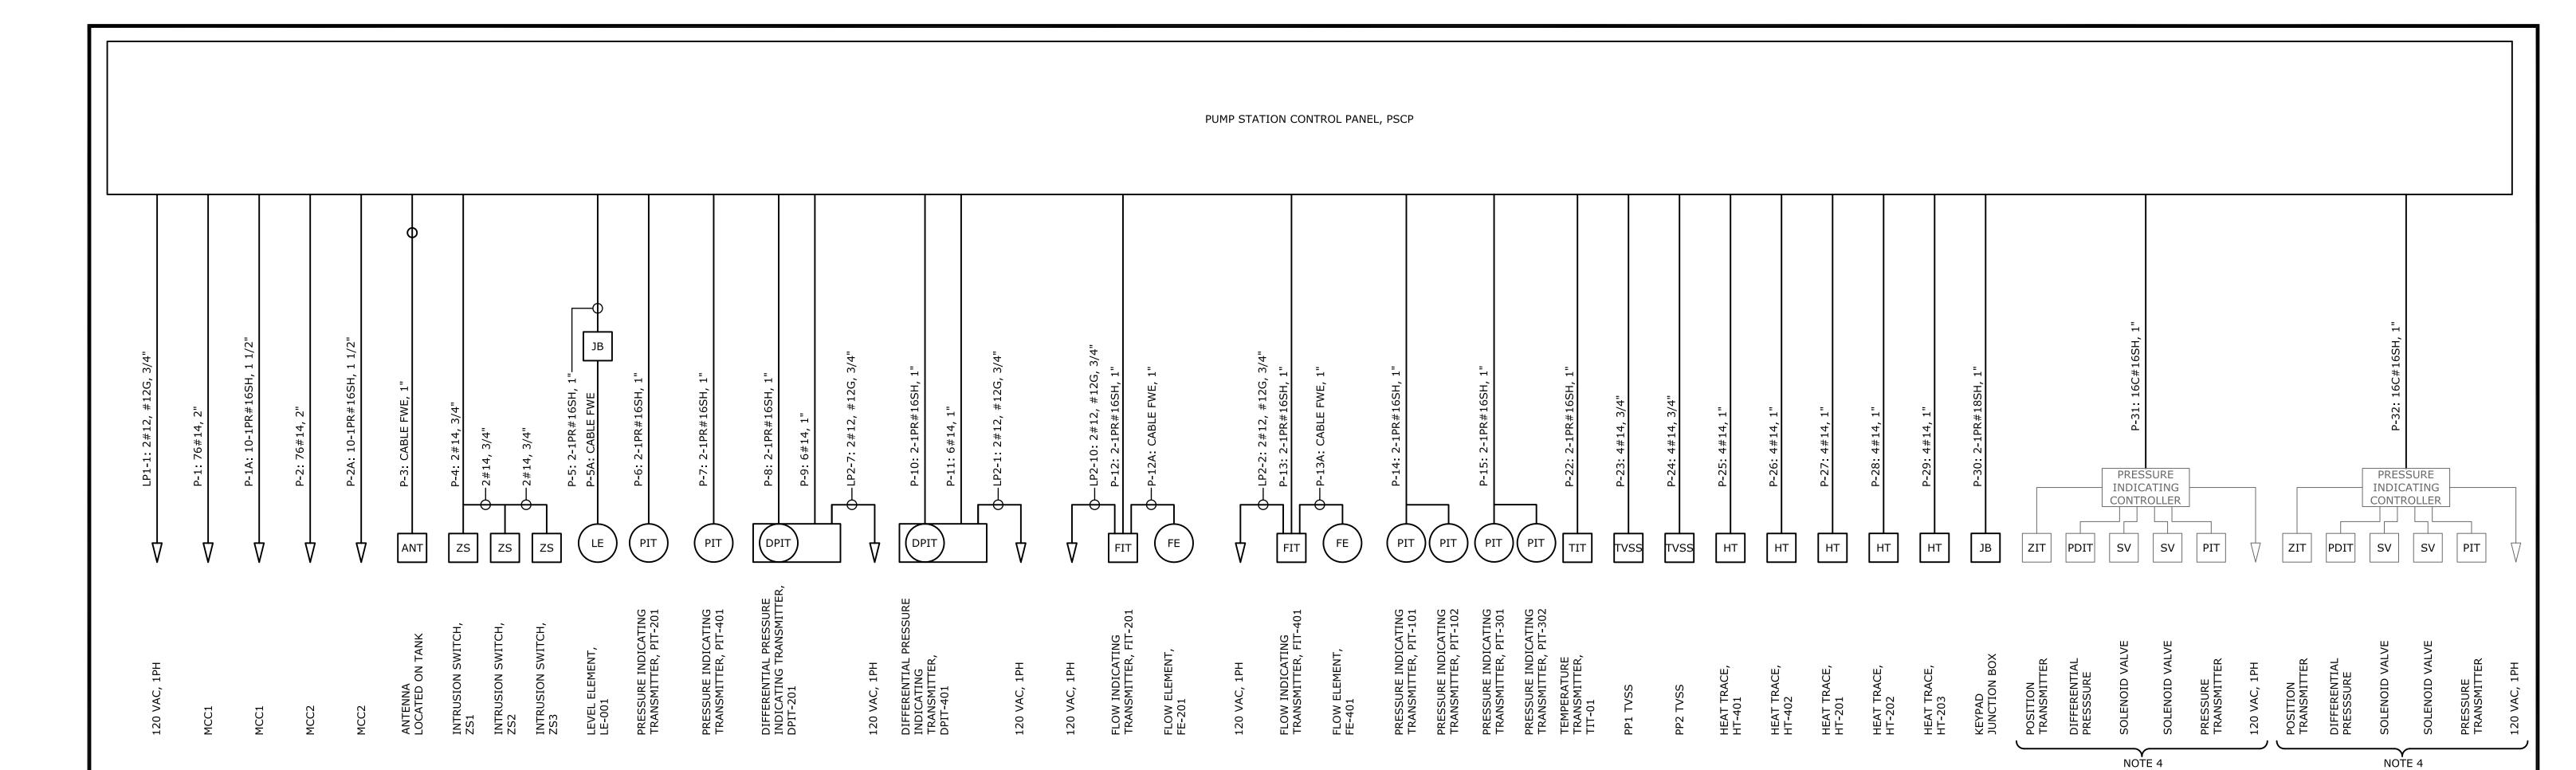

PSCP ONE-LINE DIAGRAM

NOT TO SCALE

## NOTES:

- 1. CONTRACTOR RESPONSIBLE FOR ROUTING ALL CONDUITS.
- 2. CONTRACTOR SHALL VERIFY EQUIPMENT STUB-UP PRIOR TO INSTALLATION.
- 3. "\*" DENOTES CONDUCTORS COMBINED IN SINGLE CONDUIT.
- 4. EXISTING PRV EQUIPMENT LOCATED IN PRV STATION.

BT: KLAWS					PROJECT R. W. STURGILL ENGINEER:
<b>.</b>					DESIGNED BY: R. W. STURGILL
Z: 59: 49					DRAWN BY: R. W. LAWSON
2010/03/02					CHECKED BY: -
₹	3	CONSTRUCTION	3-8-16	RWS	
2016	2	BUILDING PERMIT REVIEW	2-26-16	RWS	IF THIS BAR DOES NOT 0 1/2" 1"
UAIE	1	REGULATORY REVIEW	1-20-16	RWS	MEASURE 1" THEN DRAWING 0 1/2" 1"
<u> </u>	REV	ISSUED FOR	DATE	BY	IS NOT TO FULL SCALE

ISSUED FOR CONSTRUCTION





TURGILL C-1210	DAVIDSON COUNTY NORTH CAROLINA
VGINEERING	DAVIDSON WATER INC


DAVIDSON WATER INC. HYATTOWN PUMP STATION IMPROVEMENTS

PSCP ONE-LINE DIAGRAM

MARCH 2016 HAZEN NO.: 30961-010 CONTRACT NO.: DRAWING NUMBER:

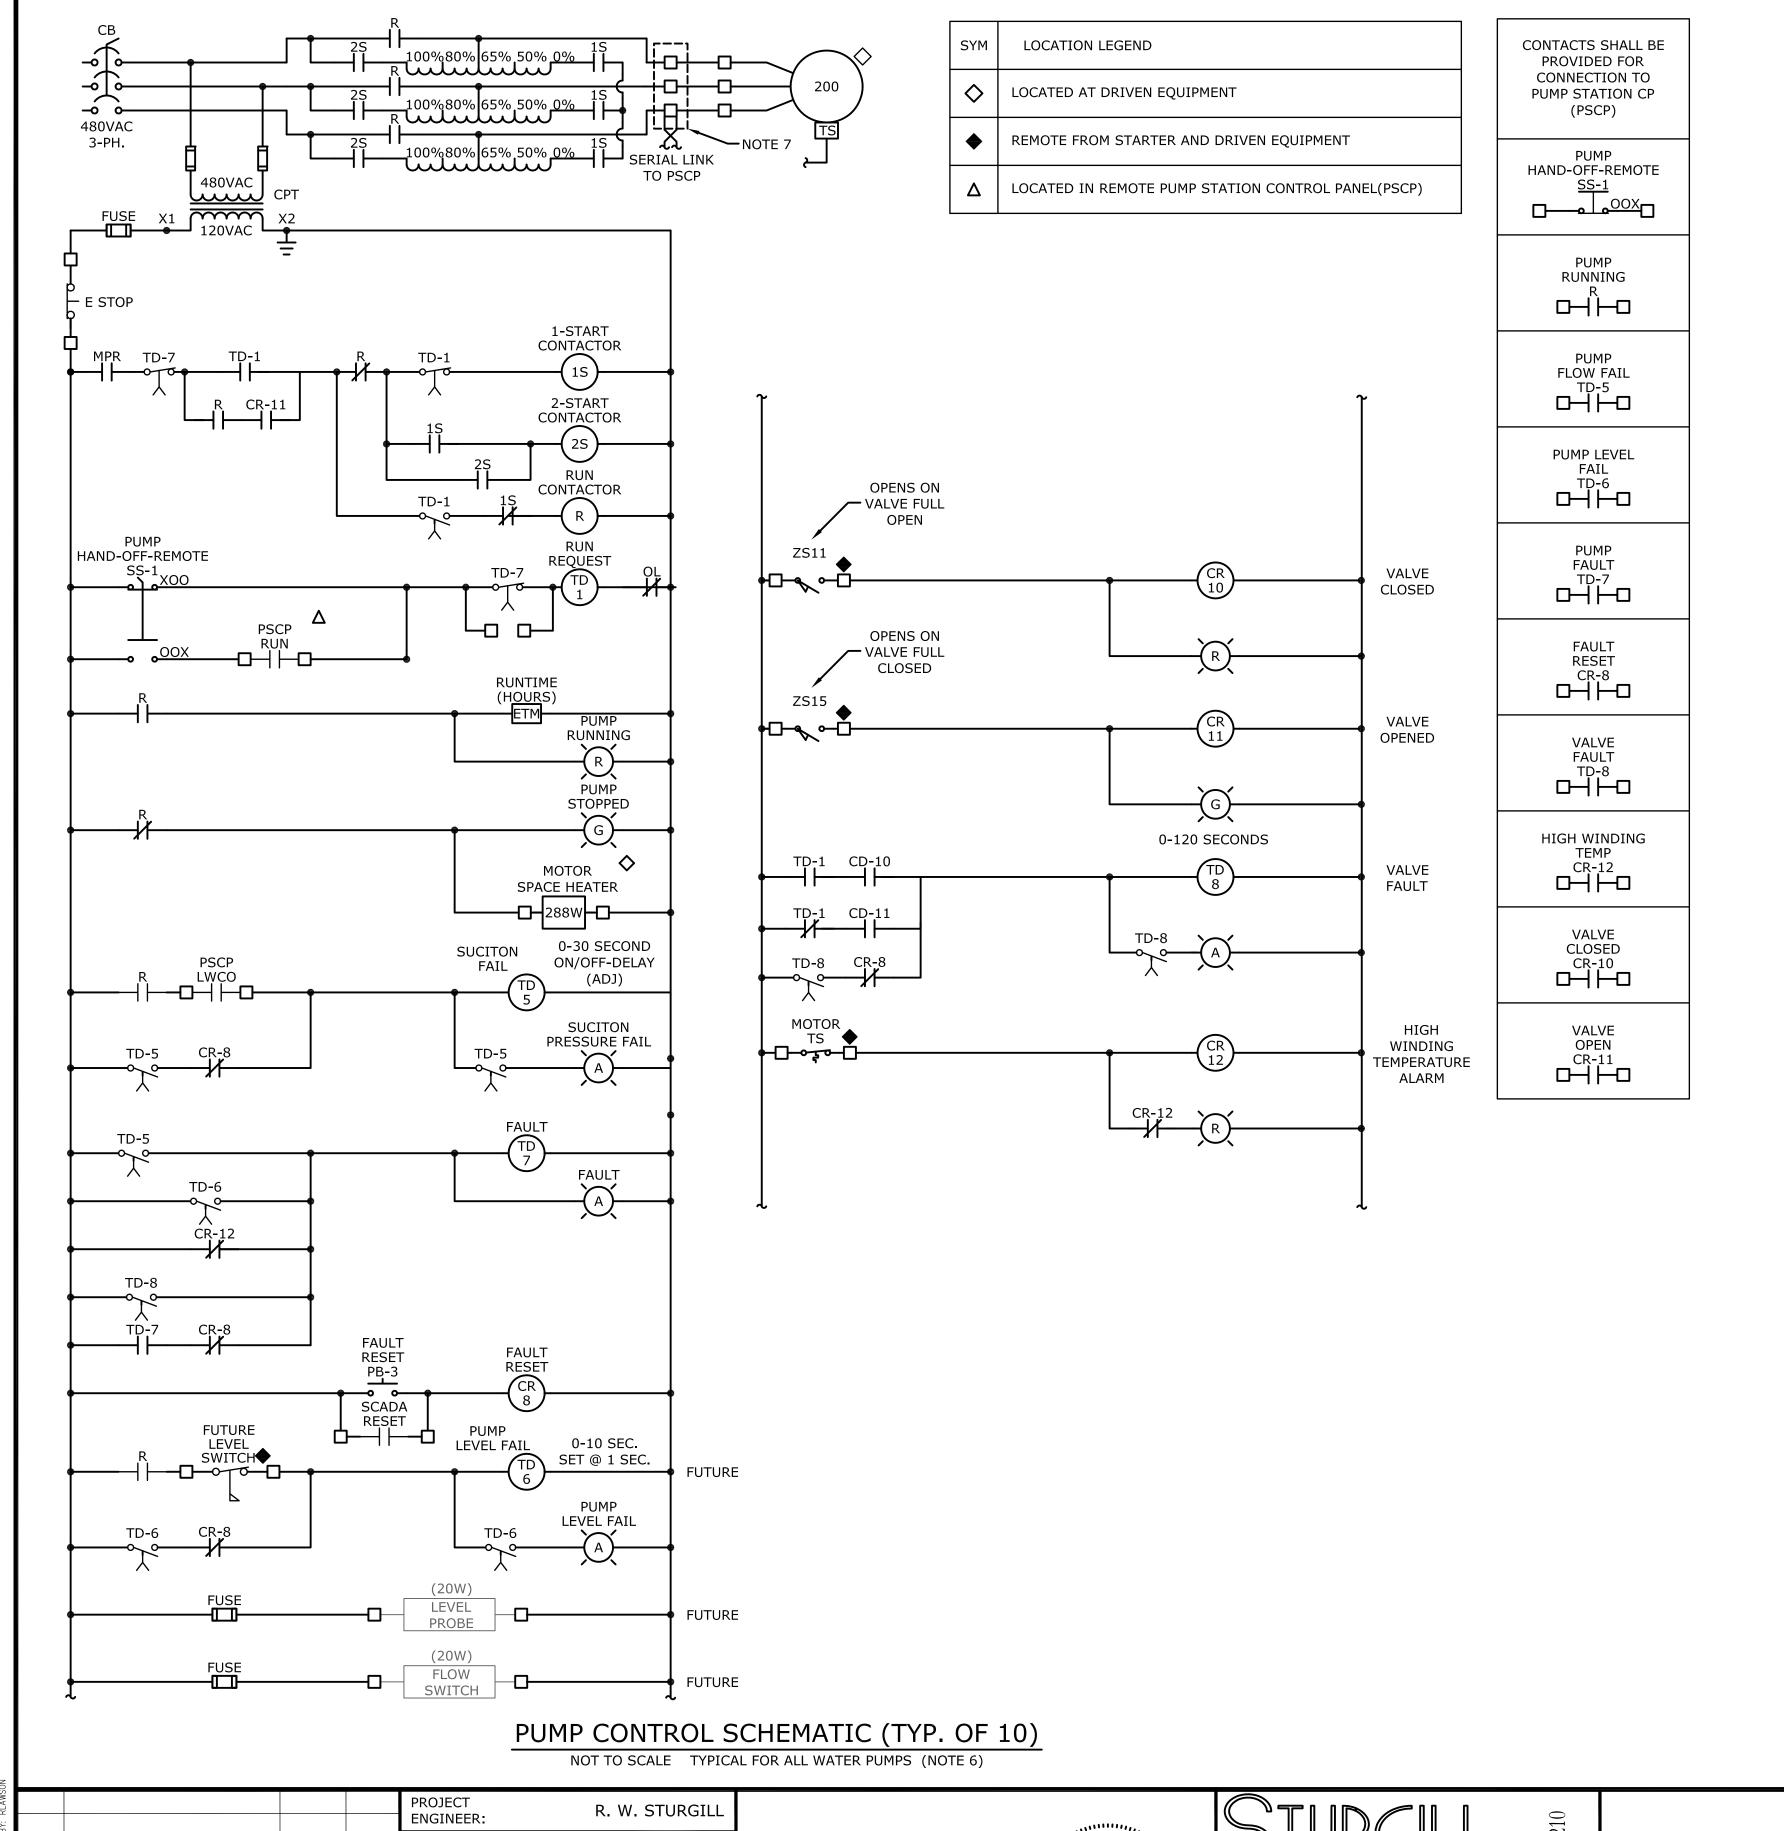

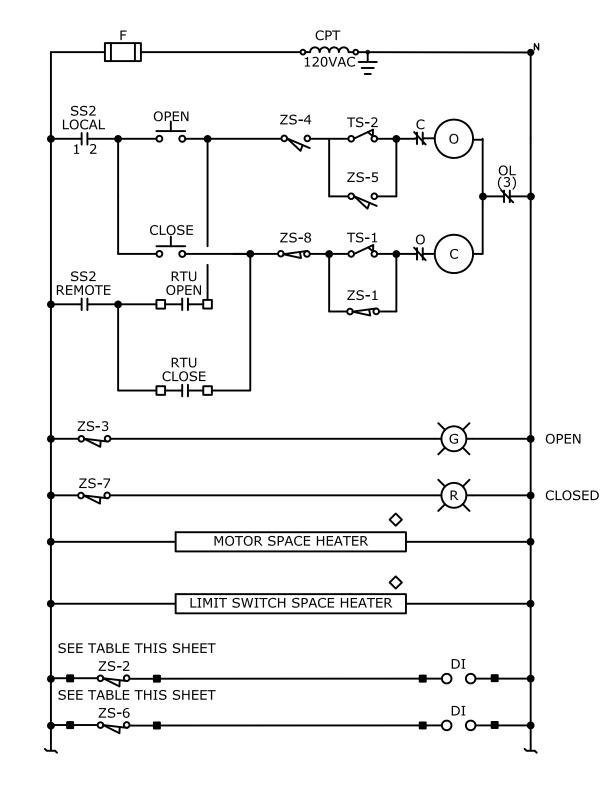

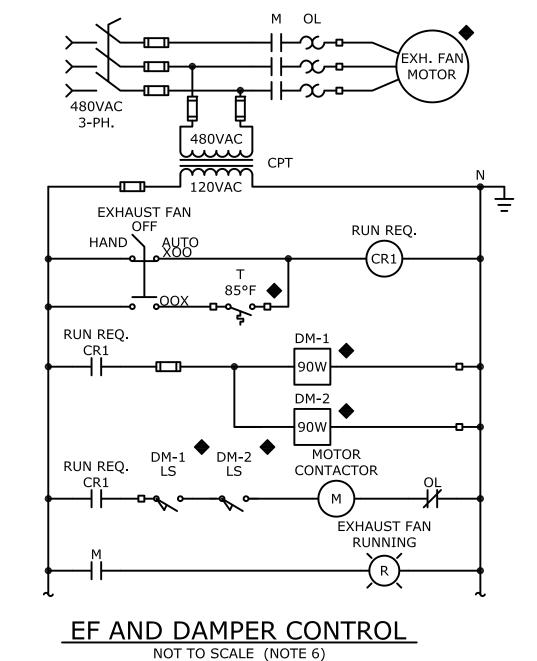

## ELECTRIC VALVE CONTROL NOT TO SCALE

R	<b>—</b>		LIMIT SWI	TCH ZS
0	AC.	POS	ITION	
T O R	CONTACT	FULL OPEN	FULL CLOSED	FUNCTION
	1			TORQUE SW. BYPASS
7.0	2			REMOTE INDICATION
ZS	3			INDICATING LIGHTS
	4			OPEN LIMIT
	5			TORQUE SW. BYPASS
7.	6			REMOTE INDICATION
ZS	7			INDICATING LIGHTS
	8			CLOSE LIMIT
	9			REMOTE INDICATION
7.	10			REMOTE INDICATION
ZS	11			SPARE
	12			SPARE
	13			REMOTE INDICATION
70	14			REMOTE INDICATION
ZS	15			SPARE
	16			SPARE

## TORQUE SWITCH LEGEND

- TS-1 CLOSING TORQUE SWITCH STOPS VALVE IF MECHANICAL OVERLOAD OCCURS DURING CLOSING CYCLE
- TS-2 OPENING TORQUE SWITCH STOPS
  VALVE IF MECHANICAL OVERLOAD
  OCCURS DURING OPENING CYCLE

VALVE SWITCH IN FULL OPEN POSITION


# LIMIT SWITCH CONTACTS 1. SI

NOTES:

- 1. SEE SHEET E001 FOR ELECTRICAL LEGEND AND ABBREVIATIONS.
- 2. UNLESS OTHERWISE NOTED, DEVICES INDICATED ON THIS DRAWING SHALL BE SUPPLIED AS AN INTEGRAL PART OF THE PUMP DRIVE (VFD, RVAT, CONTACTORS, CONTROLS, ETC.) DEVICES LOCATED REMOTELY SHALL BE IDENTIFIED BY A LOCATION SYMBOL AS DEFINED IN THE DEVICE LOCATION LEGEND.
- 3. RELAY AND TIMER DESIGNATIONS APPLY TO THE INDIVIDUAL SCHEMATIC ONLY.
- 4. CONTROL SETTINGS, ALARM LIMITS, TIMER SETTINGS AND ADJUSTABLE PARAMETERS ARE INTENDED TO BE FOR THE INITIAL START-UP. ADJUSTABLE SETTINGS SHALL BE TESTED AND CHANGED BY THE CONTRACTOR, IF REQUIRED FOR PROPER OPERATION.
- 5. MOTOR STARTER SCHEMATICS INDICATE GENERAL CONTROLS AND SEQUENCING. EQUIPMENT SUPPLIER SHALL ADAPT THE SPECIFIC PACKAGE TO PROVIDE A FULLY FUNCTIONAL SYSTEM.
- 6. CONTROL SCHEMATICS ARE A DIAGRAMMATIC REPRESENTATION TO INDICATE THE MINIMUM ACCEPTABLE CONTROL FUNCTIONS. ACTUAL CONTROL LOGIC WILL DEPEND ON DRIVE MANUFACTURER'S CONTROL. PUMP CONTROLS FURNISHED WITH MCC. INDICATED FOR REFERENCE ONLY. CONTRACTOR SHALL TERMINATE CABLES PER MANUFACTURERS DRAWINGS.
- 7. MOTOR PROTECTION RELAY, MPR SHALL PROVIDE MOTOR PROTECTION FOR OVERLOAD, LOSS-OF-PHASE AND PHASE REVERSAL. IN ADDITION, SHALL PROVIDE KW, KWHR AMPS TO PSCP VIA MODBUS LINK.

BY: RLAWS					PROJECT R. W. STURGIL	L
PM					DESIGNED BY: R. W. STURGIL	L
2:59:52 F					DRAWN BY: R. W. LAWSON	
/08		CONCEDUCATION	2016	D14/G	CHECKED BY:	-
5/03,	3	CONSTRUCTION	3-8-16	RWS		
2016,	2	BUILDING PERMIT REVIEW	2-26-16	RWS	IF THIS BAR DOES NOT	1"
DATE:	1	REGULATORY REVIEW	1-20-16	RWS	MEASURE 1" THEN DRAWING 0 1/2"	1"
LOT DA	REV	ISSUED FOR	DATE	BY	IS NOT TO FULL SCALE	•

ISSUED FOR CONSTRUCTION

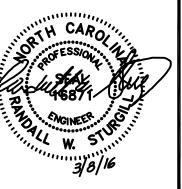



DAVIDSON COUNTY NORTH CAROLINA

DAVIDSON WATER INC.
HYATTOWN PUMP STATION IMPROVEMENTS

MISCELLANEOUS CONTROL SCHEMATIC


DATE:	MARCH 2016
HAZEN NO.:	30961-010
CONTRACT N	0.: 1
DRAWING NUMBER:	

E26

HAZEN & SAWYER\HYATTOWN TE: 2016/03/08 2:59:52 PM

TION IMPROVEMENTS

	LIGHTING FIXTURE SCHEDULE						
	LAMP	TOTAL POWER					
SYMBOL	BALLAST	PER FIXTURE	MOUNTING	DESCRIPTION	MANUFACTURER'S PART NUMBER		
A •	ONE (1) 275 W LED -	275 WATTS	SUSPEND FROM CEILING 14' A.F.F	52" LED FIXTURE FIBERGLASS ENCLOSED WITH ACRYLIC PRISMATIC DIFFUSER. DAMP LABEL LISTED, 120VAC.	COLUMBIA LXEW4-35V-FAW-EU METALUX VT4LED-LD4-28-DRF-120-L840-ED-3-WL-U OR APPROVED EQUIVALENT.		
В	EIGHTEEN (18) 2.7W LED	45 WATTS	SURFACE MOUNT ON WALL	COMPACT LED WALL PACK, WET LOCATION LISTED, 120VAC.	HUBBELL LNC2-18LU-4K-4-1-PC OR EQUIVALENT.		
C	TWO (2) 3W LED	6 WATTS	WALL MOUNT 8' AFF	EMERGENCY LIGHT, DAMP LABEL LISTED 120VAC, w/BATTERY PACK.	DUAL LITE LZ15-032 OR EQUIVALENT.		
	LED EXIT  REMOTE  HEADS	11 WATTS	WALL OR CEILING MOUNT ABOVE DOOR	LED EXIT SIGN; WHITE WITH RED LETTERS, 120VAC. WITH BATTERY PACK AND MATCHING OUTDOOR REMOTE HEADS.	DUAL LITE HCXURW-RC12-03L WITH 0CRDZ0605 REMOTE HEAD OR EQUIVALENT.		

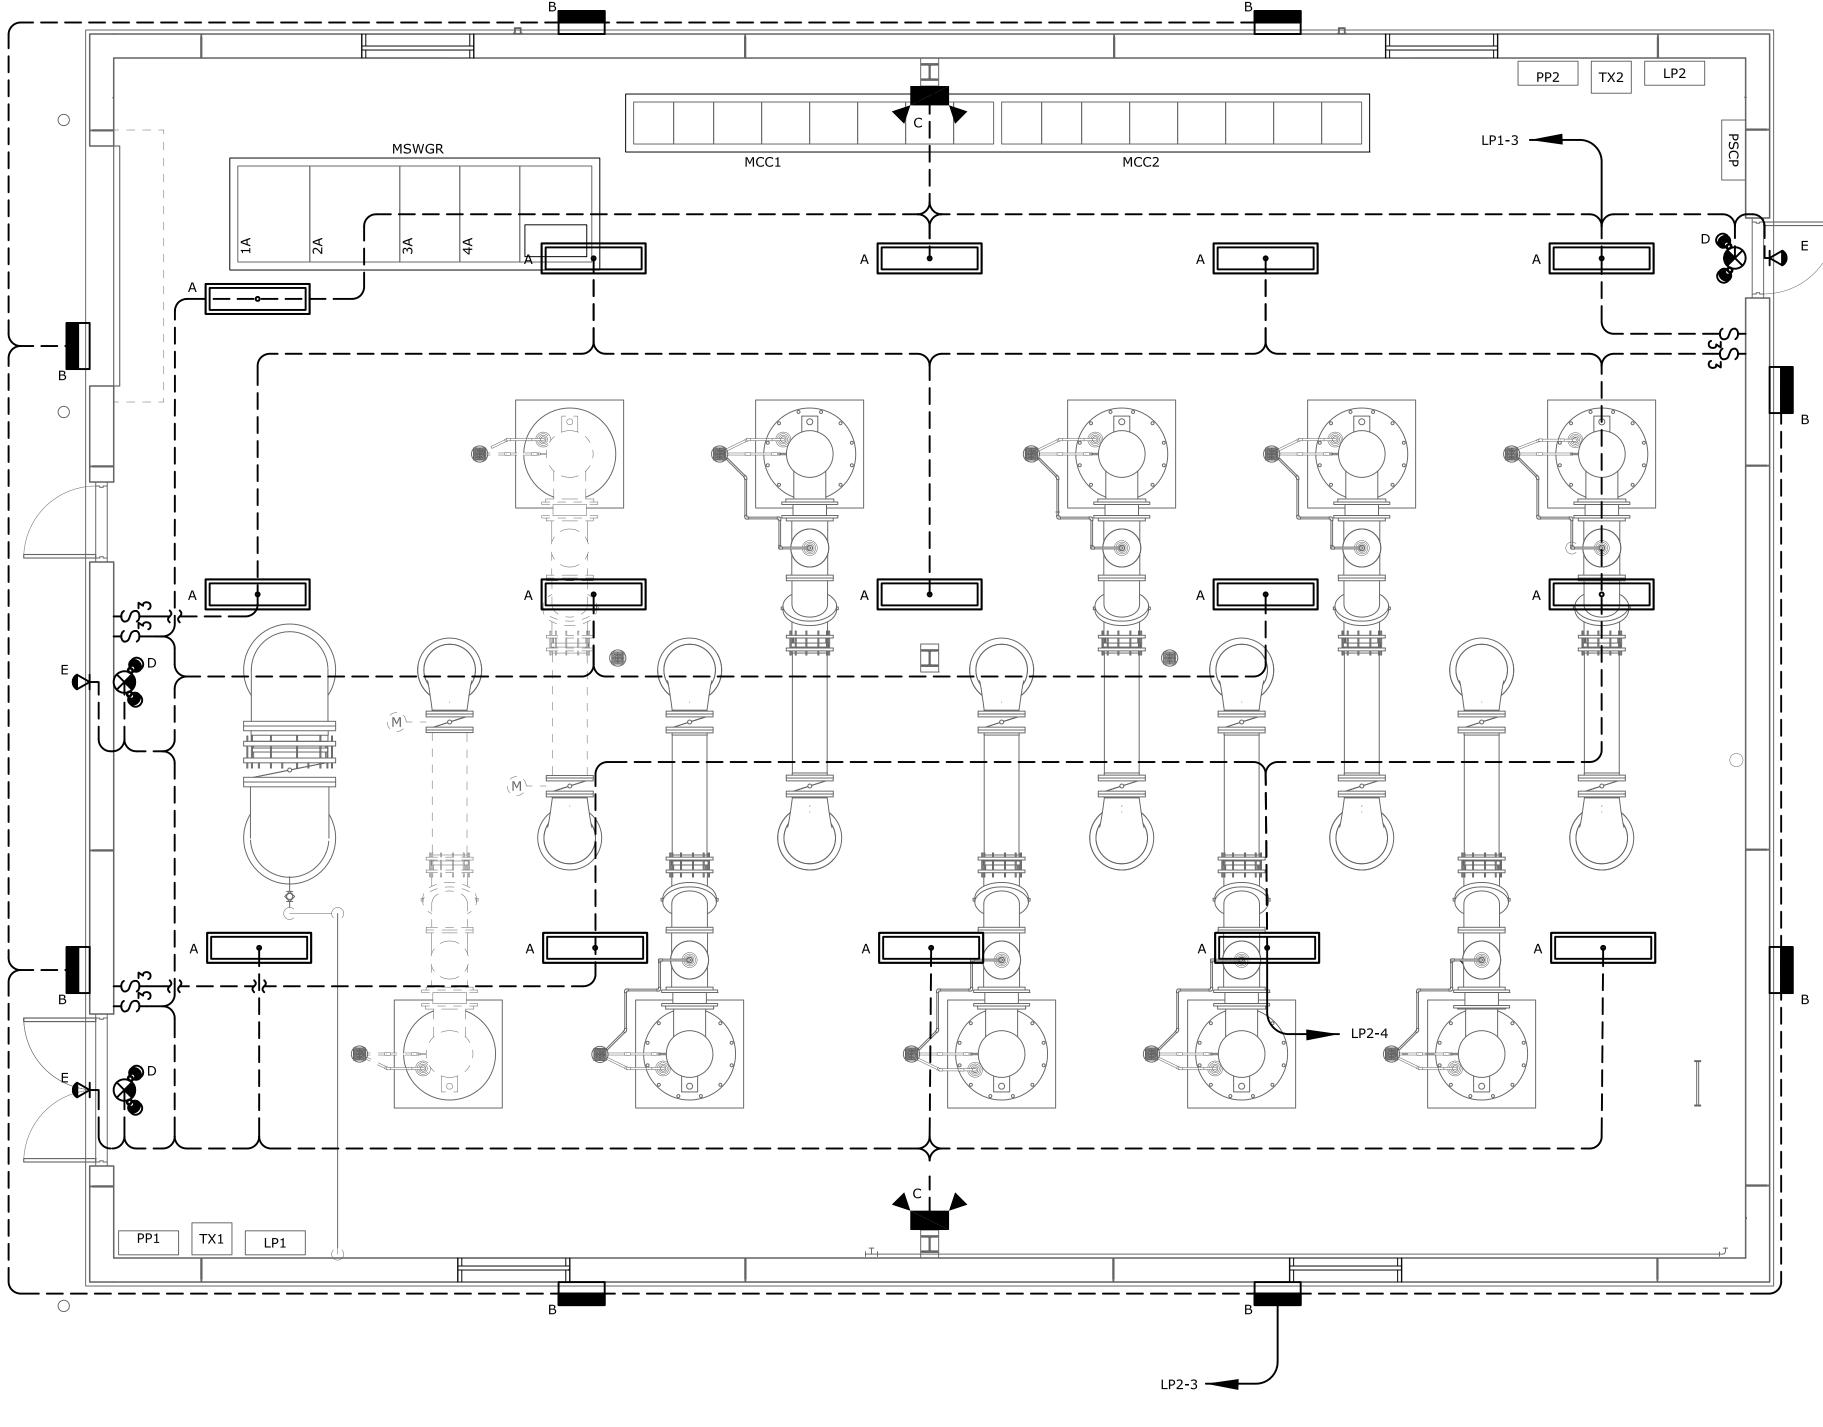

PUMP STATION LIGHTING PLAN

SCALE 1/4" = 1'-0"

				PROJECT ENGINEER:	R. W. STURGILL
				DESIGNED BY:	R. W. STURGILL
				DRAWN BY:	R. W. LAWSON
				CHECKED BY:	-
3	CONSTRUCTION	3-8-16	RWS	CHECKED DT:	
2	BUILDING PERMIT REVIEW	2-26-16	RWS	IF THIS BAR DOES NOT	0 1/2" 1"
1	REGULATORY REVIEW	1-20-16	RWS	MEASURE 1" THEN DRAWING 0 1/2"	
REV	ISSUED FOR	DATE	BY	IS NOT TO FULL SCALE	

ISSUED FOR CONSTRUCTION





DAVIDSON COUNTY NORTH CAROLINA

DAVIDSON WATER INC. HYATTOWN PUMP STATION IMPROVEMENTS PUMP STATION LIGHTING PLAN

DATE:	MARCH 2016		
HAZEN NO.:	30961-010		
CONTRACT N	0.: 1		
554147146			

DRAWING NUMBER:

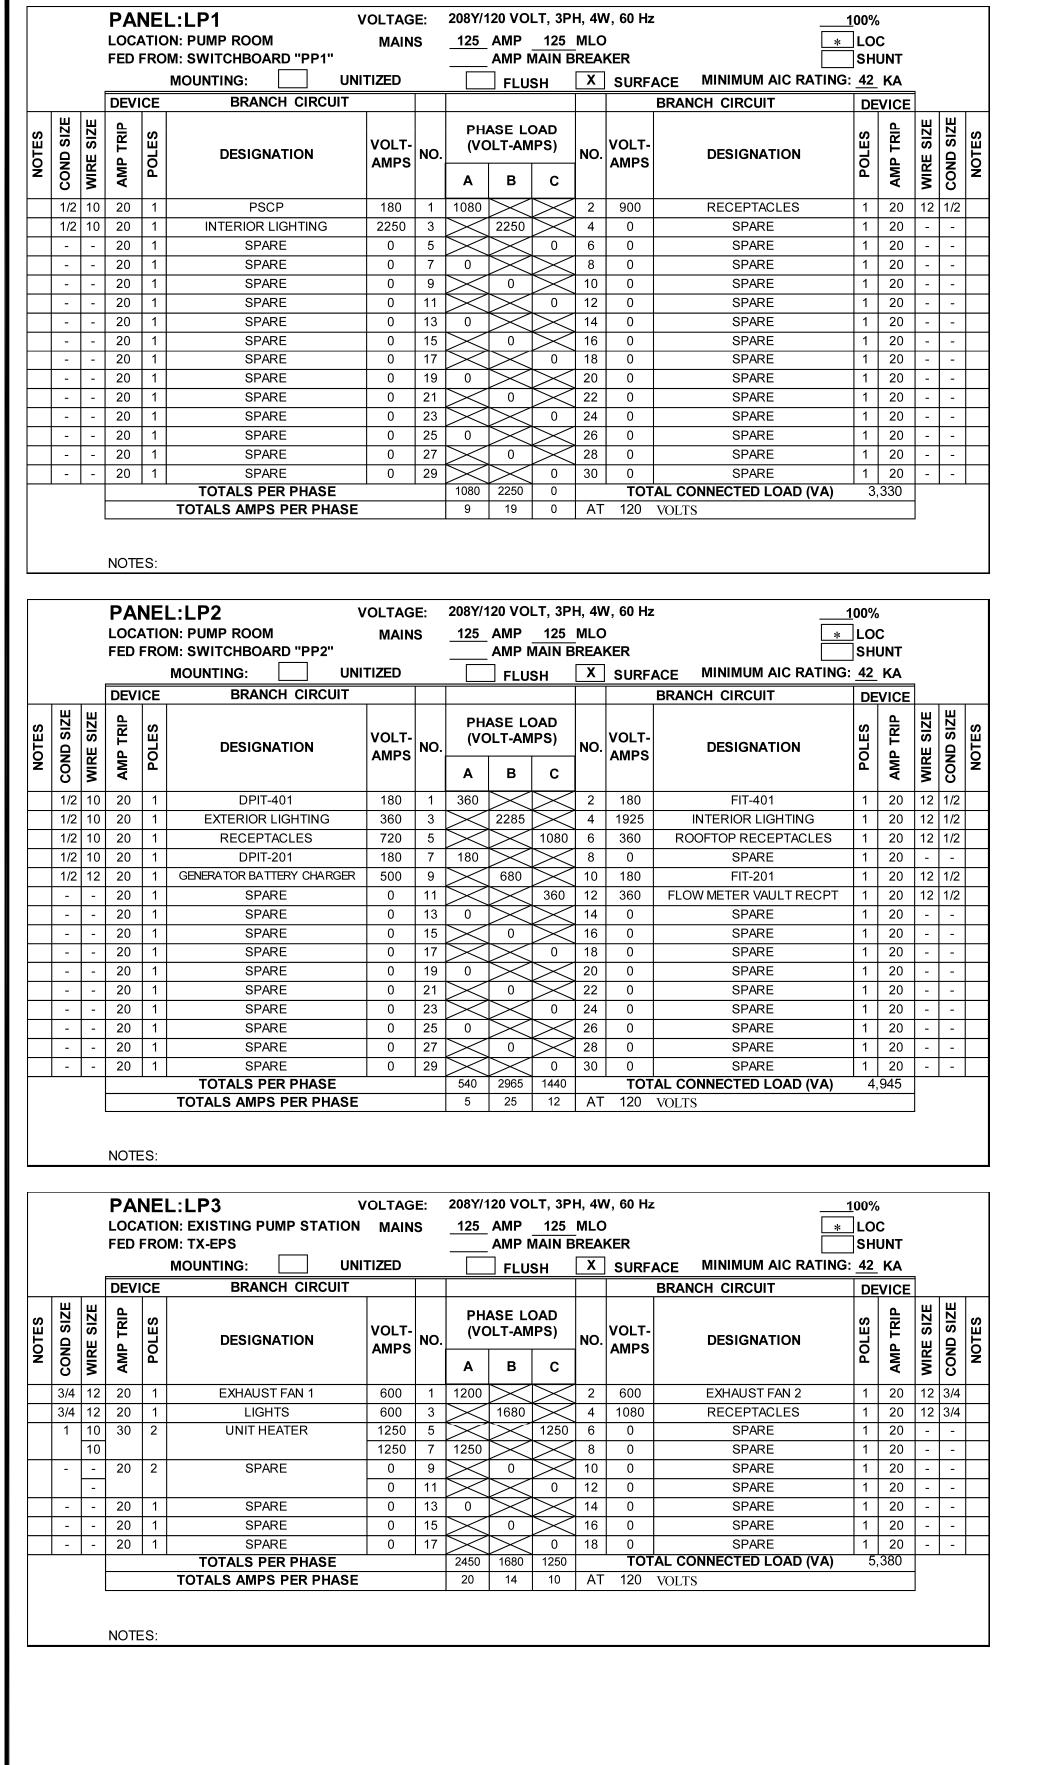

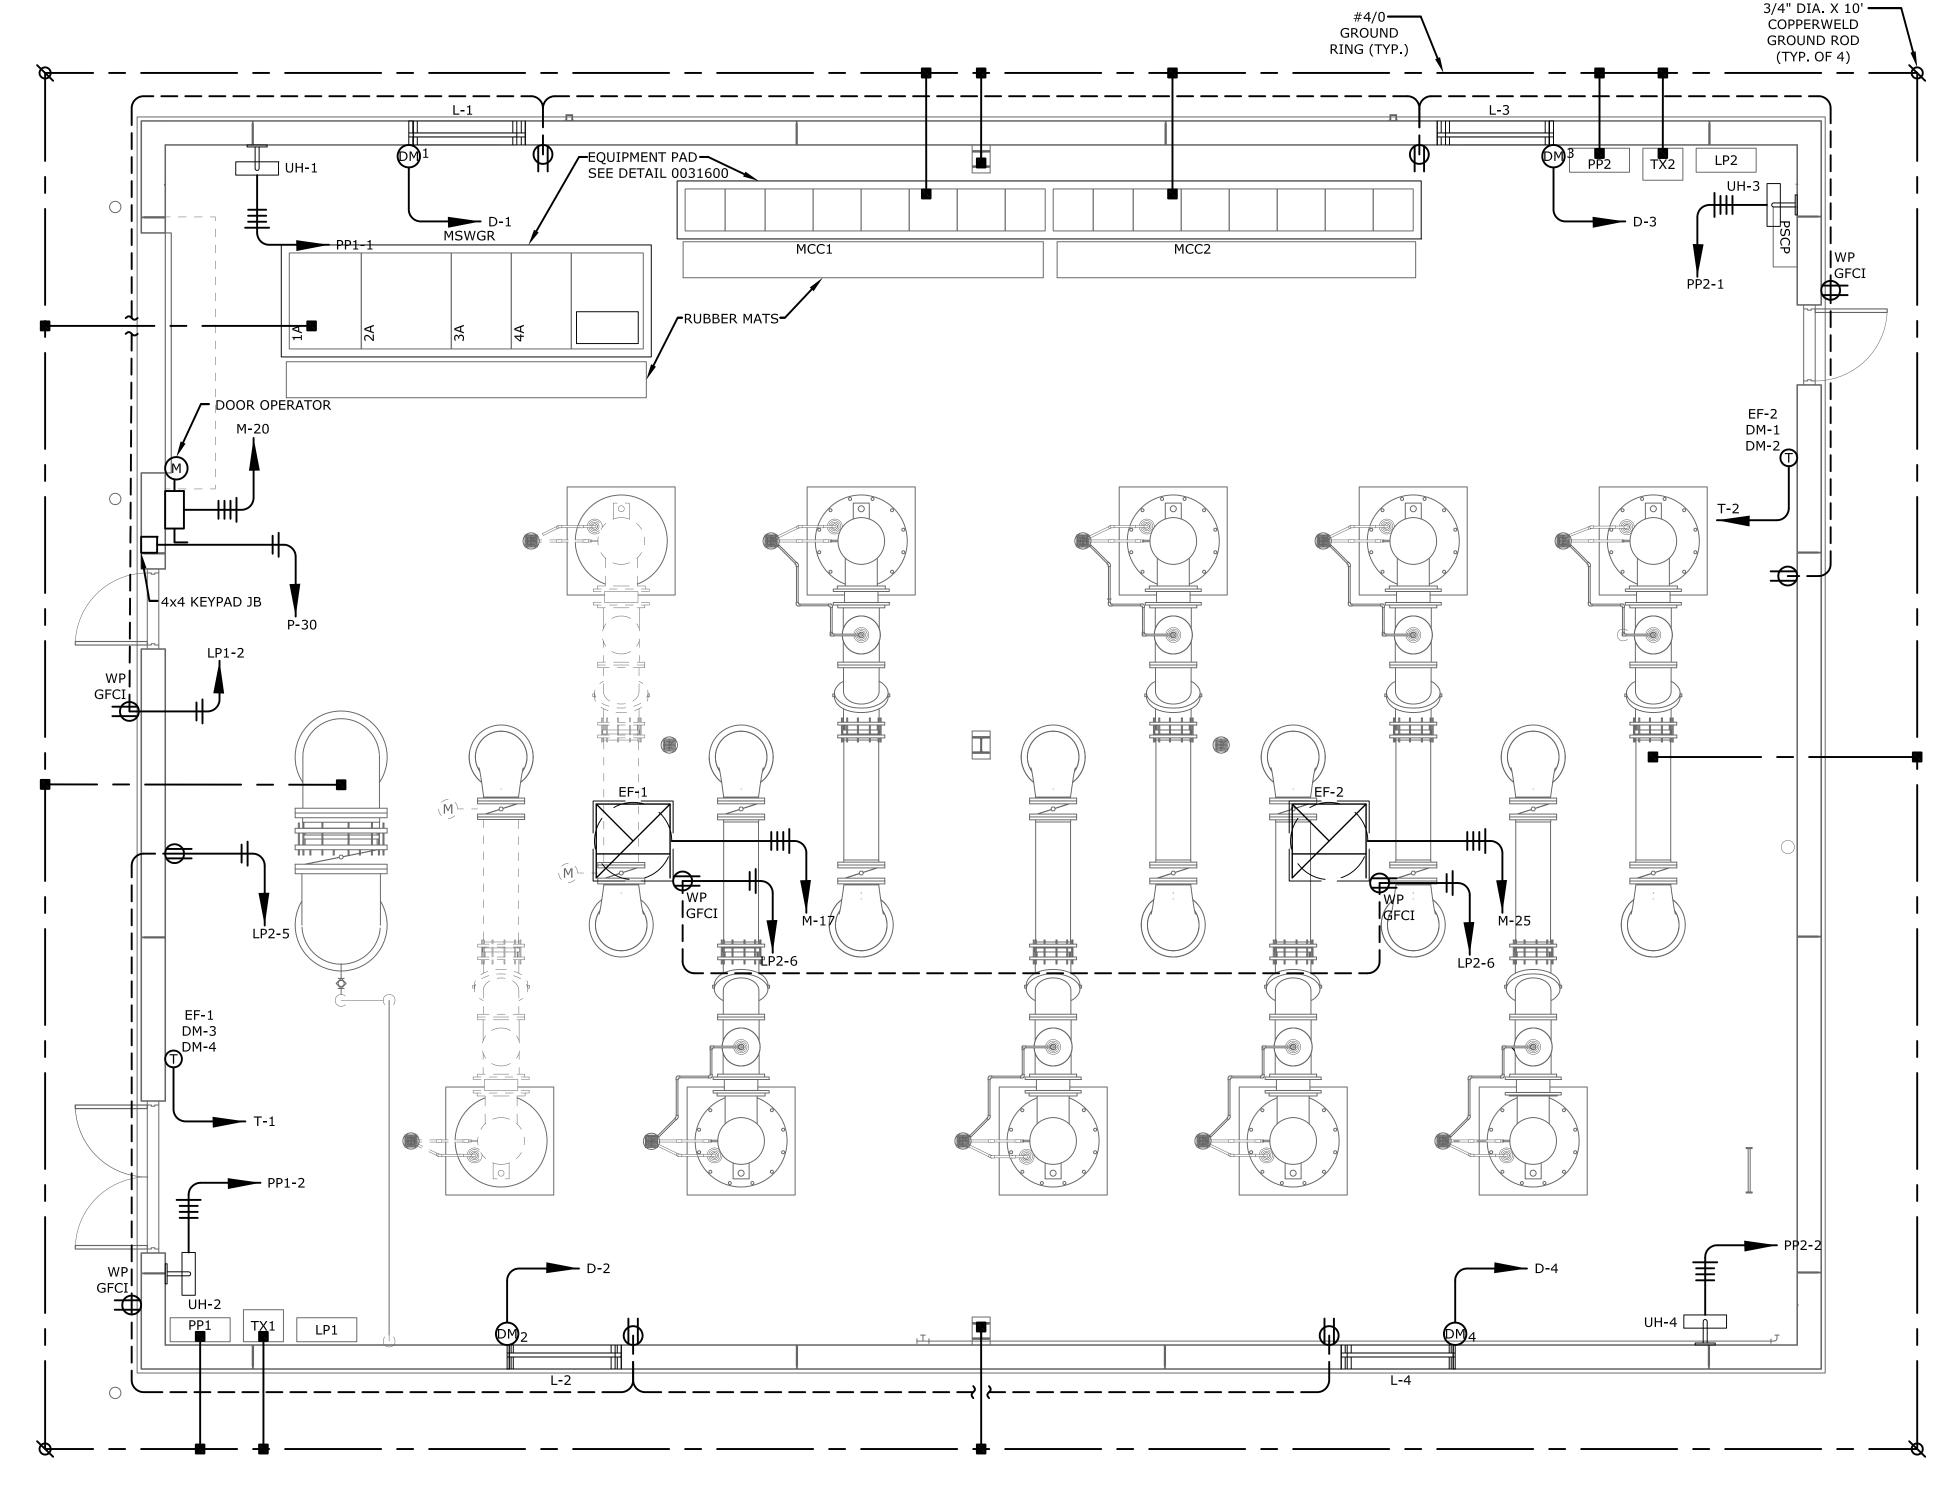


PUMP STATION HVAC AND RECEPTACLE POWER PLAN

SCALE 1/4" = 1'-0"

				PROJECT R. W. STURGILL ENGINEER:
				DESIGNED BY: R. W. STURGILL
				DRAWN BY: R. W. LAWSON
3	CONSTRUCTION	3-8-16	RWS	CHECKED BY: -
2	BUILDING PERMIT REVIEW	2-26-16	RWS	IF THIS BAR DOES NOT
1	REGULATORY REVIEW	1-20-16	RWS	MEASURE 1" THEN DRAWING 1/2" 1"
REV	ISSUED FOR	DATE	BY	IS NOT TO FULL SCALE

ISSUED FOR CONSTRUCTION

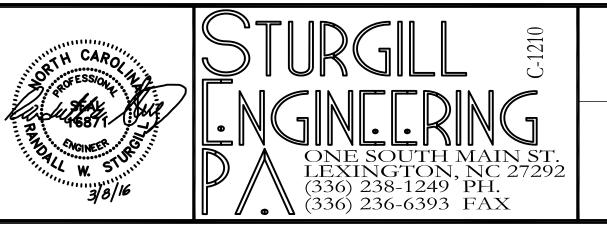


DAVIDSON COUNTY NORTH CAROLINA

DAVIDSON WATER INC.
HYATTOWN PUMP STATION IMPROVEMENTS

PUMP STATION HVAC AND RECEPTACLE POWER PLAN

DATE:	MARCH 2016
HAZEN NO.:	30961-010
CONTRACT NO	).: 1
DRAWING	


NUMBER:

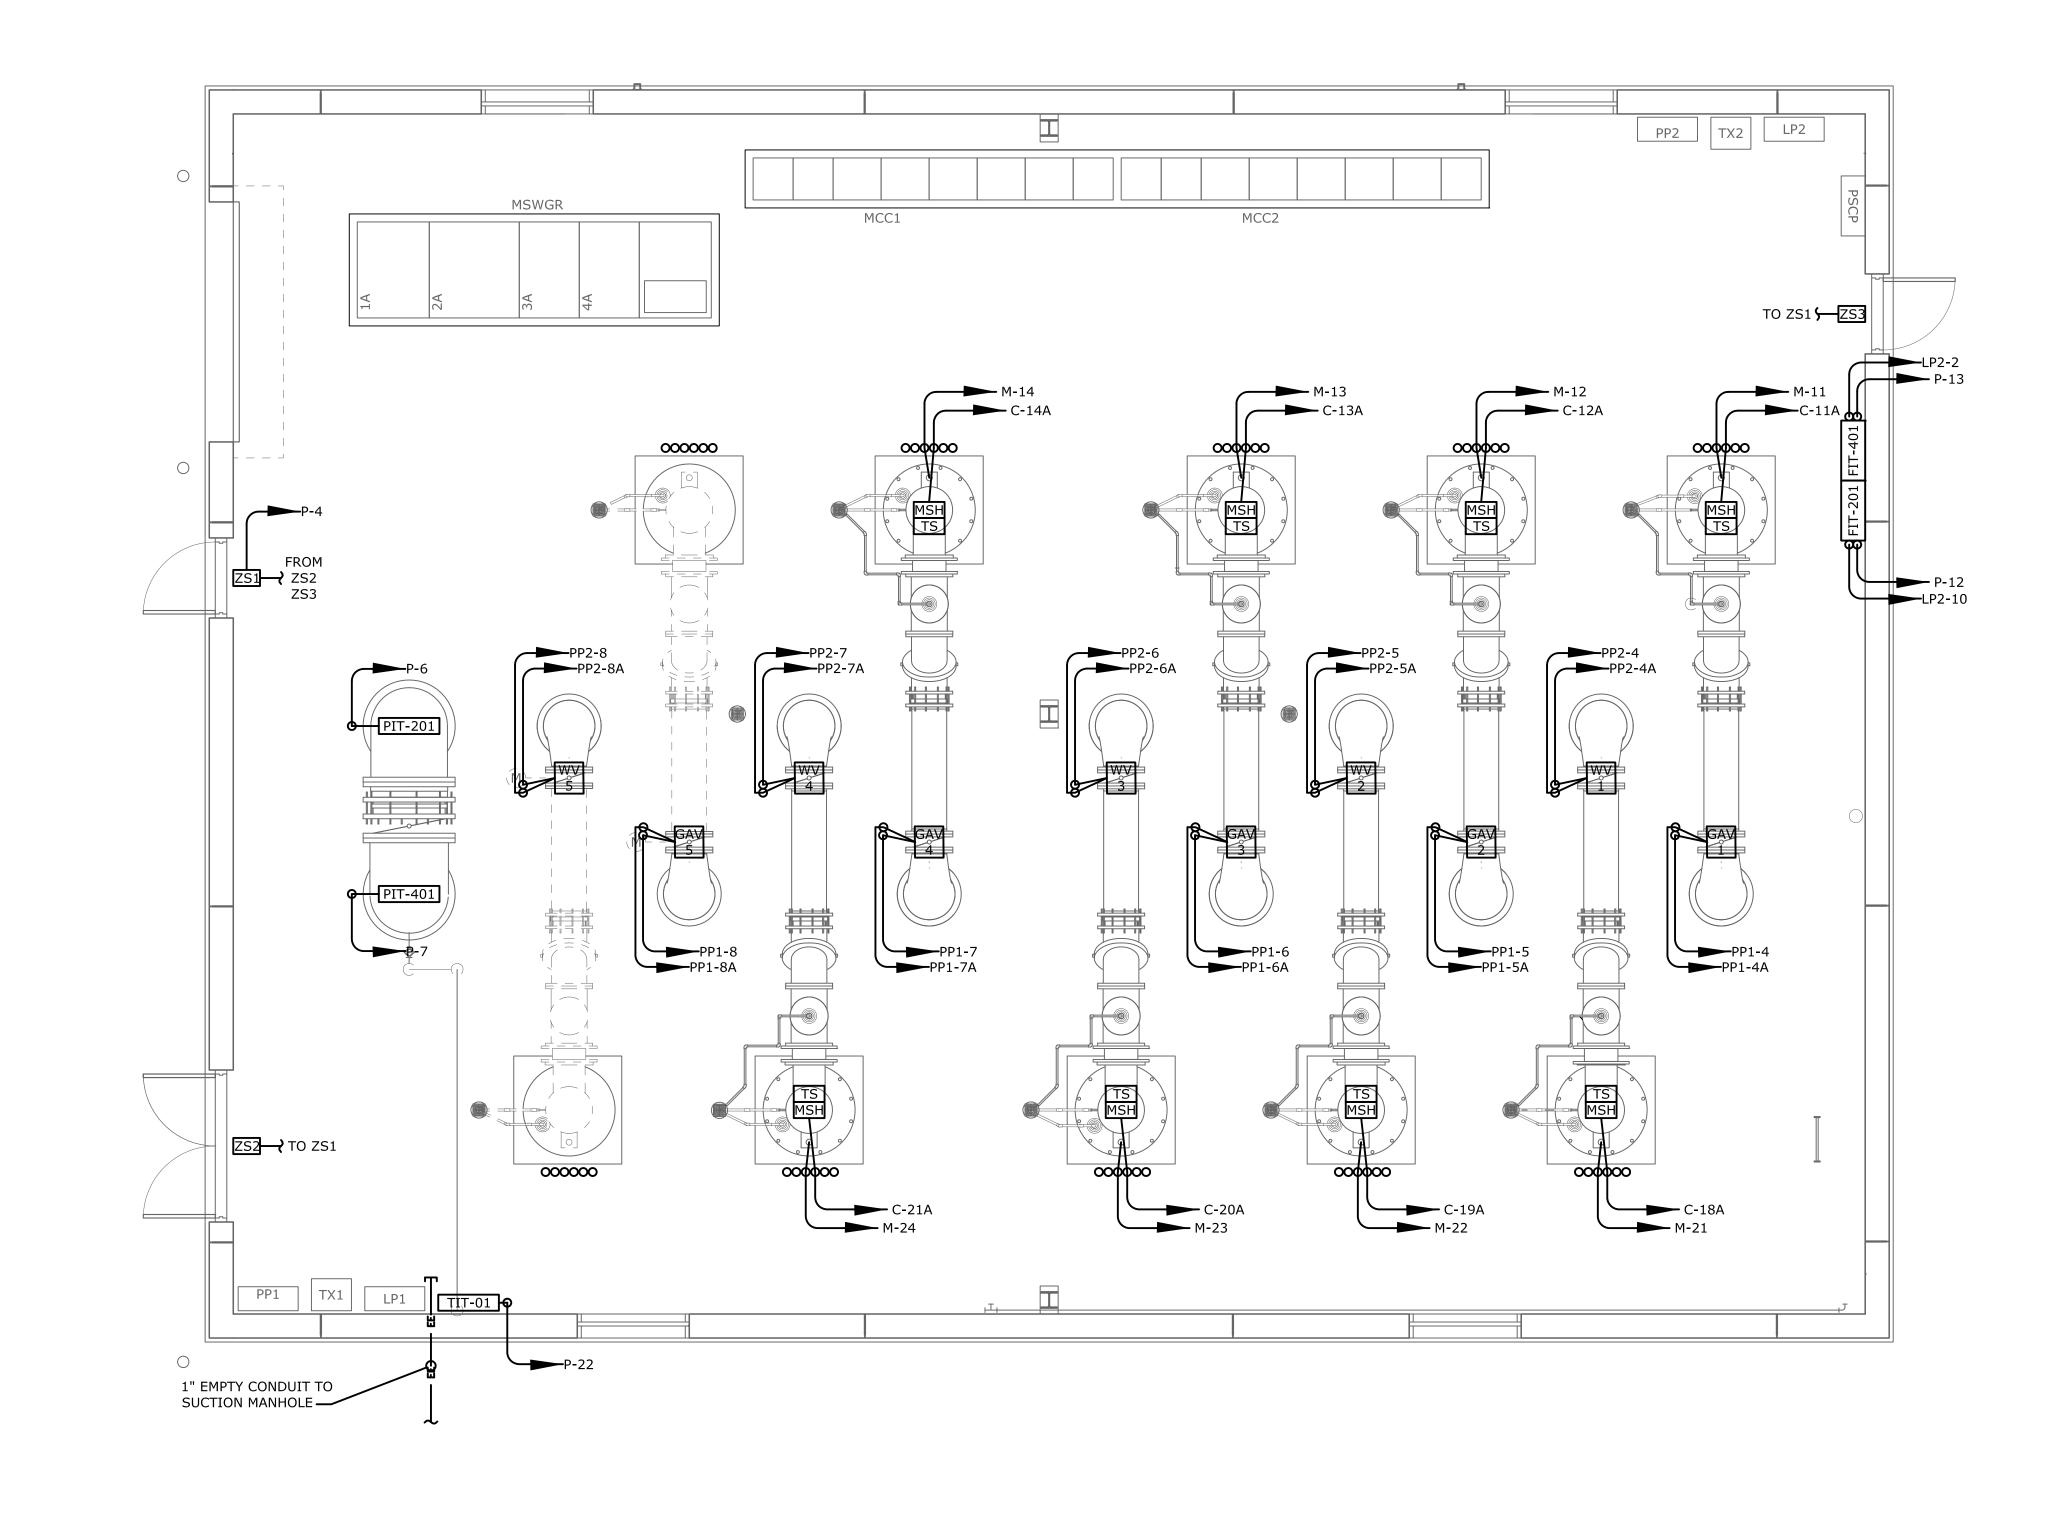

# PUMP STATION CONDUIT ROUTING SCALE 1/4" = 1'-0"

8							
BY: RLAWSON					PROJECT ENGINEER:	R. W. STURGILL	
DM M					DESIGNED BY:	R. W. STURGILL	
3: 00: 07					DRAWN BY:	R. W. LAWSON	
2016/03/08	3	CONSTRUCTION	3-8-16	RWS	CHECKED BY:	-	
0/9		CONSTRUCTION					
201	2	BUILDING PERMIT REVIEW	2-26-16	RWS	IF THIS BAR DOES NOT	0 1/2" 1"	
نن	1	REGULATORY REVIEW	1-20-16	RWS	MEASURE 1" THEN DRAW:	ING 0 1/2" 1"	
OT DATE:	REV	ISSUED FOR	DATE	BY	IS NOT TO FULL SCALE		

ISSUED FOR CONSTRUCTION

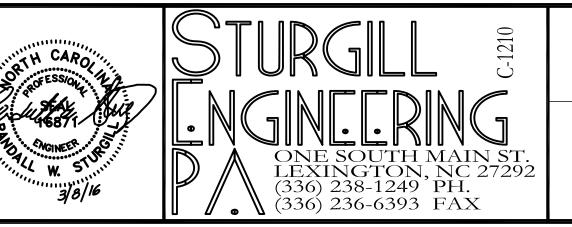


DAVIDSON COUNTY NORTH CAROLINA

DAVIDSON WATER INC. HYATTOWN PUMP STATION IMPROVEMENTS PUMP STATION CONDUIT ROUTING

DATE:	MARCH 2016
HAZEN NO.:	30961-010
CONTRACT NO	D.: 1

DRAWING NUMBER:

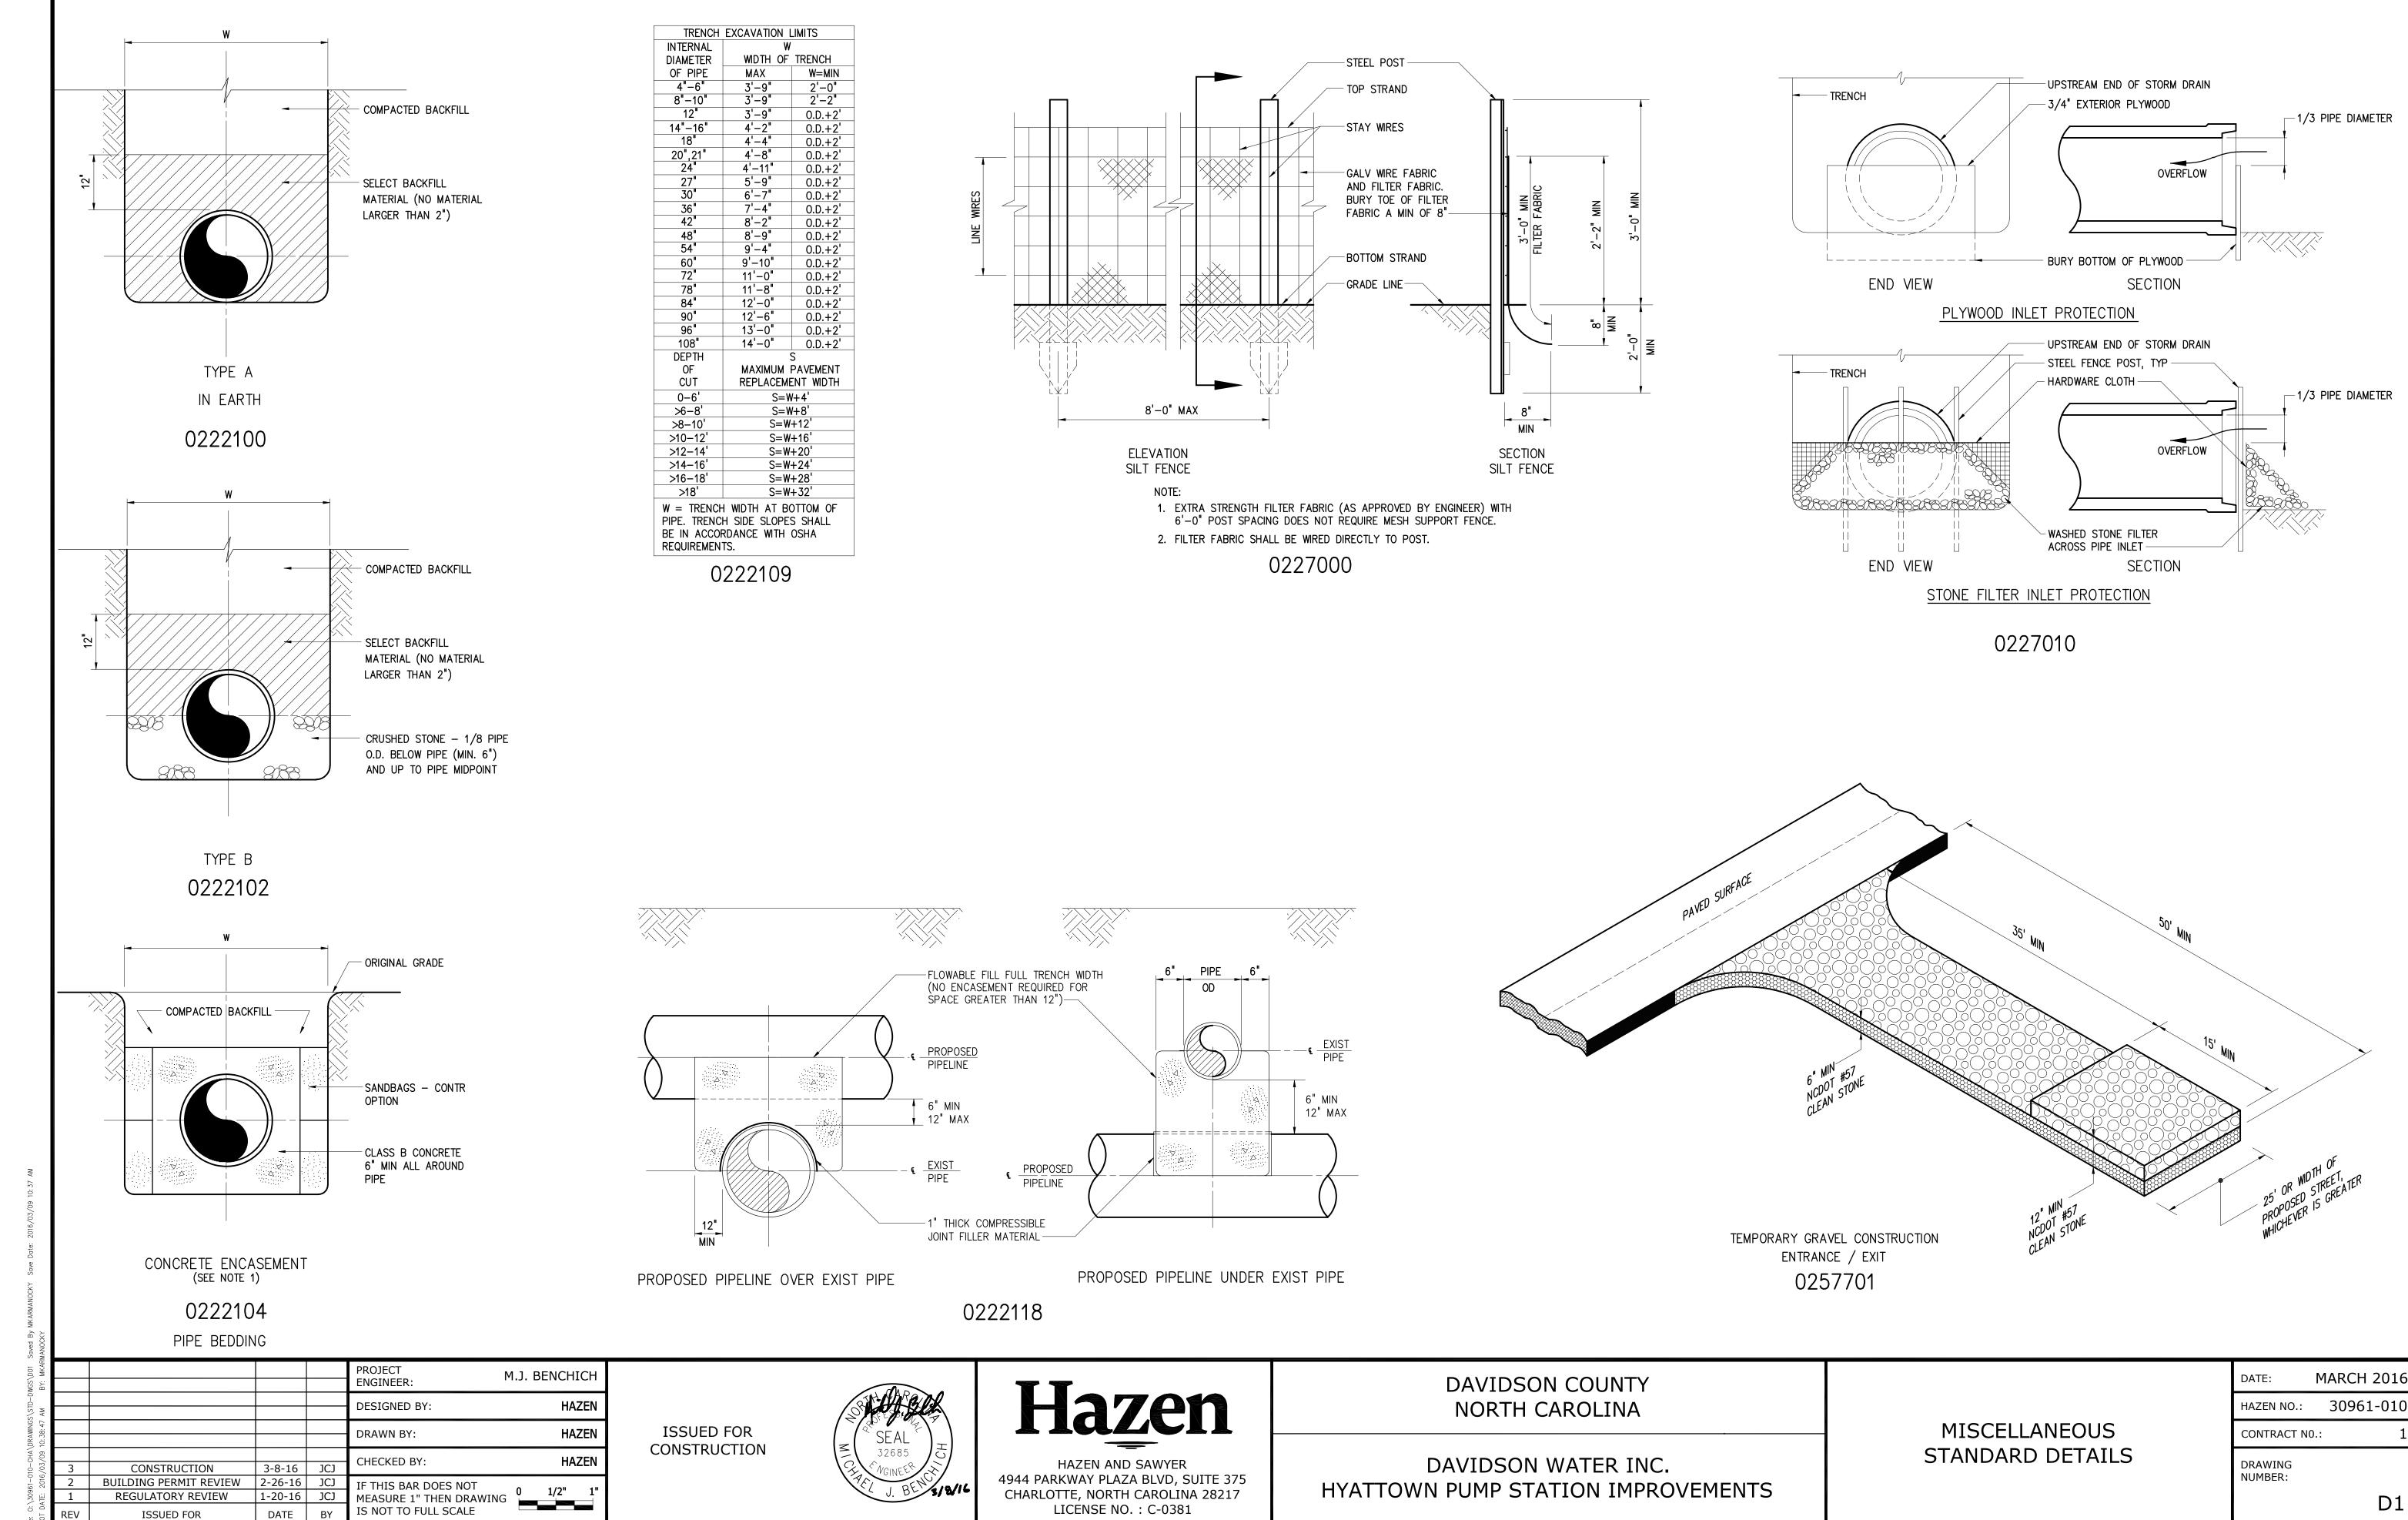


D1


REGULATORY REVIEW

**ISSUED FOR** 

1-20-16 JCJ

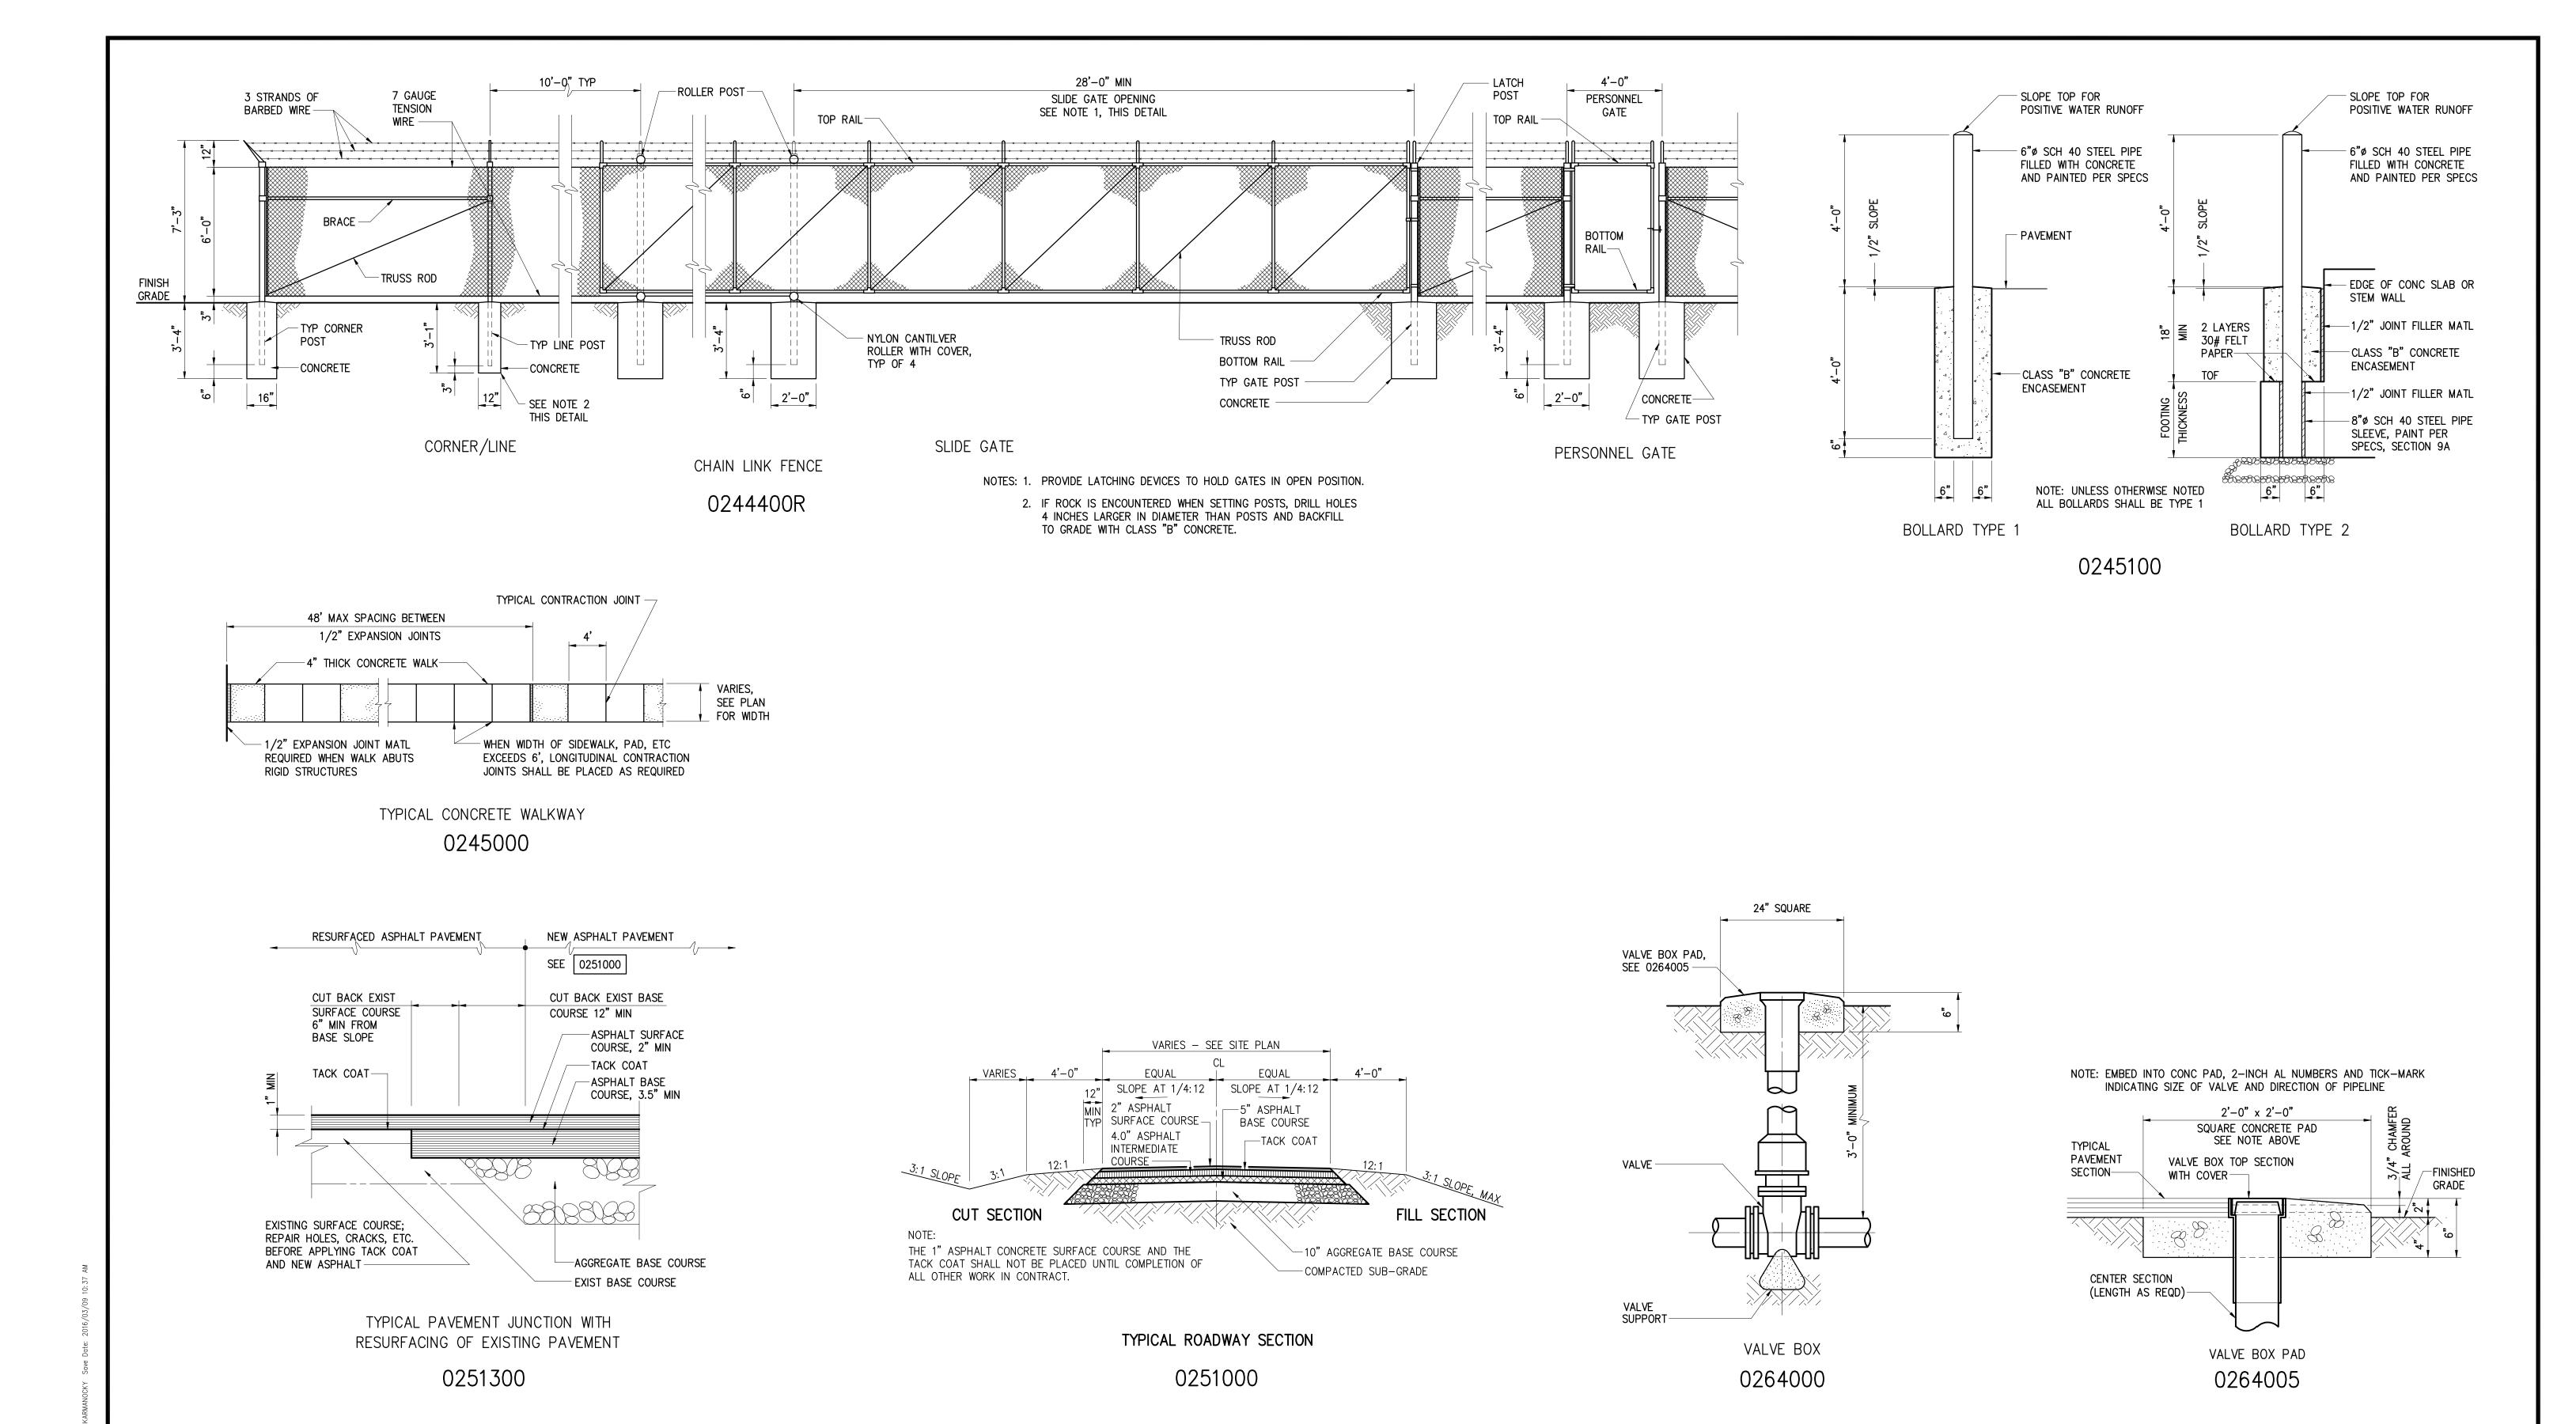

MANC						
BY: MKARMANC					PROJECT M.J. BENCHICH ENGINEER:	
AM					DESIGNED BY: HAZEN	]
10: 38: 49					DRAWN BY: HAZEN	
/03/09	3	CONSTRUCTION	3-8-16	JCJ	CHECKED BY: HAZEN	
2016,	2	BUILDING PERMIT REVIEW	2-26-16	JCJ	IF THIS BAR DOES NOT 0 1/2" 1"	1
DATE:	1	REGULATORY REVIEW	1-20-16	JCJ	MEASURE 1" THEN DRAWING 0 1/2" 1"	ı
√O J	DE\/	ISSUED FOR	DATE	RV	IS NOT TO FULL SCALE	

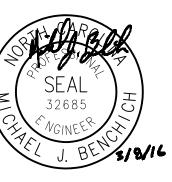

Hazen
HAZEN AND SAWYER 4944 PARKWAY PLAZA BLVD, SUITE 375


DAVIDSON COUNTY NORTH CAROLINA

DAVIDSON WATER INC. HYATTOWN PUMP STATION IMPROVEMENTS

MISCELLANEOUS STANDARD DETAILS

DATE:	MARCH 2016
HAZEN N	NO.: 30961-010
CONTRA	CT NO.: 1
DRAWIN NUMBER	:
	D2

**ISSUED FOR** CONSTRUCTION CHARLOTTE, NORTH CAROLINA 28217 LICENSE NO.: C-0381

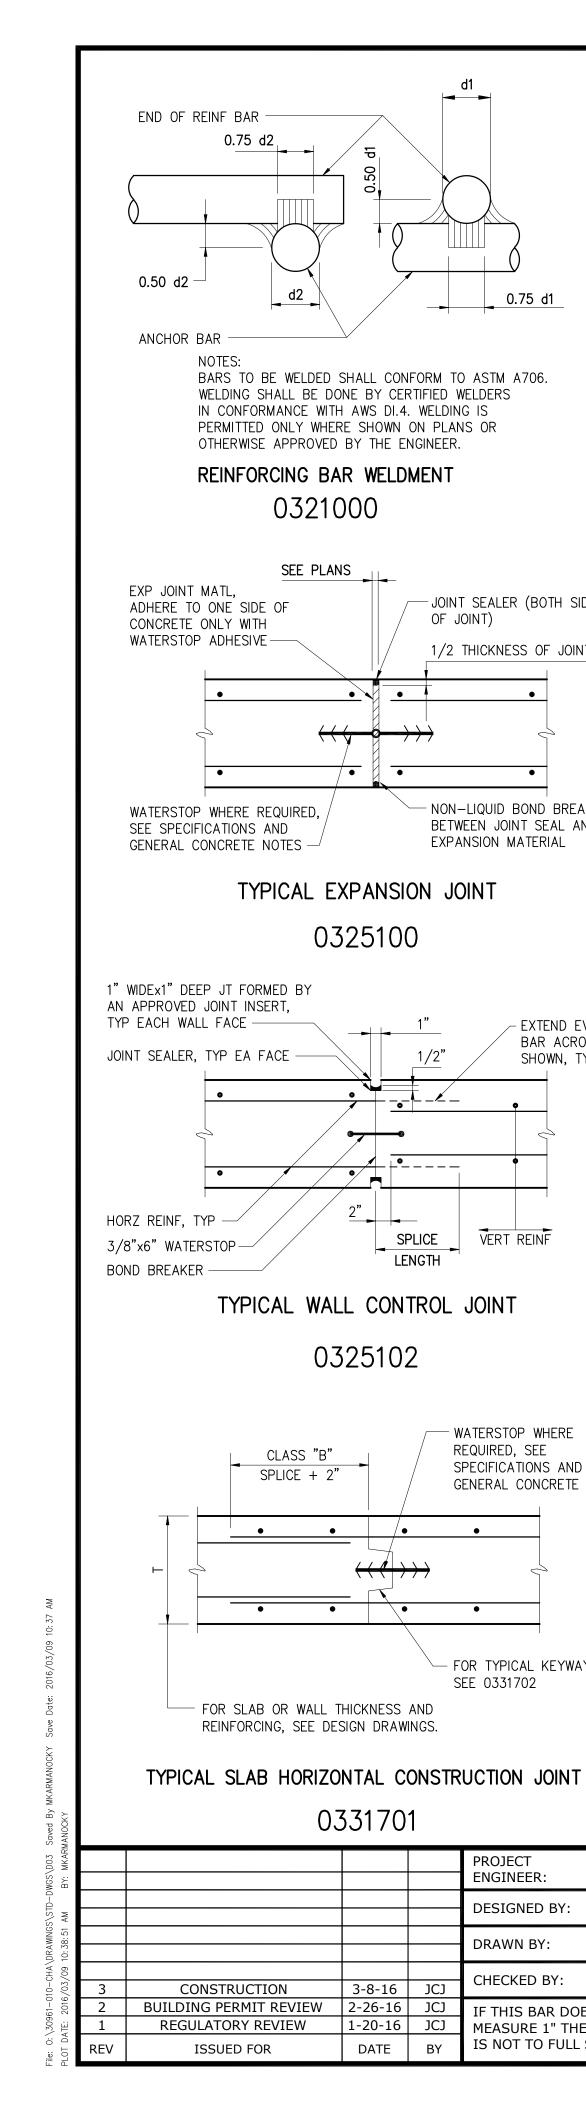

- JOINT SEALER (BOTH SIDES

1/2 THICKNESS OF JOINT

NON-LIQUID BOND BREAKER

BETWEEN JOINT SEAL AND

WATERSTOP WHERE

SPECIFICATIONS AND

FOR TYPICAL KEYWAY,

SEE 0331702

PROJECT

**ENGINEER:** 

**DESIGNED BY:** 

CHECKED BY:

IF THIS BAR DOES NOT

IS NOT TO FULL SCALE

MEASURE 1" THEN DRAWING
IS NOT TO FILL SCALE

DRAWN BY:

M.J. BENCHICH

HAZEN

HAZEN

HAZEN

GENERAL CONCRETE NOTES.

REQUIRED, SEE


- EXTEND EVERY OTHER HORZ

BAR ACROSS JOINT AS

SHOWN, TYP EACH FACE

EXPANSION MATERIAL


OF JOINT)

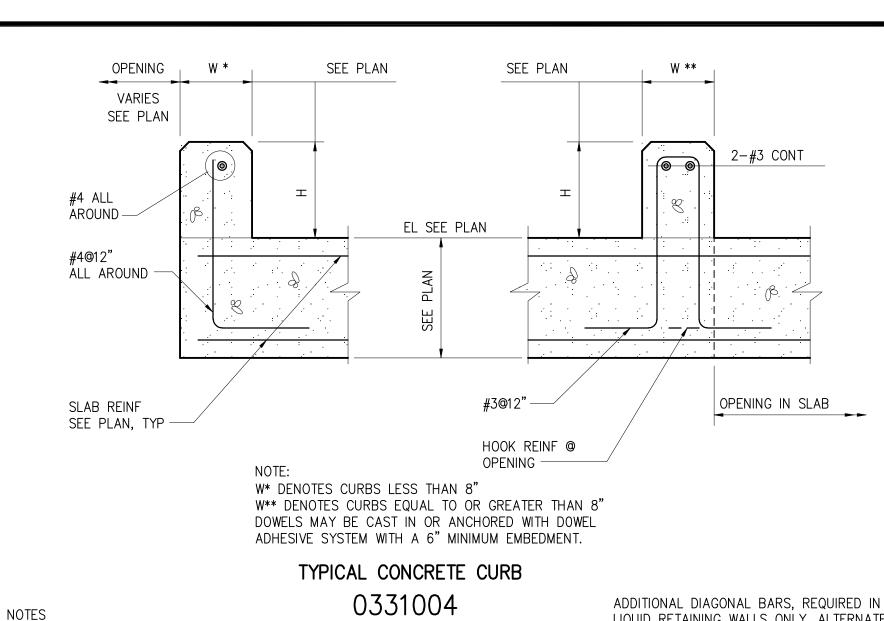

AS REQUIRED PUMP OR EQUIP 1" GROUT (SEE BASE SPECIFICATIONS) CONC BASE-6" MINIMUM, IF OVER 24", ADDL CL ANCHOR #4@12 EW STEEL REQUIRED BOLTS REQUIRED 8" MIN, COVER + 1" — CONC FLOOR -SEE NOTE MAX — #5 DOWELS @12" #5 DOWELS @12" ALL AROUND, SEE NOTE ALL AROUND, SEE NOTE - DOWEL ADHESIVE DOWELS MAY BE CAST IN WITH 90° HOOK OR ANCHORED WITH DOWEL ADHESIVE AT CONTRACTORS OPTION. WHERE

FLOOR IS 8" THICK OR LESS, USE #4 DOWELS EMBEDDED TO WITHIN 2" OF BOTTOM OF FLOOR SLAB.

## TYP PUMP OR EQUIP BASE 0331600

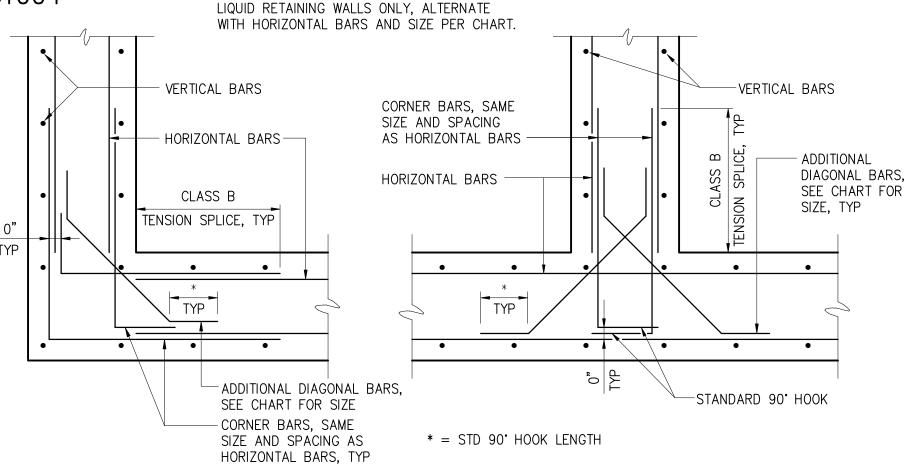

DIAGONAL BAI	R SIZE CHART			
BAR SIZE — HORIZONTAL REINFORCEMENT	BAR SIZE — DIAGONAL REINFORCEMENT			
# 3	# 3			
# 4	# 3			
# 5	# 4			
# 6	# 5			
# 7	# 5			
# 8	# 6			
# 9	# 7			
# 10	# 8			
# 11	# 9			
AT LOCATIONS WHERE DIFFERENT SIZE HORIZONTAL BARS CONVERGE, THE LARGER BAR SIZE SHALL CONTROL				

#### NOTES:

TO WITHIN 2" OF BOTTOM OF FLOOR SLAB.

PARTICULARLY FOR OUTSIDE AERIAL PIPE.

PIPE OD

APPROVED ADHESIVE

ON BOTH CONTACT

SURFACES OF PAD

1/4" MIN NEOPRENE PAD, DUROMETER 40 TO 50

MATERIAL HARDNESS,

SEE NOTE 2 -

#3@12", TIES

REQUIRED

MAX -

COVER + 1"

1. THIS DETAIL APPLIES FOR OPENINGS 8" AND LARGER. FOR SMALLER OPENINGS, BEND BARS OR ADJUST SPACING OF REINFORCEMENT TO AVOID OPENING.

6" MIN SEE NOTE 3

- DOWEL ADHESIVE

120°

- CONC FLOOR-

#5 DOWELS @12" EF

SEE NOTE 1

CONTRACTORS OPTION. WHERE FLOOR IS 8" THICK OR LESS, USE #4 DOWELS EMBEDDED

-ROTATE HOOK 90' FROM SHOWN SO THAT

1. DOWELS MAY BE CAST IN WITH 90' HOOK OR ANCHORED WITH DOWEL ADHESIVE AT

2. ENGINEER SHALL VERIFY THICKNESS OF PAD WILL ACCOMMODATE DESIGN MOVEMENT,

3. COORDINATE SUPPORT WIDTH WITH PIPE STRAP ANCHORAGE REQUIREMENTS. PROVIDE

6" MINIMUM, FROM CENTER OF PIPE STRAP ANCHOR ROD TO EDGE OF CONCRETE.


CRADLE PIPE SUPPORT

0331601

HOOK IS PARALLEL TO PIPE, TYP

#4 EF, TYP

- 2. PLACE EXTRA BARS OF THE SAME SIZE AS THE INTERRUPTED BARS AT EACH SIDE OF OPENING. QUANTITY OF EXTRA BARS AT EACH SIDE SHALL EQUAL HALF THE QUANTITY OF INTERRUPTED BARS EXCEPT WHERE NOTED OTHERWISE.
- 3. PROVIDE ONE DIAGONAL BAR EACH SIDE OF OPENING WITH SIZE EQUAL TO MAIN REINFORCEMENT, TYPICAL EACH FACE.
- 4. WHERE INVERT OF OPENING IN WALL IS LESS THAN 44 BAR DIAMETERS FROM TOP OF SLAB, EXTRA REINFORCEMENT ON EACH SIDE SHALL INCLUDE DOWELS EMBEDDED INTO SLAB WITH STANDARD 90 DEGREE HOOKS TO SPLICE WITH EXTRA VERTICAL REINFORCEMENT. DOWELS SHALL ALSO STILL BE PROVIDED BELOW OPENING.
- WHERE INVERT OF OPENING IN WALL OR SLAB IS CLOSER THAN 44 BAR DIAMETERS TO EDGE OF SLAB OR BOTTOM OF WALL, EXTRA DIAGONAL BARS MAY BE TERMINATED TWO INCHES FROM EDGE OF SLAB OR BOTTOM OF WALL. DOWELS DO NOT HAVE TO BE PROVIDED TO SPLICE WITH DIAGONAL

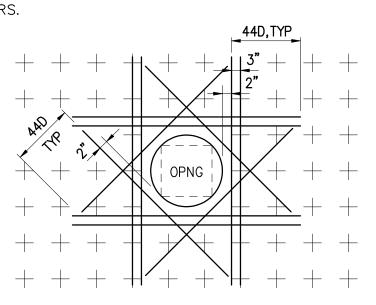

TYPICAL REINF AT OPENINGS 0331703

# INTERSECTION CORNER TYPICAL WALL REINFORCING 0331700 OPTIONAL SLOPE AS REQUIRED

#4@12", TYP -#4**@**12**"**, T&B #4@12" ,EW #4@12" EW, TYP #4@12" TYPE I TYPE II NOTE: TIE IN ALL PIPES & CONDUITS BELOW GROUND FLOOR SLAB WHEN PILE FOUNDATION IS UTILIZED. USE TYPE 1. PIPE ENCASEMENTS

> ALL PIPING AND CONDUITS BELOW SLABS ON EARTH TO BE ENCASED BY GENERAL CONTRACTOR UNLESS NOTED OTHERWISE.

> > 0331606

PIPE OR CONDUIT EMBEDDED IN SLAB 0331604

2D (2" MIN)

DAVIDSON COUNTY NORTH CAROLINA

NOTE: D DENOTES PIPE OR CONDUIT OD

REINF BAR-

TOP OF SLAB -

DAVIDSON WATER INC. HYATTOWN PUMP STATION IMPROVEMENTS

MISCELLANEOUS STANDARD DETAILS

DATE:	MARCH 2016
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DRAWING NUMBER:	

D3

ISSUED FOR CONSTRUCTION

1 JOINTS SHALL BE FORMED BY AN APPROVED

2 DEPTH SHALL BE 1 1/2" IN REINF CONC

TYPICAL SEALED JOINT

0325101

1/3 1/3 1/3

TYPICAL KEYWAY

0331702

-WATERSTOP

NOT BE ALLOWED.

3/8"± 1/16"


1/4" TOOLED

RADIUS, TYP -

JOINT INSERT. SAWCUTTING OF JOINTS WILL

DEPTH SHALL BE 1/3 OF CONCRETE THICK-

NESS IN UNREINFORCED CONCRETE PAVEMENT

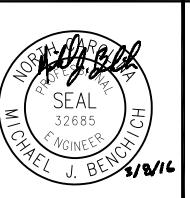


Hazen HAZEN AND SAWYER


4944 PARKWAY PLAZA BLVD, SUITE 375

CHARLOTTE, NORTH CAROLINA 28217

LICENSE NO.: C-0381

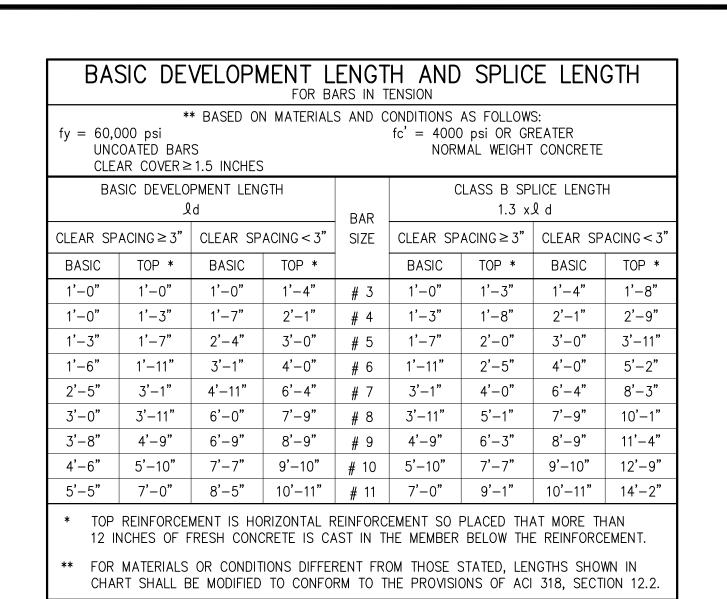


0321004

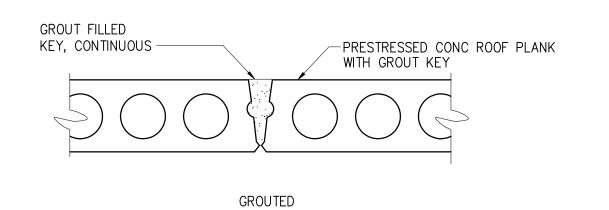

PRECAST PLANK CONNECTION

0341203

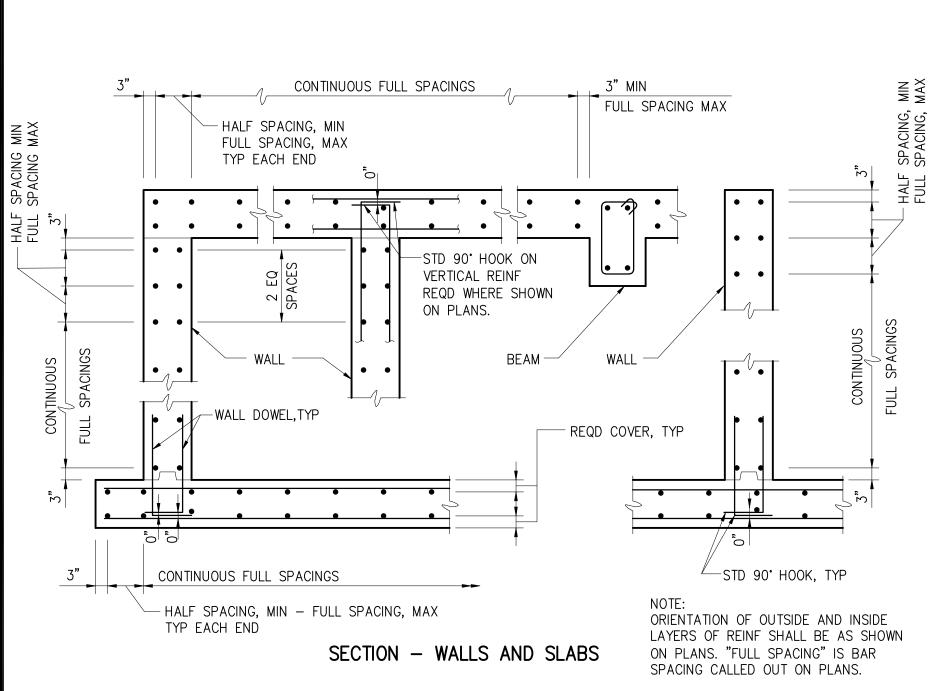


PROJECT

TYPICAL BAR PLACEMENT 0331704 M.J. BENCHICH

HAZEN

HAZEN

HAZEN

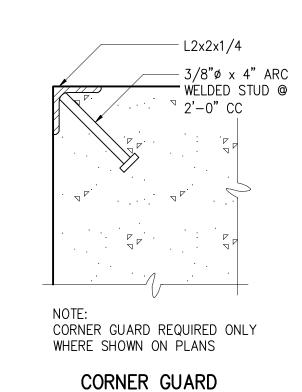

0554001

REQD COVER, TYP — CONTINUOUS FULL SPACINGS HALF SPACING, MIN FULL SPACING, MAX TYP EACH END . . . . . . . . . . . . . . -4 VERTICAL BARS IN CORNER HALF SPACING, MIN CONTINUOUS HALF SPACING, MIN FULL SPACINGS FULL SPACING, MIN FULL SPACING, MAX

PLAN - WALLS

#### DEVELOPMENT LENGTH OF STANDARD HOOKS FOR BARS IN TENSION fc' = 4000 psi OR GREATER fy = 60,000 psiDEVELOPMENT LENGTH, & dh BAR SIZE W/ CONC COVER \* 6" 10" 1'-0" 1'-3" 1'-5" 1'-0" 1'-2" 1'-7" 1'-10" 1'-4" #10 1'-6" 2'-1" 2'-3" 1'-7" \* SIDE COVER NORMAL TO PLANE OF HOOK AT LEAST 2 1/2"; AND FOR 90° HOOK, END COVER BEYOND OUTSIDE END OF HOOK AT LEAST 2".

0321003

AT CONTROL JOINT

- CONTROL JOINT

JOINT FILLER

CONTROL JOINTS MAY BE OFFSET A MAXIMUM

**ELEVATION** 

PLAN

NOTE: WIDE FLANGED PREFORMED CONTROL JOINT

CONTROL JOINT BLOCK

0418000

FILLER MAY BE USED IN LIEU OF DETAIL SHOWN

#### **GENERAL CONCRETE NOTES:**


E - WALLS 12" OR MORE -


- 1 CONCRETE PROTECTION FOR REINFORCING SHALL BE AS FOLLOWS UNLESS OTHERWISE NOTED ON THE DRAWINGS: A - CONCRETE DEPOSITED DIRECTLY AGAINST SOIL ----B - CONCRETE EXPOSED TO WEATHER (#5 OR SMALLER) -------1 1/2
- (#6 OR LARGER) -C - SLABS ----
- AT SURFACES CONTACTING WATER OR SEWAGE D — BEAMS AND COLUMNS (TO MAIN REINFORCEMENT) -(TO COLUMN TIES OR STIRRUPS) ——— 1 1/2°
- WALLS LESS THAN 12" (#5 OR SMALLER) ——— (#6 OR LARGER)-
- SURFACES EXPOSED TO SEAWATER 3" F - FOR SURFACES EXPOSED TO WATER OR SEWAGE OR AREAS EXPOSED TO HIGH HUMIDITY IN BEAMS, COLUMNS, WALLS
- 2 SPLICES SHALL BE CLASS "B" CONFORMING TO THE PROVISIONS OF ACI 318 UNLESS NOTED OTHERWISE.

AND SLABS ADD 1/2" TO ABOVE.

- 3 ALL EMBEDDED ITEMS SHALL BE INSTALLED AND SECURED IN PLACE BEFORE CONCRETE PLACEMENT. CONSULT ELECTRICAL, MECHANICAL AND HVAC DRAWINGS FOR PIPING, EMBEDDED ITEMS AND OPENINGS.
- 4 ALL JOINTS IN WATER BEARING STRUCTURES SHALL HAVE A WATERSTOP. ALL JOINTS BELOW GRADE IN WALLS OR SLABS WHICH ENCLOSE AN ACCESSIBLE AREA SHALL HAVE WATERSTOPS
- 5 CONSTRUCTION JOINTS NOT SHOWN SHALL BE SUBMITTED BY THE CONTRACTOR FOR THE APPROVAL OF THE ENGINEER PRIOR TO SUBMITTING REBAR SHOP DRAWINGS.
- 6 PROVIDE VERTICAL CONSTRUCTION JOINTS IN WALLS AND HORIZONTAL JOINTS IN SLABS NOT GREATER THAN 45'-0" ON CENTER.
- 7 NO BACKFILL SHALL BE PLACED AGAINST ANY SUBSTRUCTURE WALLS UNLESS ADJACENT FLOOR SLABS HAVE TAKEN THEIR FINAL SET, OR WALLS HAVE BEEN PROPERLY BRACED, AND IN ANY CASE NOT SOONER THAN 28 DAYS AFTER THE PLACING OF CONCRETE UNLESS APPROVED BY THE ENGINEER.

0331000

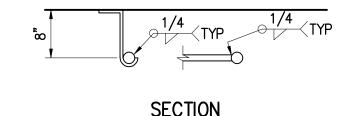

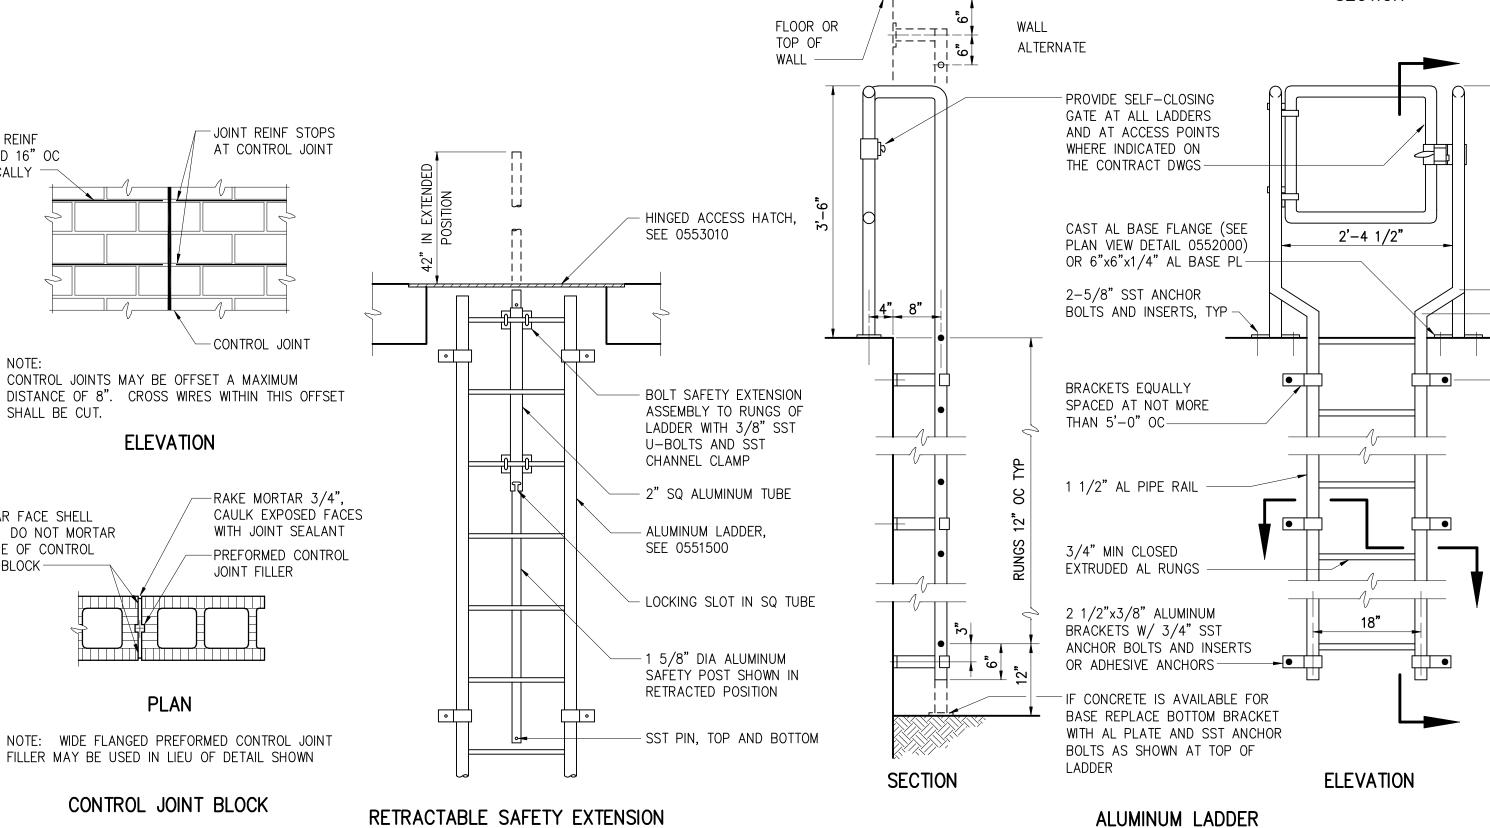



Hazen HAZEN AND SAWYER

4944 PARKWAY PLAZA BLVD, SUITE 375

CHARLOTTE, NORTH CAROLINA 28217

LICENSE NO.: C-0381

HORIZ REINF

VERTICALLY

SPACED 16" OC

SHALL BE CUT.

MORTAR FACE SHELL

TONGUE OF CONTROL

JOINT BLOCK -

ONLY. DO NOT MORTAR

DAVIDSON COUNTY NORTH CAROLINA

0551503

DAVIDSON WATER INC. HYATTOWN PUMP STATION IMPROVEMENTS


**MICELLANEOUS** STANDARD DETAILS


0551500


MARCH 2016 30961-010 HAZEN NO.: CONTRACT NO.: DRAWING **NUMBER:** D4


**ENGINEER: DESIGNED BY:** DRAWN BY: CHECKED BY: CONSTRUCTION 3-8-16 BUILDING PERMIT REVIEW | 2-26-16 | JCJ IF THIS BAR DOES NOT MEASURE 1" THEN DRAWING
IS NOT TO FILL SCALE REGULATORY REVIEW 1-20-16 JCJ IS NOT TO FULL SCALE **ISSUED FOR** 

ISSUED FOR CONSTRUCTION

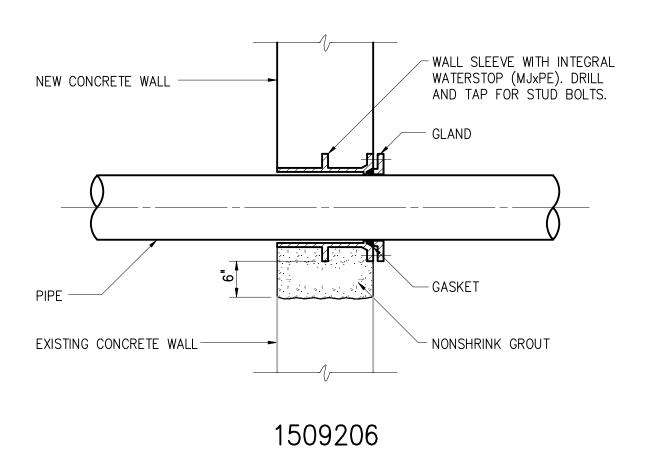

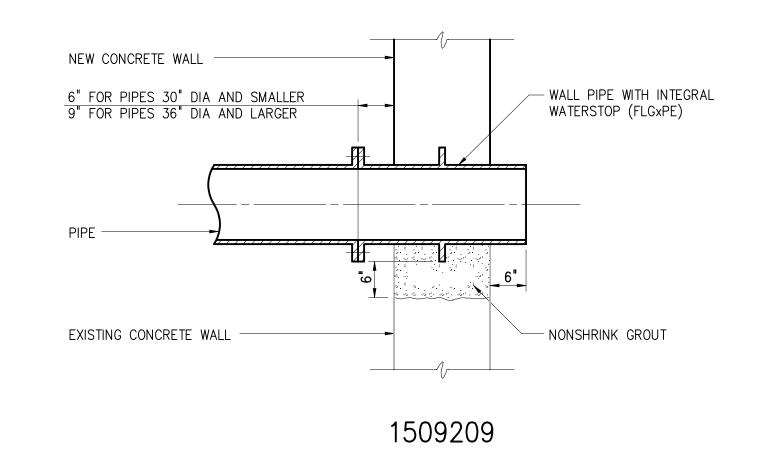


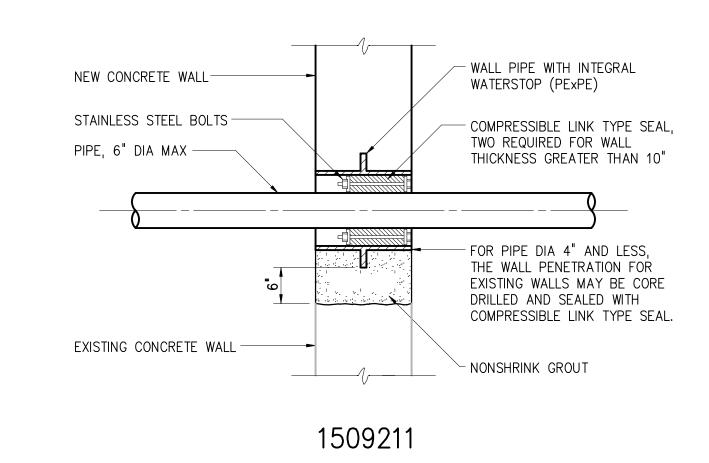

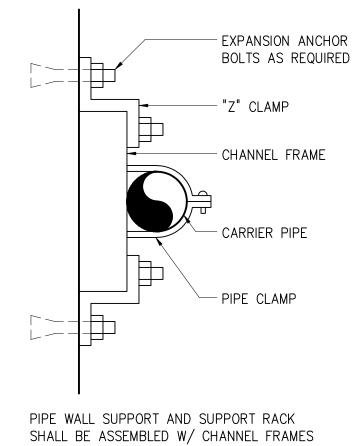

AND ACCESSORIES AS MANUFACTURED BY UNISTRUT CORP OR EQUAL

PIPE WALL SUPPORT 1509402

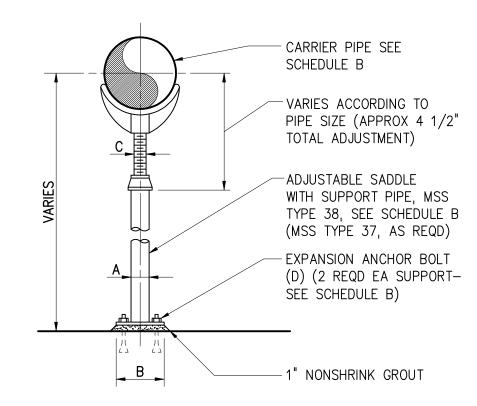

SCHEDULE A					ADJUSTABLE SADDLE
BASE ELBOW (TEE) (DIM IN INCHES)				S)	1509405
IZE	A	В	С	D	

				DIA x LG		
3	1 1/2	5	4 7/8	1/2 x 5		
4	2	6	5 1/2	5/8 x 5		
5-6	2 1/2	7	VARIES	5/8 x 5		
8–10	4	9	VARIES	5/8 x 5		
12-16	6	11	VARIES	3/4 x 6		
18-24	8	13 1/2	VARIES	3/4 x 6		
30	10	16	23	7/8 x 7		
36	12	19	26	7/8 x 7		
SCHEDULE B						
ADJ	USTABLE S	SADDLE (DI	M IN INCH	ES)		
PIPE SIZE	Α	В	С	D DIA x LG		
3	2 1/2	7	1 1/2	5/8 x 5		
4–12	3	7 1/2	2 1/2	5/8 x 5		
14–16	4	9	3	5/8 x 5		
18-20	6	11	3 1/2	3/4 x 6		

PIPE SIZE

24-48

SCHEDULE C									
SUPPORT RODS AND BRACKET SPACING (FOR STANDARD WEIGHT PIPE)									
PIPE SIZE BACK PLATE ROD Ø (INCHES)  MINIMUM ROD Ø (INCHES)							TE 8)		
(INCHES)	(INCHES)	PROCESS PIPING	STEEL AIR PIPING	COPPER	PLASTIC	STEEL	DIP (SEE NOTE 7)		
UP TO 1	SEE NOTE 4	3/8	3/8	5	5	6	_		
1 1/4-2	II	3/8	3/8	8	5	10	_		
2 1/2-3 1/2	II	3/8	3/8	8	5	12	6		
4-5	II	1/2	3/8	_	5	14	8		
6	11	5/8	3/8	_	5	15	9		
8–12	II	3/4	1/2	_	5	15	9		
14–16	II	7/8	1/2	_	5	15	9		
18	II	1	1/2	_	5	18	10		
20-24	II	1 1/4	5/8	_	5	18	10		

1509412

- SCHEDULE 80 PVC, MINIMUM (5' MAXIMUM SPACING ON SUPPORTS) - 1" BALL VALVE BUSHING AS REQUIRED - 2 PIPE SUPPORTS - 3/4" SST -3/4" GLOBE VALVE - 3/4" STD HOSE THREAD - 3/4" HOSE VACUUM BREAKER CONNECTION HOSE BIBB 1511500

FLOOR DRAIN WITH
SEDIMENT BUCKET
AND ADJUSTABLE TOP FINISH FLOOR—FORM 2'-0"ø DISH WHERE REQUIRED -45° WYE AND 45° BEND FOR VENT LINE IF REQD - "P" TRAP NOTE: INTERIOR FLOOR DRAIN AND CLEANOUTS TO HAVE NICKEL BRONZE TOPS. EXTERIOR FLOOR DRAINS AND CLEANOUTS TO HAVE LACQUERED CAST IRON TOPS.


> FLOOR DRAIN 1542102

1	50940	D1		
			DDO1ECT	

 $3/4 \times 6$ 

2						
BY: MKARM					PROJECT I ENGINEER:	M.J. BENCHICH
AM					DESIGNED BY:	HAZEN
10: 38: 56					DRAWN BY:	HAZEN
/03/09	3	CONSTRUCTION	3-8-16	JCJ	CHECKED BY:	HAZEN
2016,	2	BUILDING PERMIT REVIEW	2-26-16	JCJ	IF THIS BAR DOES NOT	0 1/2" 1"
DATE:	1	REGULATORY REVIEW	1-20-16	JCJ	MEASURE 1" THEN DRAWING	
T D/	RE\/	ISSUED FOR	DATE	RV	BY IS NOT TO FULL SCALE	

ISSUED FOR CONSTRUCTION

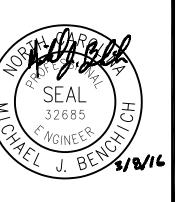

Hazen HAZEN AND SAWYER 4944 PARKWAY PLAZA BLVD, SUITE 375


CHARLOTTE, NORTH CAROLINA 28217 LICENSE NO. : C-0381


DAVIDSON COUNTY NORTH CAROLINA


DAVIDSON WATER INC. HYATTOWN PUMP STATION IMPROVEMENTS

MISCELLANEOUS STANDARD DETAILS

DATE:	MARCH 2016
HAZEN NO.:	30961-010
CONTRACT N	0.: 1
DRAWING NUMBER:	
	D5

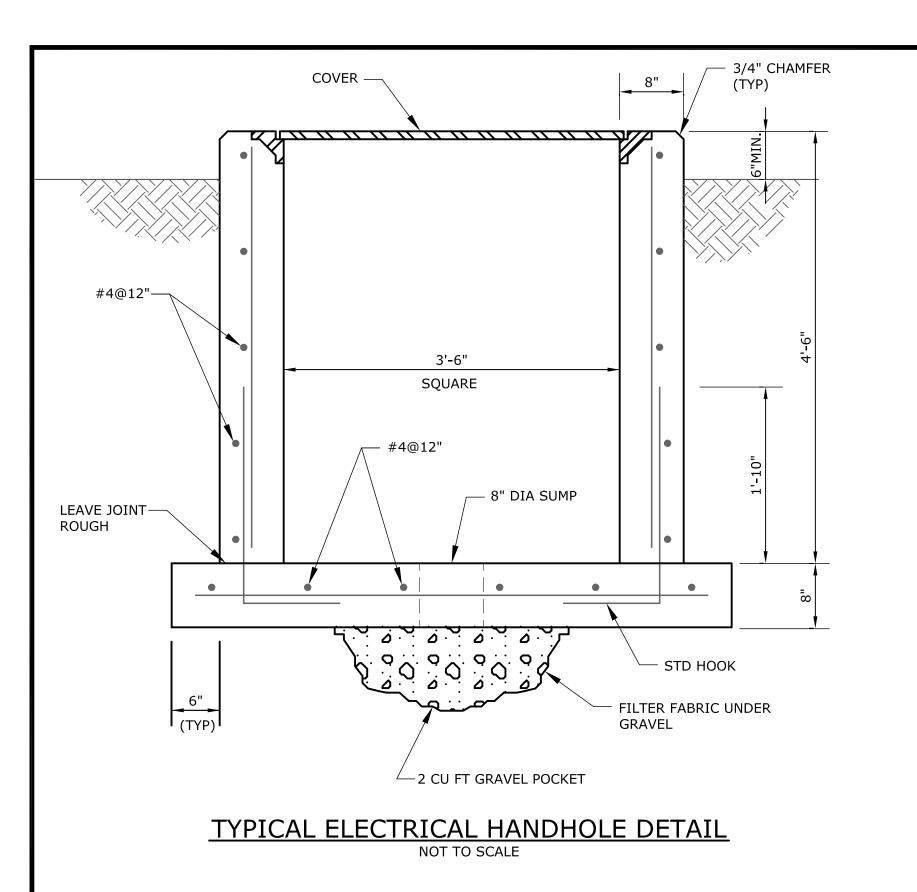


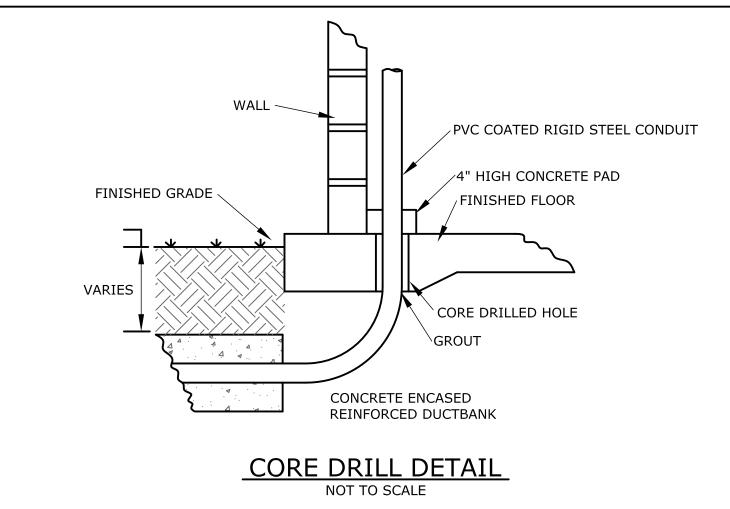


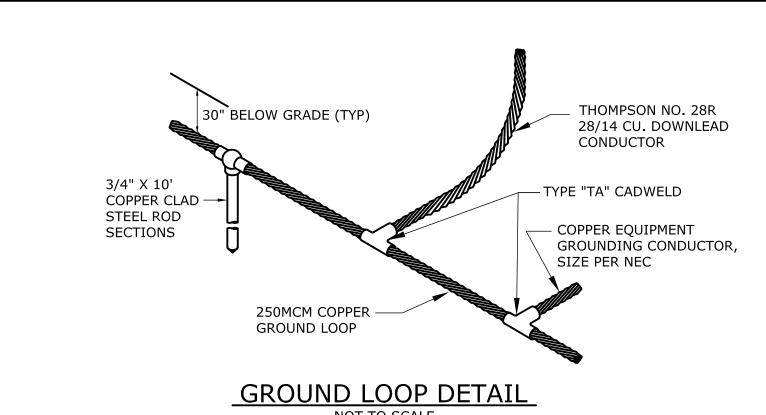


	1401 10 30/122					
				PROJECT ENGINEER:	R. W. STURGILL	
				DESIGNED BY:	R. W. STURGILL	
				DRAWN BY:	R. W. LAWSON	
3	CONCTRUCTION	2.0.16	DWC	CHECKED BY:	-	
3	CONSTRUCTION	3-8-16	RWS			
2	BUILDING PERMIT REVIEW	2-26-16	RWS			
1	REGULATORY REVIEW	1-20-16	RWS	MEASURE 1" THEN DRA	WING 0 1/2" 1"	
REV	ISSUED FOR	DATE	BY	IS NOT TO FULL SCALE		

ISSUED FOR CONSTRUCTION

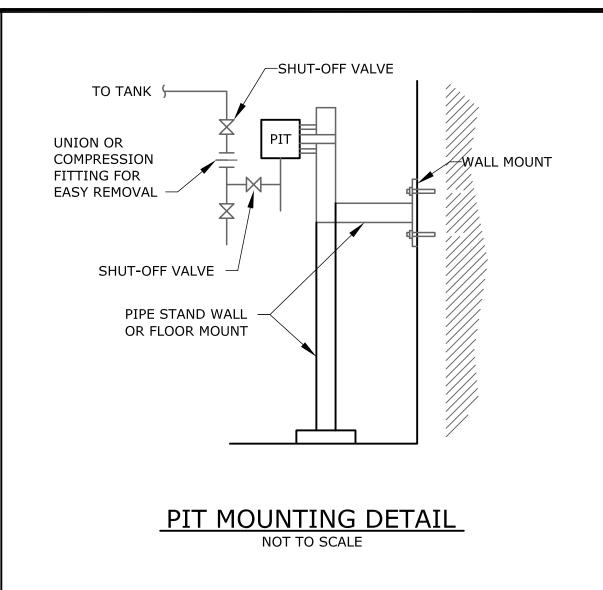

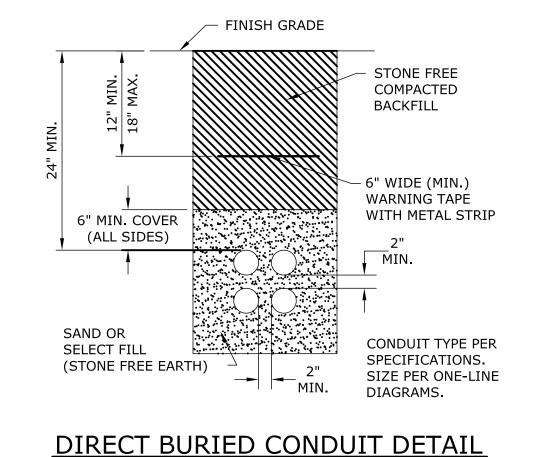

NOT TO SCALE

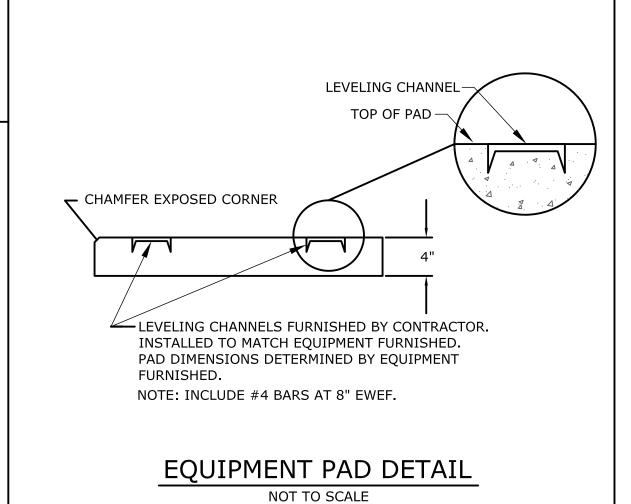



TRANSFORMER PAD NOTES: 1. COORDINATE DIMENSIONS AND REQUIREMENTS WITH DUKE ENEGERY


PRIOR TO INSTALLATION. 2. 1" CONDUIT FOR METERING, AND 2 x 4" GALVANIZED METER MOUNTING

3. REINFORCEMENT PER CITY OF HIGH POINT SPECIFICATIONS.

4. TOP EDGES TO BE BEVELED 1/4". PAD TO BE SLOPED 1/4" FROM BACK TO FRONT, AND RIGHT TO LEFT. 5. PAD TO BE A MINIMUM THICKNESS OF 8", 6" ABOVE GRADE ON HIGHEST

SIDE, AND A MINIMUM OF 2" BELOW GRADE AT ALL POINTS. 6. MINIMUM OF 10' CLEAR, LEVEL AREA MUST BE MAINTAINED IN FRONT OF PAD FOR HOTSTICK OPERATION.

7. COORDINATE EXACT PAD REQUIREMENTS WITH THE CITY OF HIGH POINT ELECTRICAL DEPARTMENT PRIOR TO INSTALLATION.

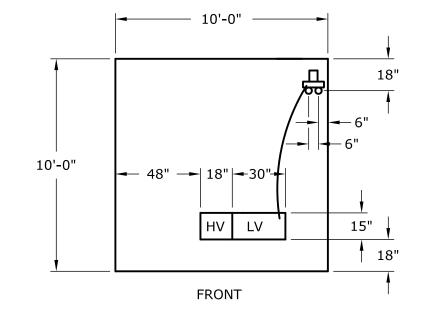


TRANSFORMER PAD OUTSIDE DIMENSIONS:

1. SEE PIT DETAIL BELOW FOR HIGH VOLTAGE (HV) AND LOW VOLTAGE (LV)

2. VERIFY LAYOUT AT SITE WITH DUKE ENGINEER AND OWNER. 3. 10' AREA IN FRONT OF TRANSFORMER

MUST NOT BE OBSTRUCTED. 4. 5' AREA AROUND TRANSFORMER MUST


NOT BE OBSTRUCTED (COOLING).

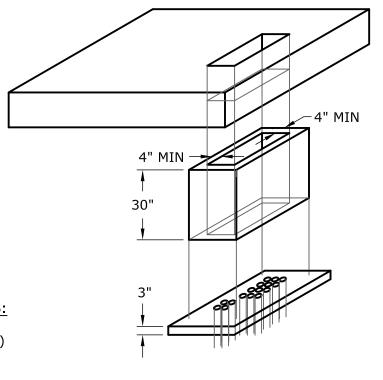

PIT DETAIL NOT TO SCALE

## TRANSFORMER PAD DETAIL

NOT TO SCALE

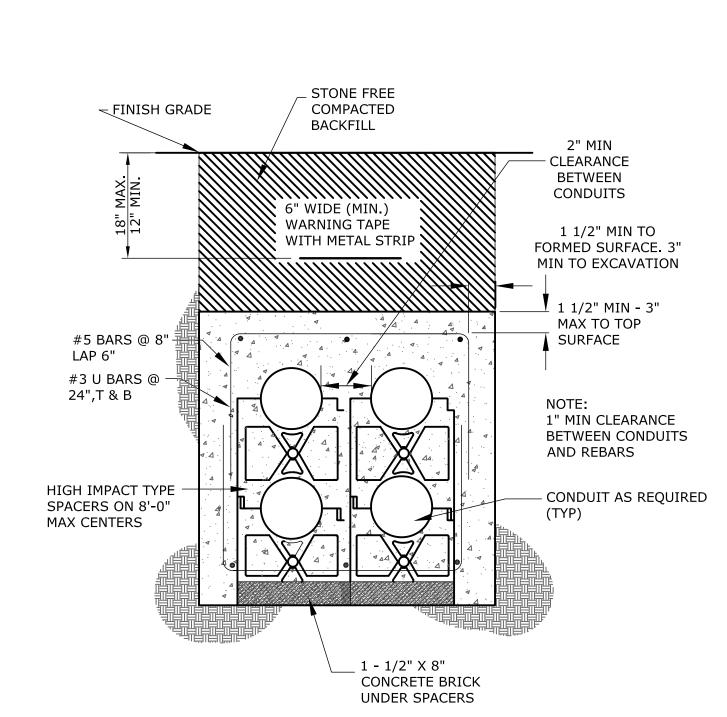

TYP CONCRETE ENCASED CONDUIT SECTION NOT TO SCALE

AS REQUIRED TO FIT EQUIPMENT FURNISHED AS REQUIRED TO F EQUIPMENT FURNIS CONTROL PANEL - 2" GALVANIZED RIGID STEEL POST ALL MOUNTING HARDWARE SHALL BE HOT DIPPED CONDUITS GALVANIZED STEEL AS REQUIRED FINISHED GRADE CONCRETE

TYPICAL PANEL MOUNTING ON POST DETAIL

DAVIDSON COUNTY NORTH CAROLINA

DAVIDSON WATER INC. HYATTOWN PUMP STATION IMPROVEMENTS

**ELECTRICAL** MISCELLANEOUS DETAILS

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D6