


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No.	Description	Date	STAMP:	ADDRESS:	
			ATEO R.G.		PROJECT NO:
			ELECTER T	E ngineered \clubsuit	DESIGNED BY:
			+ (No. PE-28455 +)	SYSTEMS & 2950 Horizon Park Drive Suite B	DRAWN BY:
			2 11 22 19 3	Services	CHECKED BY:
			SEN & DERAMA		DATE : 1
			0.10		SCALE:

		SCALE : 1/4" = 1'-0"	
		CITY OF ATLANTA DEPT. OF WATERSHED MANAGEMENT	DRAWING NO.
	TASK 1	WATER SUPPLY PROGRAM	
:	SP		RI-PS
	NM	RIVER INTAKE PUMP STATION	
	SP	ELECTRICAL ROOM	M1-101
	11-22-2019		
	AS NOTED	HVAC PLAN	SHEET OF
		ISSUED	FOR BIDDING

48" 24" 0'

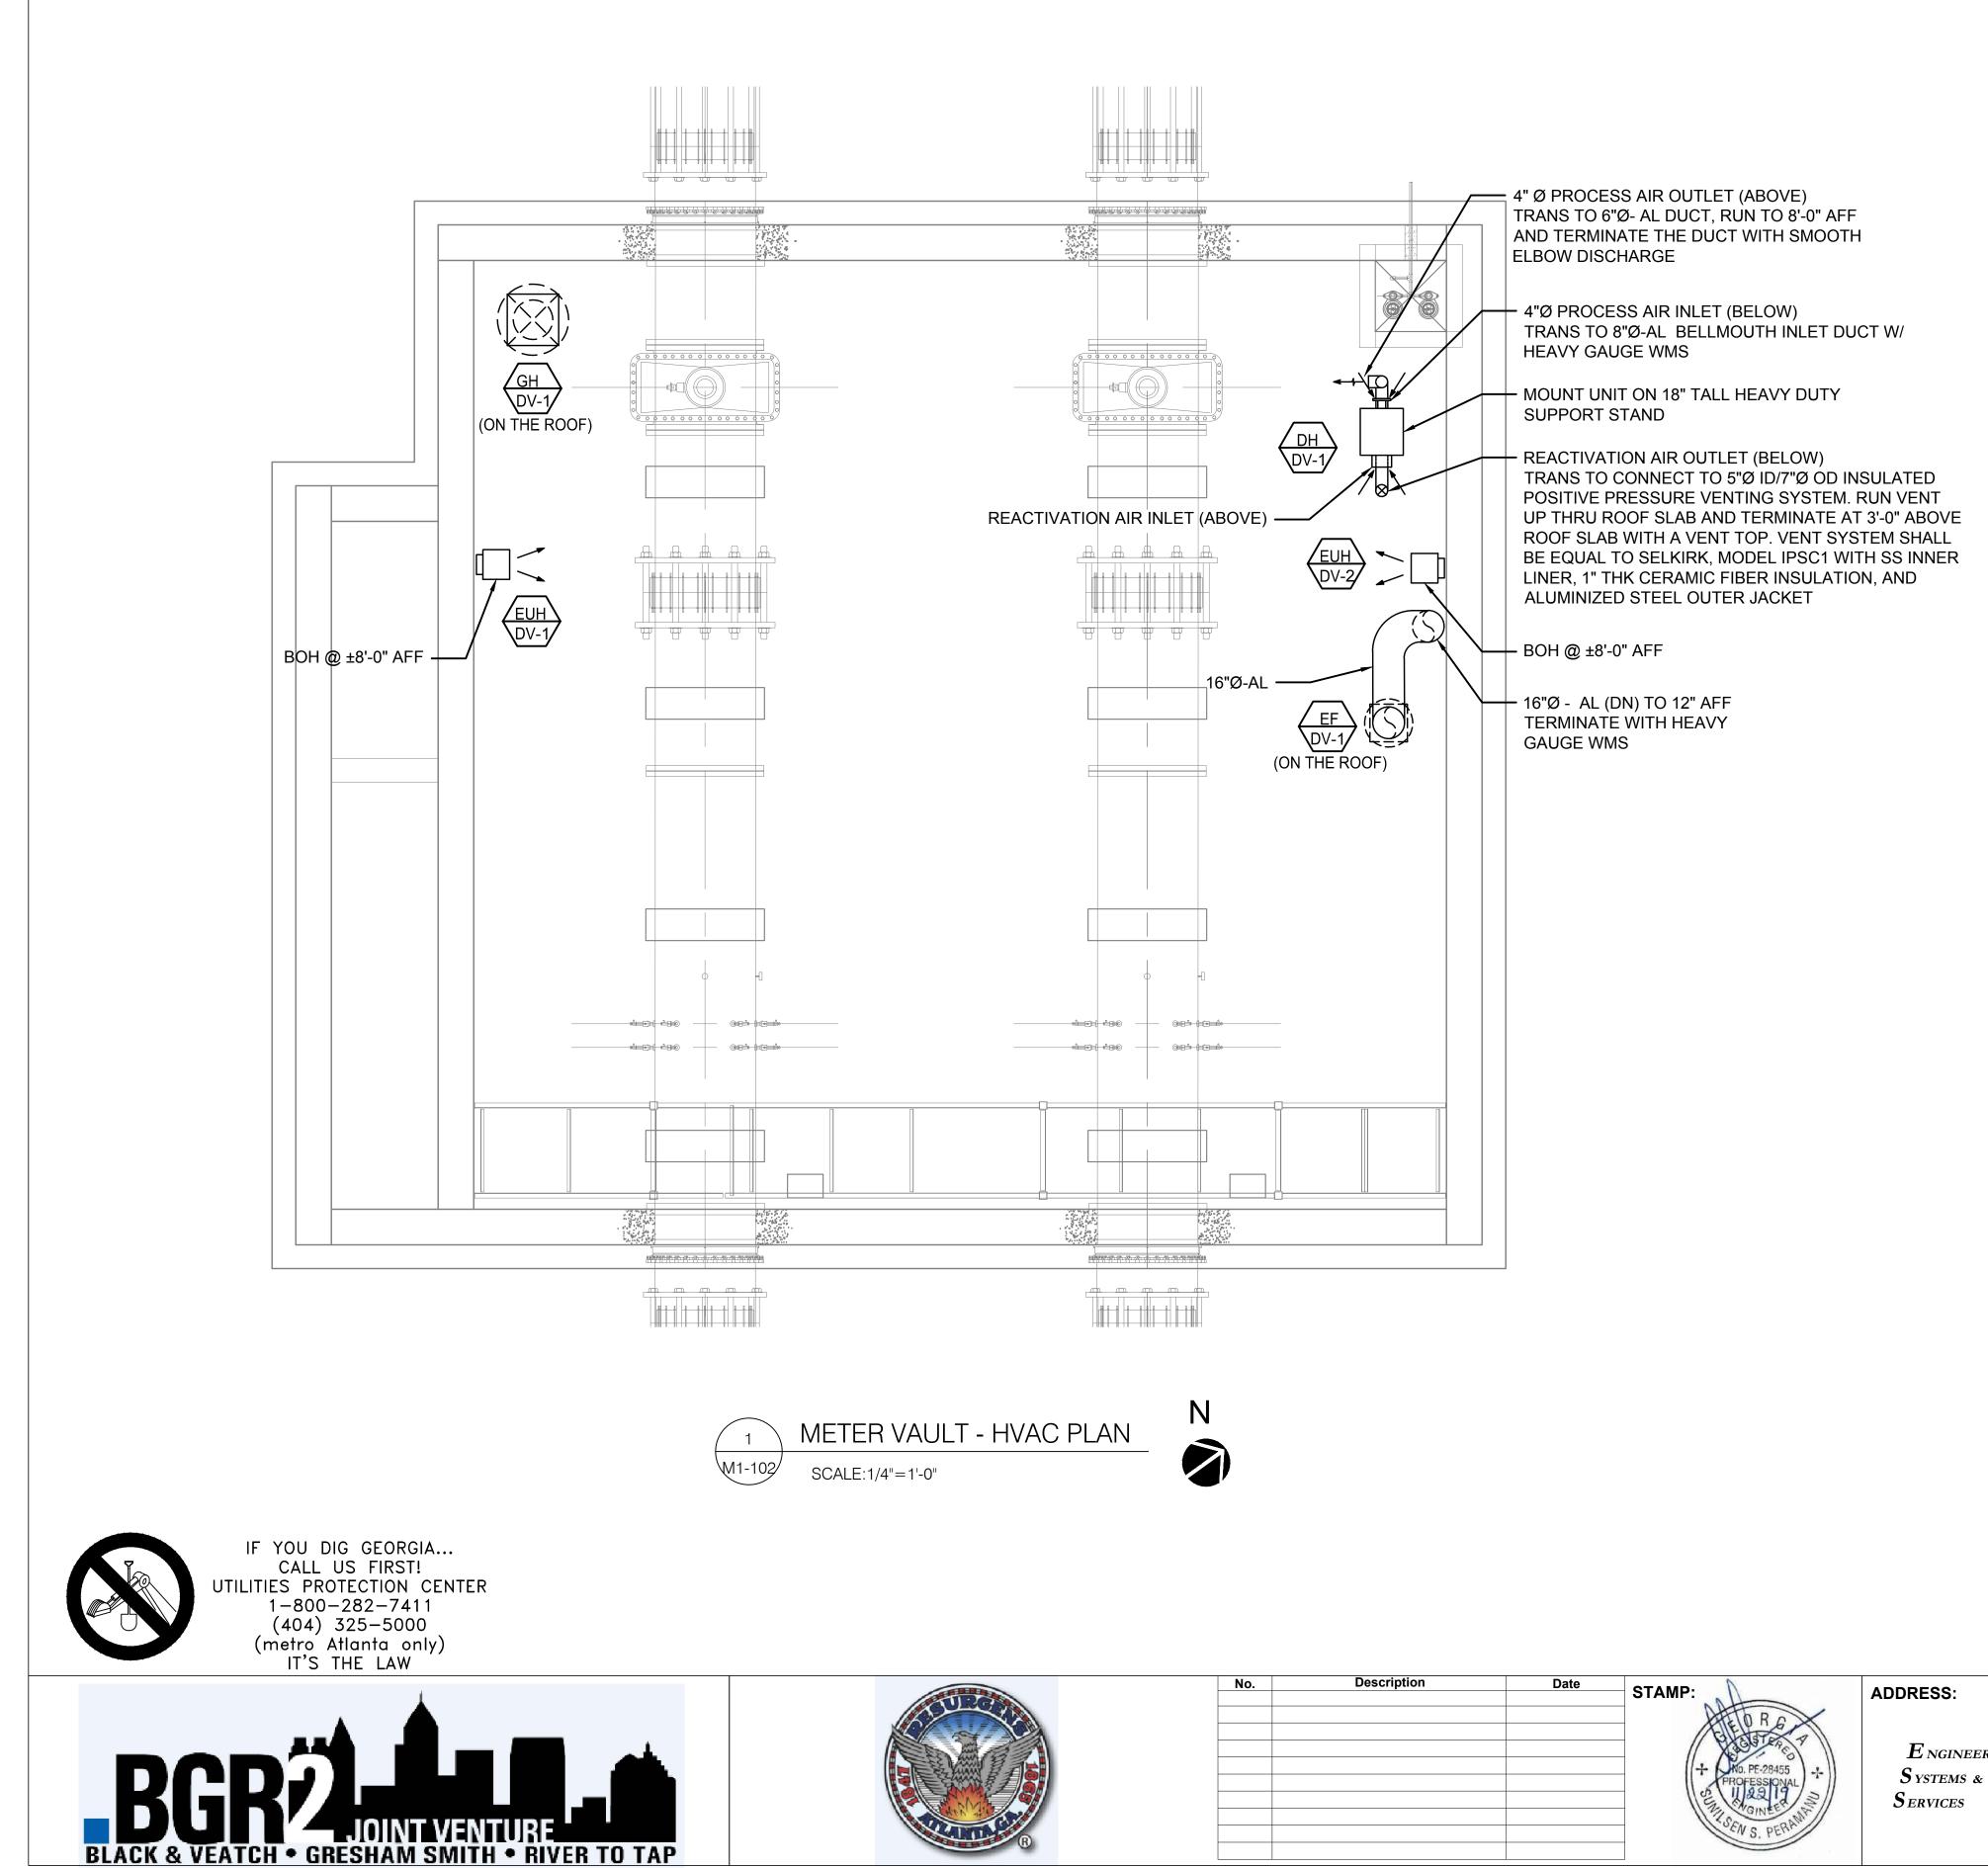

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No.	Description Date	STAMP:	ADDRESS:	
		ATEO R.G.		PROJECT NO:
		A STATES T	$E_{ngineered}$	DESIGNED BY:
		+ NO. PE-28455	S YSTEMS & 2950 Horizon Park Drive Suite B	DRAWN BY:
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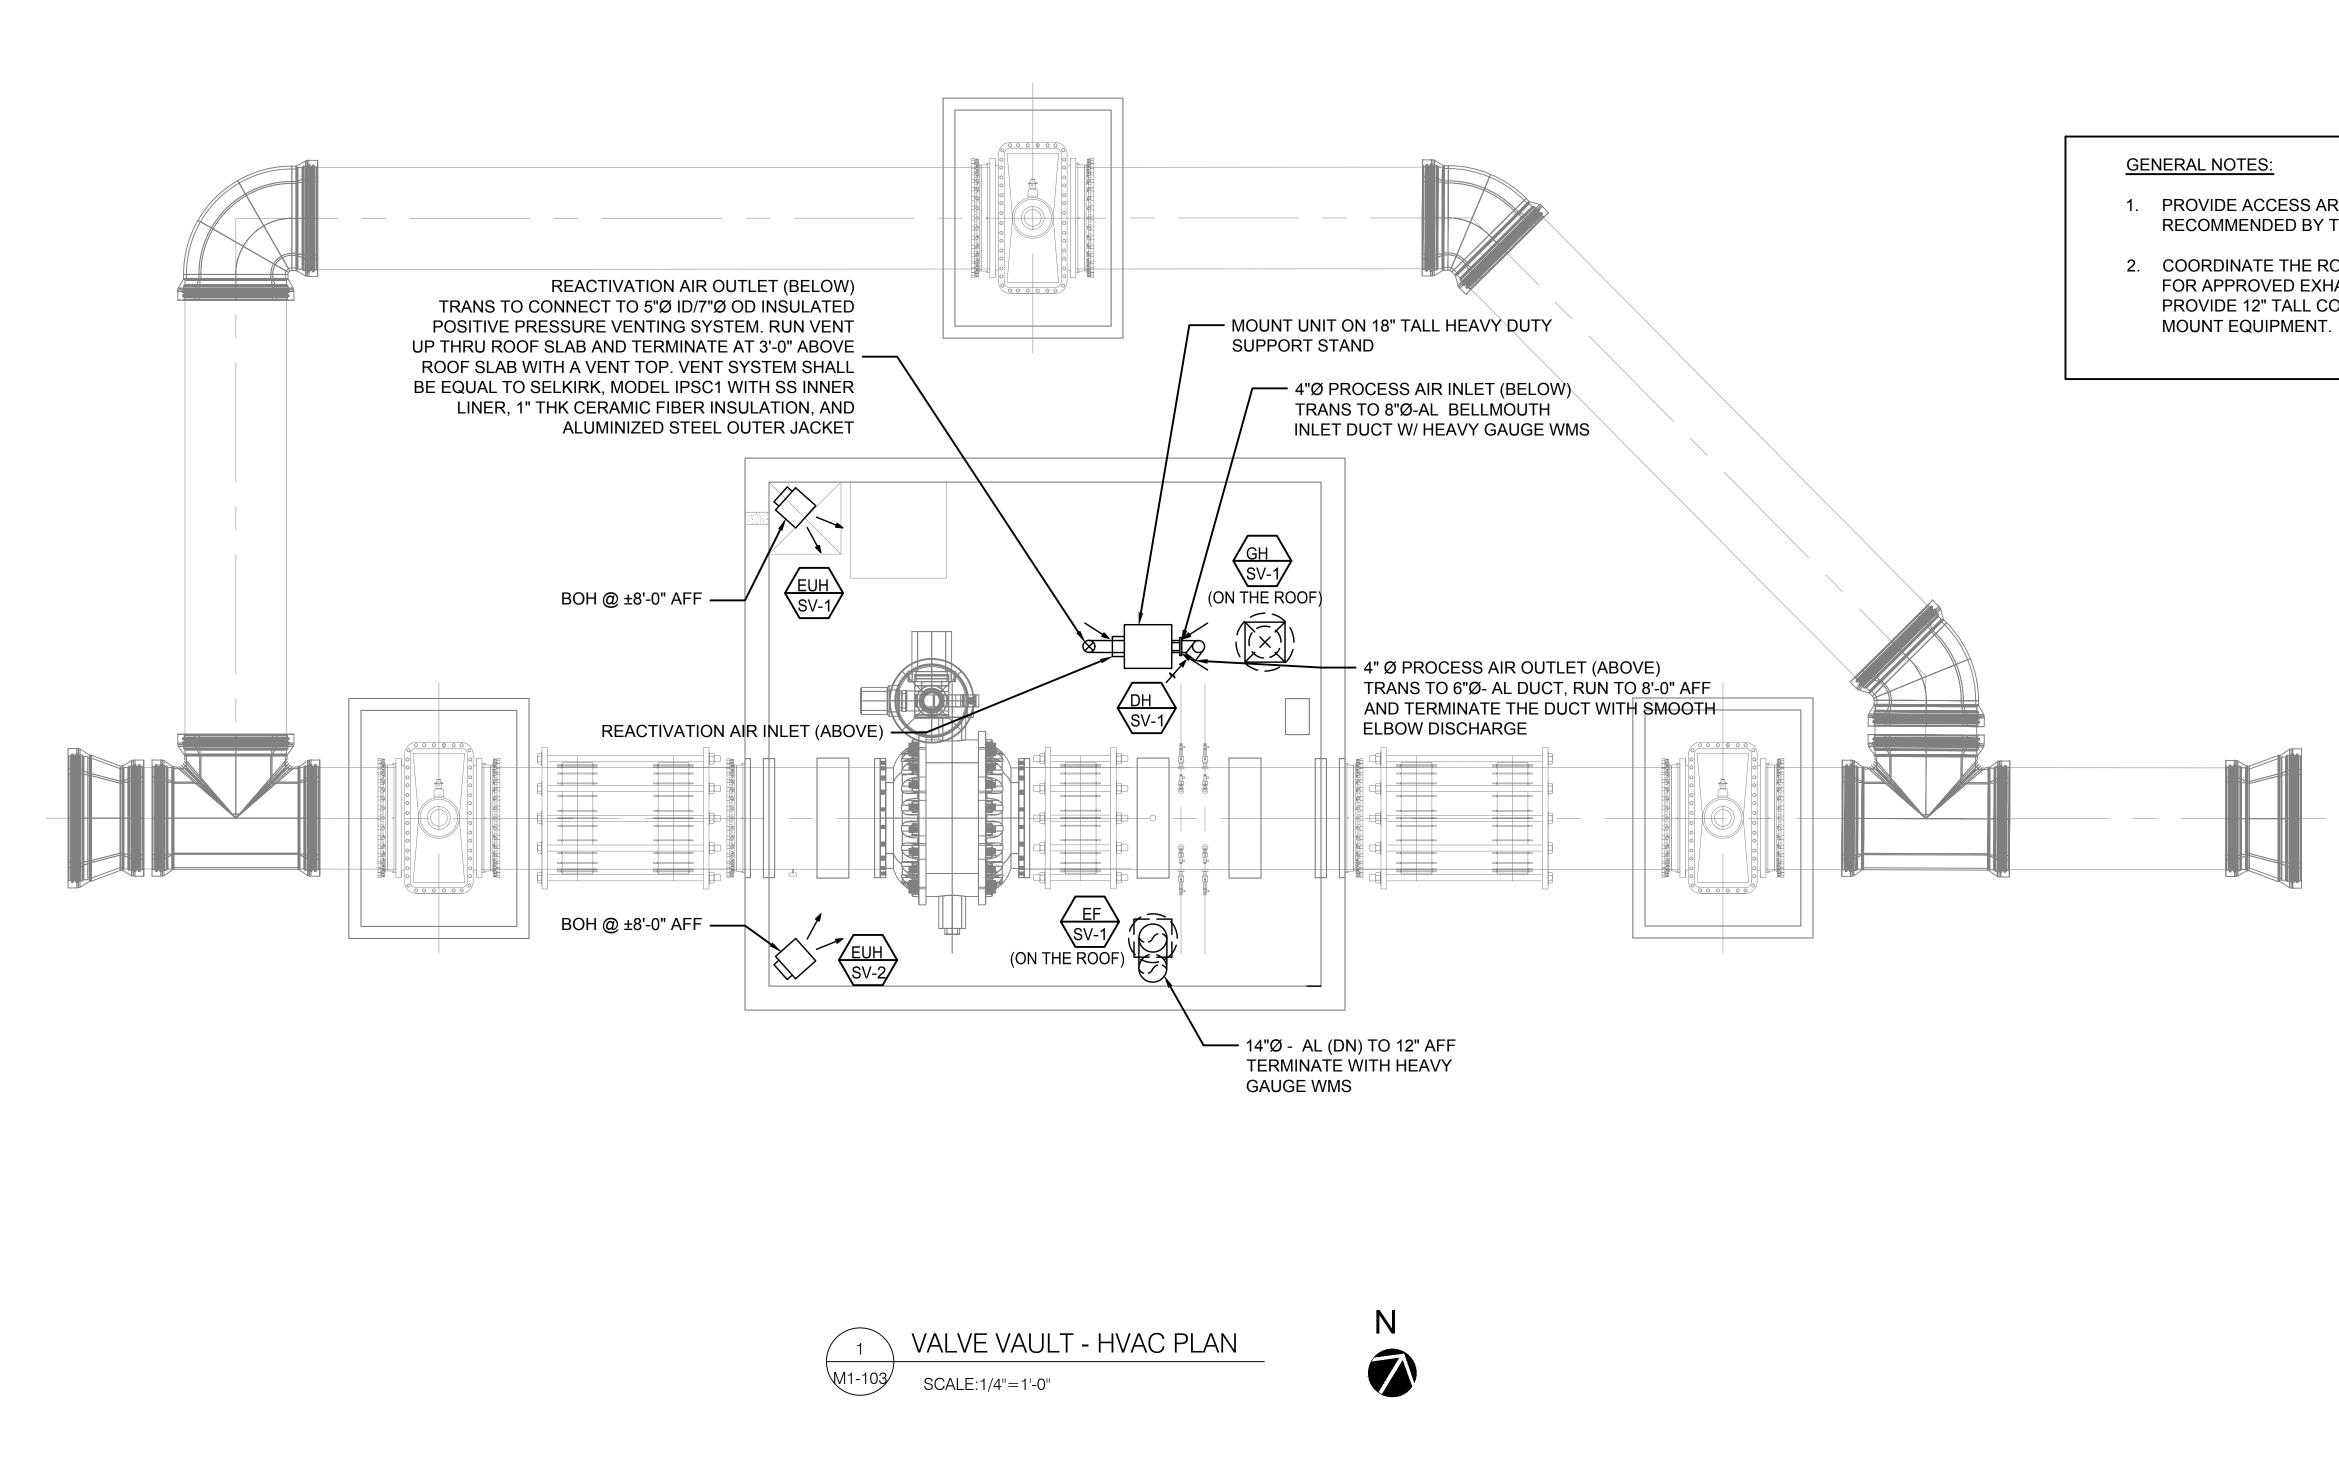
GENERAL NOTES:

1. PROVIDE ACCESS AROUND THE DEHUMIDIFIER UNIT AS RECOMMENDED BY THE MANUFACTURER.

2. COORDINATE THE ROOF SLAB OPENING SIZES WITH STRUCTURAL FOR APPROVED EXHAUST FAN AND GRAVITY INTAKE AIR HOOD. PROVIDE 12" TALL CONCRETE CURB FOR THESE OPENINGS TO MOUNT EQUIPMENT.

	SCALE : 1/4" = 1'-0"	
	CITY OF ATLANTA DEPT. OF WATERSHED MANAGEMENT	DRAWING NO.
TASK 1	WATER SUPPLY PROGRAM	
SP		RI-PS
NM	RIVER INTAKE PUMP STATION	
SP	METER VAULT	M1-102
11-22-2019		
AS NOTED	HVAC PLAN	SHEET OF
	ISSUED	FOR BIDDING

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	DRESS:	STAMP:	Date	Description	No.
PROJECT NO:		ATEO R.G.			
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SCALE:		0.1			

1. PROVIDE ACCESS AROUND THE DEHUMIDIFIER UNIT AS RECOMMENDED BY THE MANUFACTURER.

2. COORDINATE THE ROOF SLAB OPENING SIZES WITH STRUCTURAL FOR APPROVED EXHAUST FAN AND GRAVITY INTAKE AIR HOODS. PROVIDE 12" TALL CONCRETE CURB FOR THESE OPENINGS TO





	SCALE : 1/4" = 1'-0"	
	CITY OF ATLANTA DEPT. OF WATERSHED MANAGEMENT	DRAWING NO.
TASK 1	WATER SUPPLY PROGRAM	
SP		RI-PS
NM	RIVER INTAKE PUMP STATION	
SP	VALVE VAULT	M1-103
11-22-2019		1011-105
AS NOTED	HVAC PLAN	SHEET OF
·	ISSUED	FOR BIDDING

48" 24" 0'

48"

96"

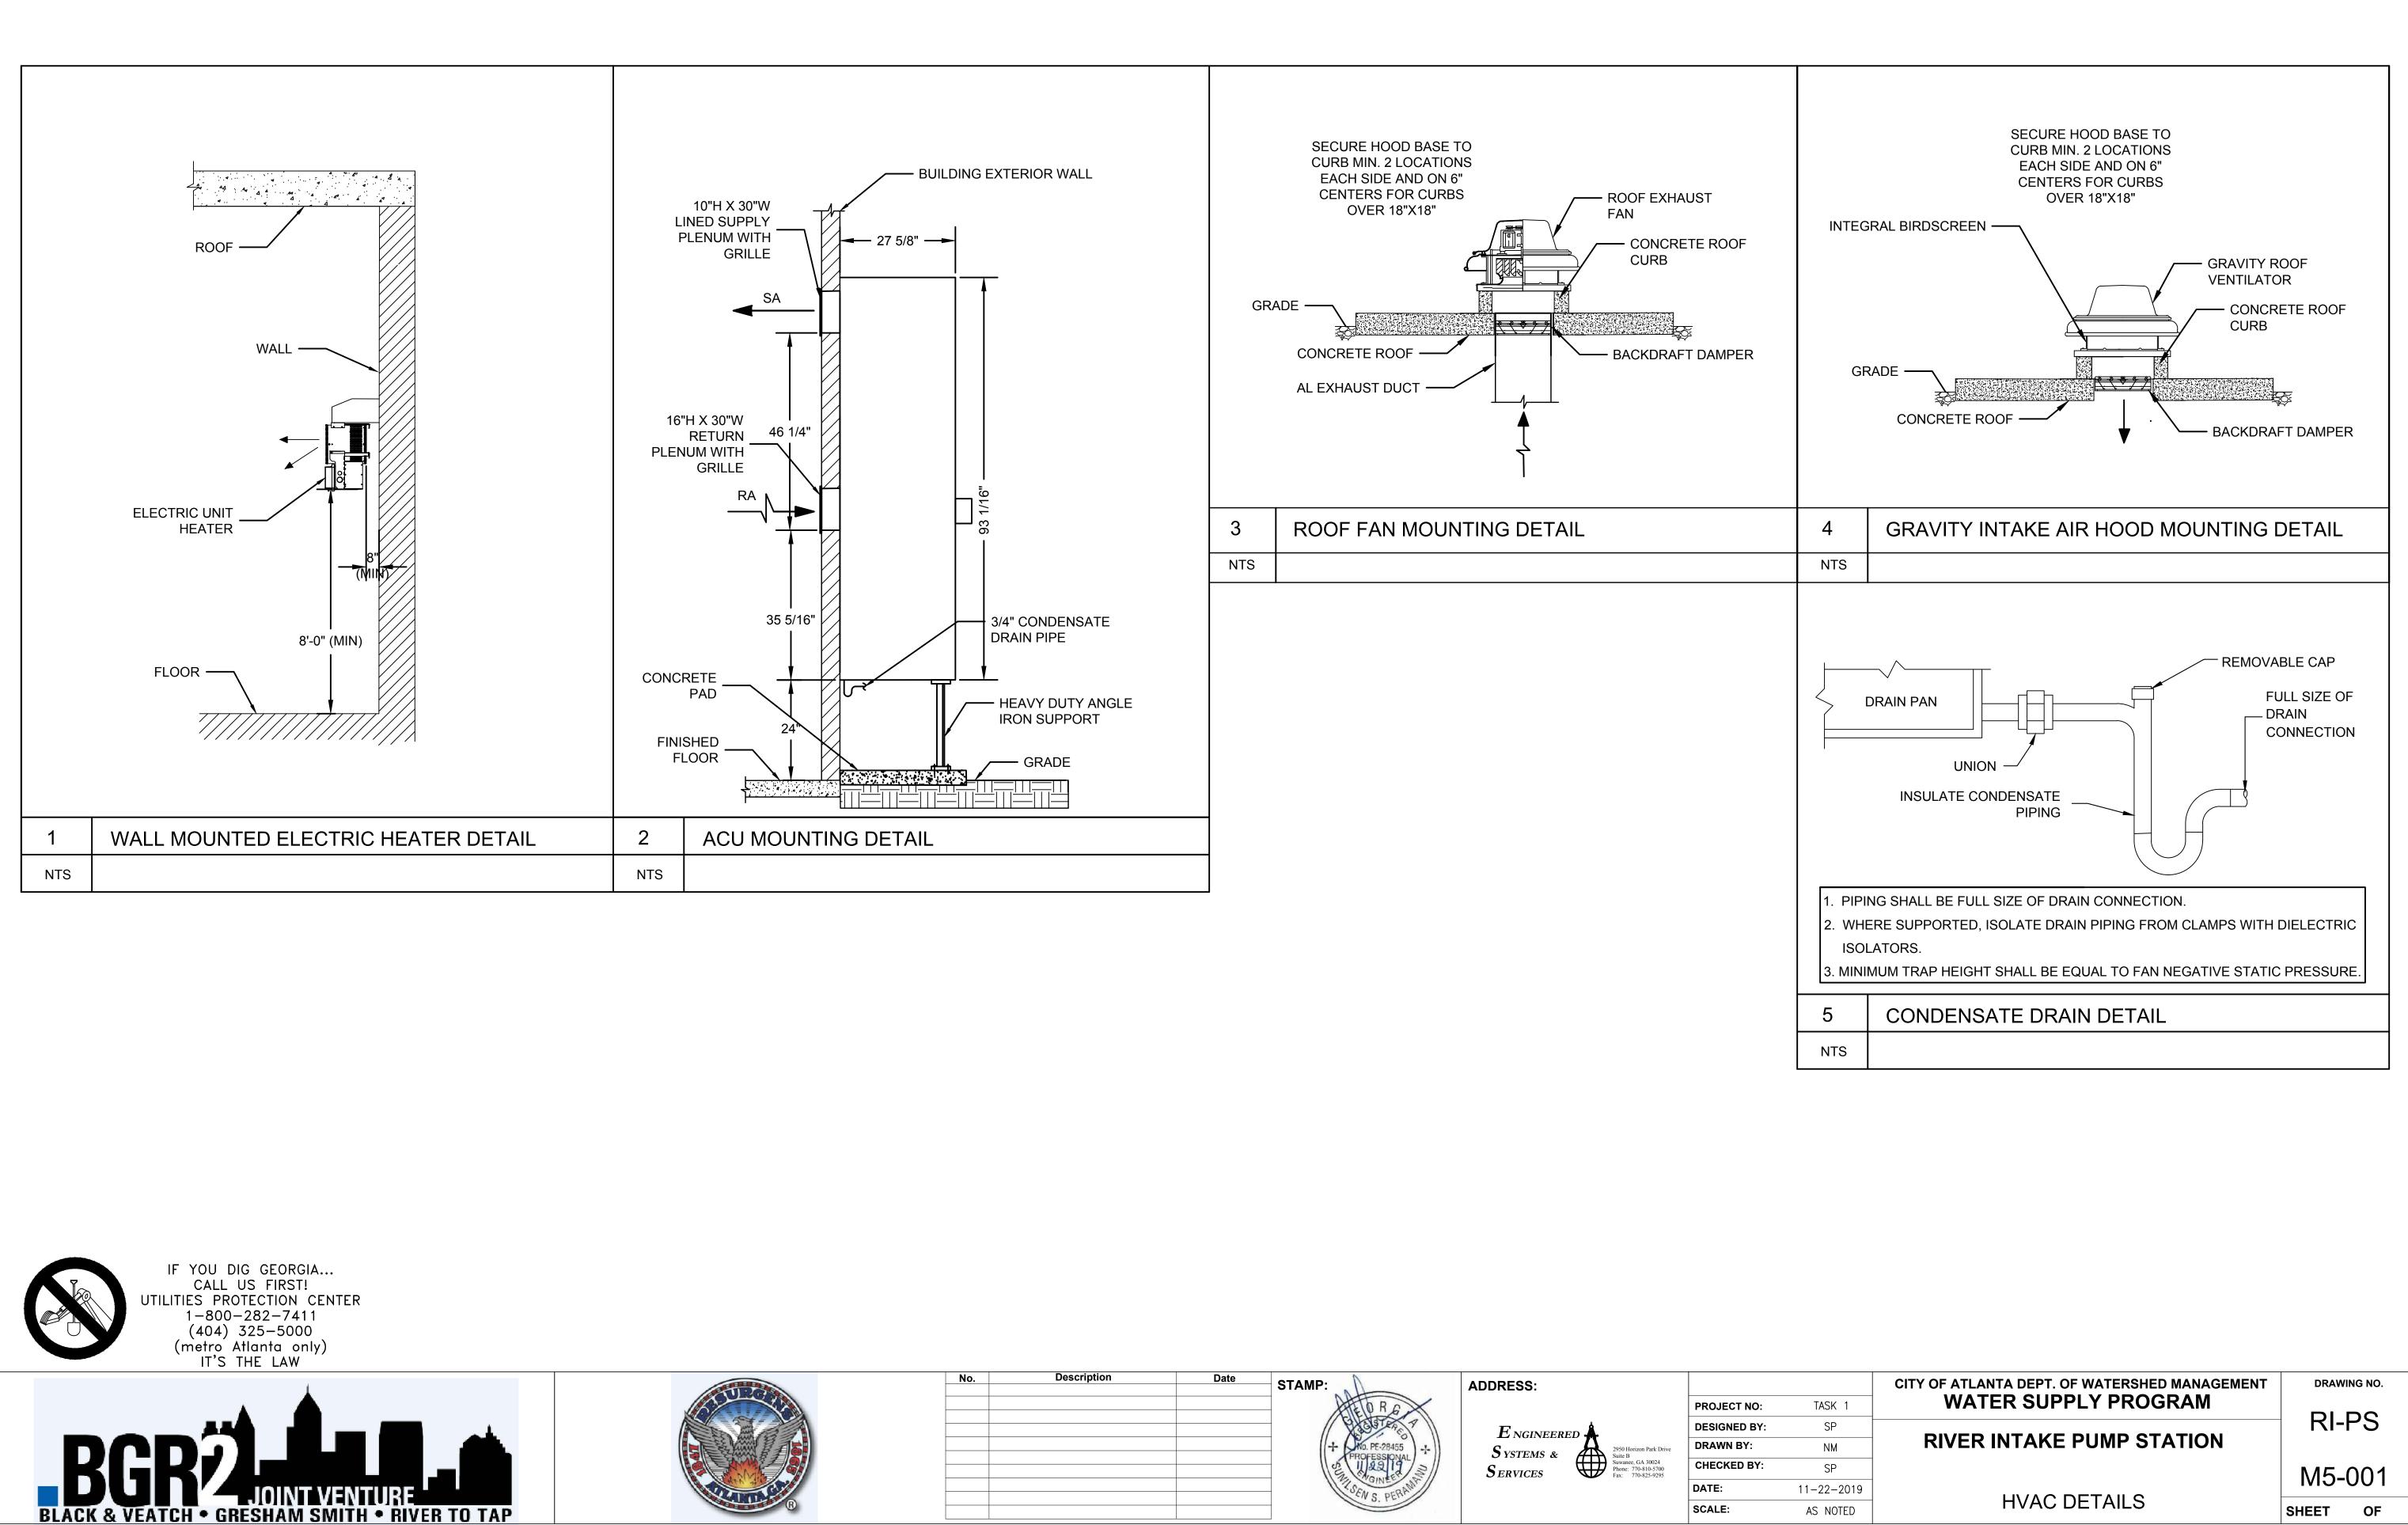

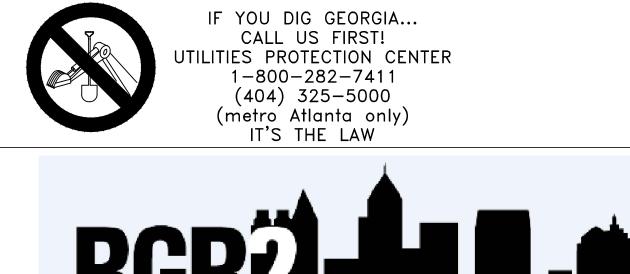



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Description	Date		ADDRESS:	
		HED R.G.		PROJECT NO
		A STRACT	E NGINEERED	DESIGNED B
		+ NO. PE-28455		DRAWN BY:
		(E) U22 19 2	Suwanee, GA 30024	CHECKED BY
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				SCALE:
	Description	Description Date	STAMP:	ADDRESS: ADDRESS: ADDRESS: ADDRESS: Systems & Systems & Syst

GENERAL NOTES

- 1. THESE CONTRACT DRAWINGS ARE SCHEMATIC IN NATURE AND ARE NOT INTENDED TO SHOW ALL POSSIBLE CONDITIONS. IT IS INTENDED THAT A COMPLETE HVAC SYSTEM BE PROVIDED WITH ALL NECESSARY EQUIPMENT, APPURTENANCES, AND CONTROLS, COMPLETELY COORDINATED WITH ALL DISCIPLINES. ALL PARAMETERS GIVEN IN THESE DOCUMENTS SHALL BE STRICTLY CONFORMED WITH ALL ITEMS AND LABOR REQUIRED FOR A COMPLETE HVAC SYSTEM IN ACCORDANCE WITH ALL APPLICABLE STANDARDS AND LATEST STATE AND LOCAL CODES AND THIS PACKAGE OF CONTRACT DOCUMENTS SHALL BE FURNISHED WITHOUT INCURRING ANY ADDITIONAL COST TO THE CONTRACT. CONTRACTOR SHALL CAREFULLY REVIEW ALL CONTRACT DOCUMENTS AND THE DESIGN OF OTHER TRADES BEFORE PREPARING SHOP DRAWINGS, AND COMMENCING ANY WORK.
- 2. COORDINATE DUCTWORK AND PIPING WITH ARCHITECTURAL, PROCESS MECHANICAL, STRUCTURAL, PLUMBING, FIRE PROTECTION AND ELECTRICAL. MAKE OFFSETS AND TRANSITIONS TO COORDINATE WITH OTHER TRADES WITHOUT ADDITIONAL EXPENSE TO THE OWNER.

WALL MOUNTED AIR CONDITIONING UNITS WITH ELECTRIC HEAT

	МАХ				INDOOR FAN	CO0	LING	ELECTRIC HEATING	OUTDOOR	EL	ECTRICAL			MAKE &	MODEL	WEIGHT	
EQUIPMENT	SUPPLY AIR	OA	NOMINAL	ESP	MOTOR	TOTAL	SENSIBLE		FAN MOTOR		MCA	МОР				OF UNIT	
TAG	(CFM)	(CFM)	TONS	(IN. WG)	(HP)	(MBH)	(MBH)	KW	(HP)	VOLT/PH/HZ	(AMPS)	(AMPS)	EER	MFR	MODEL	(LBS)	REMARKS
ACU-1	1,925	100	6.0	0.2	3/4	70.0	48.3	9	1/2	460/3/60	19.4	30	10	MARVAIR	MGA1072A	800	1 THRU 14
ACU-2	1,925	100	6.0	0.2	3/4	70.0	48.3	9	1/2	460/3/60	19.4	30	10	MARVAIR	MGA1072A	800	1 THRU 14

GENERAL NOTES:

1. COOLING CAPACITY BASED ON EAT OF 80F DB/67F WB, AND 95F OA TEMPERATURE

REMARKS:

1. SINGLE POINT POWER CONNECTION

- 2. ECONOMIZER WITH ENTHALPY CONTROLS
- 3. LOW AMBIENT CONTROLS
- 4. SCROLL COMPRESSOR WITH COMPRESSOR SOUND JACKET
- 5. ECM INDOOR FAN MOTOR
- 6. HIGH EFFCIENCY UNIT WITH HEAVY DUTY CONSTRUCTION
- 7. HUMIDITY CONTROL WITH HOT GAS RE-HEAT
- 8. MERV 11 FILTERS. DIRTY FILTER INDICATOR
- 9. SUPPLY AND RETURN GRILLES. TOP SUPPLY AND BOTTOM RETURN AIRFLOW
- **10. PROTECTIVE COATING ON CONDENSER COIL**
- 11. DRY CONTACTS FOR REMOTE ALARMING
- 12. DISCONNECT SWITCH

GENERAL NOTES:

ACCESSORIES:

2. BIRD SCREEN


1. OR EQUAL BY LOREK COOK


1. GRAVITY BACK DRAFT DAMPER

- 13. COMMSTAT3 LEAD/LAG MICROPROCESSOR CONTROLLER WITH CAPABILITY TO RUN BOTH UNITS UPON DEMAND
- 14. COLOR TO BE SELECTED BY THE ARCHITECT DURING SHOP DRAWING REVIEW

GRAVITY INTAKE AIR HOOD SCHEDULE													
EQUIPMENT	NT AIR FLOW			PRESSURE DROP	MAKE & MODEL								
TAG	LOCATION	SERVICE	(CFM)	(IN. WG)	MFR	MODEL	REMARKS						
GH-SV-1	VALVE VAULT	INTAKE	800	0.05	GREENHECK	GRSI - 16	1, 2						
GH-DV-1	METER VAULT	INTAKE	1,100	0.05	GREENHECK	GRSI - 20	1, 2						

EQUIPMENT						MAKE &	MODEL	
TAG	LOCATION	кw	CFM	FAN HP	VOLT/PH/HZ	MFR	MODEL	REMARKS
EUH-SV-1	VALVE VAULT	5	405	1/15	480/3/60	CHROMALOX	HD3D-500	1, 2, 3
EUH-SV-2	VALVE VAULT	5	405	1/15	480/3/60	CHROMALOX	HD3D-500	1, 2, 3
EUH-DV-1	METER VAULT	7.5	590	1/15	480/3/60	CHROMALOX	HD3D-750	1, 2, 3
EUH-DV-2	METER VAULT	7.5	590	1/15	480/3/60	CHROMALOX	HD3D-750	1, 2, 3

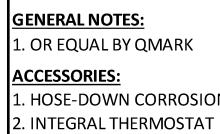

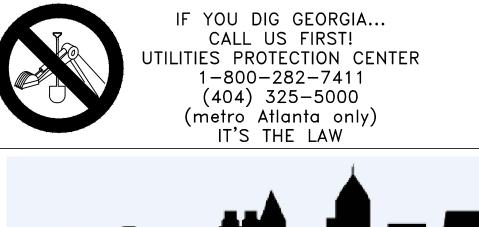



JOINT VENTURE

BLACK & VEATCH • GRESHAM SMITH • RIVER TO TAP

3. MECHANICAL CONTRACTOR SHALL COORDINATE VOLTAGE AND PHASE OF EACH PIECE OF EQUIPMENT WITH THE ELECTRICAL CONTRACTOR AND ALL ELECTRICAL CONTRACT DOCUMENTS PRIOR TO ORDERING.

4. ALL WALL MOUNTED THERMOSTATS SHALL BE INSTALLED 4'-0" ABOVE FINISHED FLOOR UNLESS NOTED OTHERWISE.

5. ALL WORK SHALL BE PERFORMED IN A CLEAN AND WORKMANLIKE MANNER. CARE SHALL BE EXERCISED TO MINIMIZE ANY INCONVENIENCE OR DISTURBANCE TO OTHER AREAS OF THE BUILDING WHICH ARE TO REMAIN IN OPERATION. ISOLATE WORK AREAS BY MEANS OF TEMPORARY PARTITIONS AND/OR TARPS TO KEEP DUST AND DIRT WITHIN THE CONSTRUCTION AREA.

6. THE CONTRACTOR SHALL BE RESPONSIBLE FOR THE SAFEKEEPING OF HIS OWN PROPERTY ON THE JOB SITE. OWNER ASSUMES NO RESPONSIBILITY FOR PROTECTION OF PROPERTIES AGAINST FIRE, THEFT AND ENVIRONMENTAL CONDITIONS.

ACU AD	AIR CONDITIONING UNIT ACCESS DOOR
AFF	ABOVE FINISHED FLOOR
AFG	ABOVE FINISHED GRADE
AHU	AIR HANDLING UNIT
AL	ACOUSTICAL LINING
AP	ACCESS PANEL
B/G	BELOW GROUND
BMS	BUILDING MANAGEMENT SYSTEM
BOG	BOTTOM OF GRILLE
BOH	BOTTOM OF HEATER
BOU	BOTTOM OF UNIT
CFM	CUBIC FEET PER MINUTE
DB	DRY BULB
DH	DEHUMIDIFICATION UNIT
DN	DOWN
EAT	ENTERING AIR TEMPERATURE

DESICCANT DEHUMIDIFICATION UNIT										
	PROCESS	REACTIVATION		DESICCANT	MOISTURE REMOVAL	ELECTRICAL				
EQUIPMENT			REACTIVATION	WHEEL DRIVE	CAPACITY	TOTAL CONNECTED				
TAG	(SCFM)	(SCFM)	HEATER (KW)	MOTOR (HP)	(LBS/HR)	VOLT/PH/HZ	LOAD (AMPS)	MOPD	MODEL	REMARKS
DH-SV-1	150	50	1.75	1/40	3.8	460/3/60	4.7	20	GC-150	1 THRU 5
DH-DV-1	150	50	1.75	1/40	3.8	460/3/60	4.7	20	GC-150	1 THRU 5

GENERAL NOTES:

1. BASIS OF DESIGN IS MUNTERS

ACCESSORIES:

1. SELF-CONTAINED, HONEYCOMB DESICCANT WHEEL TYPE DEHUMIDIFIER UNIT 2. BUILT-IN HYGROMETER AND HUMIDISTAT FOR HUMIDITY CONTROL 3. ALUMINUM CABINET WITH LIGHT GRAY ENAMEL PAINT

4. VERICAL UNIT

5. CONTACT AIR SEALS TO SEPARATE PROCESS AND REACTIVATION AIR STREAMS

FAN SCHEDULE											
EQUIPMENT	EQUIPMENT AIR FLOW ESP (IN. FAN ELECTRICAL MAKE & MODEL										
TAG	LOCATION	SERVICE	(CFM)	W.G.)	RPM	DRIVE	MOTOR HP	VOLT/PH/HZ	MFR	MODEL	REMARKS
EF-SV-1	VALVE VAULT	EXHAUST	750	0.4	1,210	DIRECT	1/4	120/1/60	GREENHECK	G-103-VG	1, 2, 3
EF-DV-1	METER VAULT	EXHAUST	1,050	0.5	1,180	DIRECT	1/4	120/1/60	GREENHECK	G-123-VG	1, 2, 3

GENERAL NOTES: 1. OR EQUAL BY LOREK COOK

ACCESSORIES:

1. VARI-GREEN EC MOTOR

2. PROVIDE DISCONNECT SWITCH

3. PROVIDE BACK DRAFT DAMPER, AND BIRD SCREEN

. HOSE-DOWN CORROSION RESISTANT BLOWER HEATER . MOUNTING BRACKETS

No.	Description	Date	STAMP:	ADDRESS: E NGINEERED S YSTEMS & 2950 Horizon Park Drive Suite B Suite B	PROJECT NO: DESIGNED BY: DRAWN BY:
			PROFESSIONAL PROFESSIONAL PROFESSIONAL PROFESSIONAL PROFESSIONAL PROFESSIONAL PROFESSIONAL PROFESSIONAL PROFESSIONAL PROFESSIONAL PROFESSIONAL PROFESSIONAL	SYSTEMS & SERVICES	CHECKED BY: DATE: SCALE:

ELECTRIC UNIT HEATER SCHEDULE

ABBREVIATIONS

-			
EER	ENERGY EFFICIENCY RATIO	MIN	MINIMUM
EF	EXHAUST FAN	MOP	MAXIMUM OVERCURRENT PROTECTION
ESP	EXTERNAL STATIC PRESSURE	MTD	MOUNTED
EUH	ELECTRICAL UNIT HEATER	OA	OUTSIDE AIR
FLR	FLOOR	OAI	OUTSIDE AIR INTAKE
FOB	FLAT ON BOTTOM	OAT	OUTSIDE AIR TEMPERATURE
FPM	FEET PER MINUTE	OC	ON CENTER
GC	GENERAL CONTRACTOR	SF	SUPPLY FAN
GH	GRAVITY HOOD	SP	STATIC PRESSURE
GPH	GALLONS PER HOUR	TYP	TYPICAL
GPM	GALLONS PER MINUTE	UON	UNLESS OTHERWISE NOTED
HD	HAND DAMPER	V	VENT
HP	HORSE POWER	W	WASTE
IE	INVERT ELEVATION	WB	WET BULB
KW	KILOWATT	WG	WATER GAGE
MCA	MINIMUM CIRCUIT AMPACITY	WL	WALL LOUVER
MFR	MANUFACTURER	WMS	WIRE MESH SCREEN

	CITY OF ATLANTA DEPT. OF WATERSHED MANAGEMENT	DRAWING NO.
TASK 1	WATER SUPPLY PROGRAM	
SP		RI-PS
NM	RIVER INTAKE PUMP STATION	
SP	NOTES, LEGENDS, ABBREVIATIONS AND	M7-001
11-22-2019		
AS NOTED	SCHEDULES	SHEET OF
	ISSUED	FOR BIDDING