



P:\City of Atlanta - Water Supply Program Phase \CD Drawings\PROCESS\RI-PS DP0-001.dwg, PRINTED BY: hody.barnes ON Thu, Dec 05, 2019 AT 8:54 AM

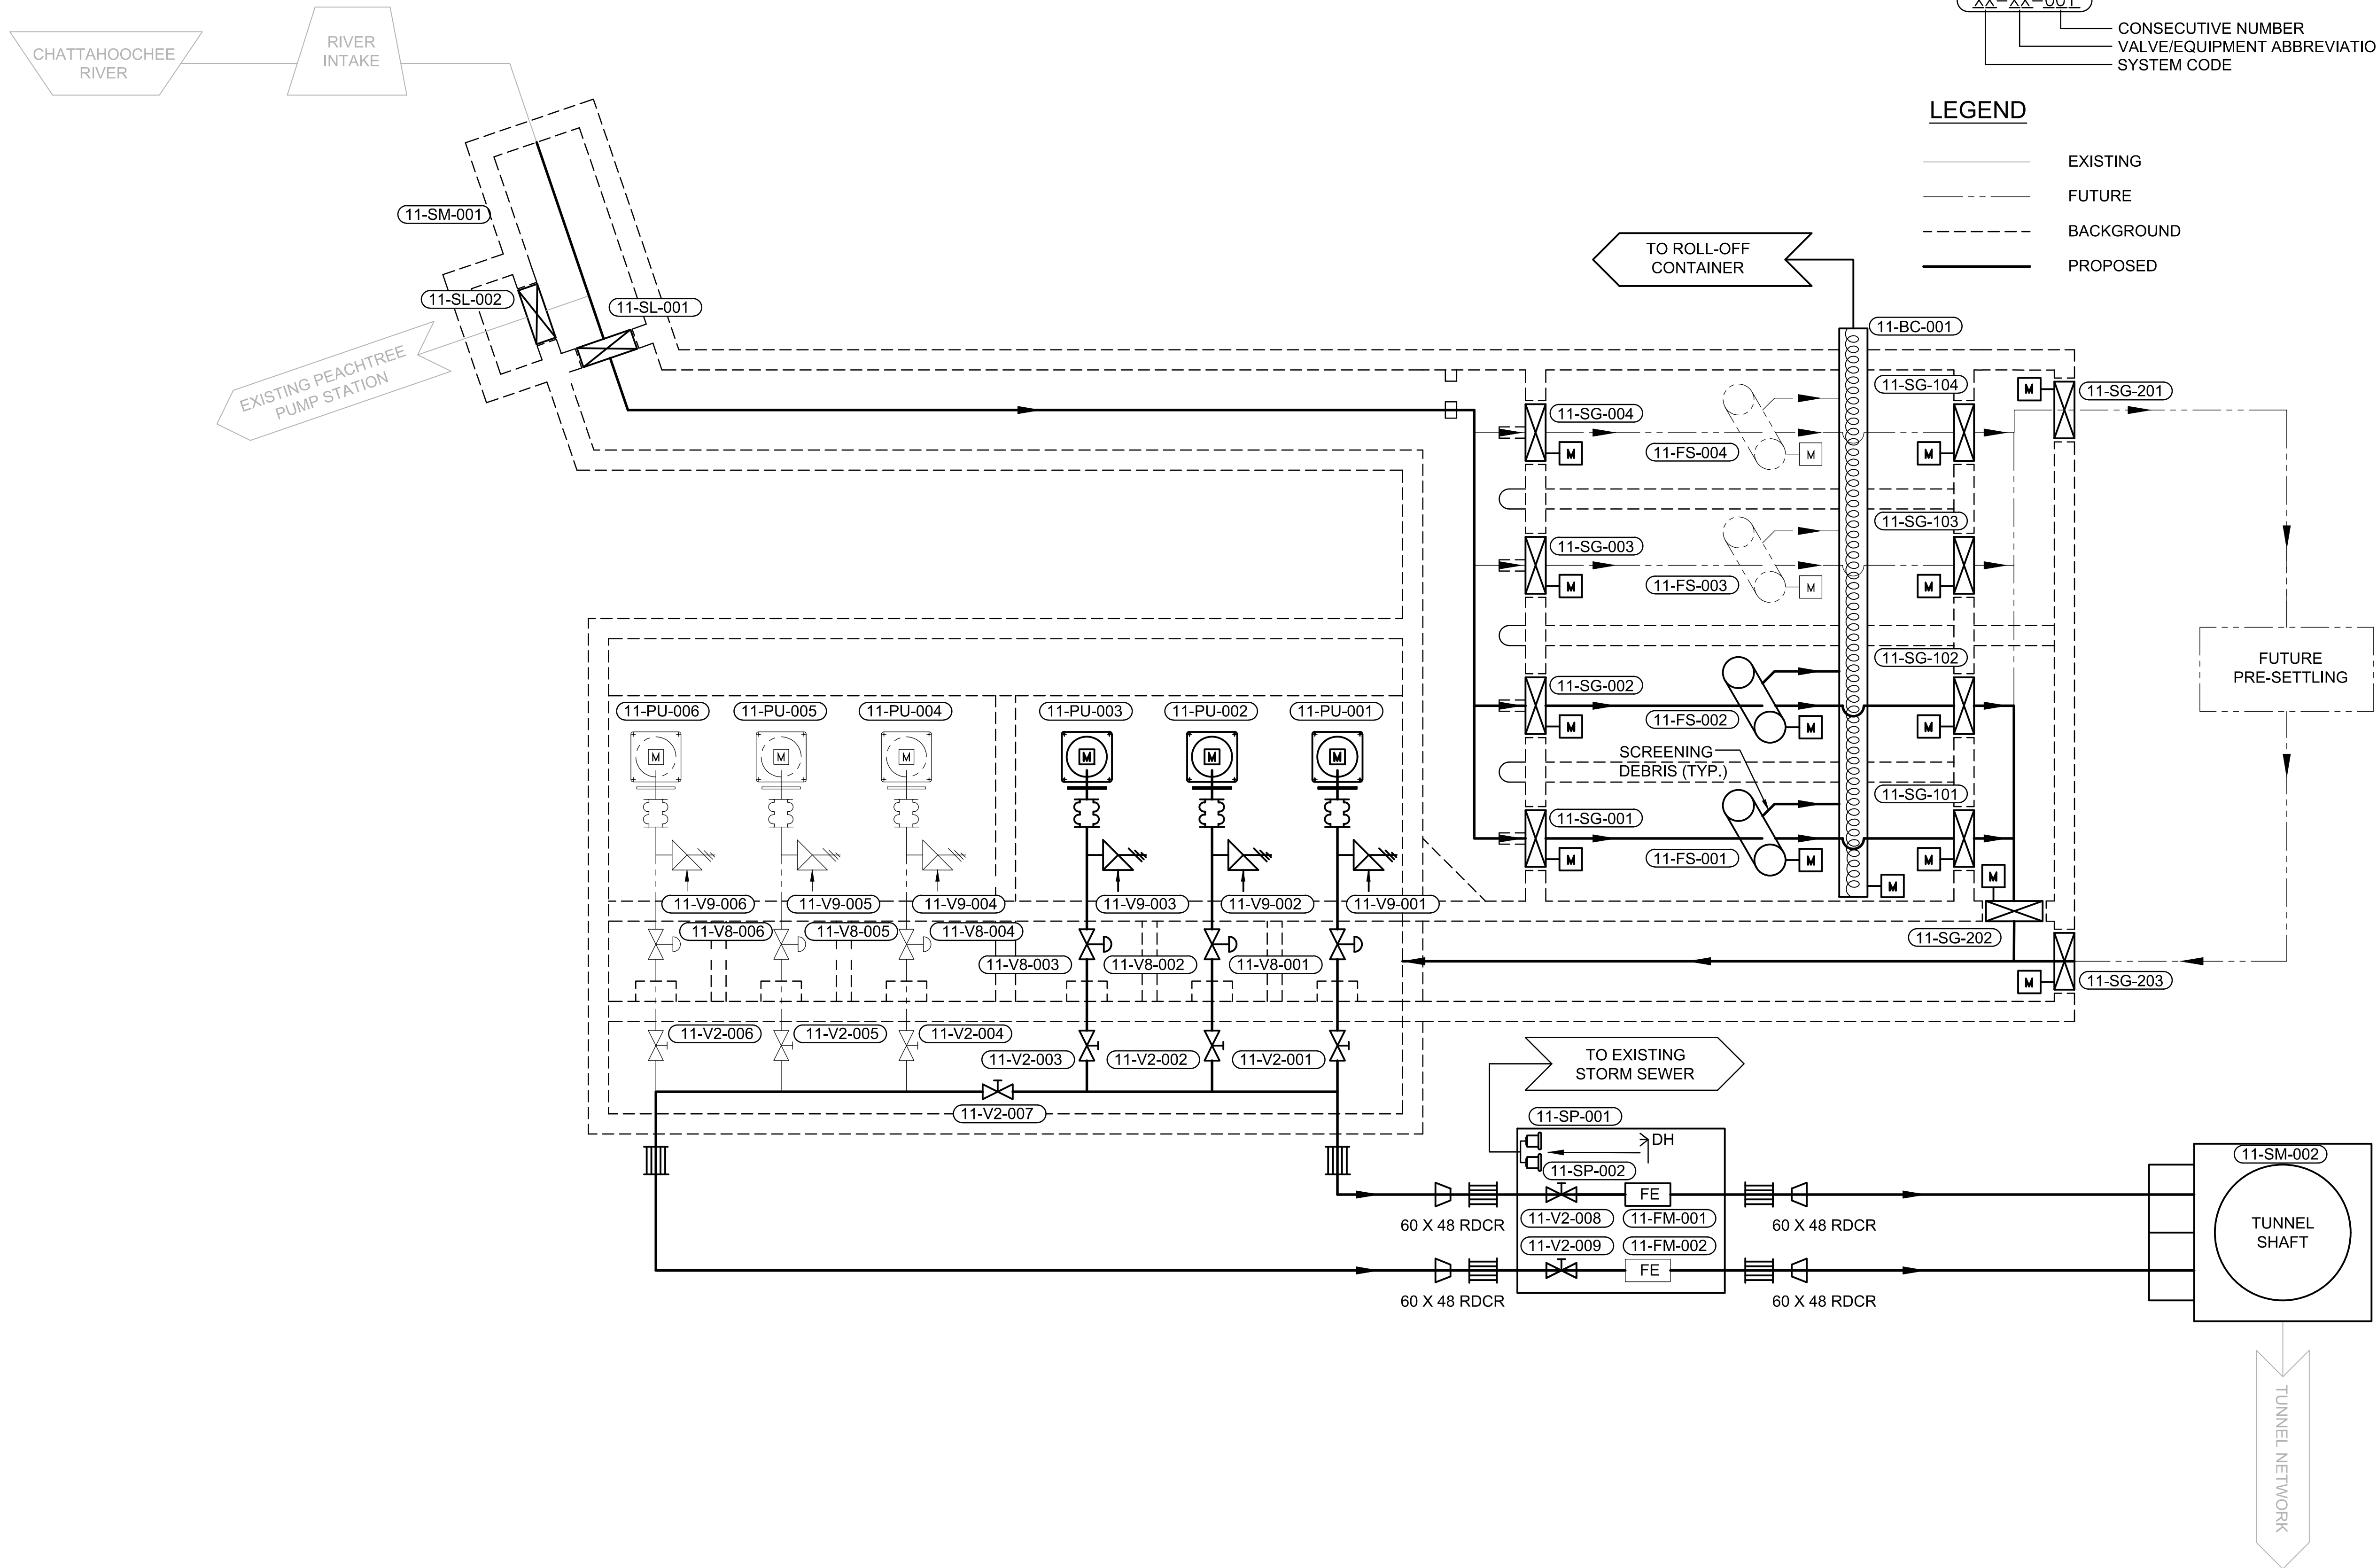


NOTES

1. TYPICAL VALVE/EQUIPMENT TAG NUMBER DESIGNATION

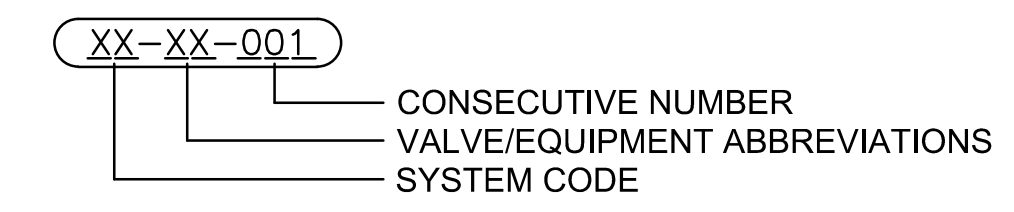

LEGEND

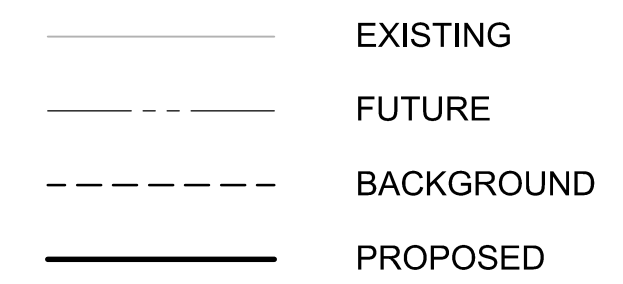

A. SYSTEM CODE:

11 - RIVER INTAKE PUMP STATION
12 - RIVER SHAFT

B. VALVE TYPE:


V2 - GATE VALVE
V8 - PUMP CONTROL VALVE
V9 - AIR VALVE

C. EQUIPMENT ABBREVIATIONS

FM - FLOW METER
SG - SLIDE GATE
WR - WEIR
FS - FINE SCREEN
SL - STOP LOG
BC - BELT CONVEYOR
SM - SAMPLE PUMPS
SP - SUMP PUMPS



No.	Description	Date

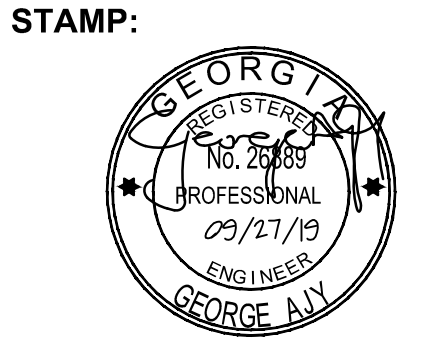

ADDRESS:
BGR2-JV
6 CONCOURSE PARKWAY
SUITE 1600
ATLANTA, GA 30328
(770) 569-7038 x101
FAX: (770) 993-5082

PROJECT NO:	TASK_13
DESIGNED BY:	J.M.
DRAWN BY:	H.B.
CHECKED BY:	A.T.
DATE:	09/27/19
SCALE:	NONE


CITY OF ATLANTA DEPT. OF WATERSHED MANAGEMENT
WATER SUPPLY PROGRAM
RIVER INTAKE PUMP STATION
SITE 1
PROCESS FLOW DIAGRAM

DRAWING NO.
RI-PS
DP0-001
SHEET OF

ISSUED FOR BIDDING

NOTES

1. TYPICAL VALVE/EQUIPMENT TAG NUMBER DESIGNATION

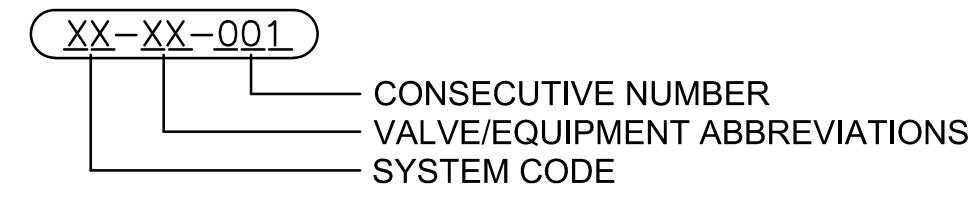

A. SYSTEM CODE:

- 08 - WET WELL
- 09 - OPERATING FLOOR
- 10 - YARD PIPING


B. VALVE TYPE:

- V1 - BALL VALVE
- V2 - GATE VALVE
- V9 - AIR/VACUUM RELIEF VALVE

C. EQUIPMENT ABBREVIATIONS

- DH - DEHUMIDIFIER
- FM - FLOW METER
- PI - PRESSURE INDICATOR
- PP - PUMP
- SP - SUMP PUMPS
- VV - VENTURI VAULT
- SM - SAMPLE PUMPS

2. FOR EXISTING VALVES SCHEDULE SEE "COA PUMPING STATION & PIPING LAYOUT 1994"

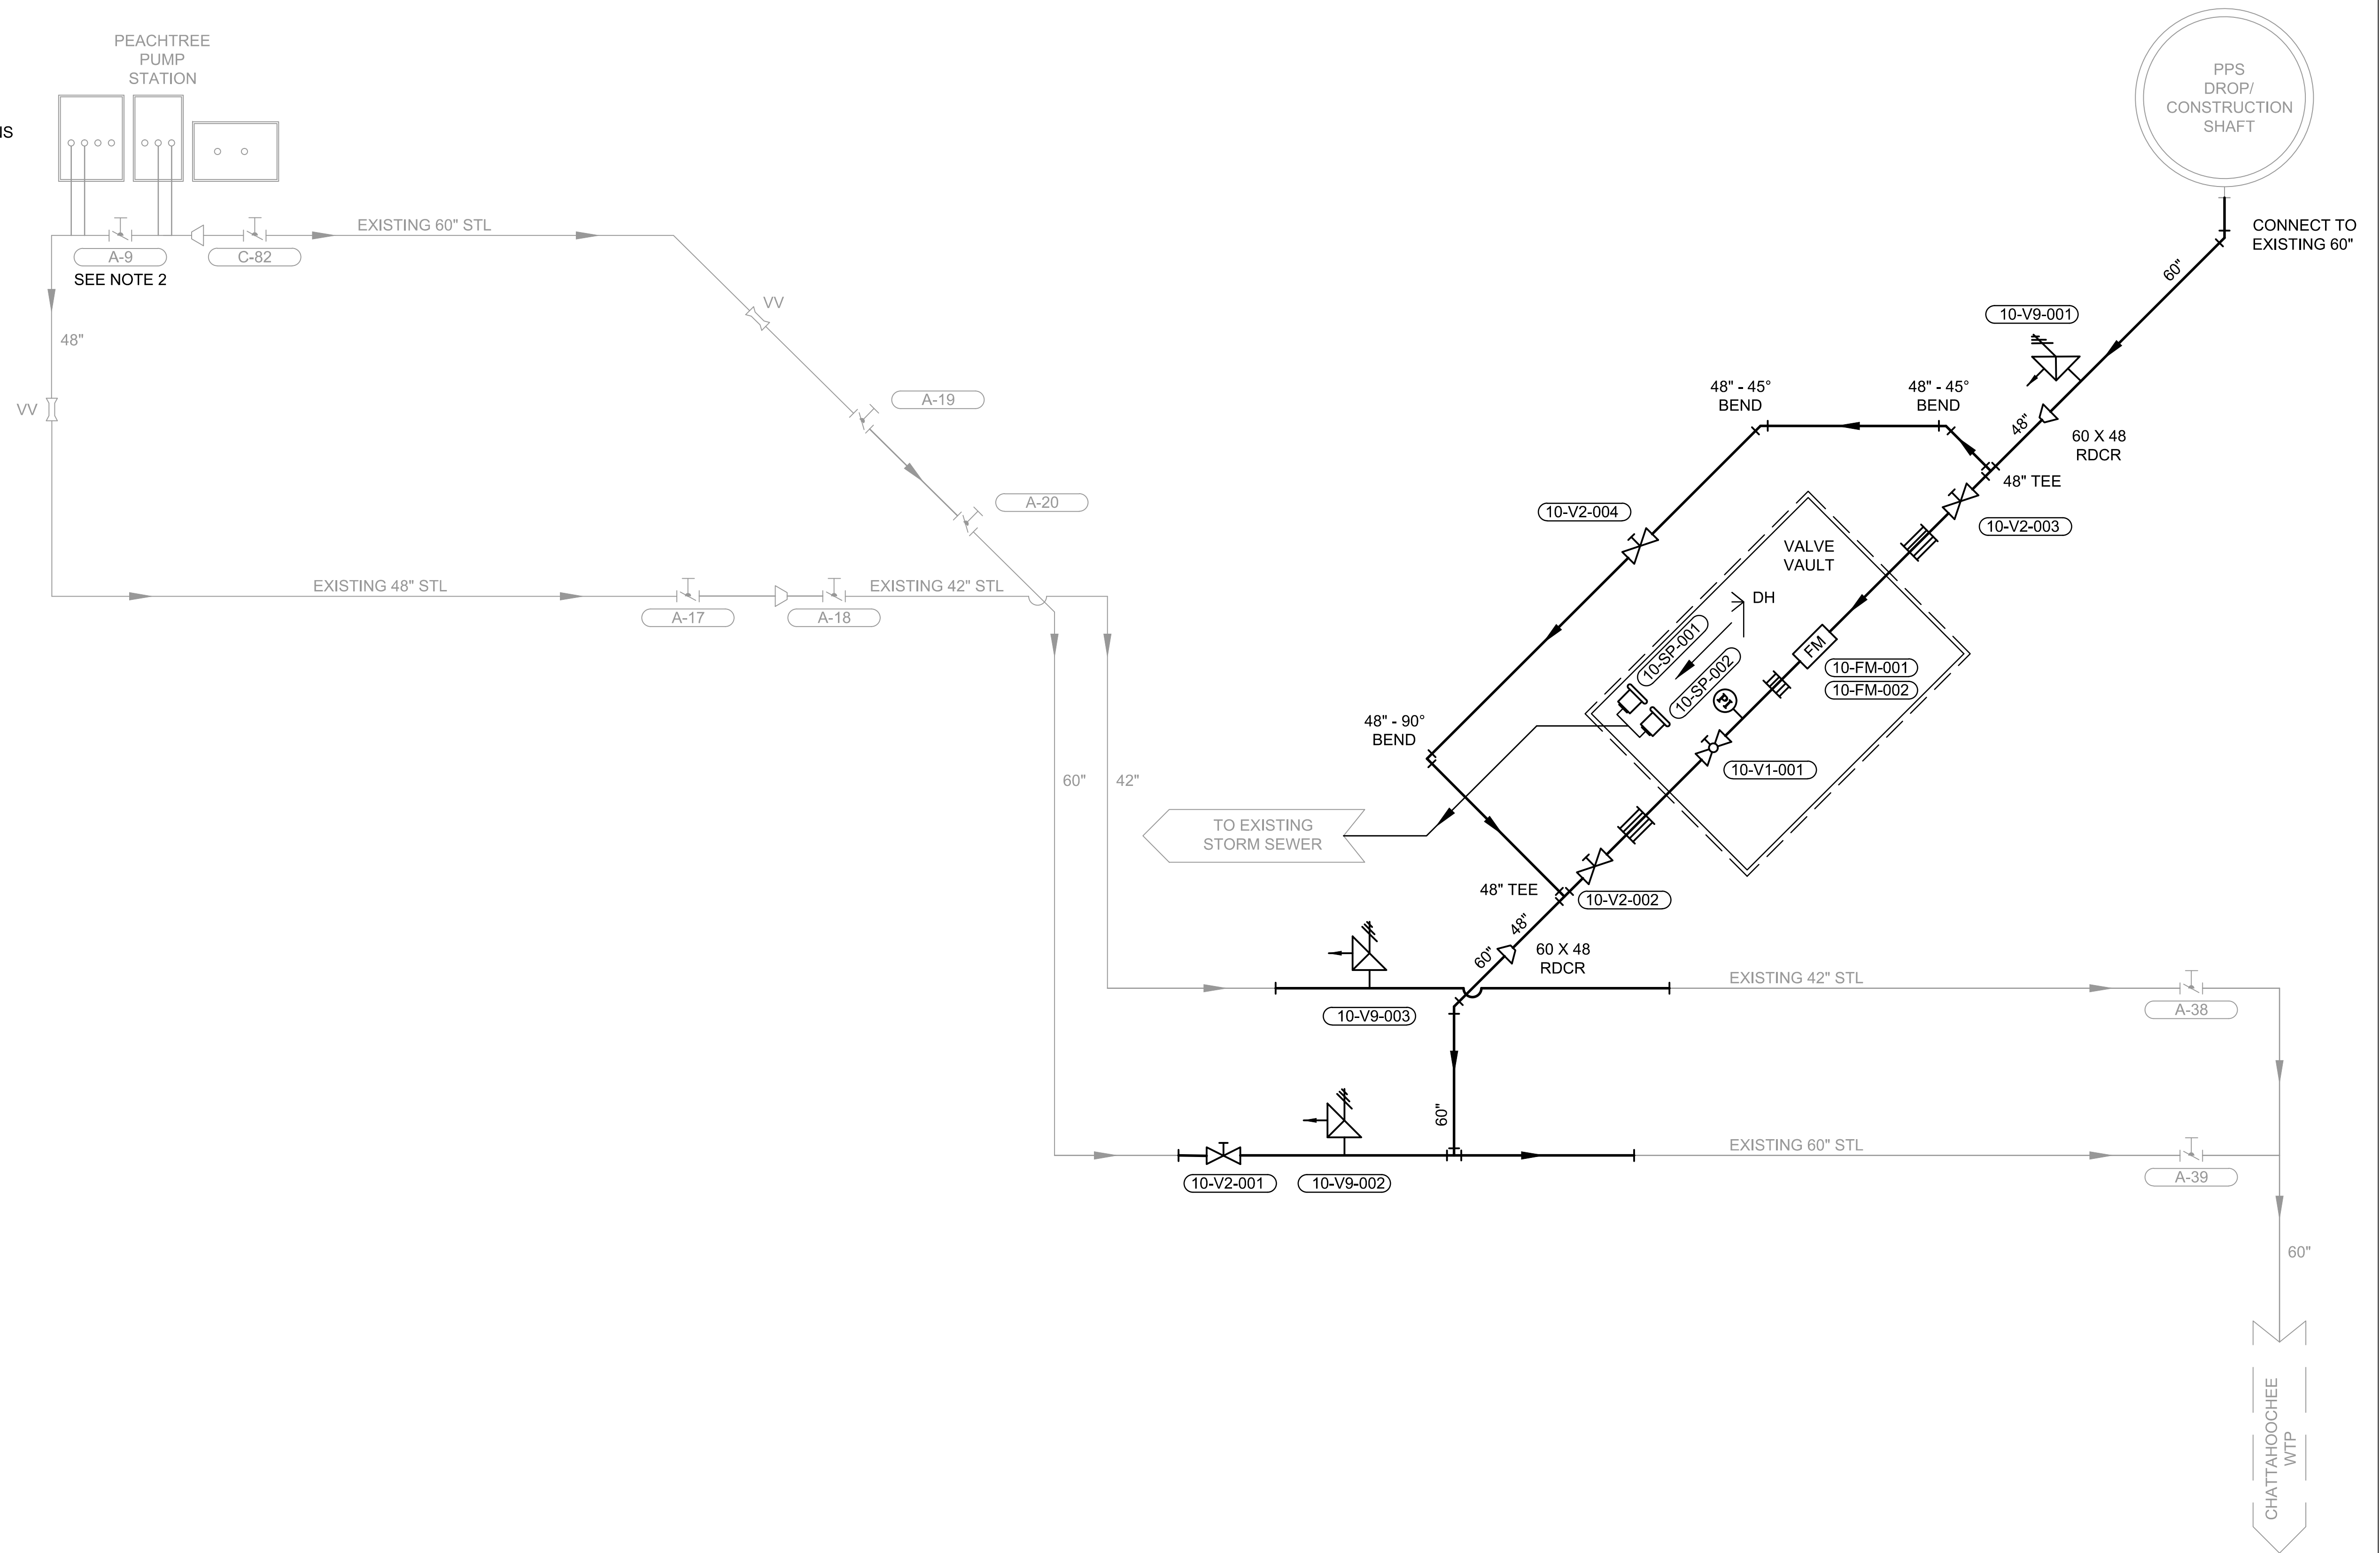

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ADDRESS:

BGR2-JV
 6 CONCOURSE PARKWAY
 SUITE 1600
 ATLANTA, GA 30328
 (770) 569-7038 x101
 FAX: (770) 993-5082

PROJECT NO:	TASK_13
DESIGNED BY:	A.T.
DRAWN BY:	H.B.
CHECKED BY:	G.A.
DATE:	09/27/19
SCALE:	NONE

CITY OF ATLANTA DEPT. OF WATERSHED MANAGEMENT
WATER SUPPLY PROGRAM

RIVER INTAKE PUMP STATION
 SITE 2
 PROCESS FLOW DIAGRAM

DRAWING NO.

RI-PS

DP0-002

SHEET OF

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ABBREVIATIONS:


W1: POTABLE WATER (FROM CITY)
 W2: POTABLE WATER BACKFLOW PREVENTOR
 W3: NON-POTABLE WATER (WELL WATER)

REFERENCE DRAWINGS

A1-100 - ARCHITECTURAL
 S-SS - STRUCTURAL

NOTES

1. TYPICAL VALVE/EQUIPMENT TAG NUMBER DESIGNATION

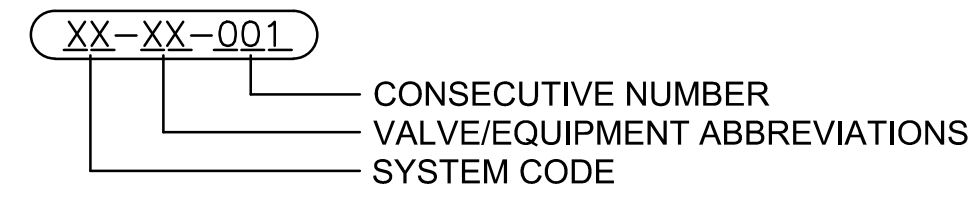

A. SYSTEM CODE:

11 - RIVER INTAKE PUMP STATION
 12 - RIVER SHAFT

A. VALVE TYPE:

V2 - GATE VALVE
 V8 - AIR/VACUUM RELIEF VALVE
 V9 - PUMP CONTROL VALVE

B. EQUIPMENT ABBREVIATIONS


SG - SLIDE GATE
 WR - WEIR GATE
 FS - FINE SCREEN
 SL - STOP LOG

2. DIMENSIONS TO BE VERIFIED PRIOR TO PROCUREMENT AND INSTALLATION OF EQUIPMENT, PIPING AND APPURTENANCES.

3. SEE STRUCTURAL DRAWINGS FOR WALL PIPES, SLAB PENETRATIONS, SUPPORTS, AND OPENINGS.

4. ALL "W3" PIPING TO BE DIP.

5. EXPOSED SEAL WATER AND SAMPLE PIPING SHALL BE HEAT TRACED AND INSULATED. REF. SPEC 15250.

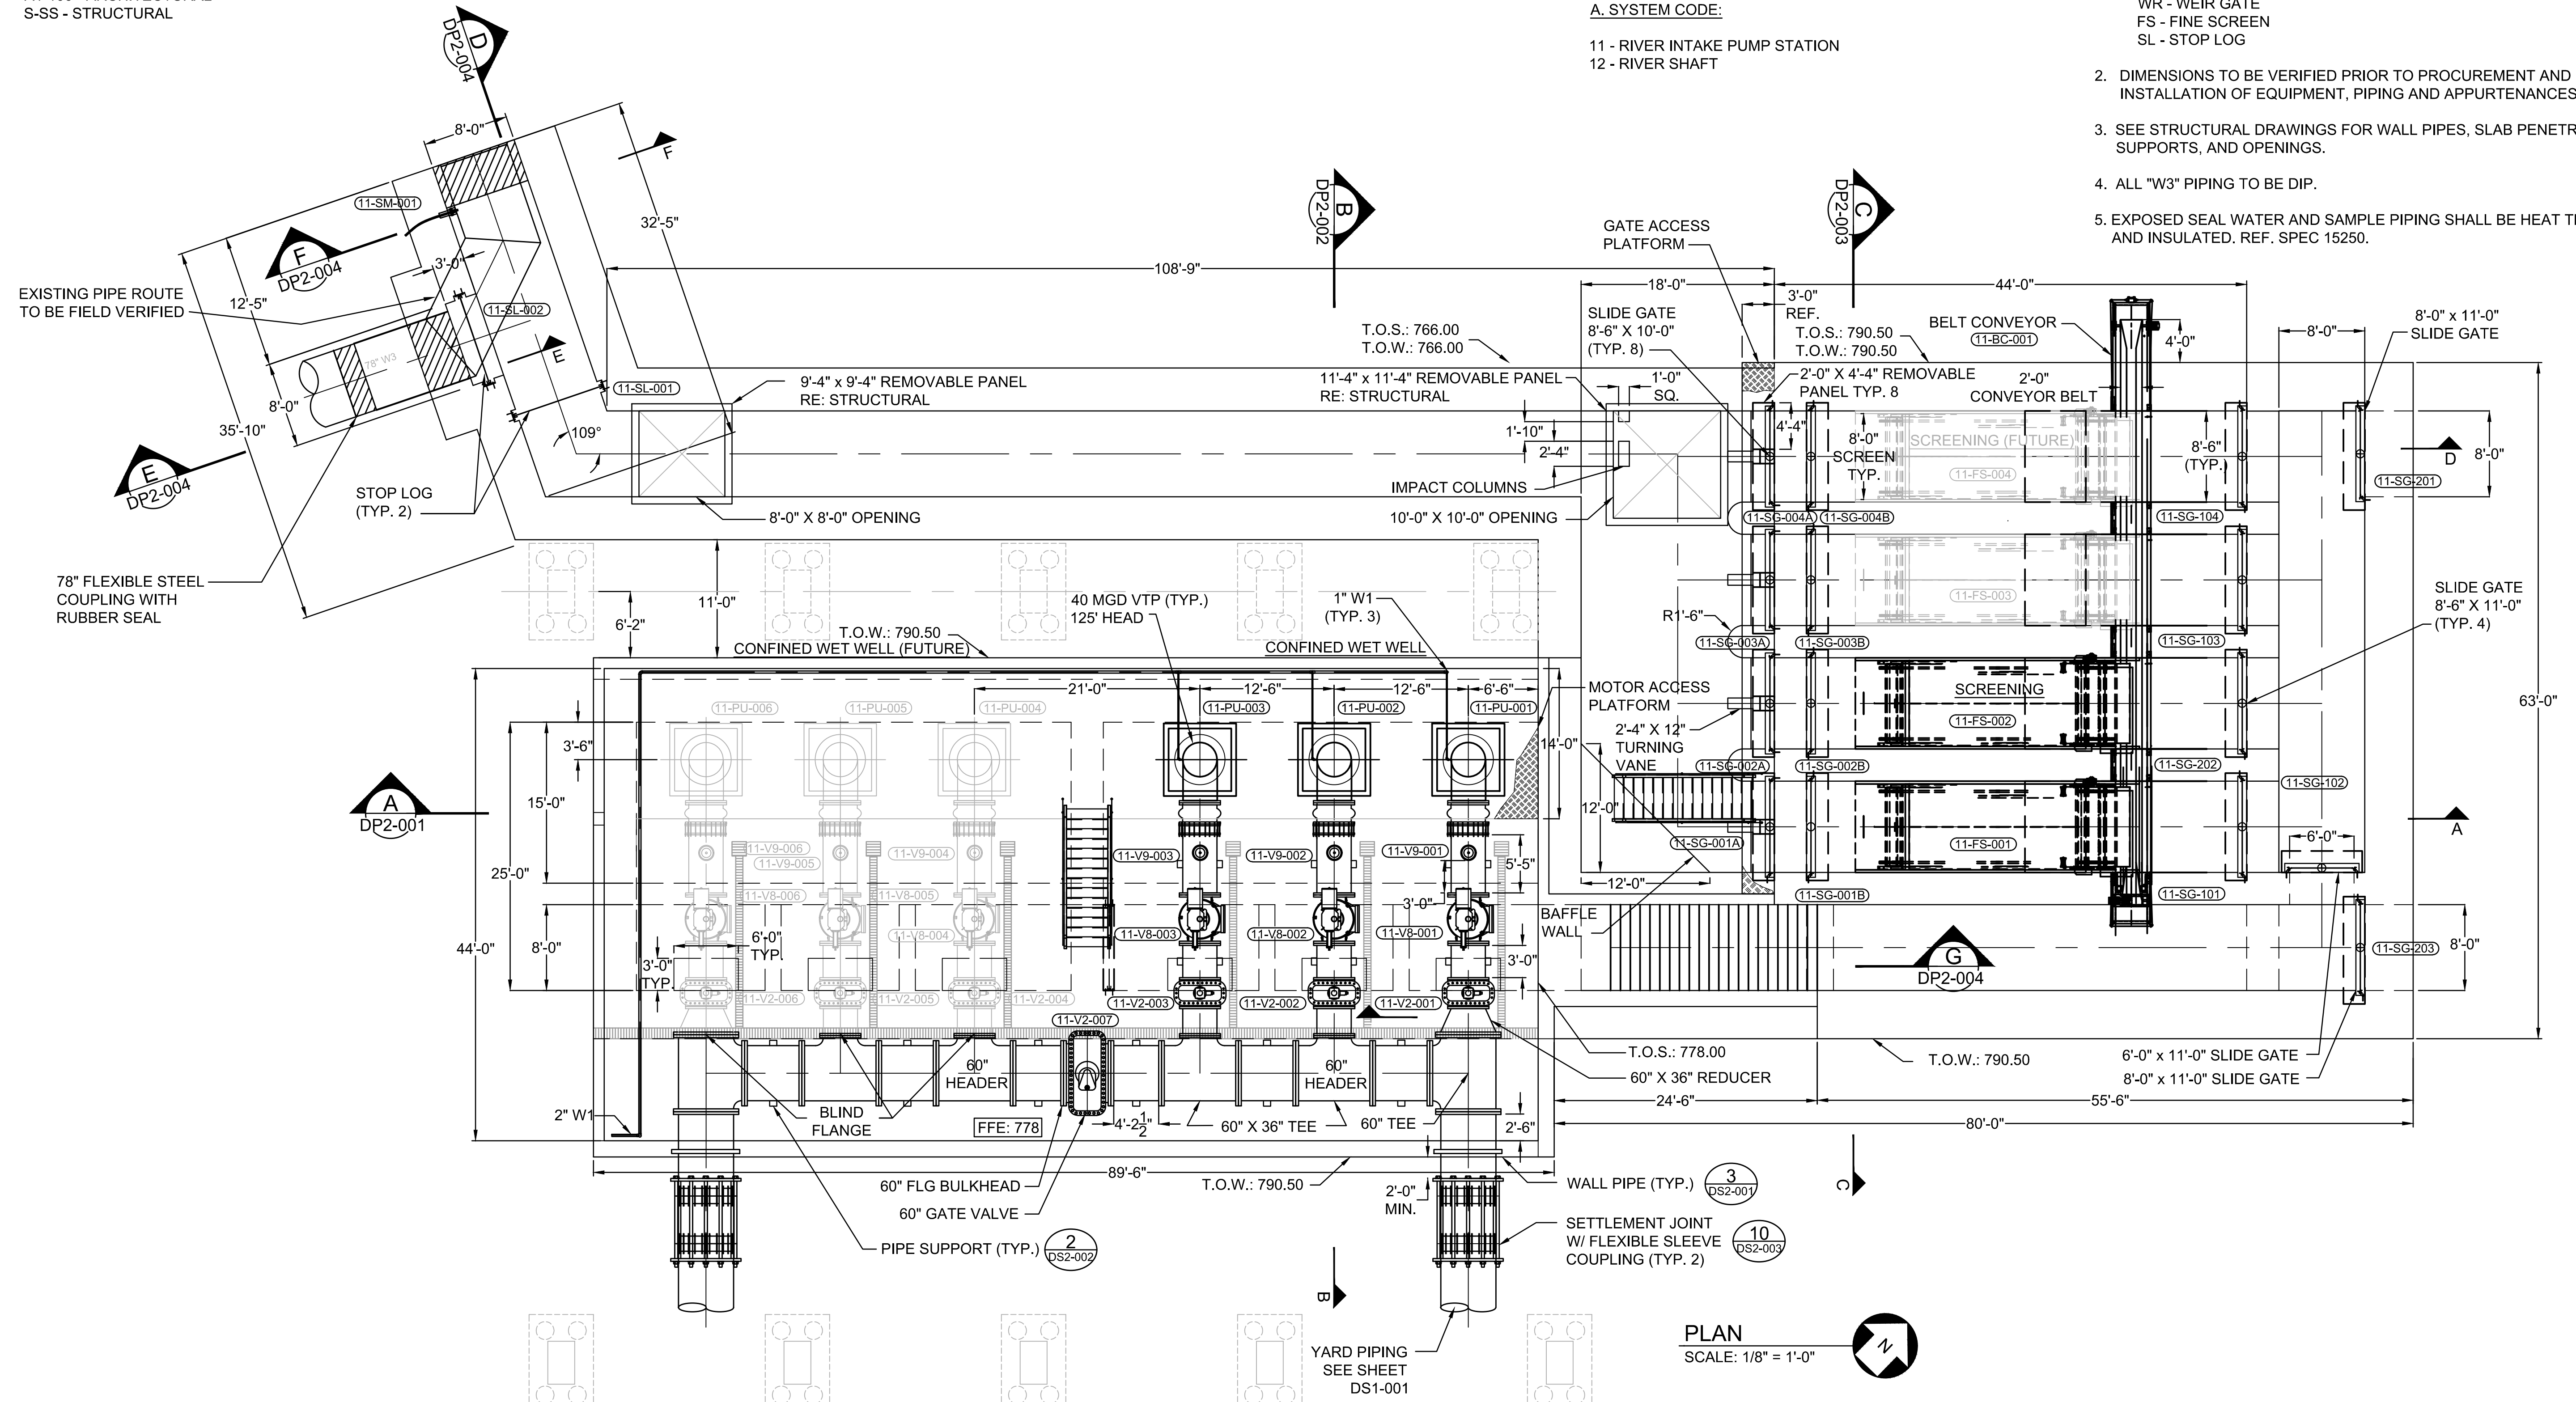


PLAN
 SCALE: 1/8" = 1'-0"

P:\City of Atlanta - Water Supply Program Phase 1\CD Drawings\PROCESS\RI-PS DP1-001.dwg, PRINTED BY: Hollyn Barnes ON: Thu, Dec 05, 2019 AT 8:55 AM



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 ATLANTA, GA 30328
 (770) 569-7038 x101
 FAX: (770) 993-5082

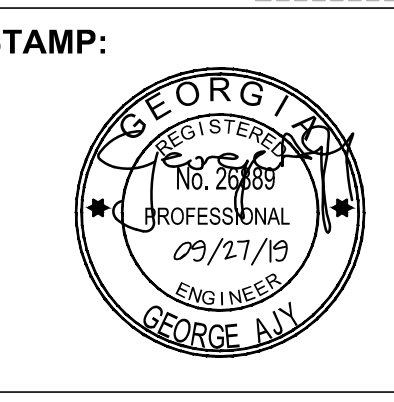PROJECT NO:	TASK_13
DESIGNED BY:	A.T.
DRAWN BY:	H.B.
CHECKED BY:	G.A.
DATE:	09/27/19
SCALE:	AS NOTED


CITY OF ATLANTA DEPT. OF WATERSHED MANAGEMENT
WATER SUPPLY PROGRAM
RIVER INTAKE PUMP STATION
PUMP STATION
PLAN

DRAWING NO.
RI-PS
DP1-001
SHEET OF

ISSUED FOR BIDDING

NOTES

- MOTOR ACCESS PLATFORM SUPPORT MEMBER LOCATIONS TO BE DETERMINED BY MANUFACTURER. MOTOR ACCESS PLATFORM ALSO TO INCLUDE REMOVABLE SECTIONS TO ALLOW FOR VERTICAL REMOVAL OF ANY OBJECT UP TO SIZE OF PUMP PAD BELOW PLATFORM.

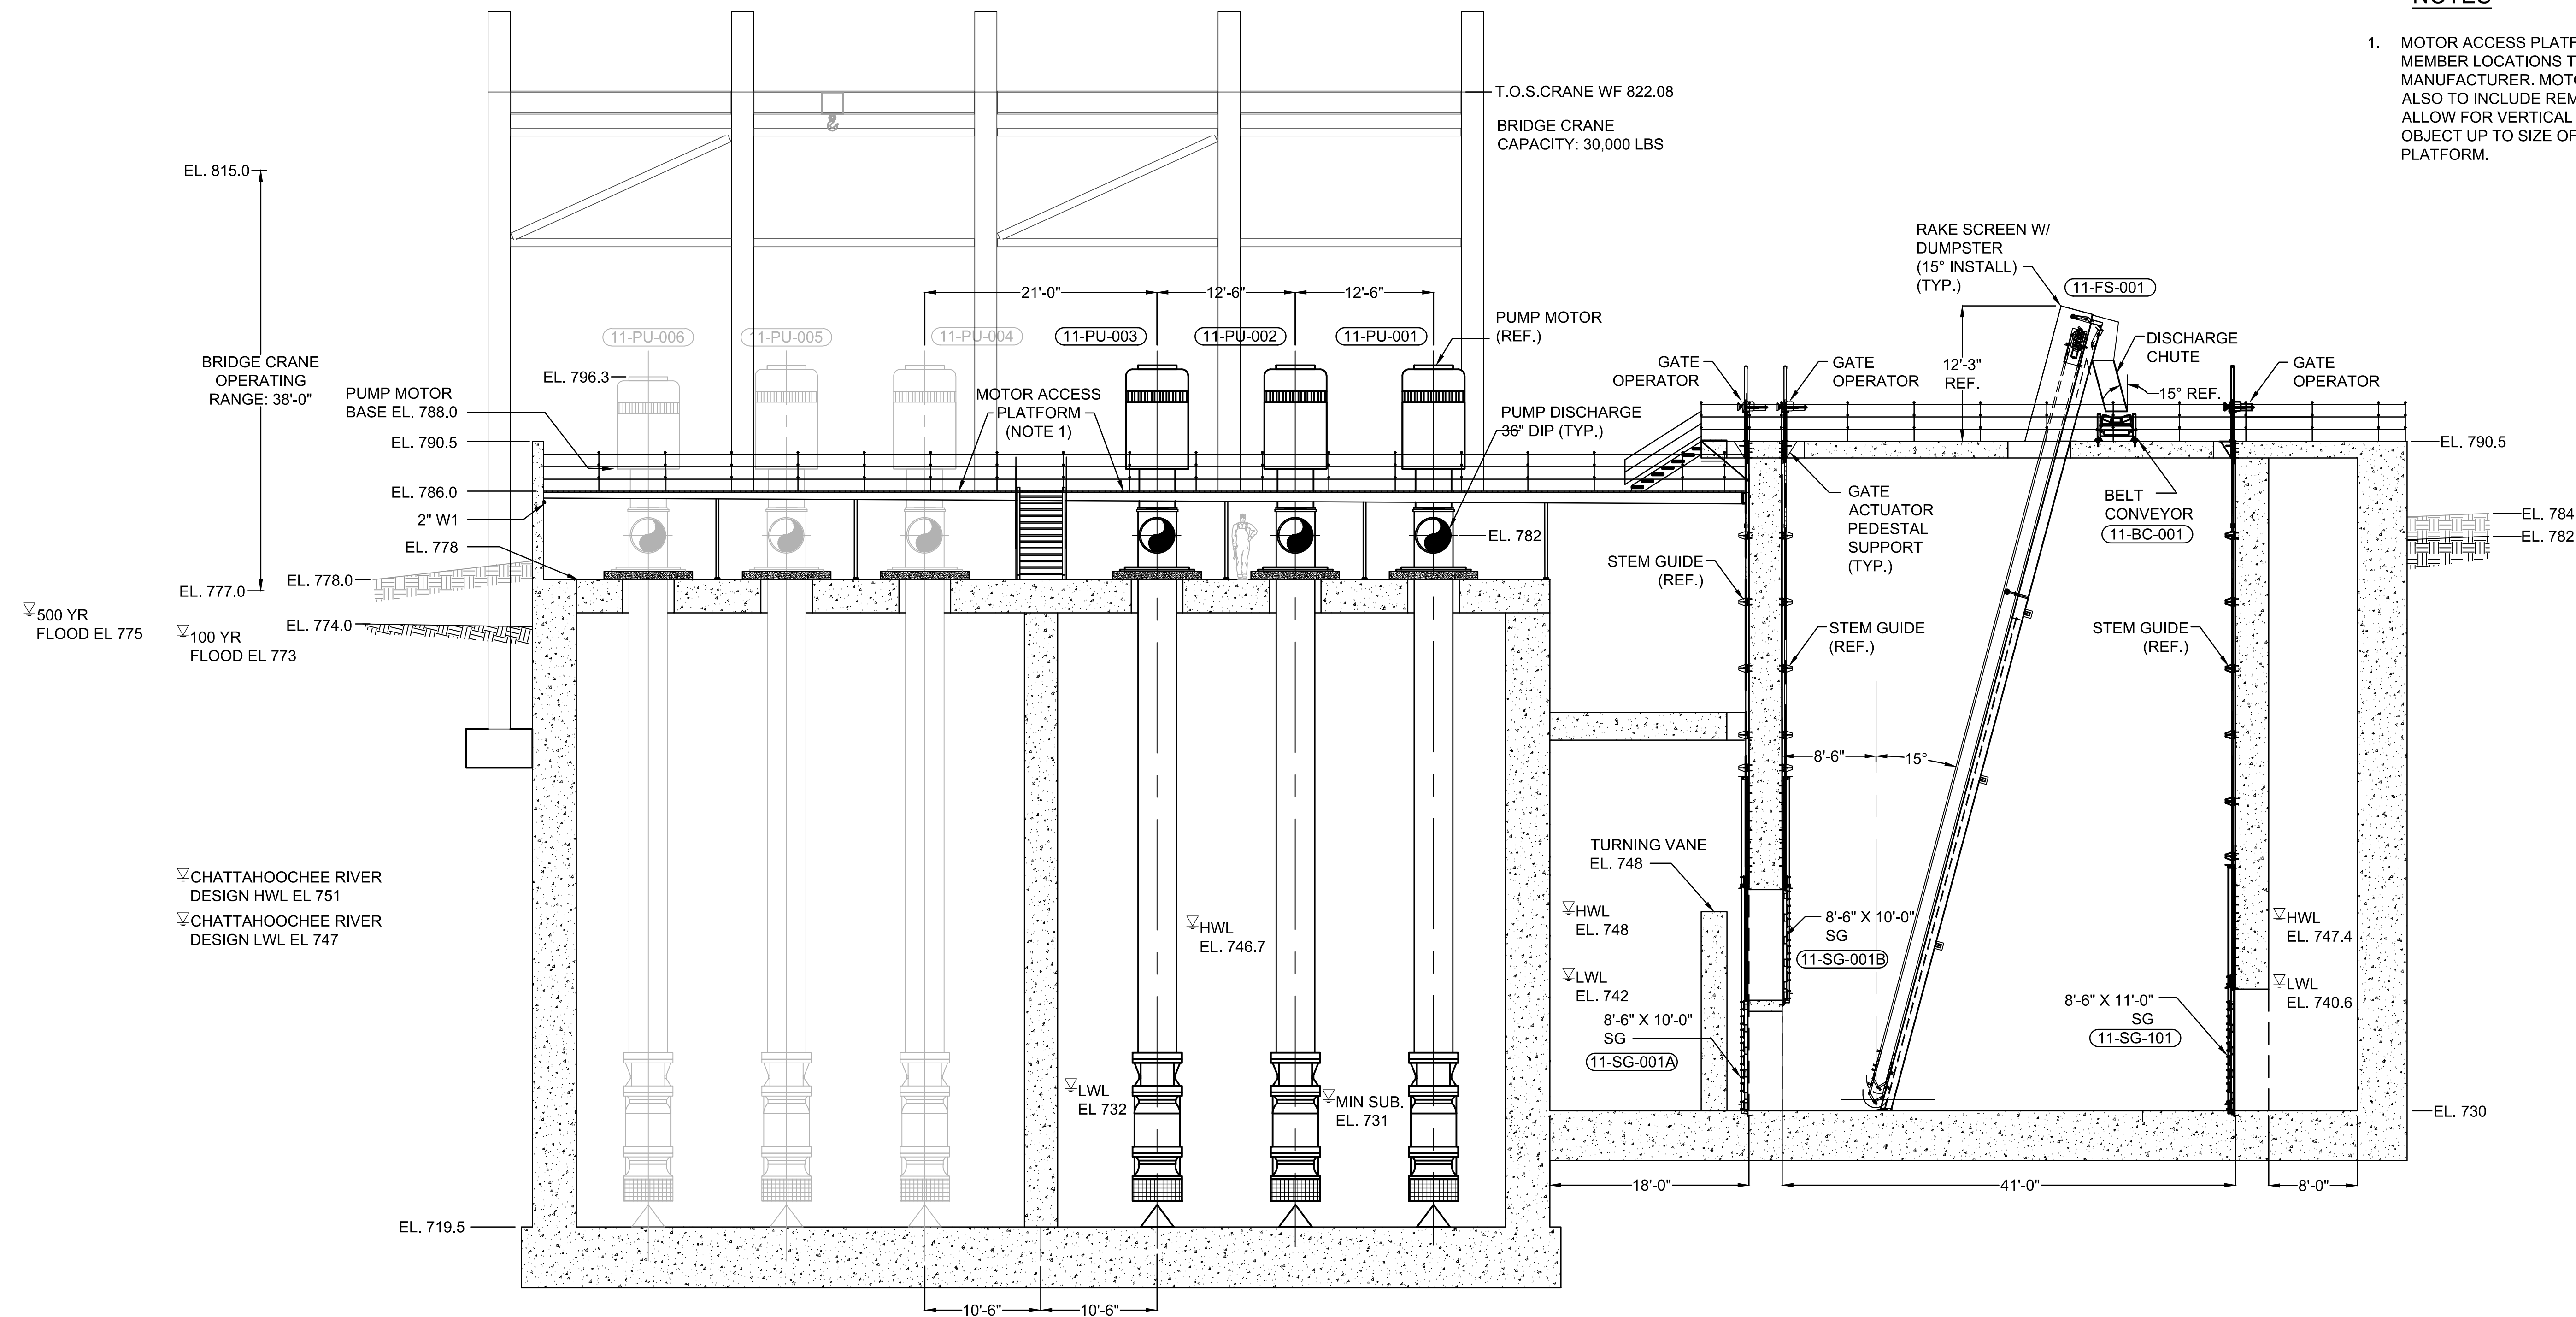


SECTION A
1/8"=1'-0"

P:\City of Atlanta - Water Supply Program Phase \CD Drawings\PROCESS\RI-PS DP2-001.dwg, PRINTED BY: Hody Barnes ON Thu, Dec 05, 2019 AT 8:55 AM



No.	Description	Date

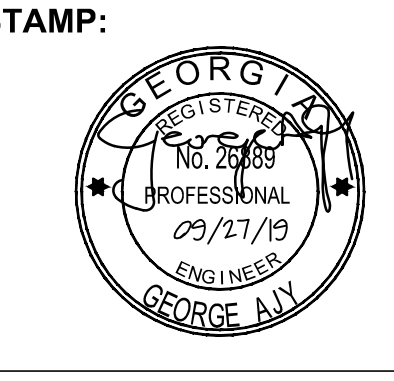

ADDRESS:
BGR2-JV
6 CONCOURSE PARKWAY
SUITE 1600
ATLANTA, GA 30328
(770) 569-7038 x101
FAX: (770) 993-5082

PROJECT NO:	TASK_13
DESIGNED BY:	A.T.
DRAWN BY:	H.B.
CHECKED BY:	G.A.
DATE:	09/27/19
SCALE:	AS NOTED


**CITY OF ATLANTA DEPT. OF WATERSHED MANAGEMENT
WATER SUPPLY PROGRAM**

**RIVER INTAKE PUMP STATION
PUMP STATION
SECTION**

DRAWING NO.
RI-PS
DP2-001
SHEET OF

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SUITE 1600
ATLANTA, GA 30328
(770) 569-7038 x101
FAX: (770) 993-5082

SECTION B
3/16"=1'-0"

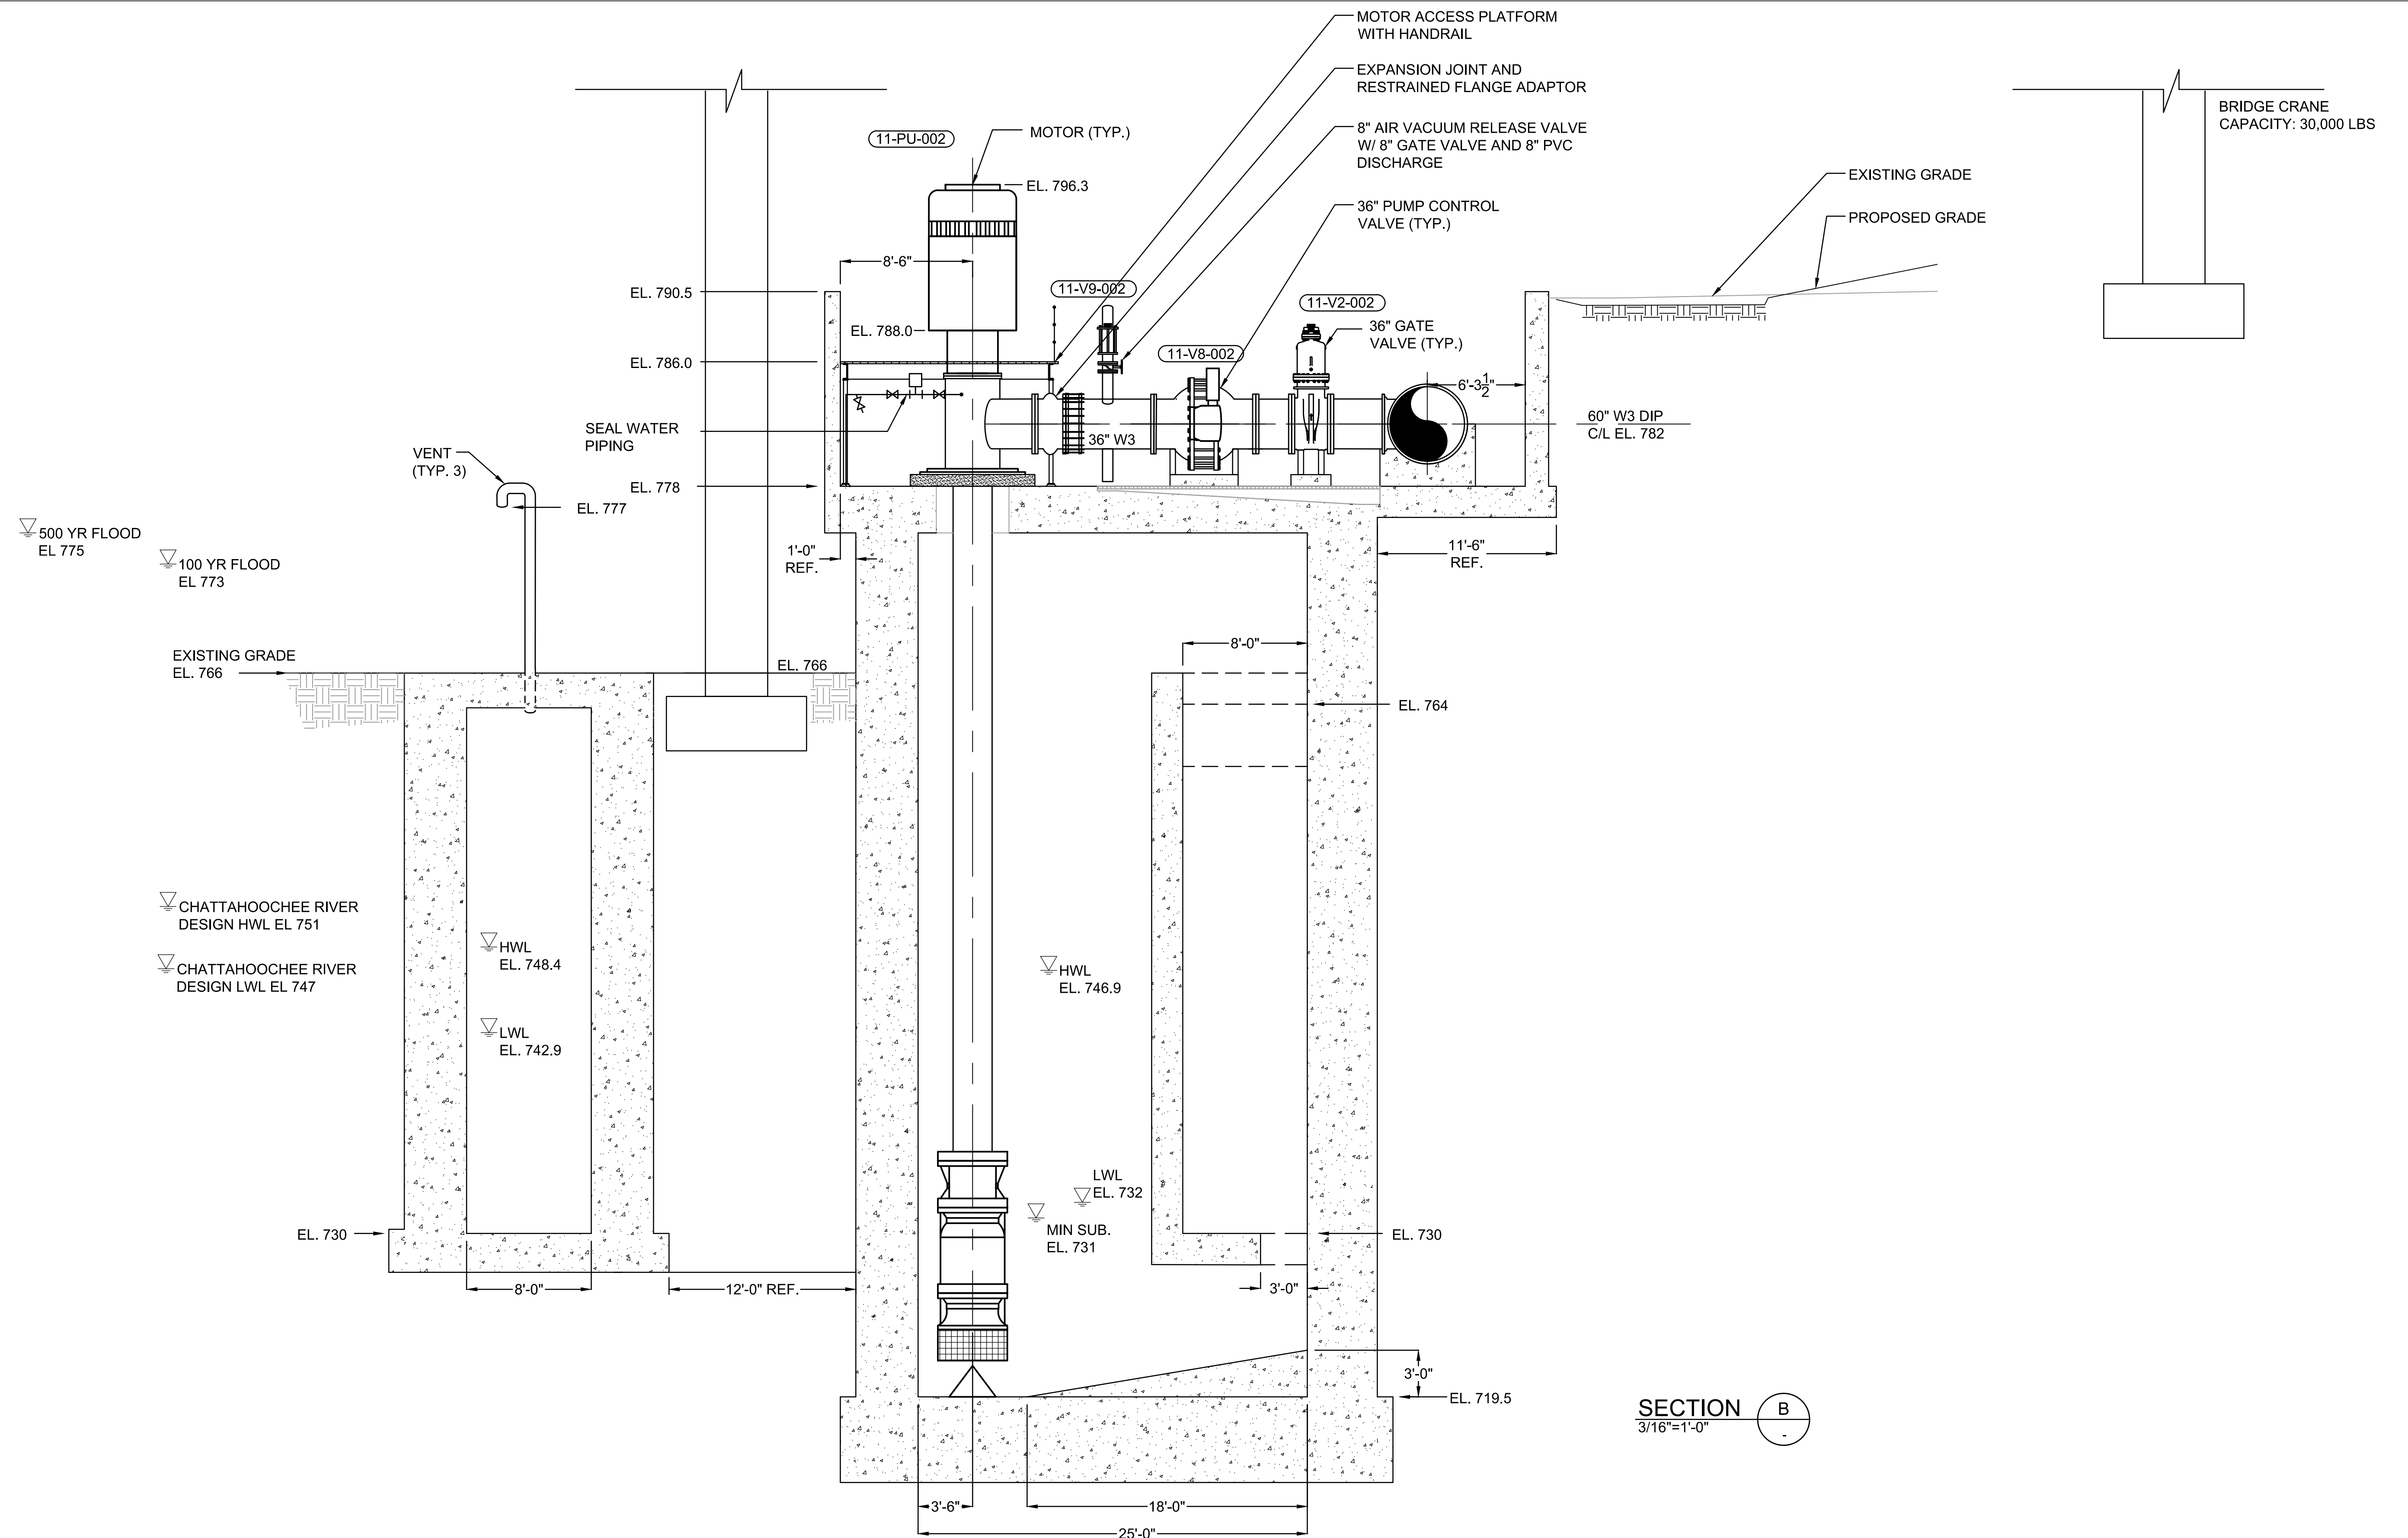PROJECT NO:	TASK_13
DESIGNED BY:	A.T.
DRAWN BY:	H.B.
CHECKED BY:	G.A.
DATE:	09/27/19
SCALE:	AS NOTED

CITY OF ATLANTA DEPT. OF WATERSHED MANAGEMENT
WATER SUPPLY PROGRAM

RIVER INTAKE PUMP STATION
PUMP STATION
SECTION

DRAWING NO.

RI-PS


DP2-002

SHEET OF

ISSUED FOR BIDDING

NOTES:

1. ROLL-OFF CONTAINER PROVIDED BY OTHERS.

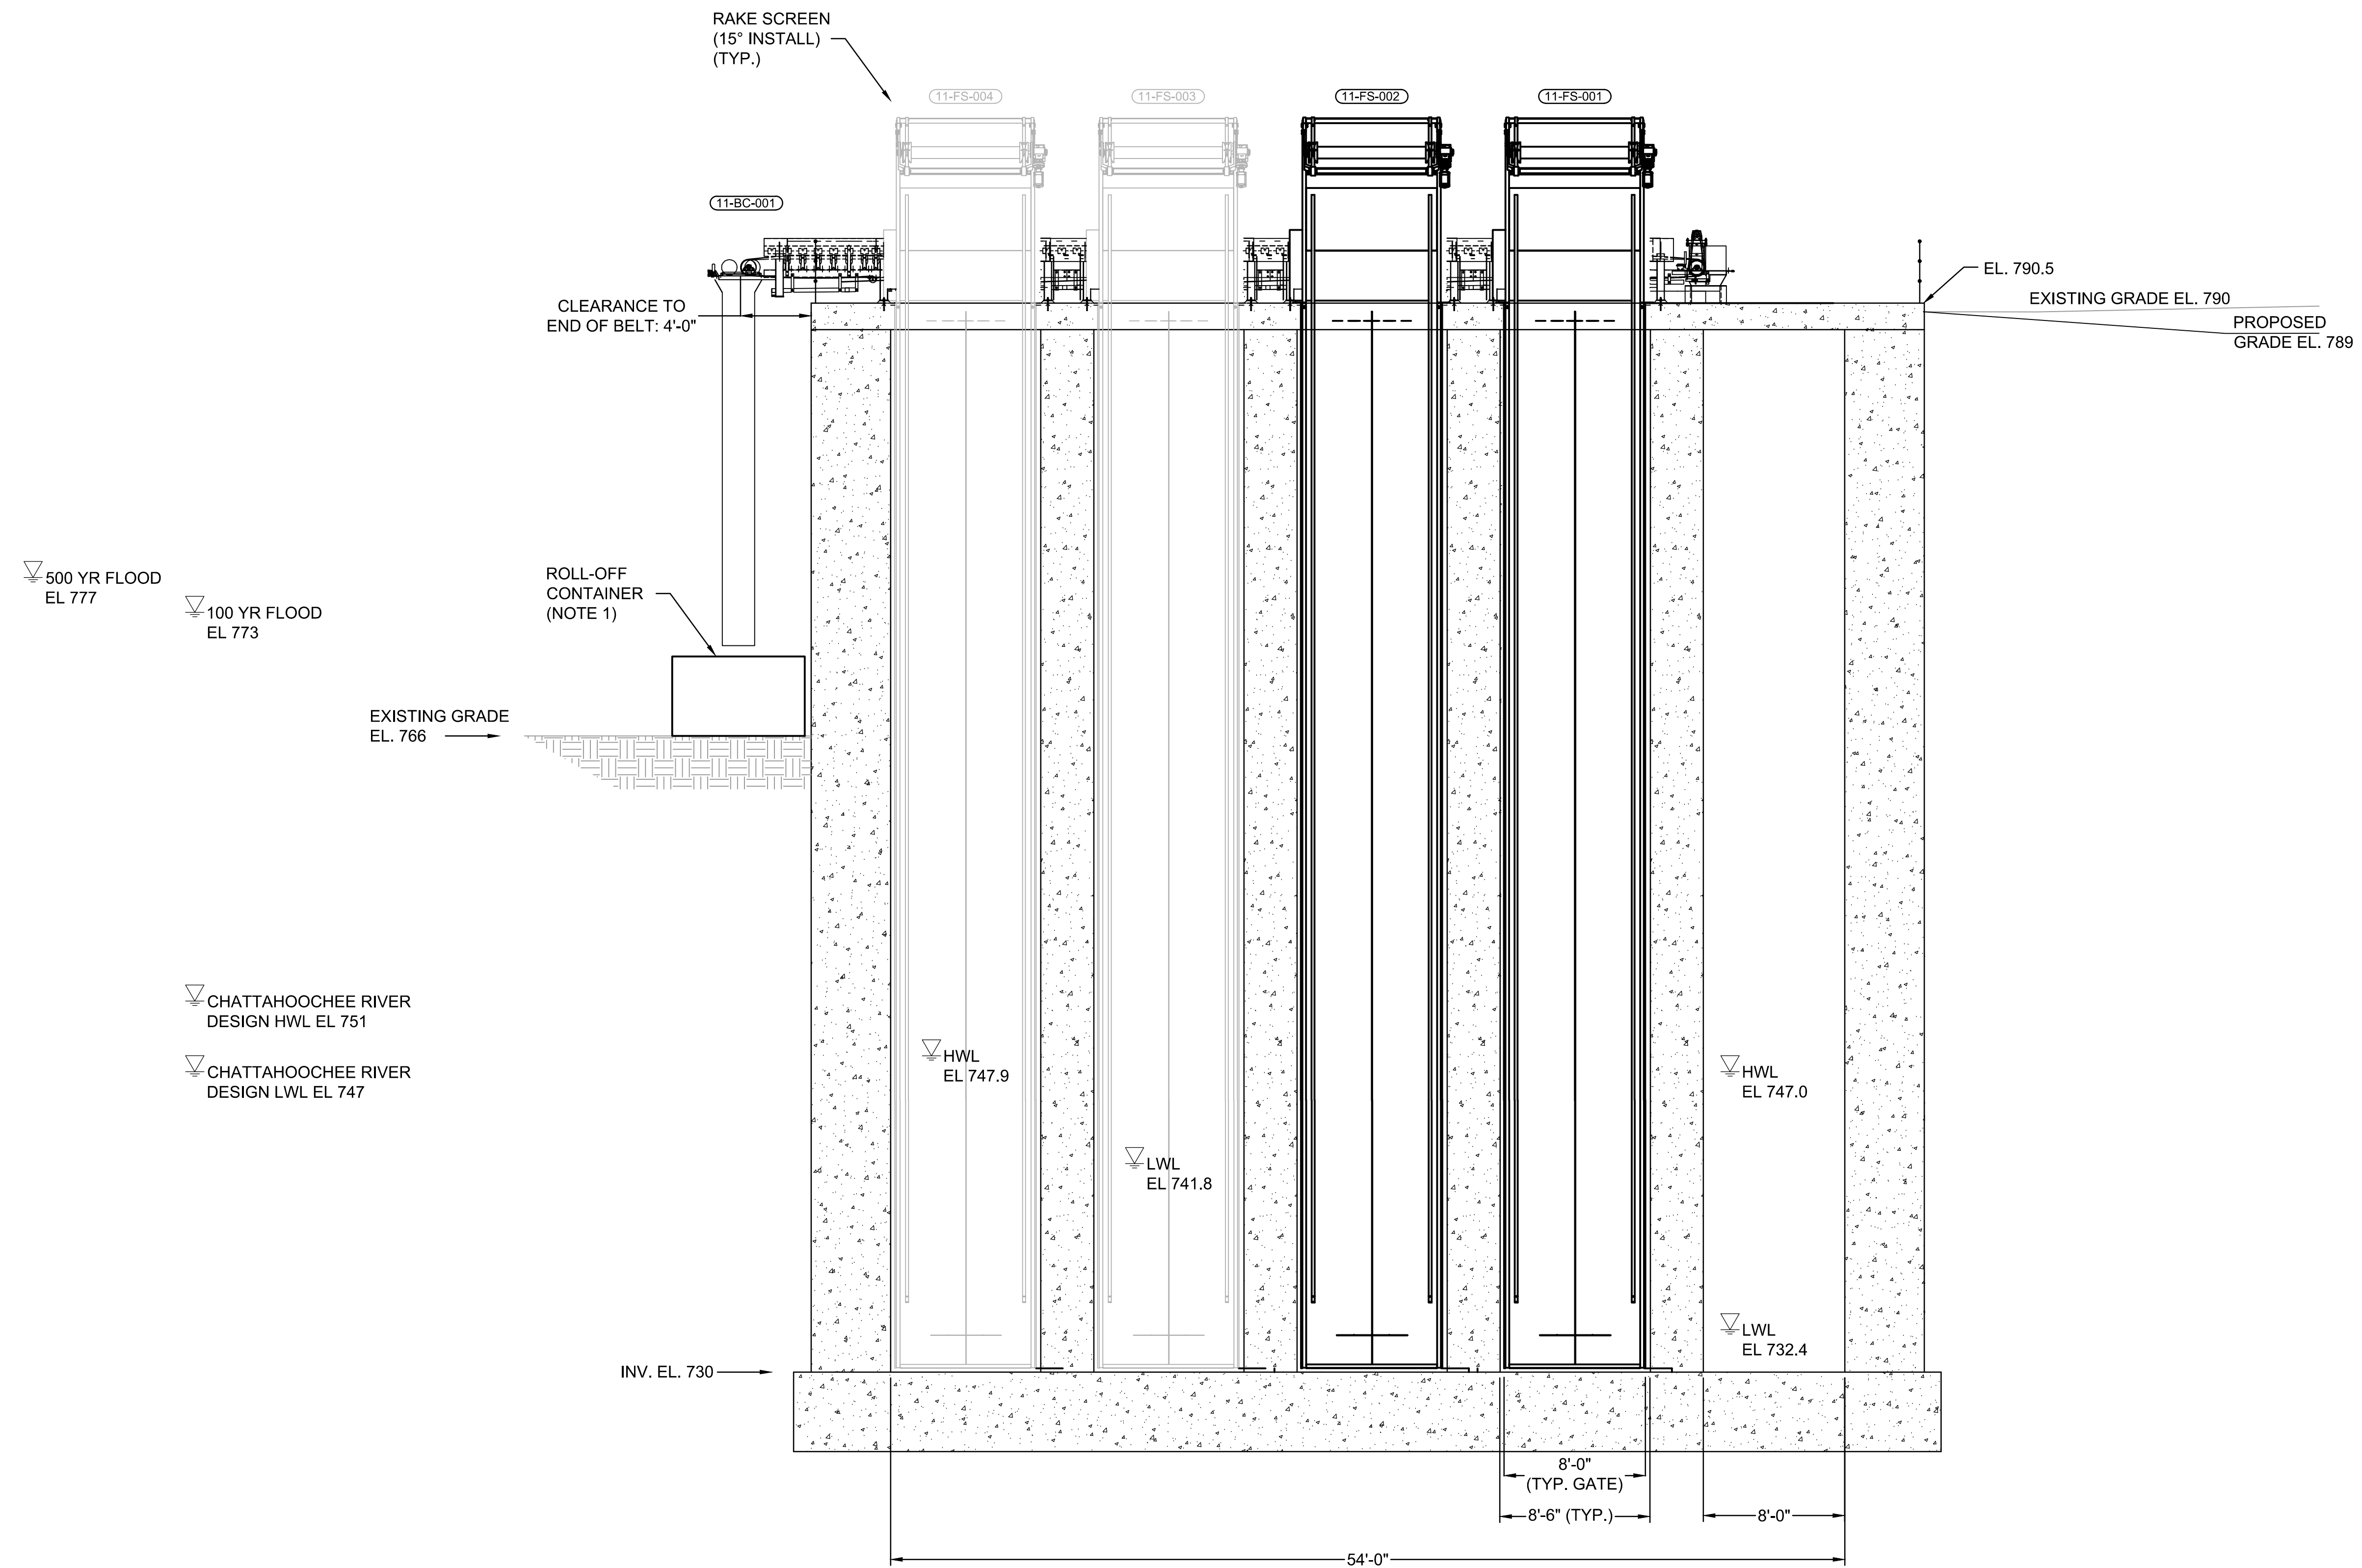


SECTION C
3/16"=1'-0"

P:\City of Atlanta - Water Supply Program Phase 1\CD Drawings\PROCESS\RI-PS DP2-003.dwg, PRINTED BY: Holly Barnes ON Thu, Dec 05, 2019 AT 8:56 AM



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ADDRESS:
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6 CONCOURSE PARKWAY
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ATLANTA, GA 30328
(770) 569-7038 x101
FAX: (770) 993-5082




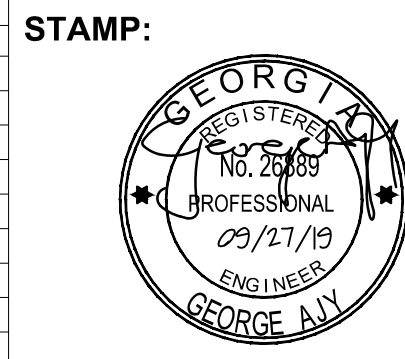
PROJECT NO:	TASK_13
DESIGNED BY:	A.T.
DRAWN BY:	H.B.
CHECKED BY:	G.A.
DATE:	09/27/19
SCALE:	AS NOTED

CITY OF ATLANTA DEPT. OF WATERSHED MANAGEMENT
WATER SUPPLY PROGRAM
RIVER INTAKE PUMP STATION
PUMP STATION
SECTION


DRAWING NO.
RI-PS
DP2-003
SHEET OF

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ADDRESS:
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 6 CONCOURSE PARKWAY
 SUITE 1600
 ATLANTA, GA 30328
 (770) 569-7038 x101
 FAX: (770) 993-5082

PROJECT NO:	TASK_13
DESIGNED BY:	A.T.
DRAWN BY:	H.B.
CHECKED BY:	G.A.
DATE:	09/27/19
SCALE:	AS NOTED

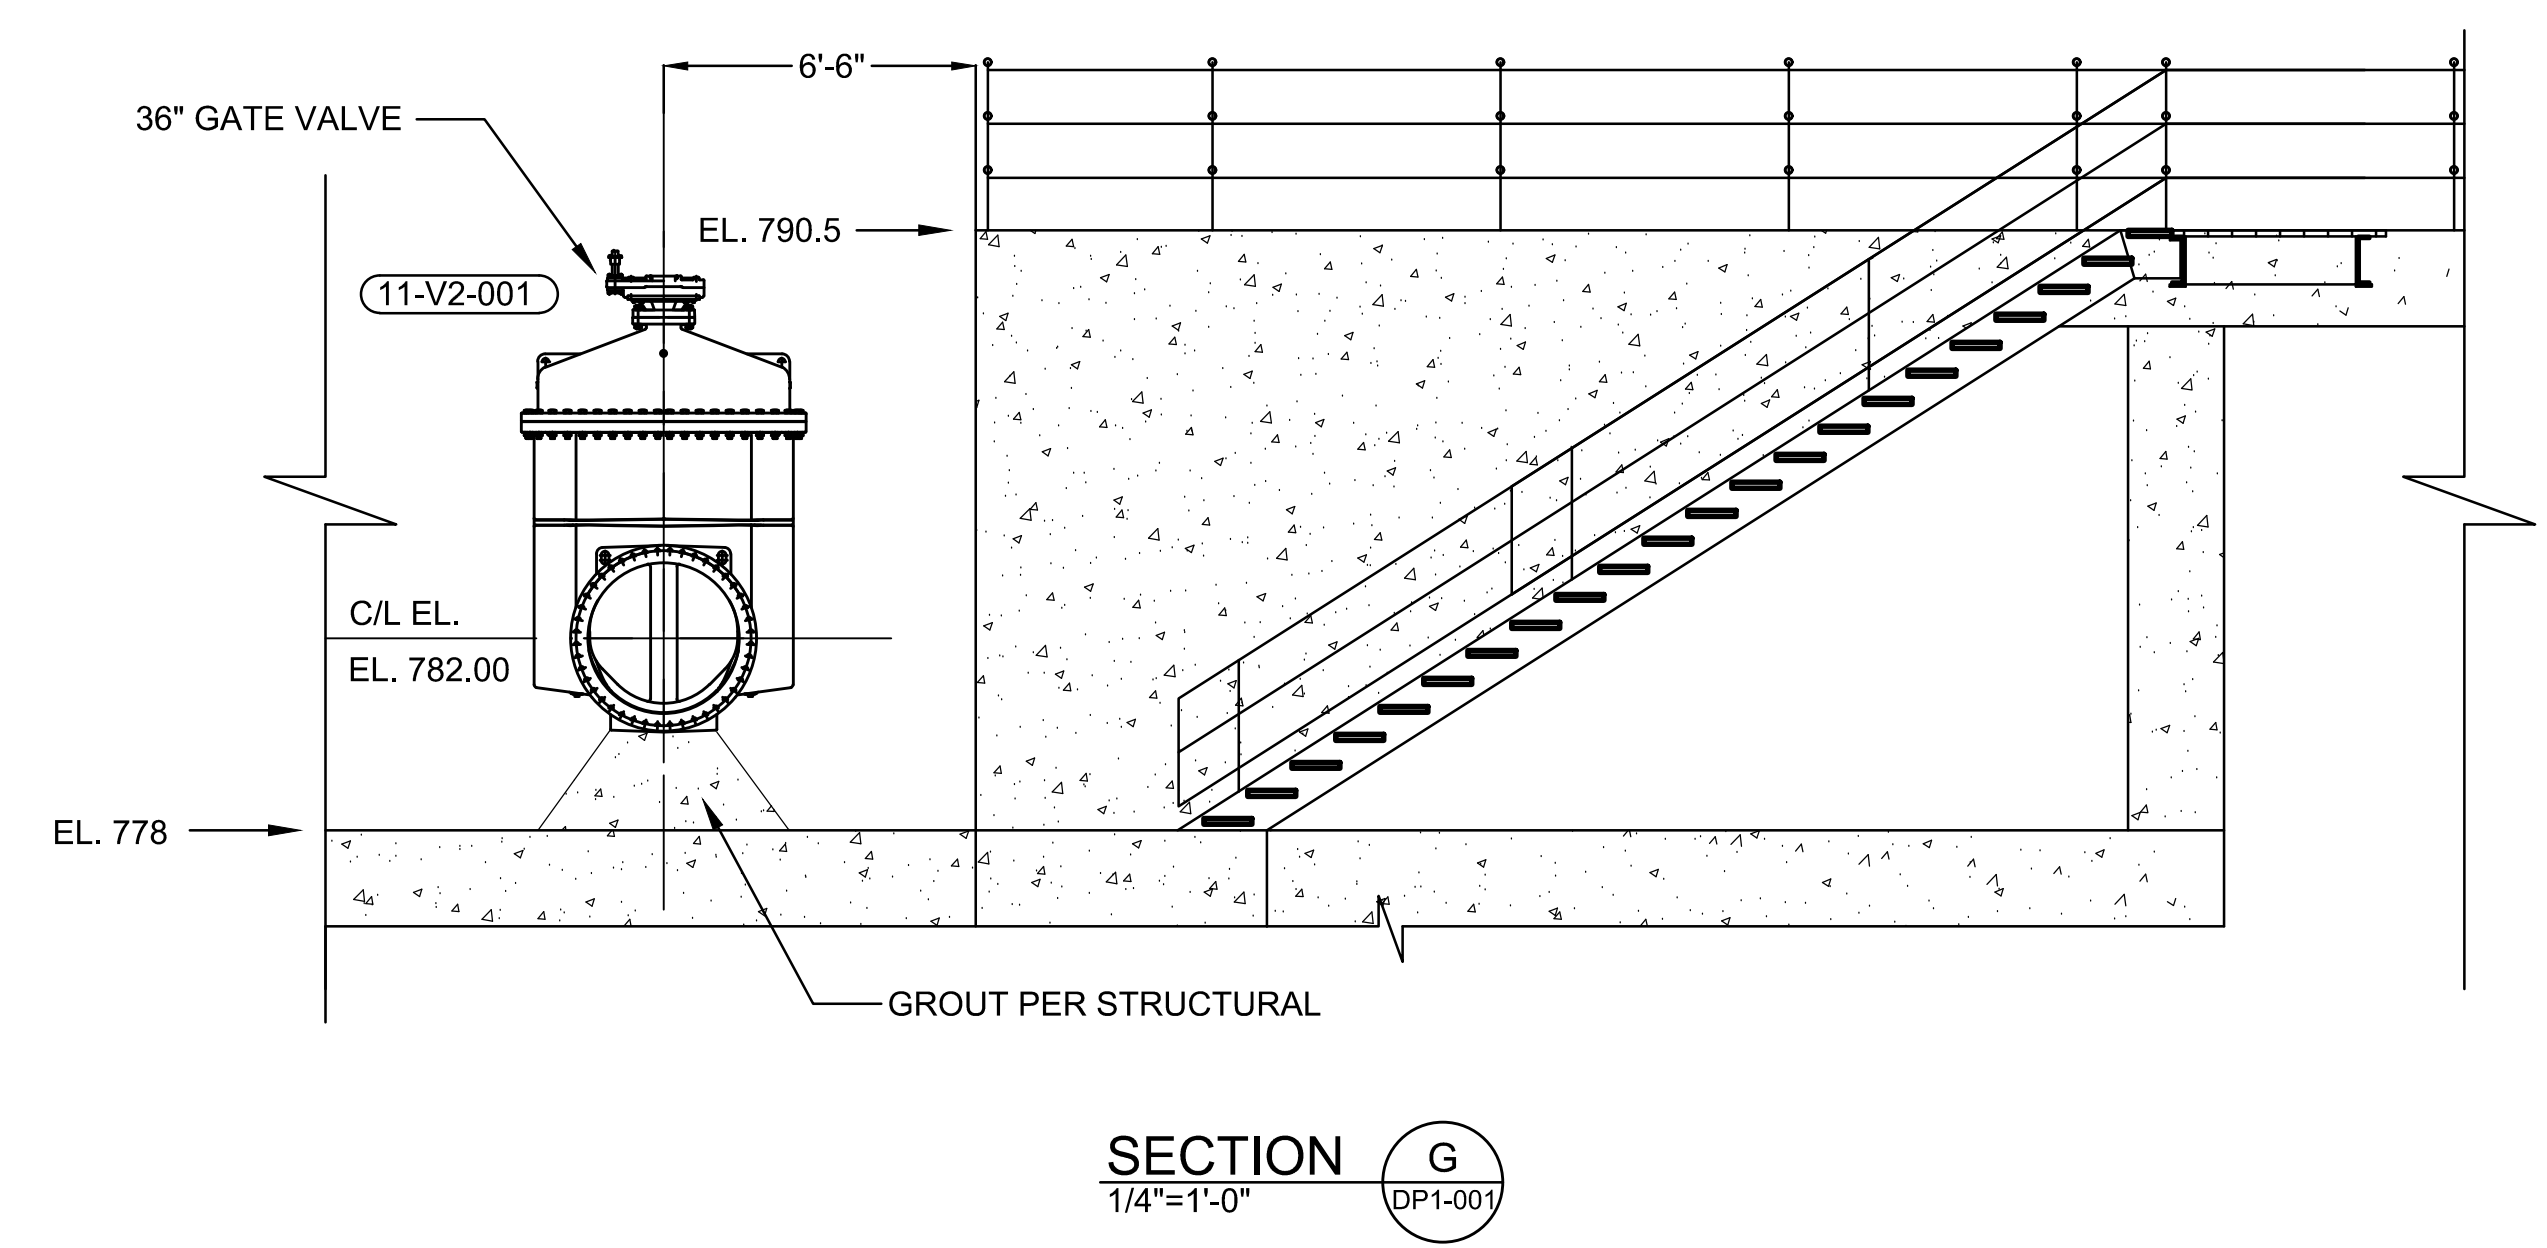
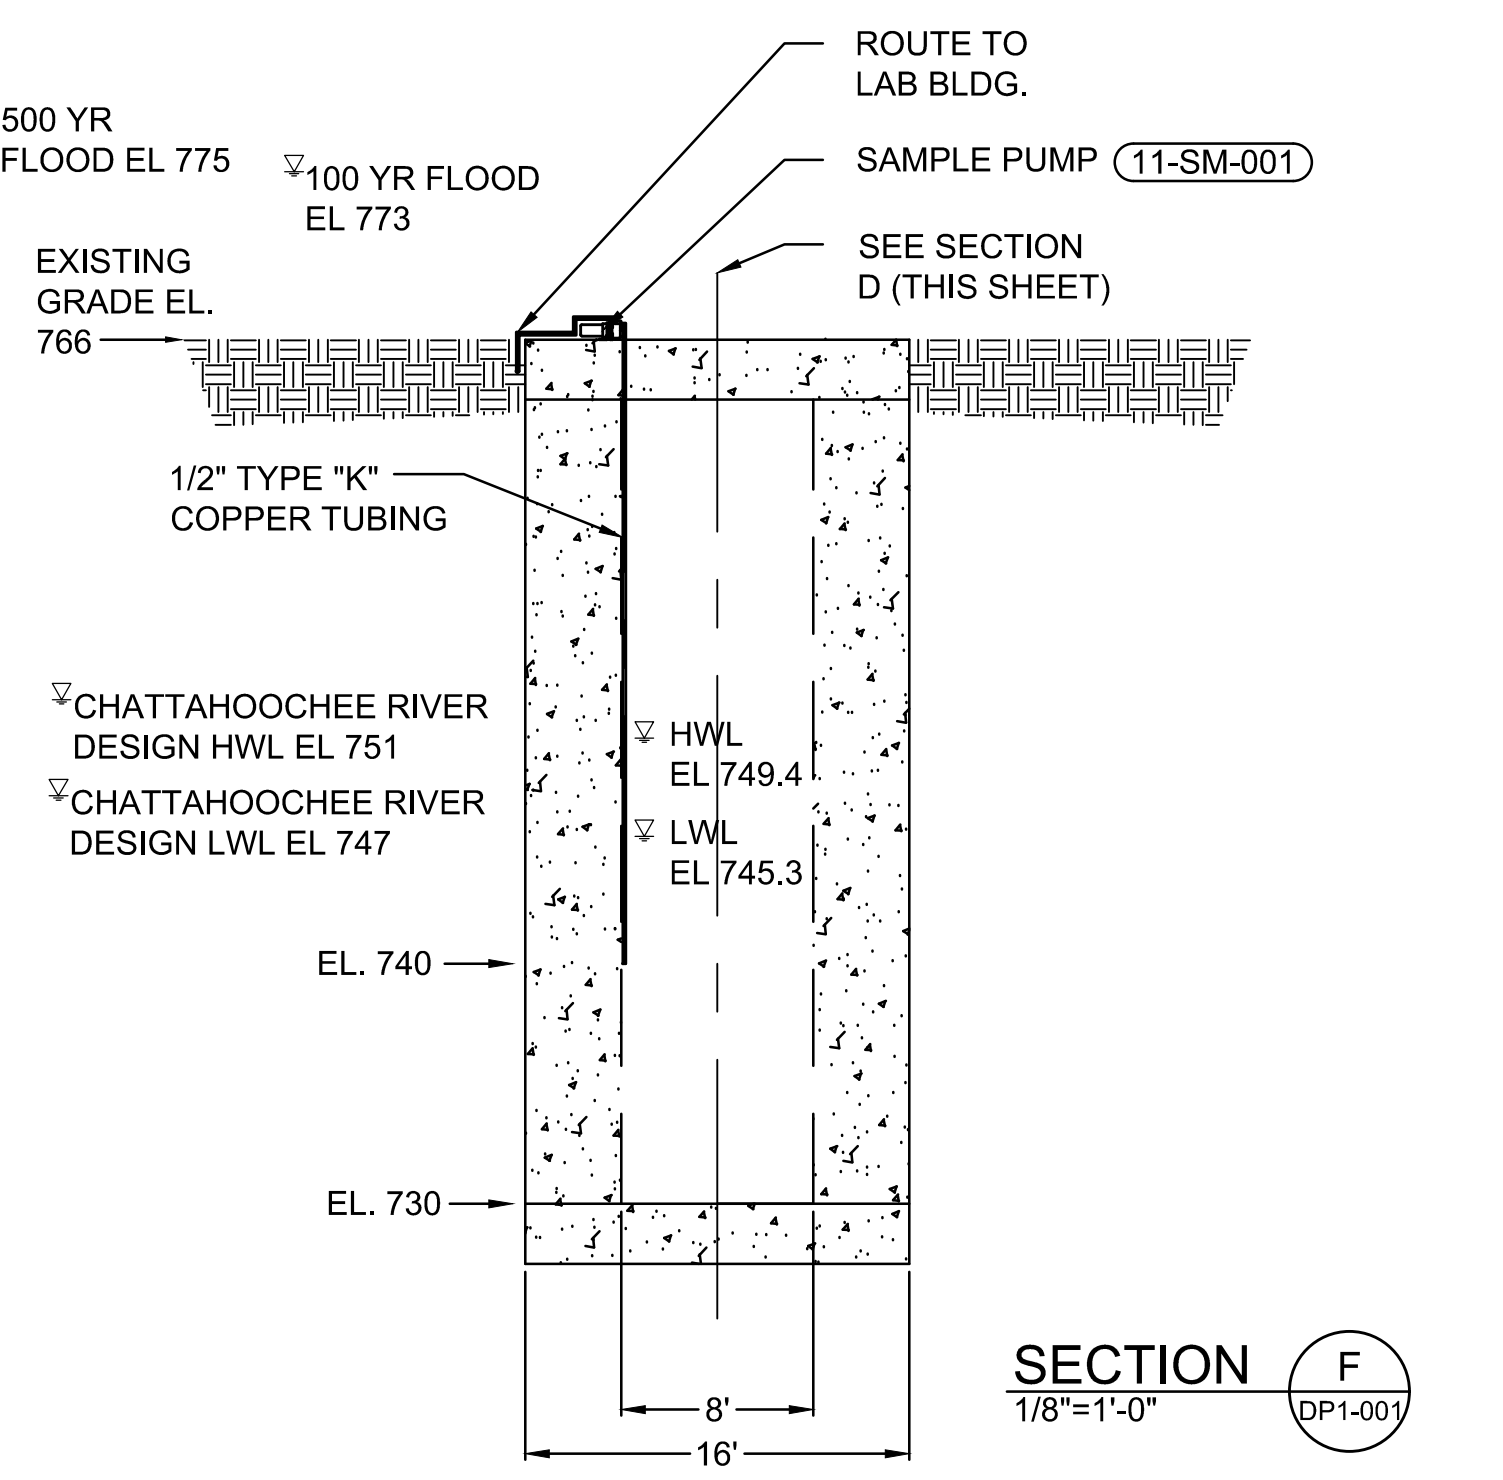
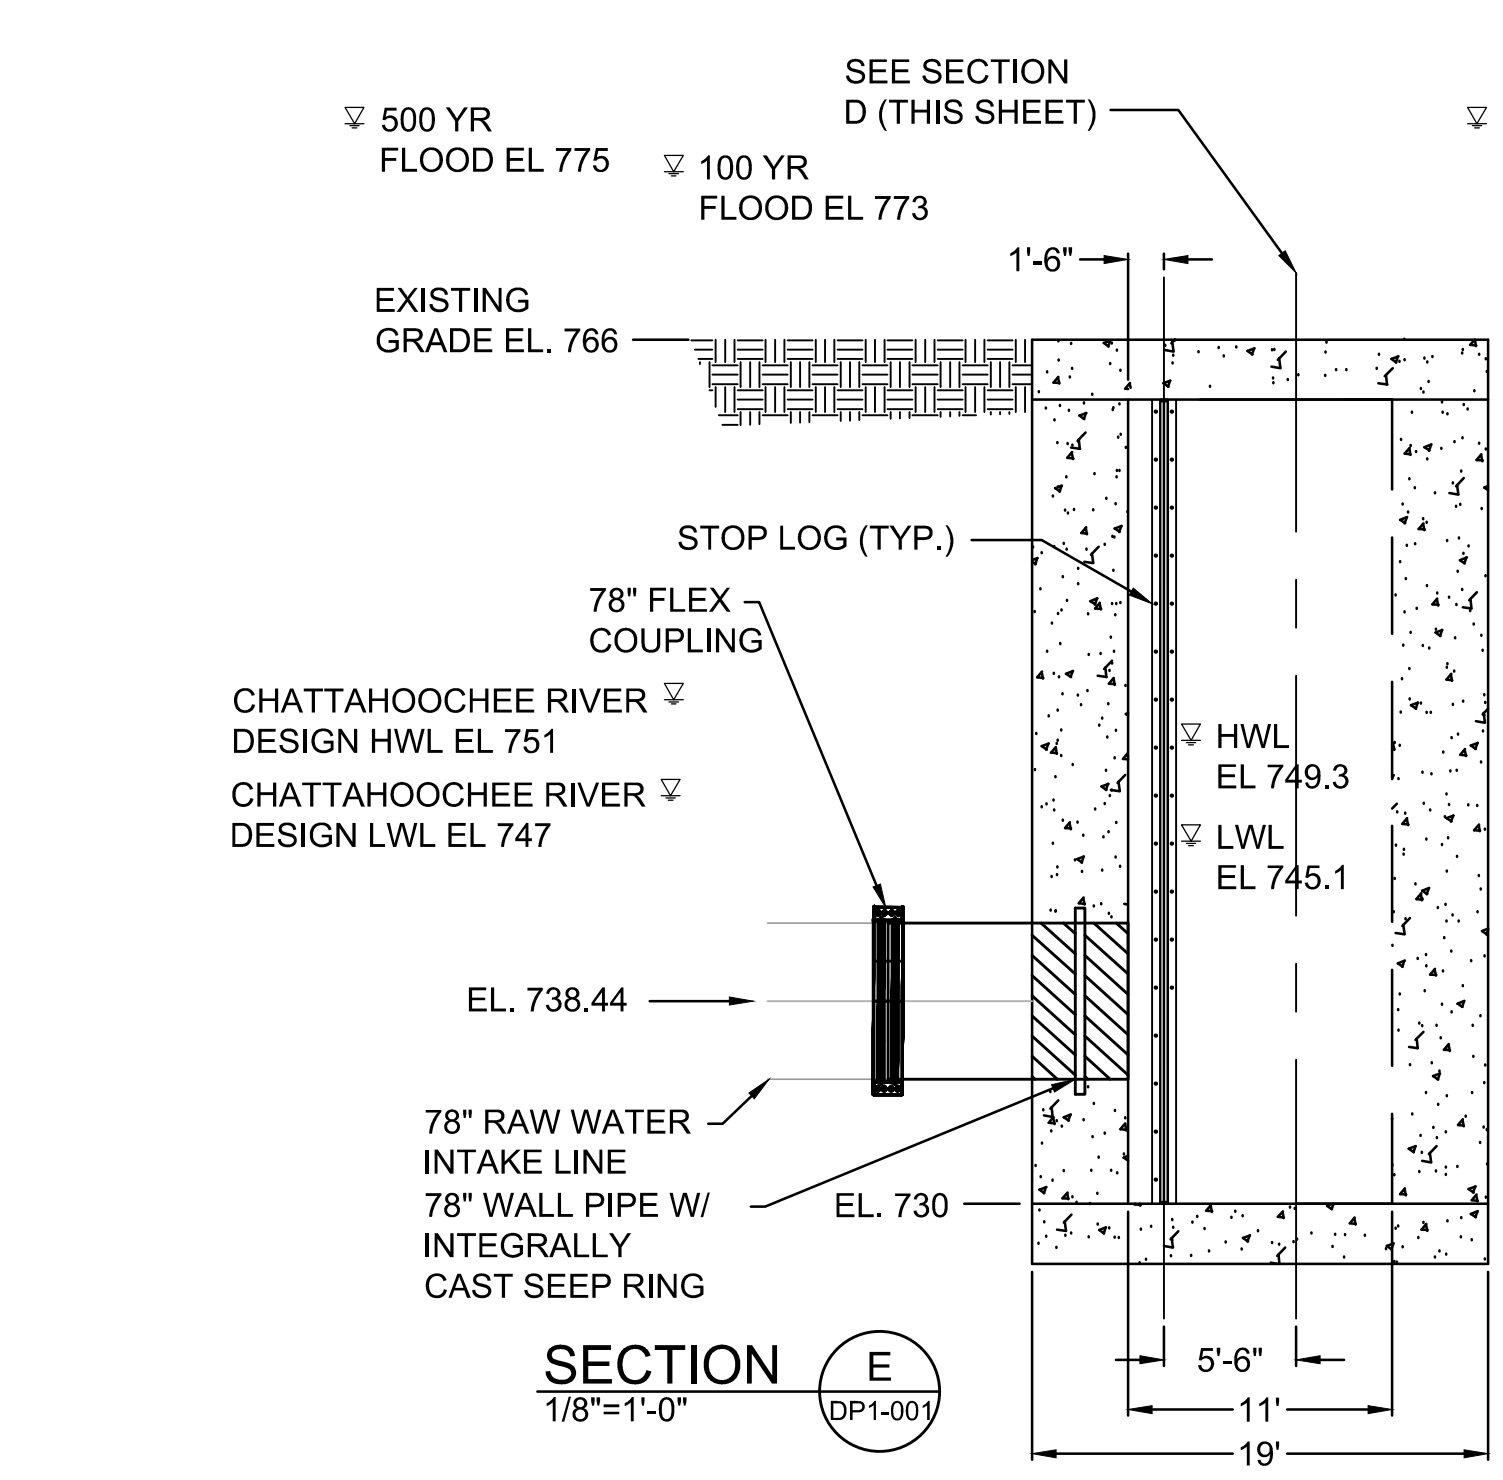
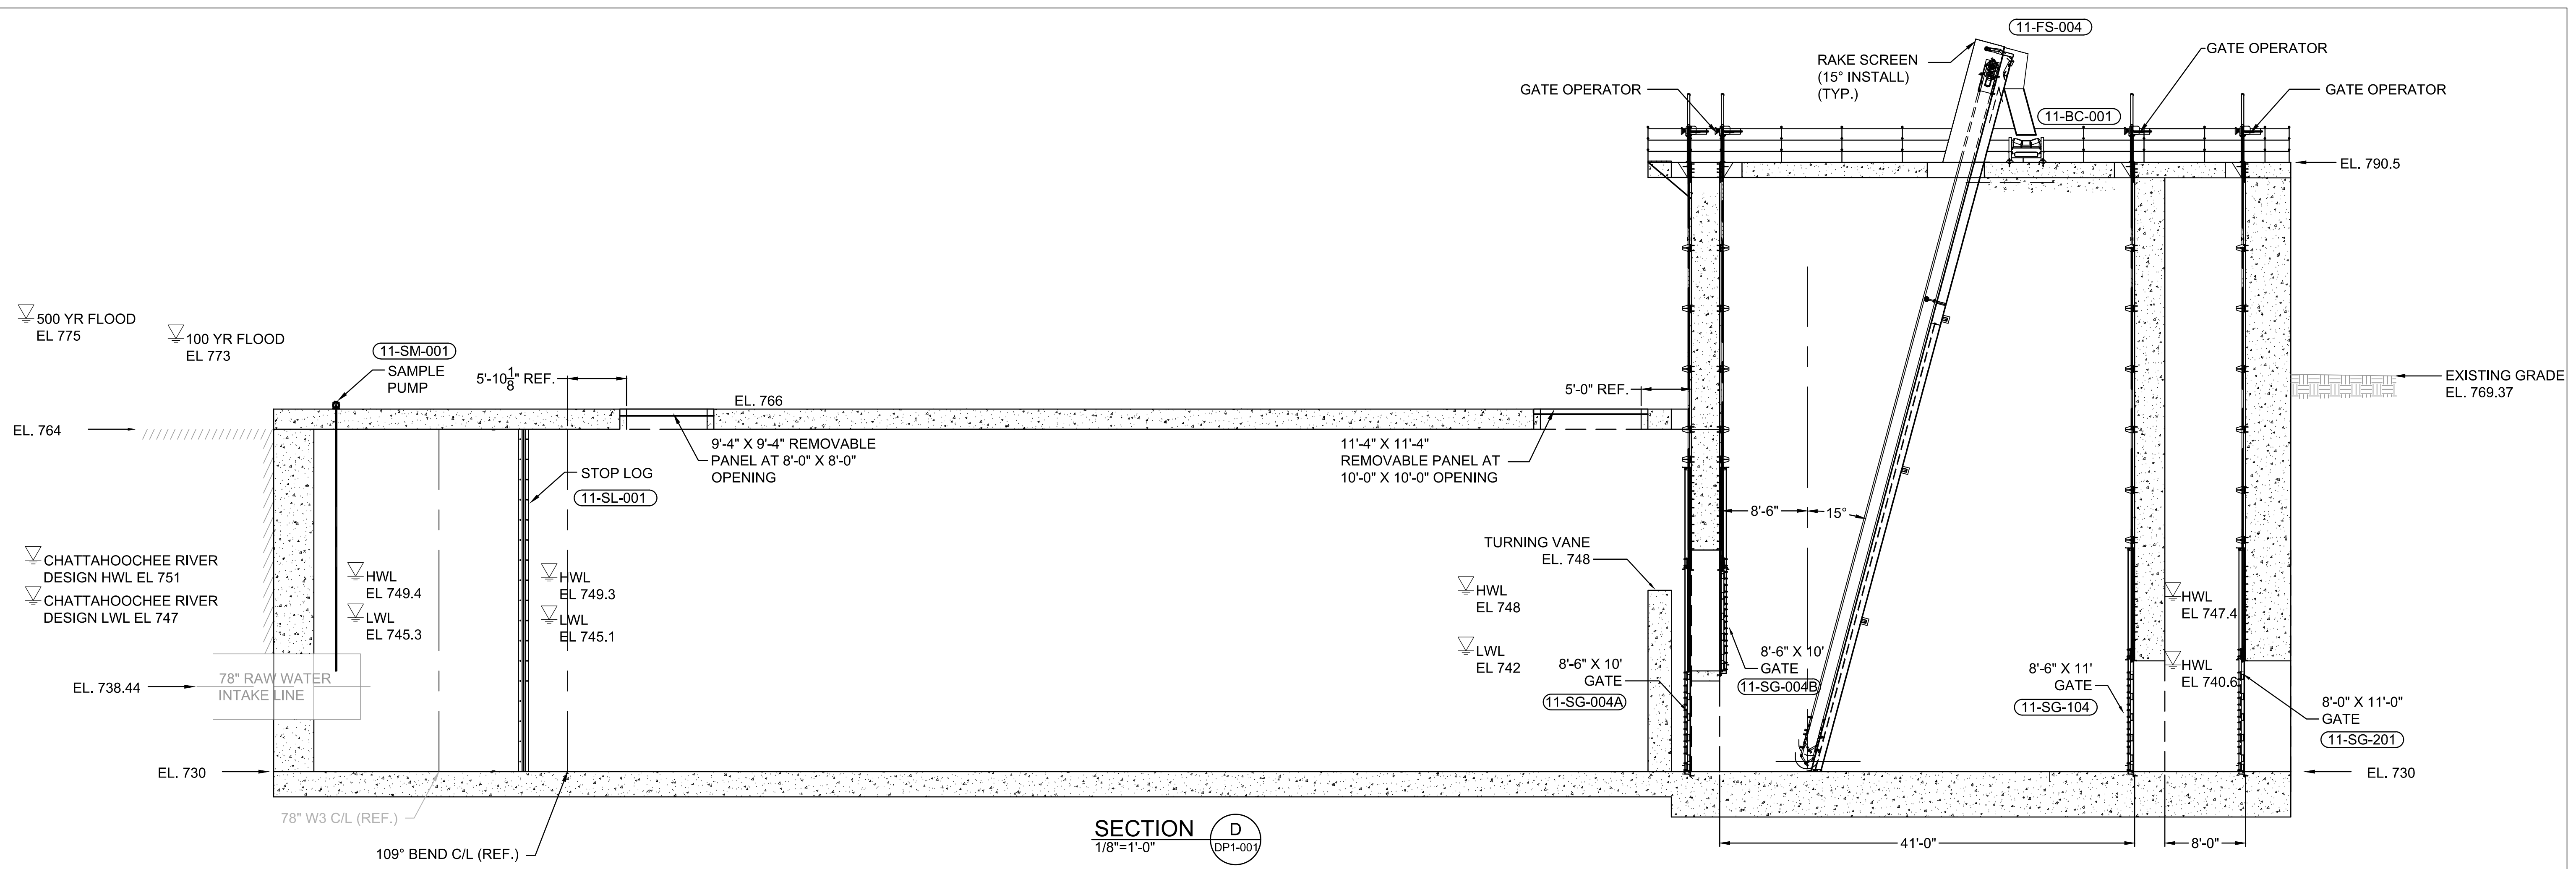
CITY OF ATLANTA DEPT. OF WATERSHED MANAGEMENT
WATER SUPPLY PROGRAM
RIVER INTAKE PUMP STATION
 PUMP STATION
 SECTION

DRAWING NO.
RI-PS
DP2-004
 SHEET OF

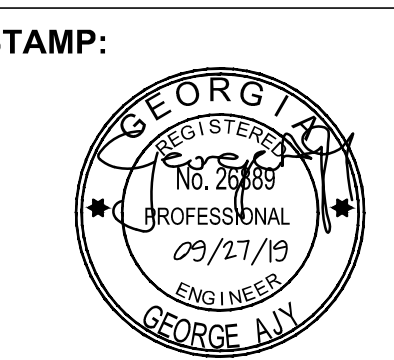ISSUED FOR BIDDING

NOTES:


1. FINAL ALIGNMENT OF THE PROPOSED 60-INCH RAW WATER MAIN MAY ALTER PENDING VERTICAL UTILITY DATA.
2. SURVEY IS SUPPLEMENTED BY ADDITIONAL INFORMATION AS RECEIVED FROM CITY OF ATLANTA GIS AND AS-BUILTS. CONTRACTOR TO VERIFY THE LOCATION OF ALL EXISTING UTILITIES.
3. CONNECTIONS TO EXISTING TEES AND SERVICE CONNECTIONS MAY REQUIRE ADDITIONAL FITTINGS NOT SPECIFIED HEREON. ADDITIONAL INTERCONNECTIONS MAY BE PRESENT, THOUGH NOT DEPICTED HERE, AND SHALL BE RE-ESTABLISHED.
4. THE CONTRACTOR SHALL COMPLY WITH ALL OSHA REGULATIONS WHEN WORKING WITHIN THE IMMEDIATE VICINITY OF POWER POLES, POWER LINES, ETC.
5. YARD PIPING SHALL MAINTAIN EIGHTEEN (18) INCHES VERTICAL CLEARANCE FROM NON-POTABLE PIPELINES, TWENTY-FOUR (24) INCHES FROM ANY EXISTING GAS MAIN GREATER THAN TWO (2) INCHES, AND THIRTY-SIX (36) INCHES FROM ANY EXISTING PERPENDICULAR CROSSING OF GRAVITY AND FORCE MAINS. (MEASURED FROM OUTSIDE OF PIPE TO OUTSIDE OF PIPE.)

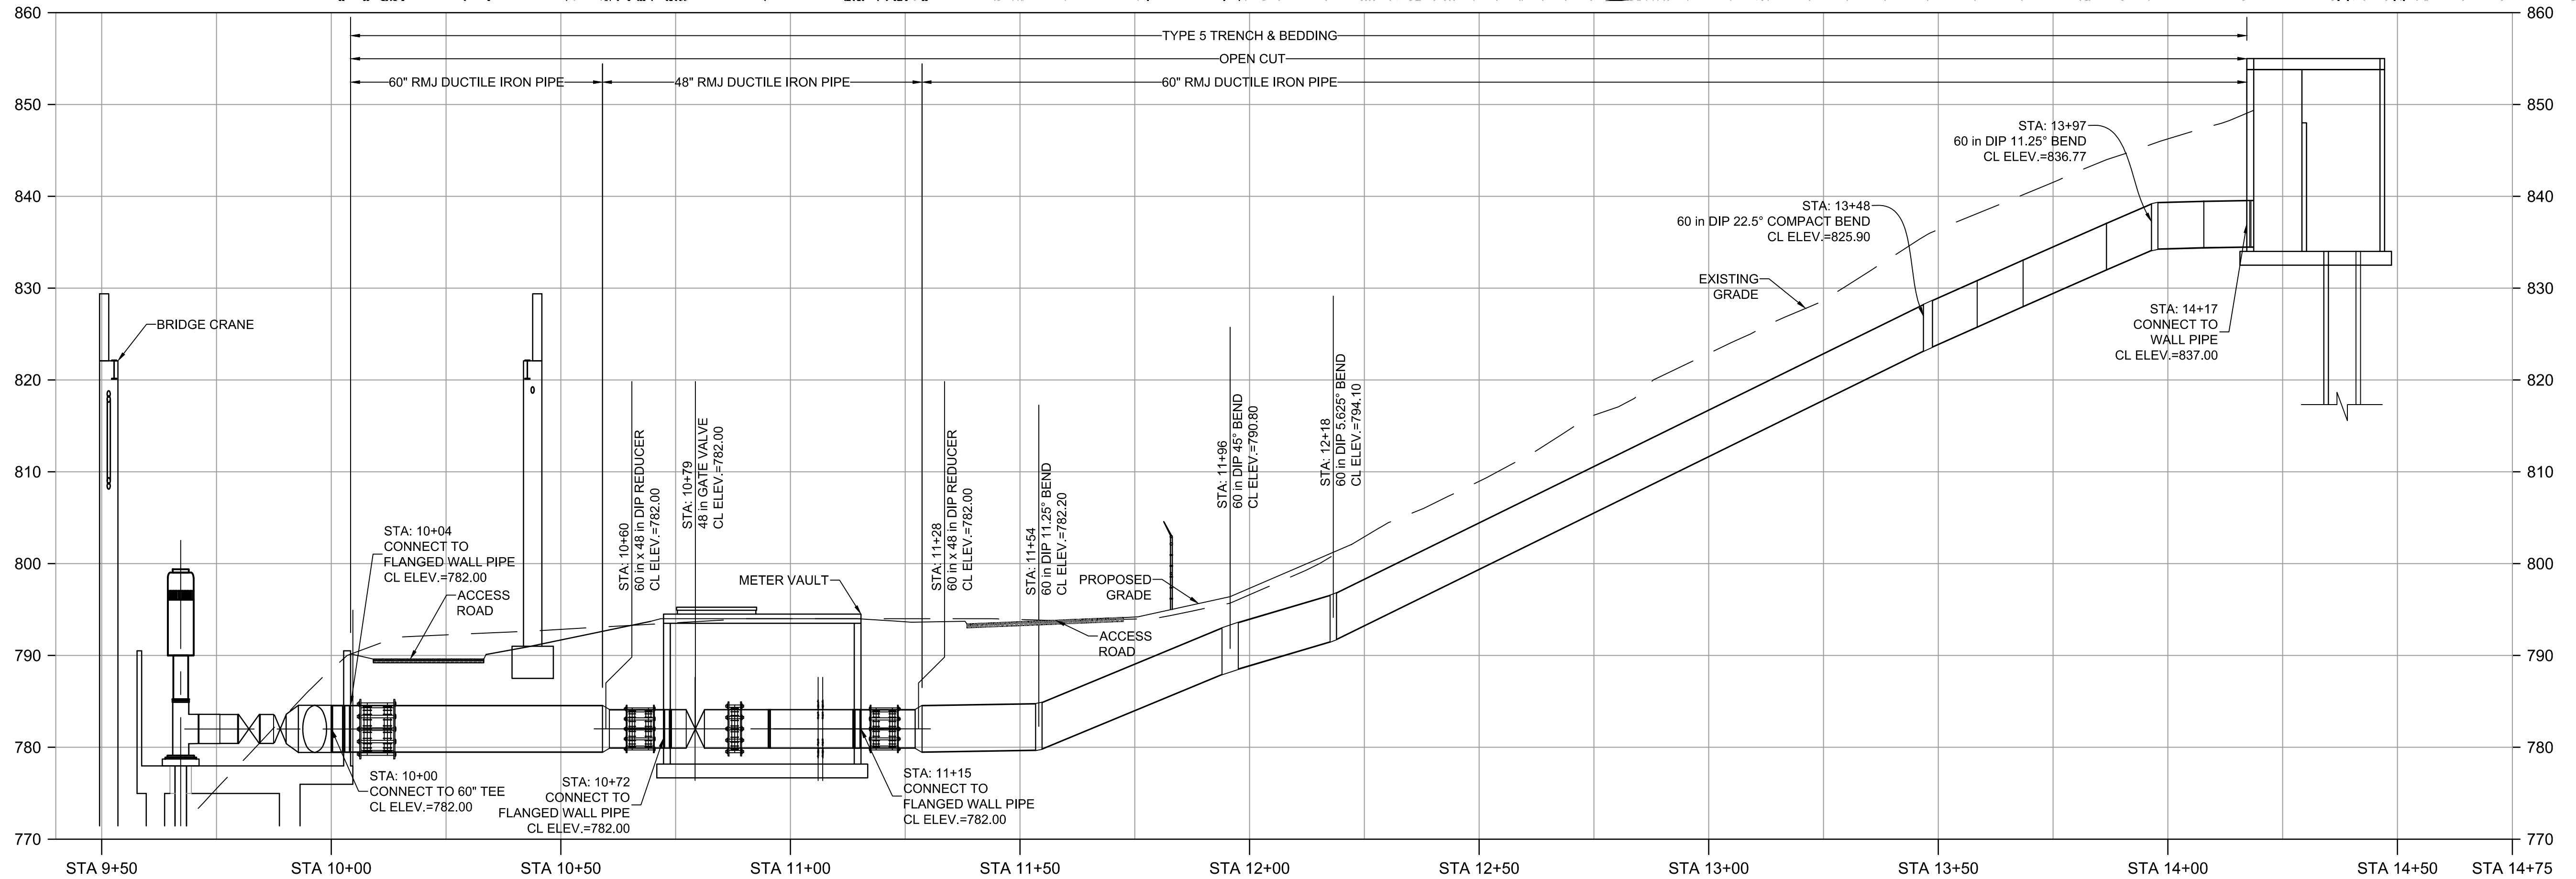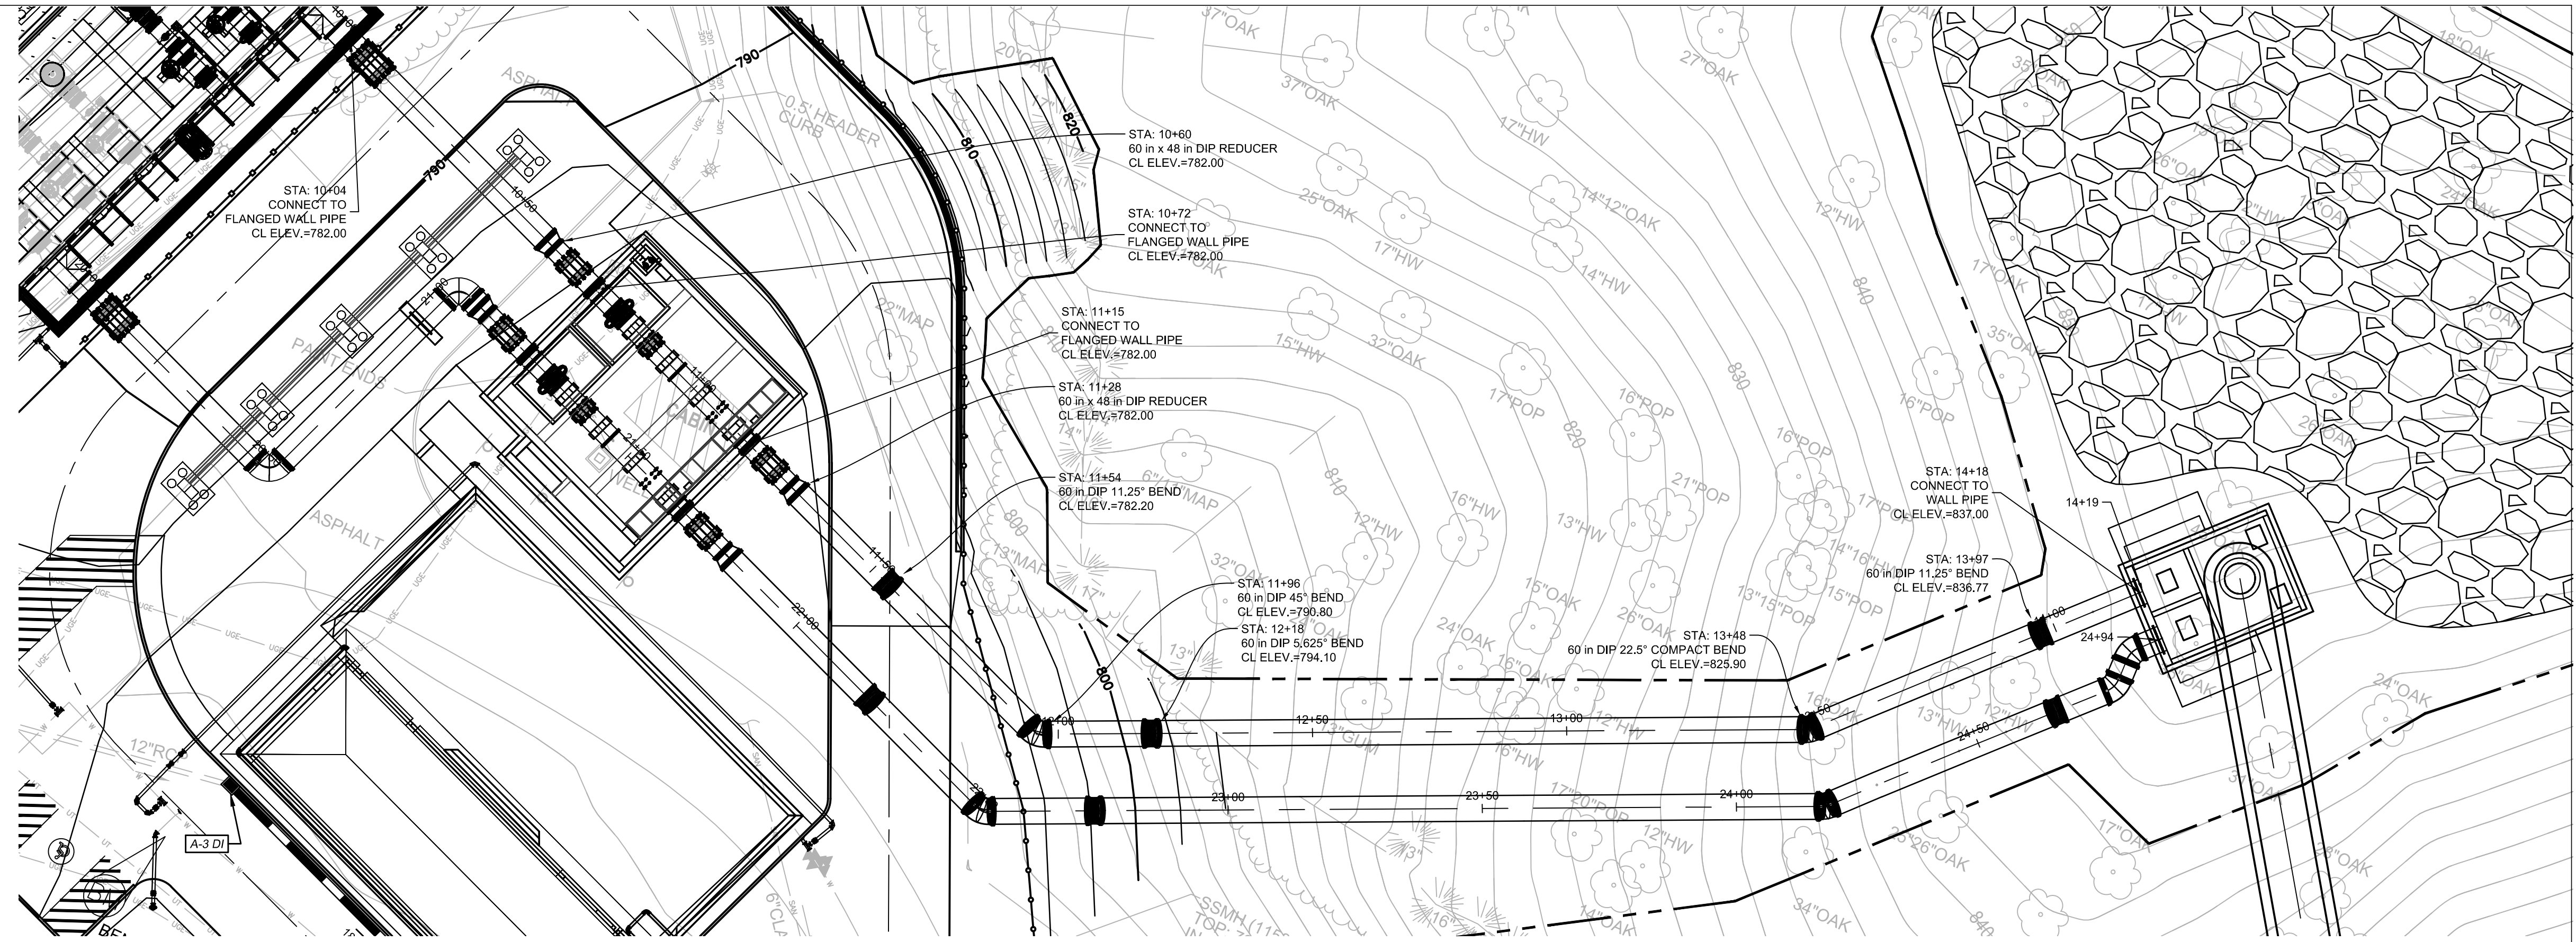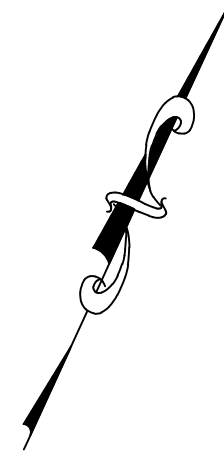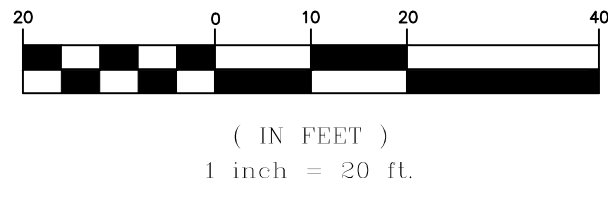

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ADDRESS:
 BGR2-JV
 6 CONCOURSE PARKWAY
 SUITE 1600
 ATLANTA, GA 30328
 (770) 569-7038 x101
 FAX: (770) 993-5082

PROJECT NO:	TASK_13
DESIGNED BY:	A.T.
DRAWN BY:	J.J.
CHECKED BY:	G.A.
DATE:	09/27/19
SCALE:	AS NOTED




**CITY OF ATLANTA DEPT. OF WATERSHED MANAGEMENT
 WATER SUPPLY PROGRAM**
**RIVER INTAKE PUMP STATION
 YARD PIPING
 PLAN & PROFILE**

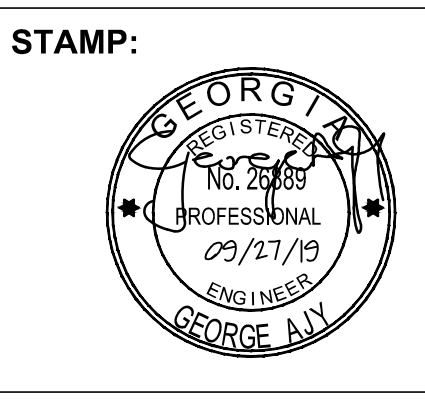DRAWING NO.
RI-PS
 DS1-001
 SHEET OF

ISSUED FOR BIDDING

NOTES:


1. FINAL ALIGNMENT OF THE PROPOSED 60-INCH RAW WATER MAIN MAY ALTER PENDING VERTICAL UTILITY DATA.
2. SURVEY IS SUPPLEMENTED BY ADDITIONAL INFORMATION AS RECEIVED FROM CITY OF ATLANTA GIS AND AS-BUILTS. CONTRACTOR TO VERIFY THE LOCATION OF ALL EXISTING UTILITIES.
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 6 CONCOURSE PARKWAY
 SUITE 1600
 ATLANTA, GA 30328
 (770) 569-7038 x101
 FAX: (770) 993-5082

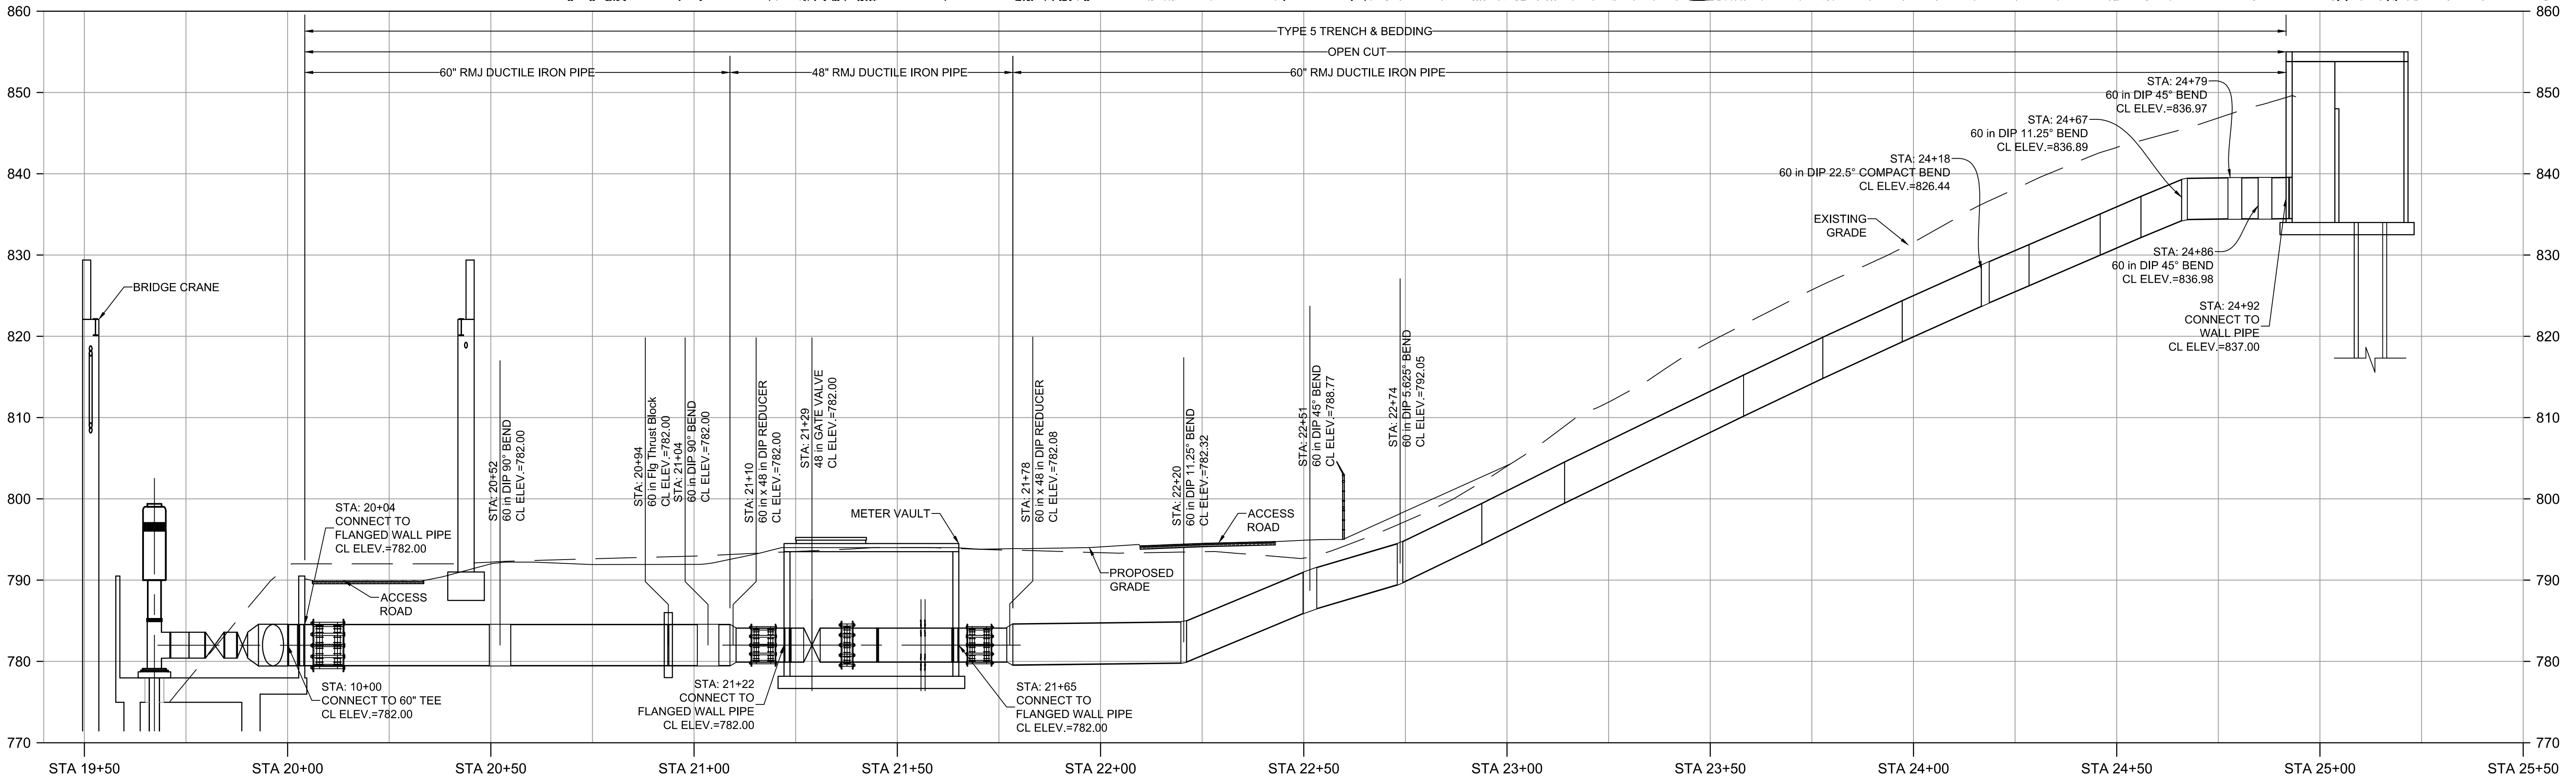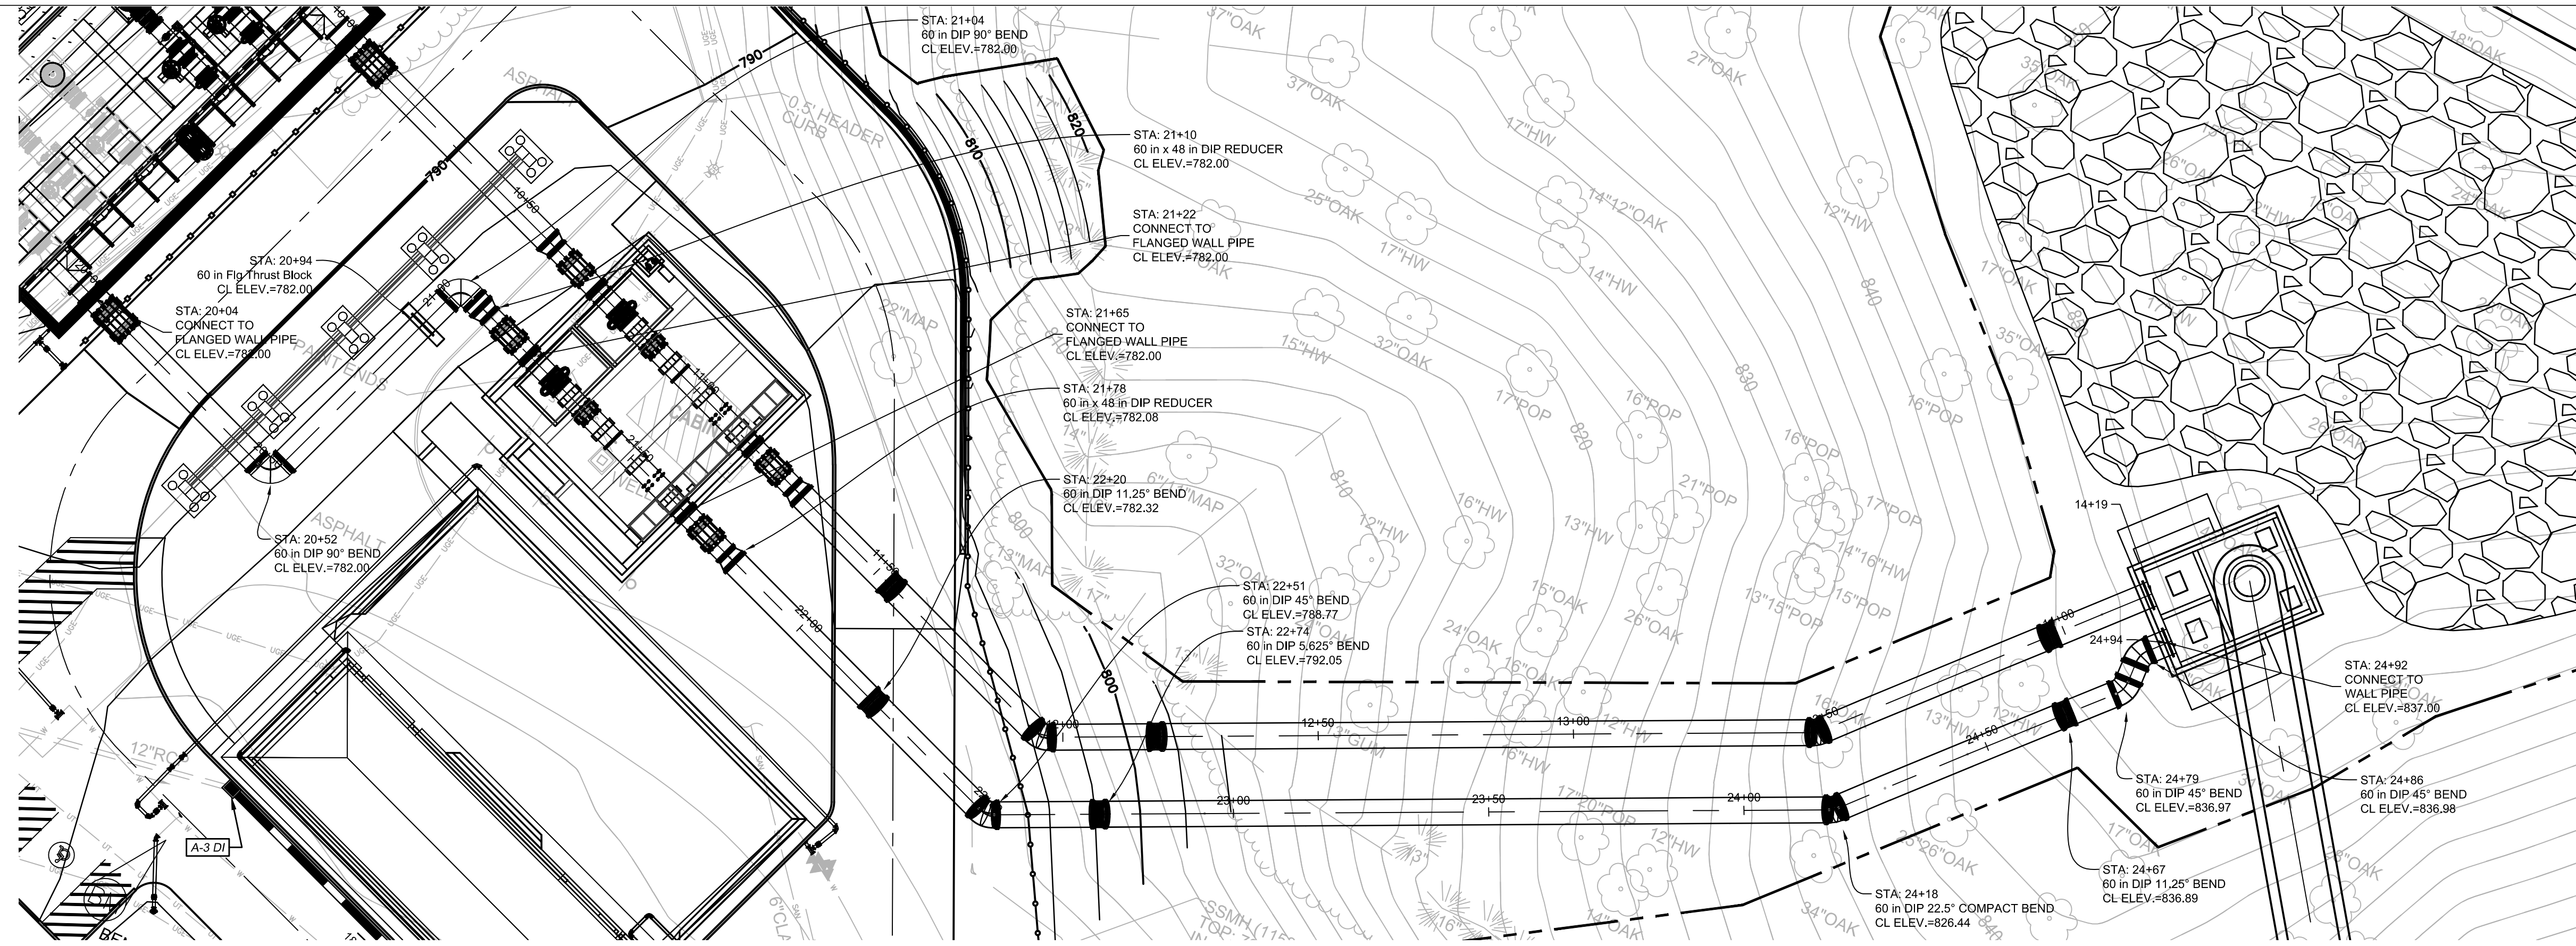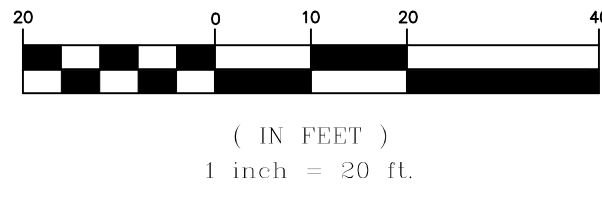PROJECT NO:	TASK_13
DESIGNED BY:	A.T.
DRAWN BY:	J.J.
CHECKED BY:	G.A.
DATE:	09/27/19
SCALE:	AS NOTED



**CITY OF ATLANTA DEPT. OF WATERSHED MANAGEMENT
 WATER SUPPLY PROGRAM**
RIVER INTAKE PUMP STATION
**YARD PIPING
 PLAN & PROFILE**

DRAWING NO.
RI-PS
DS1-002
SHEET OF

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NOTES:
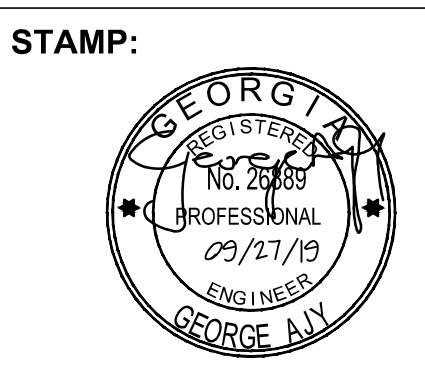
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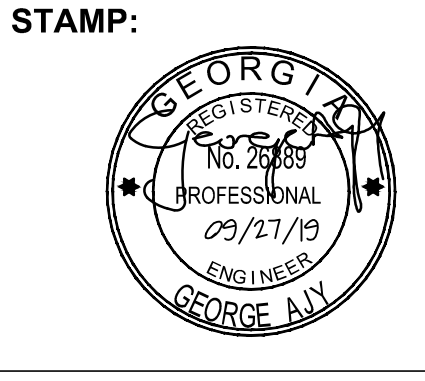


CONNECTION AT RIVER INTAKE 1
SCALE: 1" = 5'-0"
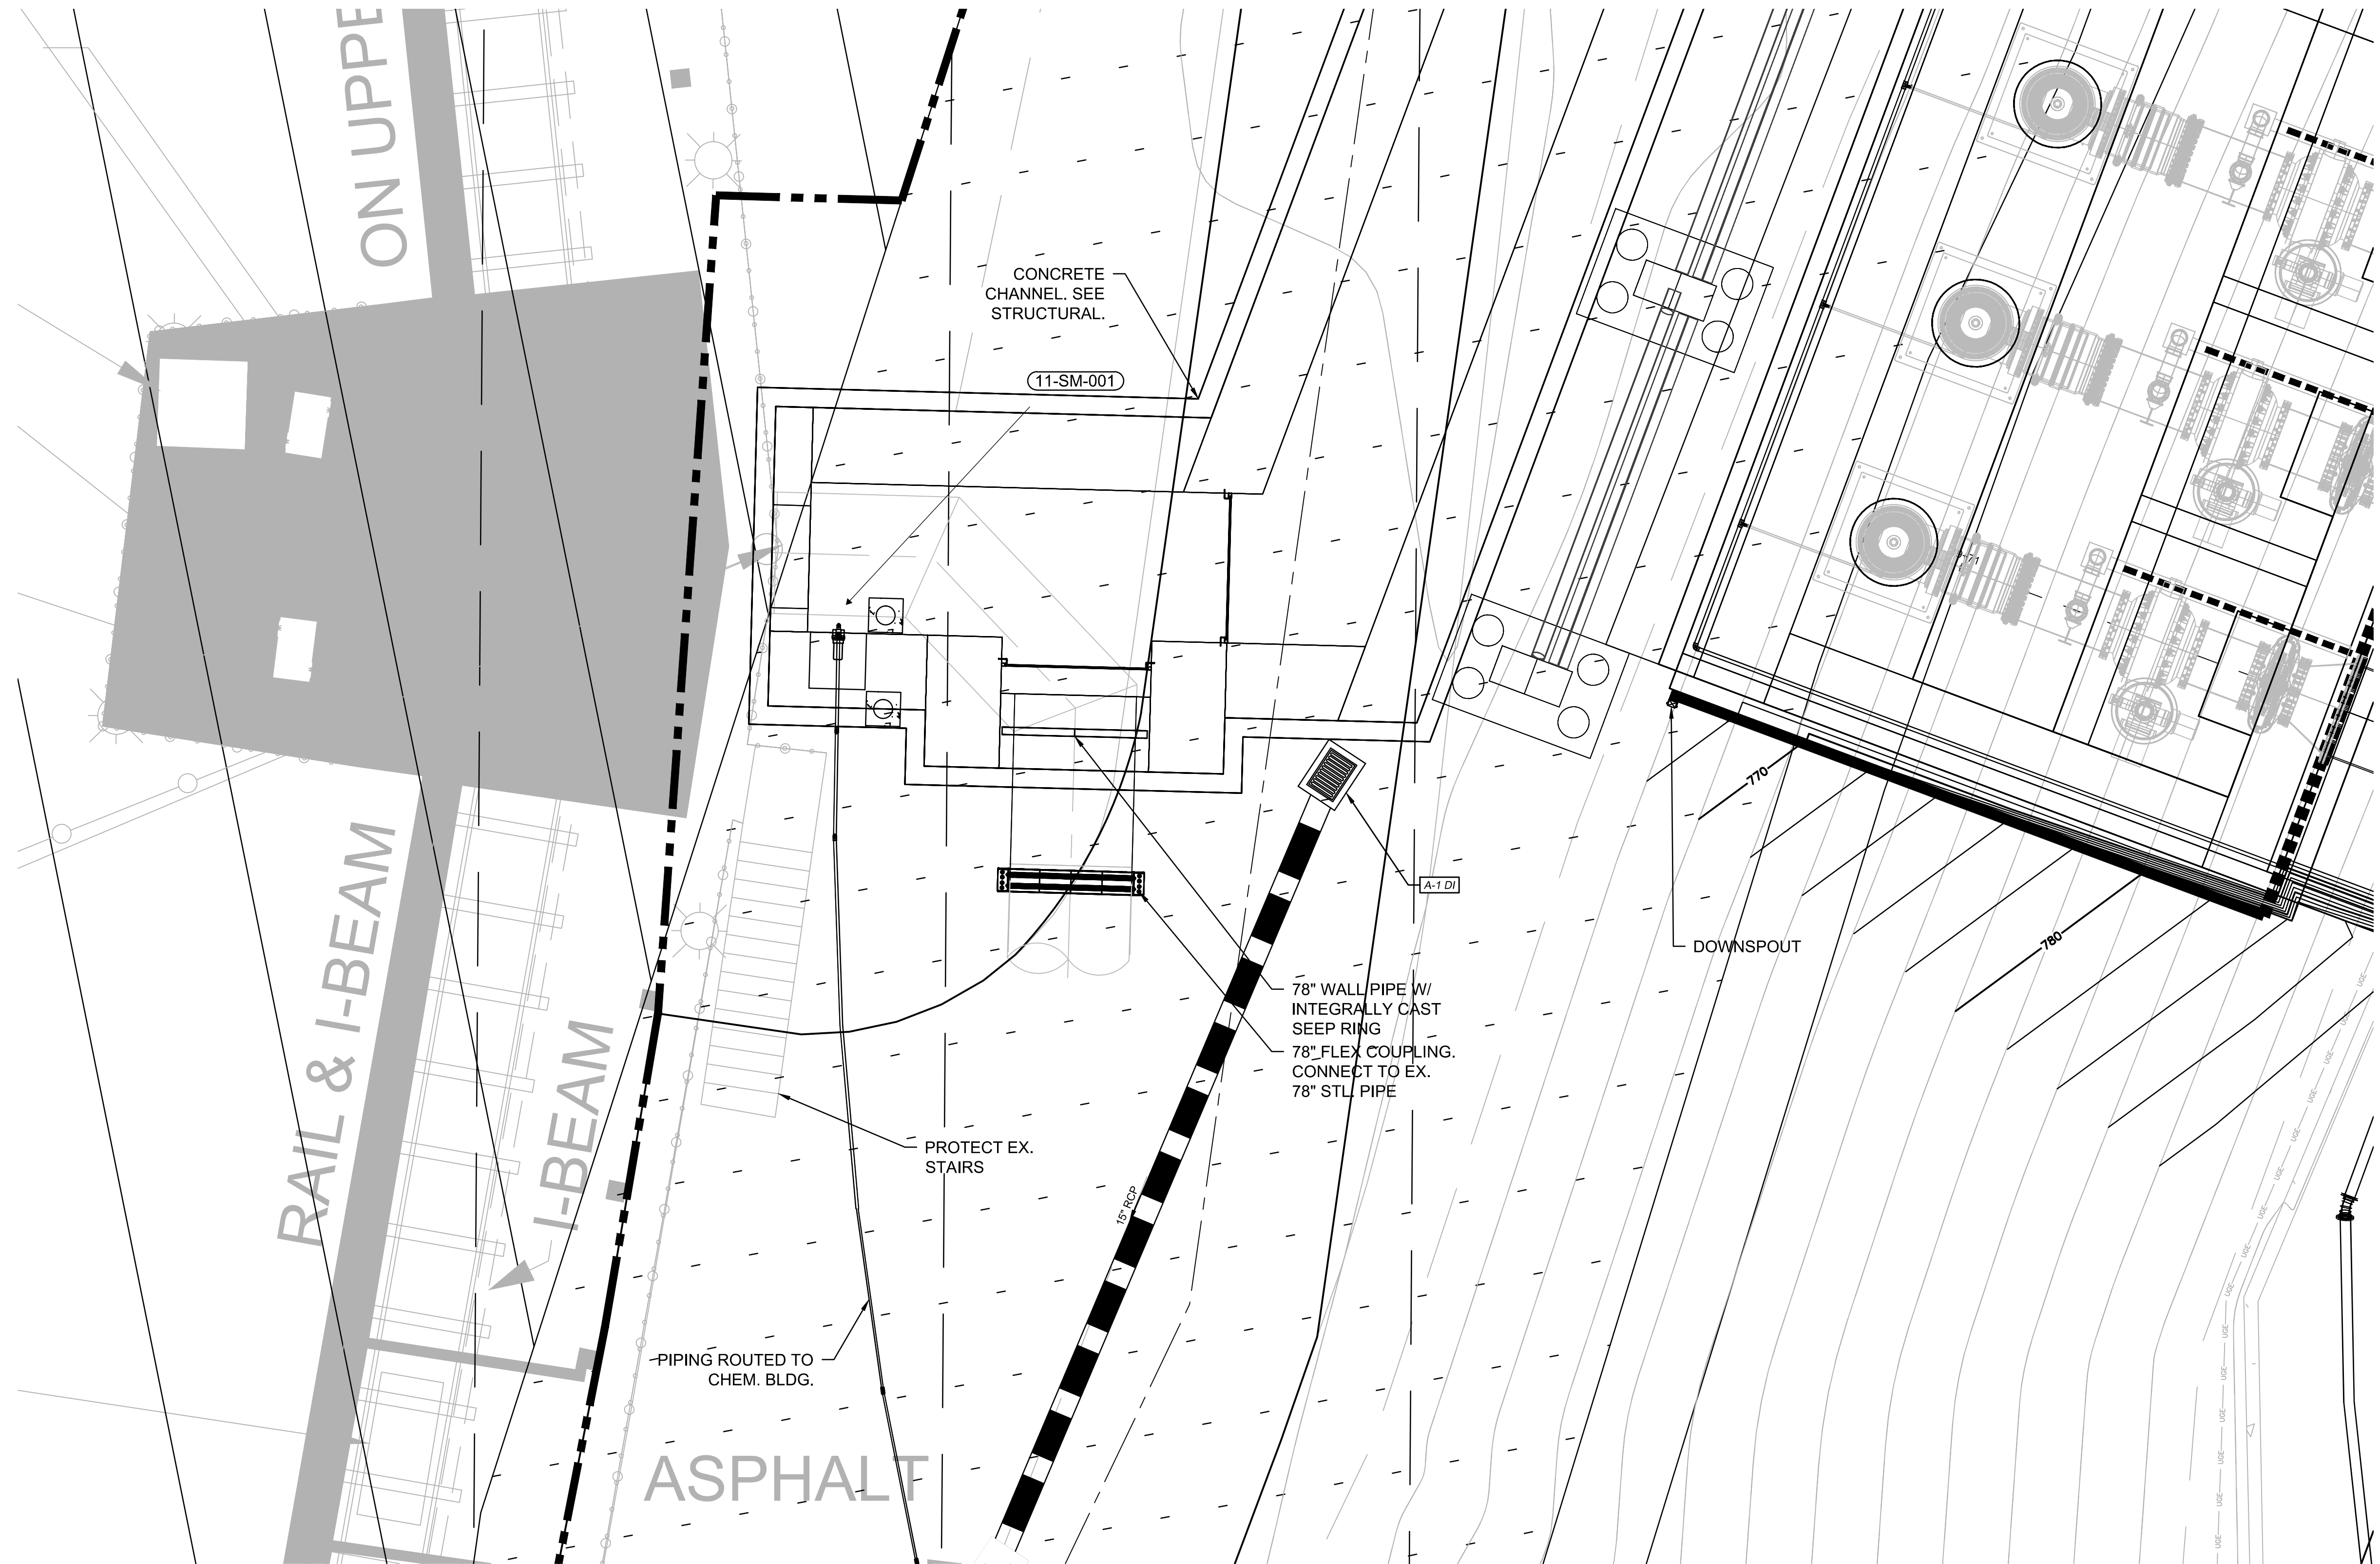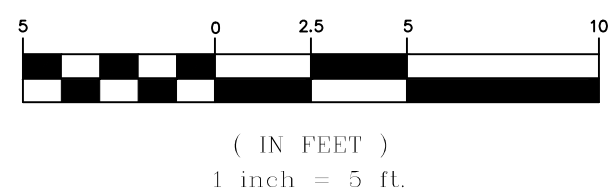
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ATLANTA, GA 30328
(770) 569-7038 x101
FAX: (770) 993-5082

PROJECT NO:	TASK 13
DESIGNED BY:	A.T.
DRAWN BY:	J.J.
CHECKED BY:	G.A.
DATE:	09/27/19
SCALE:	AS NOTED


**CITY OF ATLANTA DEPT. OF WATERSHED MANAGEMENT
WATER SUPPLY PROGRAM**

**RIVER INTAKE PUMP STATION
YARD PIPING
DETAILS**


DRAWING NO.
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DS1-003
SHEET OF

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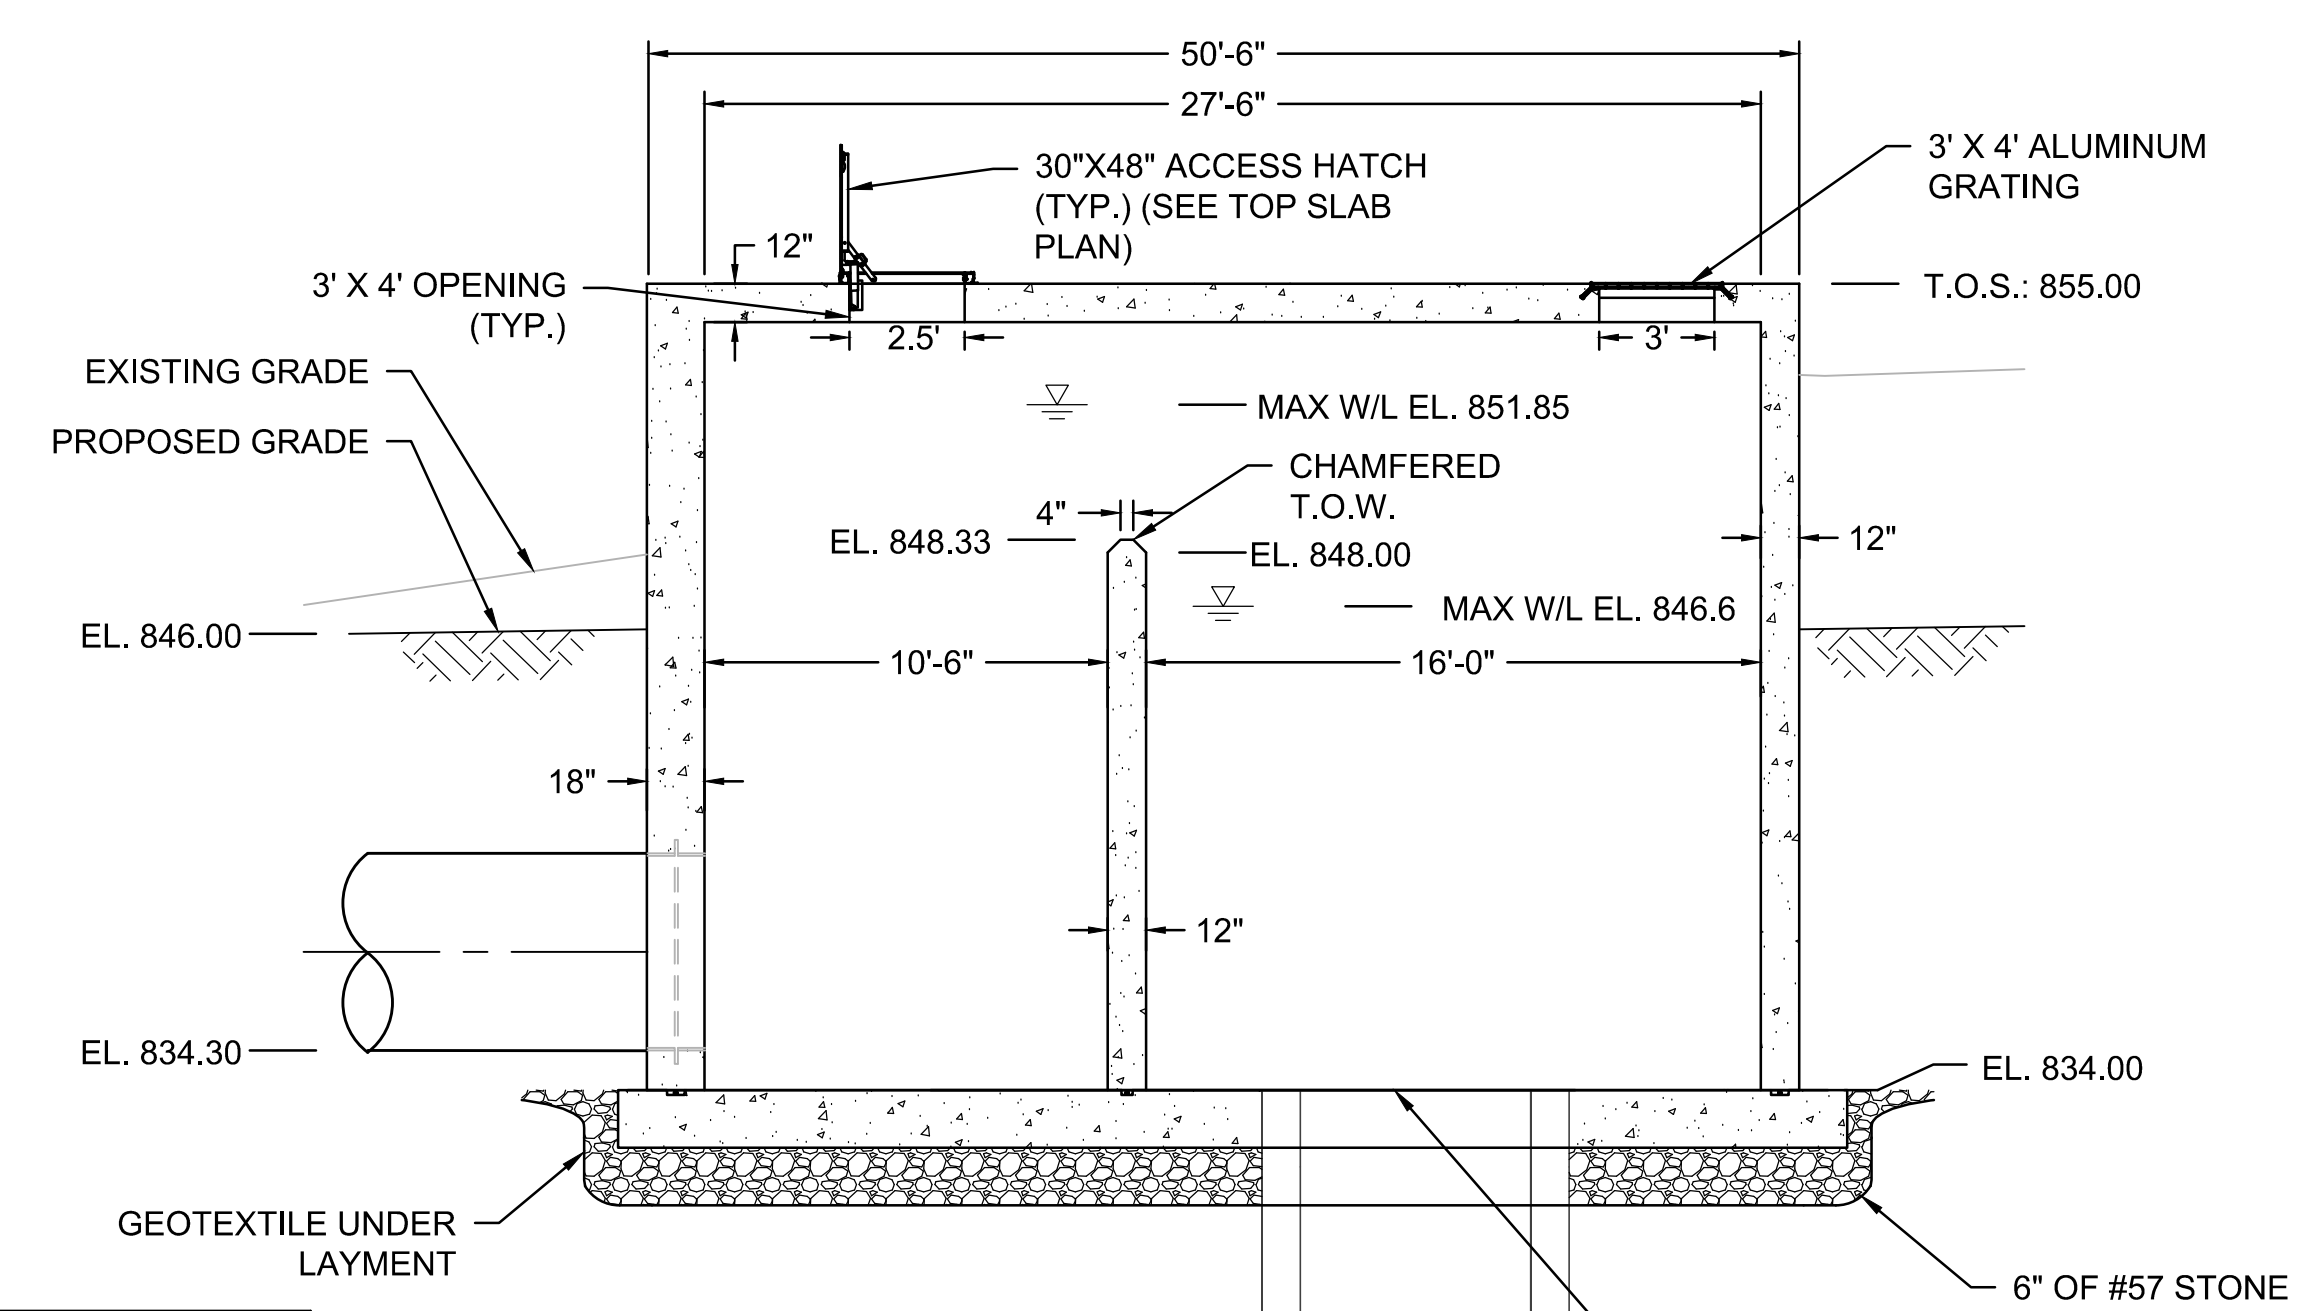
PLAN
SCALE: 1" = 5'-0"

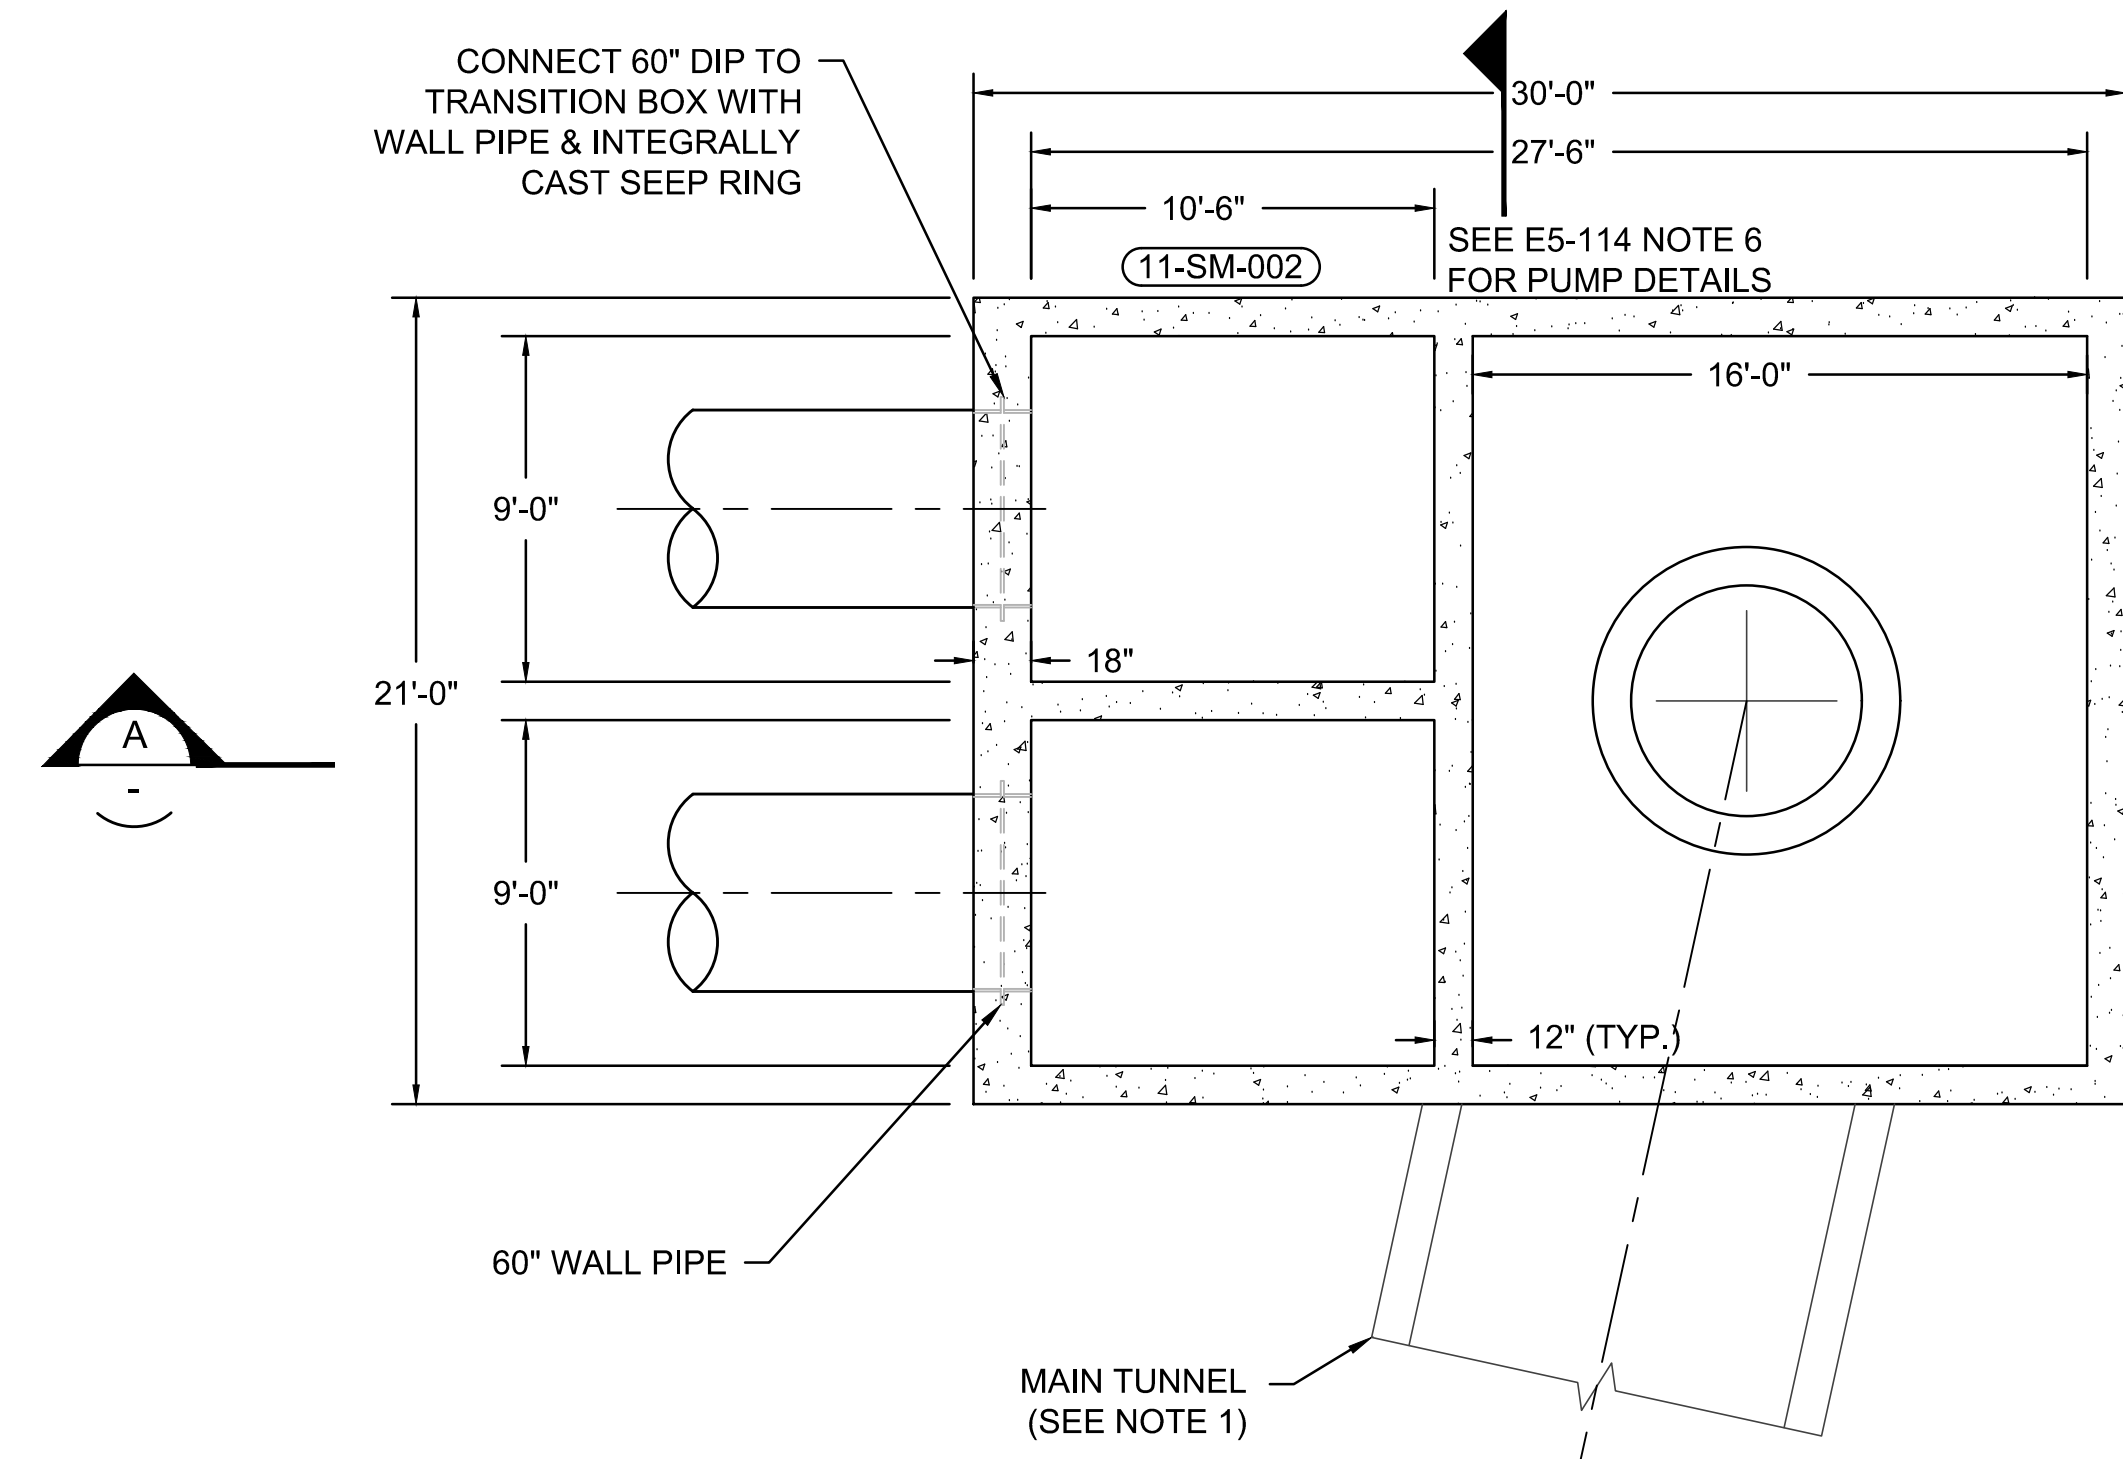


TOP SLAB PLAN
SCALE: 1" = 5'-0"

NOTES

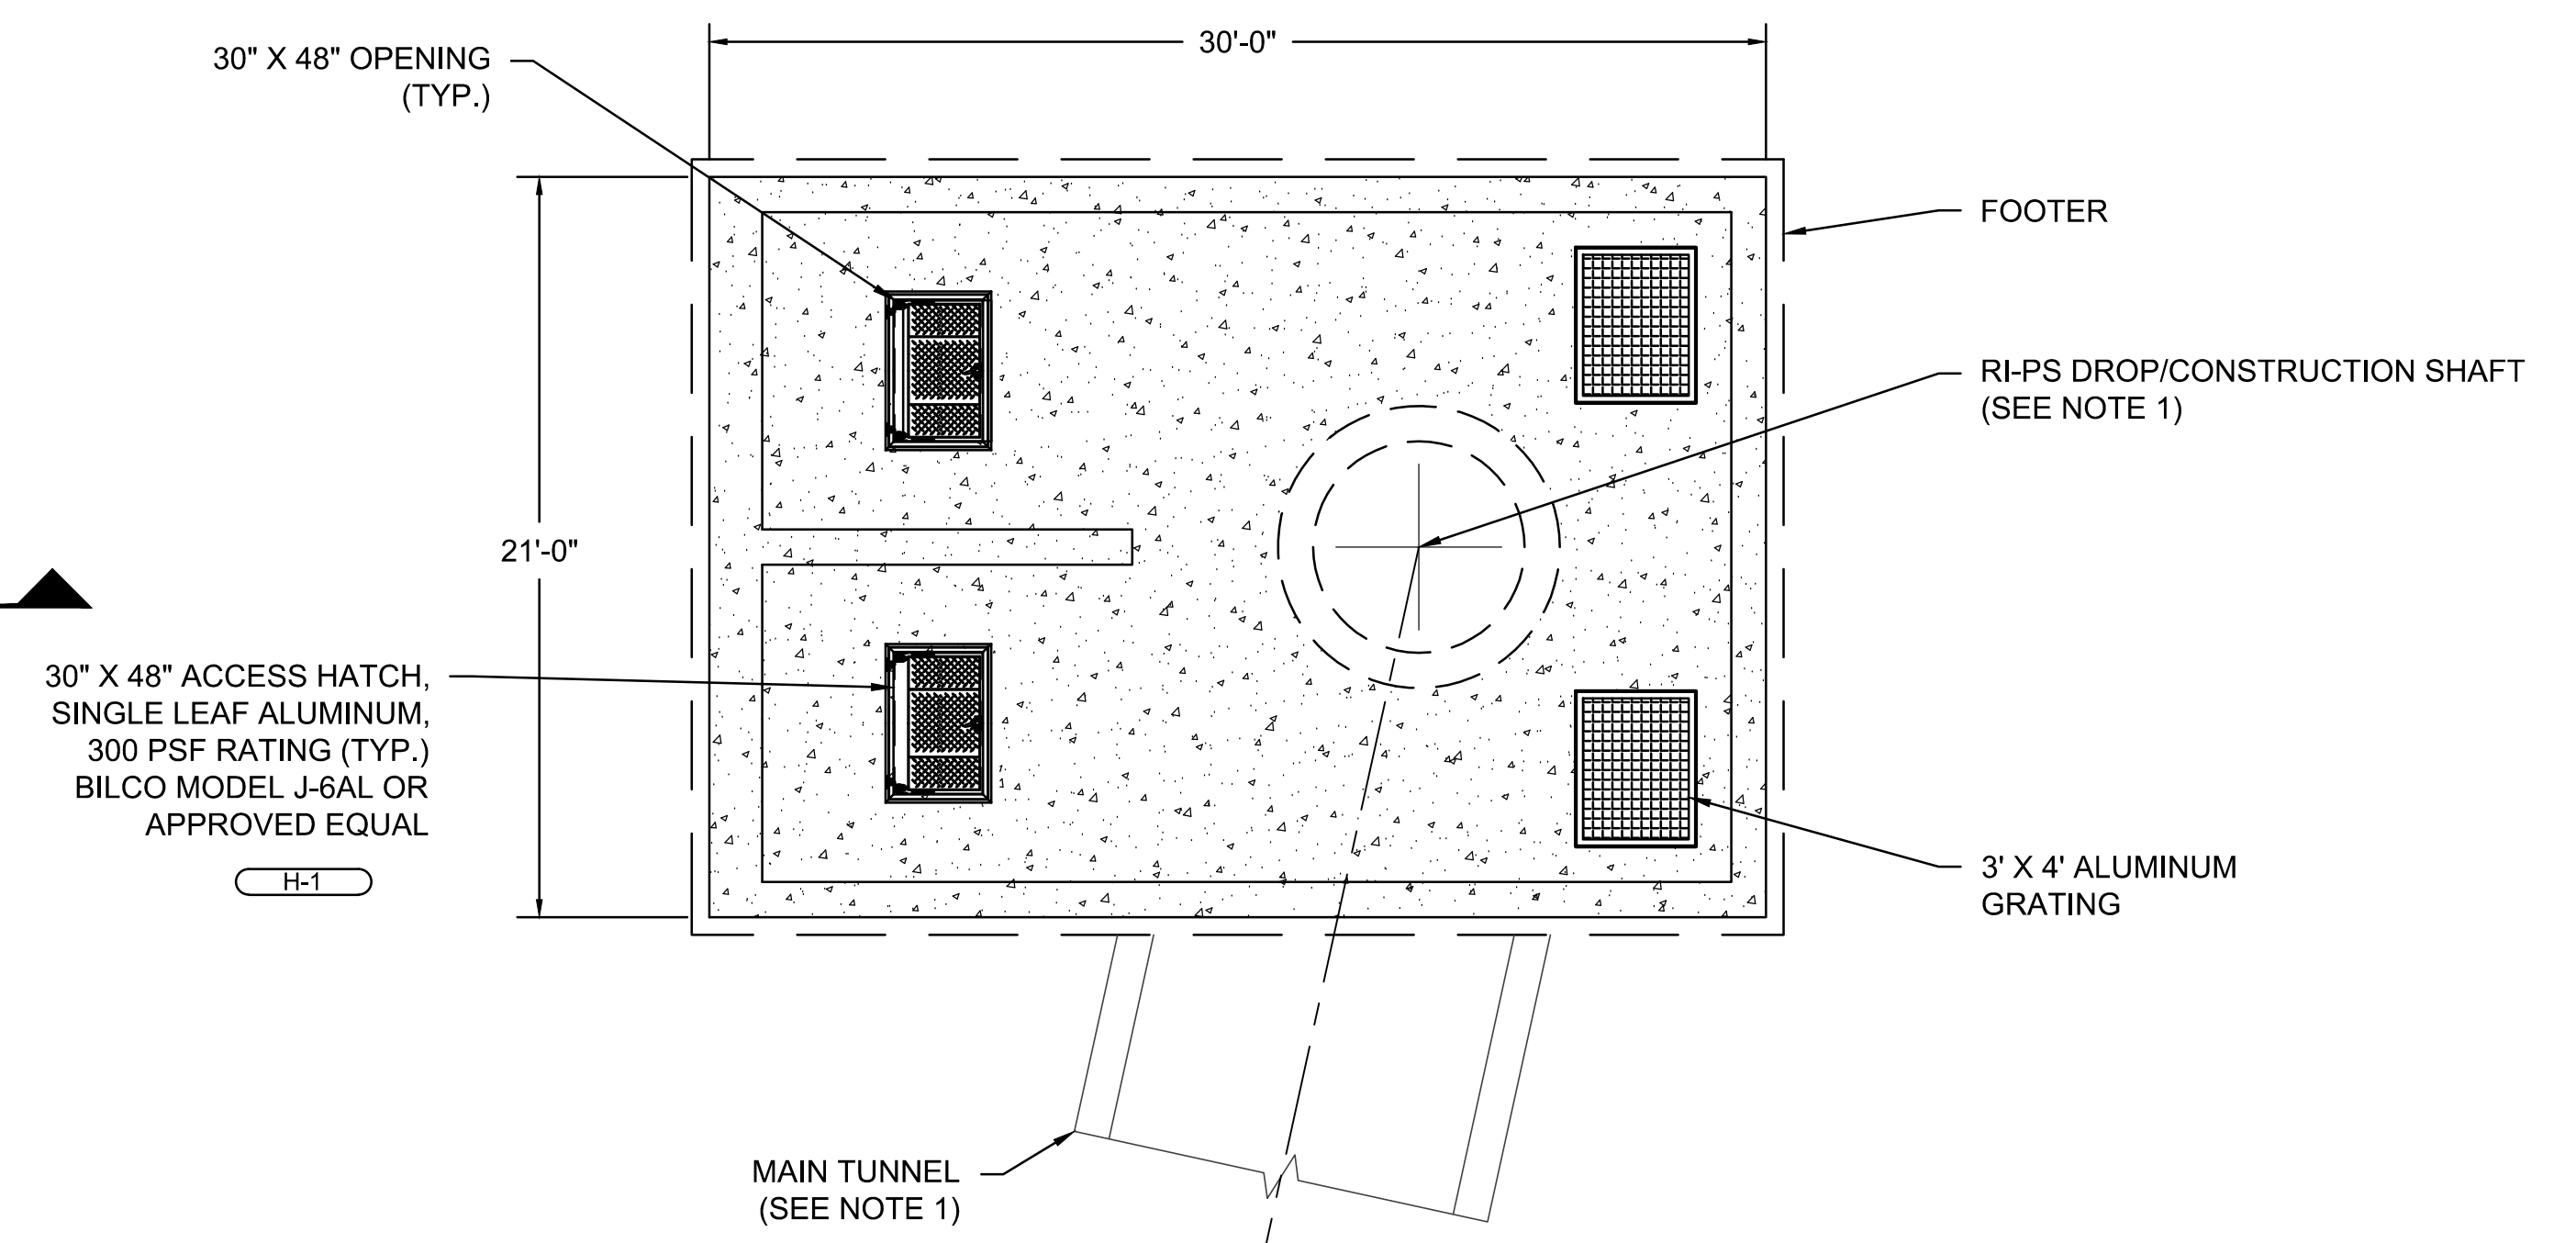1. STEEL CASING AND CONCRETE BACKFILL OF THE 72" DROPSHAFT IS TO BE CUT DOWN, WITH EXCESS REMOVED AND DISPOSED OF OFFSITE BY THE CONTRACTOR. CONTRACTOR SHALL CUT CASING AND BACKFILL SO FLOOR OF TRANSITION BOX IS AS INDICATED. MAIN TUNNEL AND DROP SHAFT WERE INSTALLED BY OTHERS UNDER PHASE 1 EXTENSION.



SECTION A
1" = 5'-0"

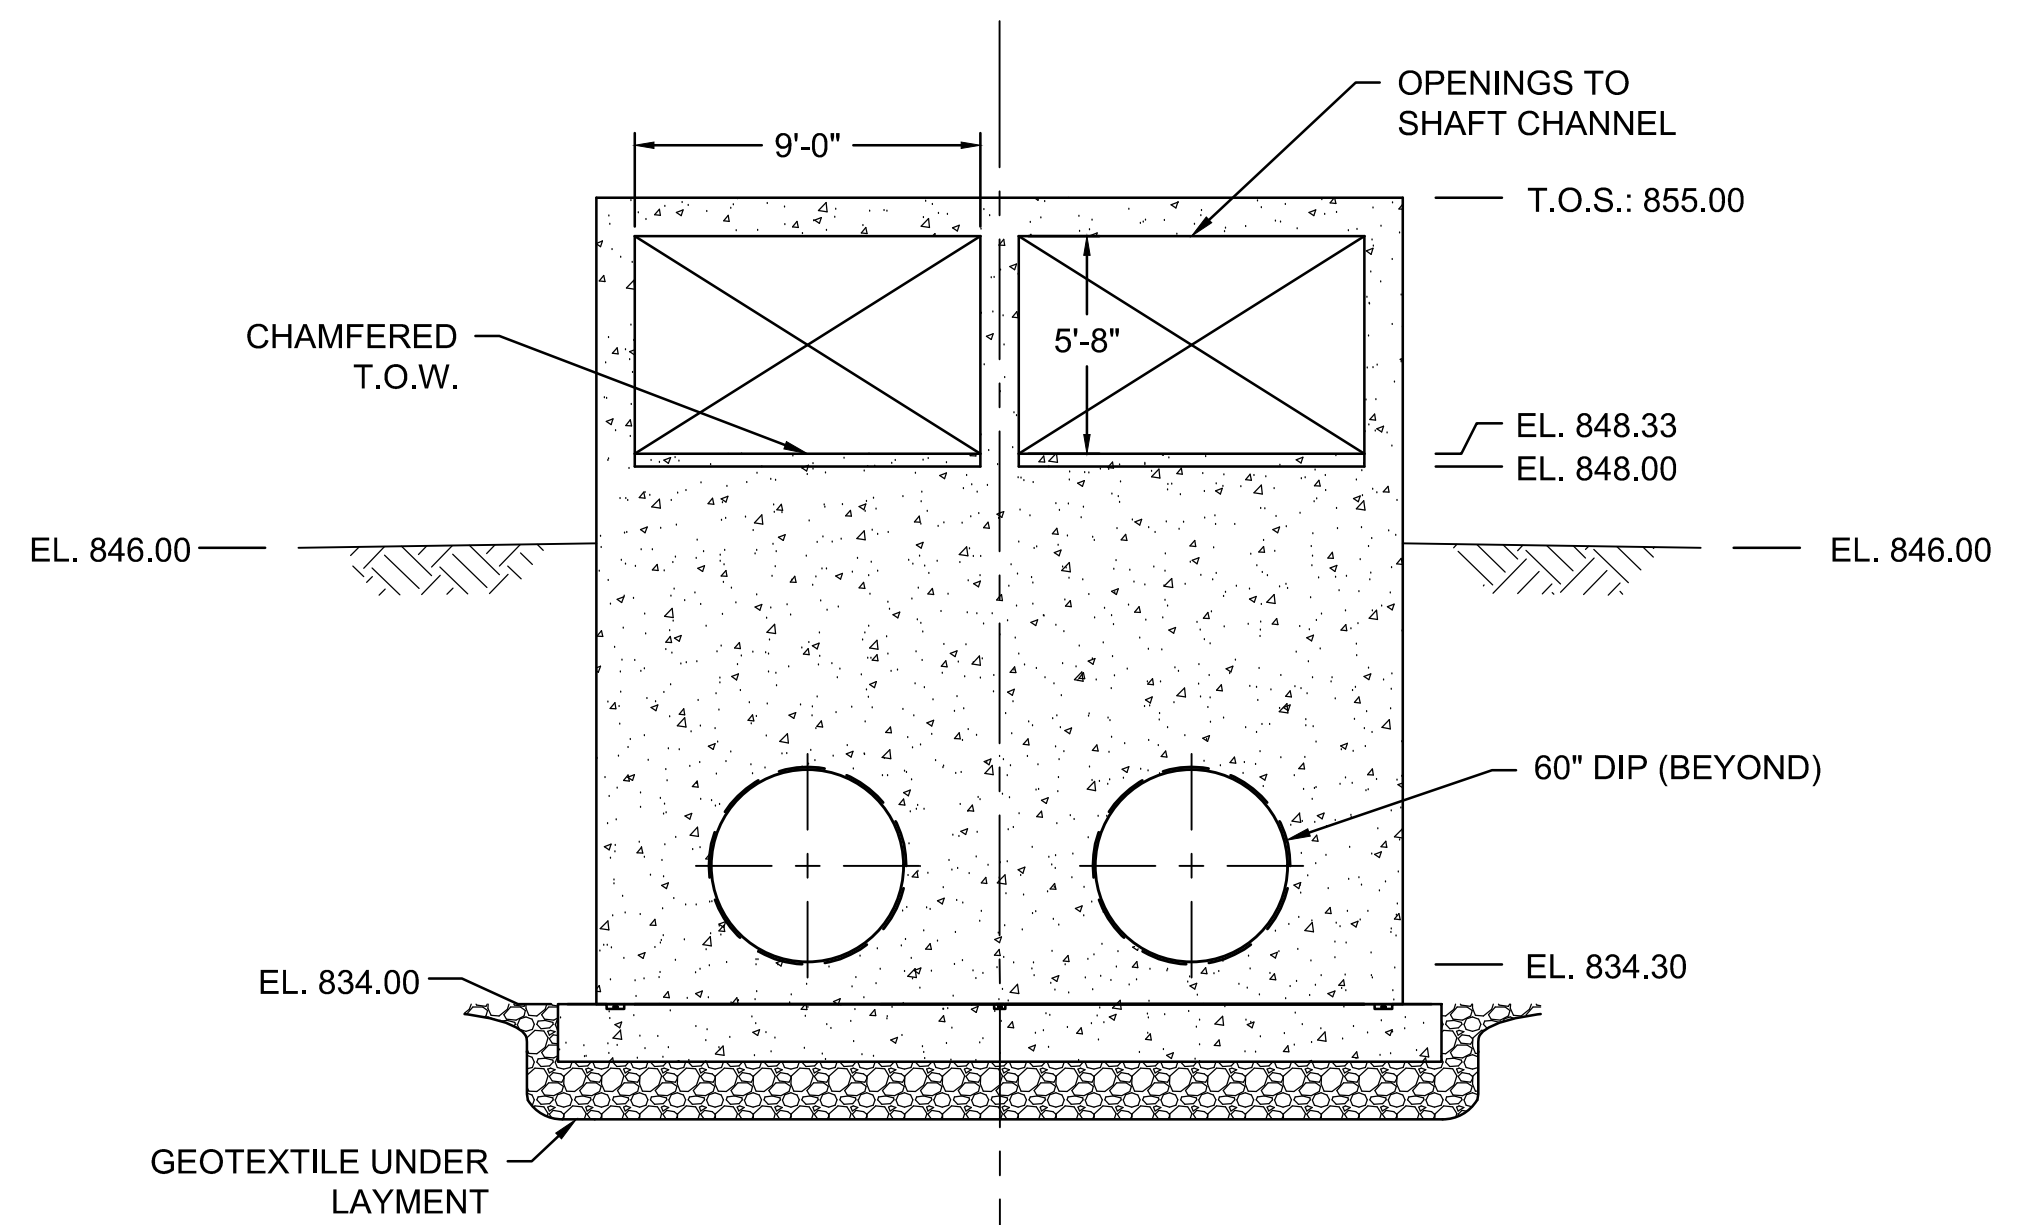


SECTION B
1" = 5'-0"

ACCESS HATCH SCHEDULE			
TAG NUMBER	SIZE (INCHES)		MANUFACTURER MODEL #
	WIDTH	LENGTH	
H-1	30	48	BILCO J-6AL



No.	Description	Date

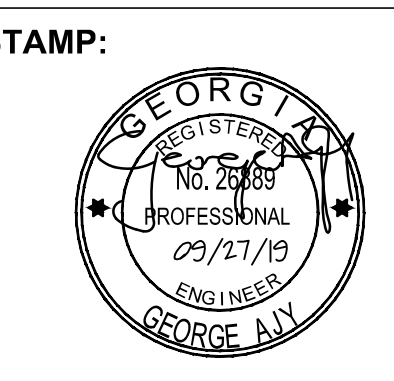

ADDRESS:
BGR2-JV
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FAX: (770) 993-5082

PROJECT NO:	TASK_13
DESIGNED BY:	A.T.
DRAWN BY:	H.B.
CHECKED BY:	G.A.
DATE:	09/27/19
SCALE:	AS NOTED

**CITY OF ATLANTA DEPT. OF WATERSHED MANAGEMENT
WATER SUPPLY PROGRAM**


**RIVER INTAKE PUMP STATION
TUNNEL SHAFT
TRANSITION BOX**

DRAWING NO.
RI-PS
DS1-004
SHEET OF

ISSUED FOR BIDDING

ABBREVIATIONS
W1: POTABLE WATER (FROM CITY)
W2: POTABLE WATER BACKFLOW PREVENTER
W3: NON-POTABLE WATER (RAW WATER)


TAG NUMBER	SIZE (INCHES)		MANUFACTURER MODEL #
	WIDTH	LENGTH	
H-2	30	96	BILCO L50 ALUMINUM SERVICE STAIR HATCH

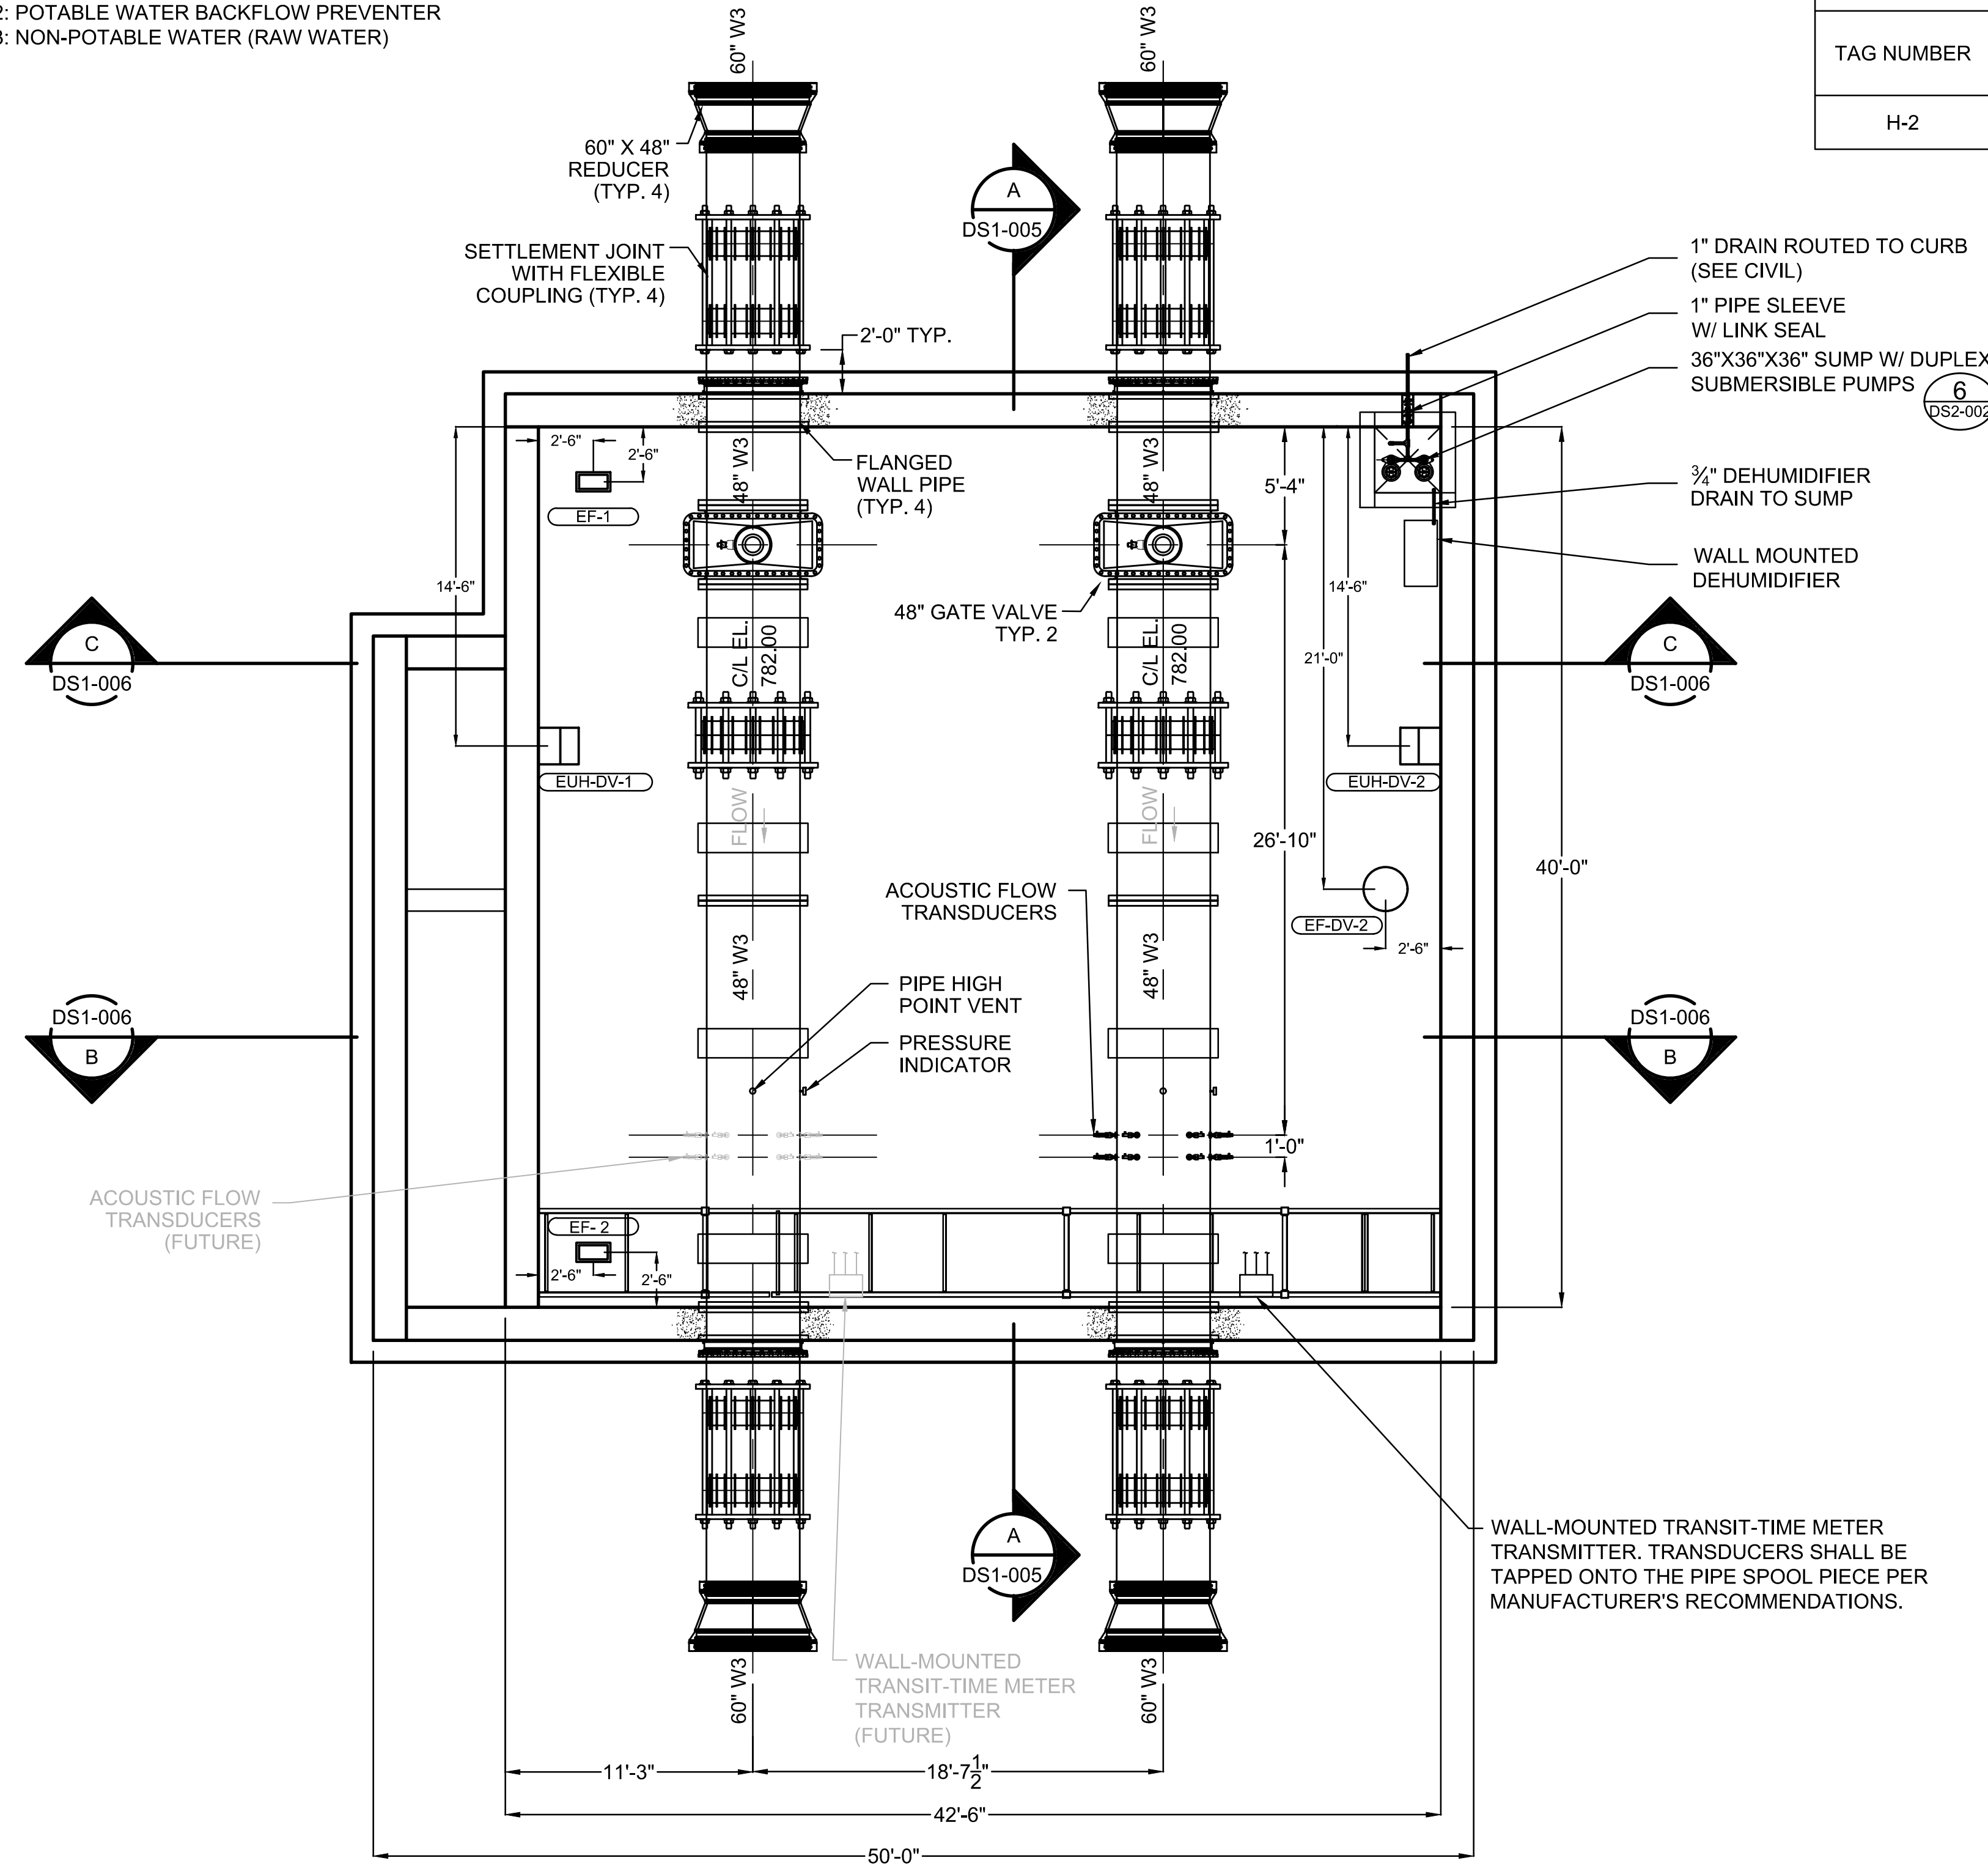

1" DRAIN ROUTED TO CURB (SEE CIVIL)
1" PIPE SLEEVE W/ LINK SEAL
36"X36"X36" SUMP W/ DUPLEX SUBMERSIBLE PUMPS (6 DS2-002)
3/4" DEHUMIDIFIER DRAIN TO SUMP
WALL MOUNTED DEHUMIDIFIER

WALL-MOUNTED TRANSIT-TIME METER TRANSMITTER. TRANSDUCERS SHALL BE TAPPED ONTO THE PIPE SPOOL PIECE PER MANUFACTURER'S RECOMMENDATIONS.

H-2
8'-0" X 2'-6" ACCESS HATCH (TYP.)

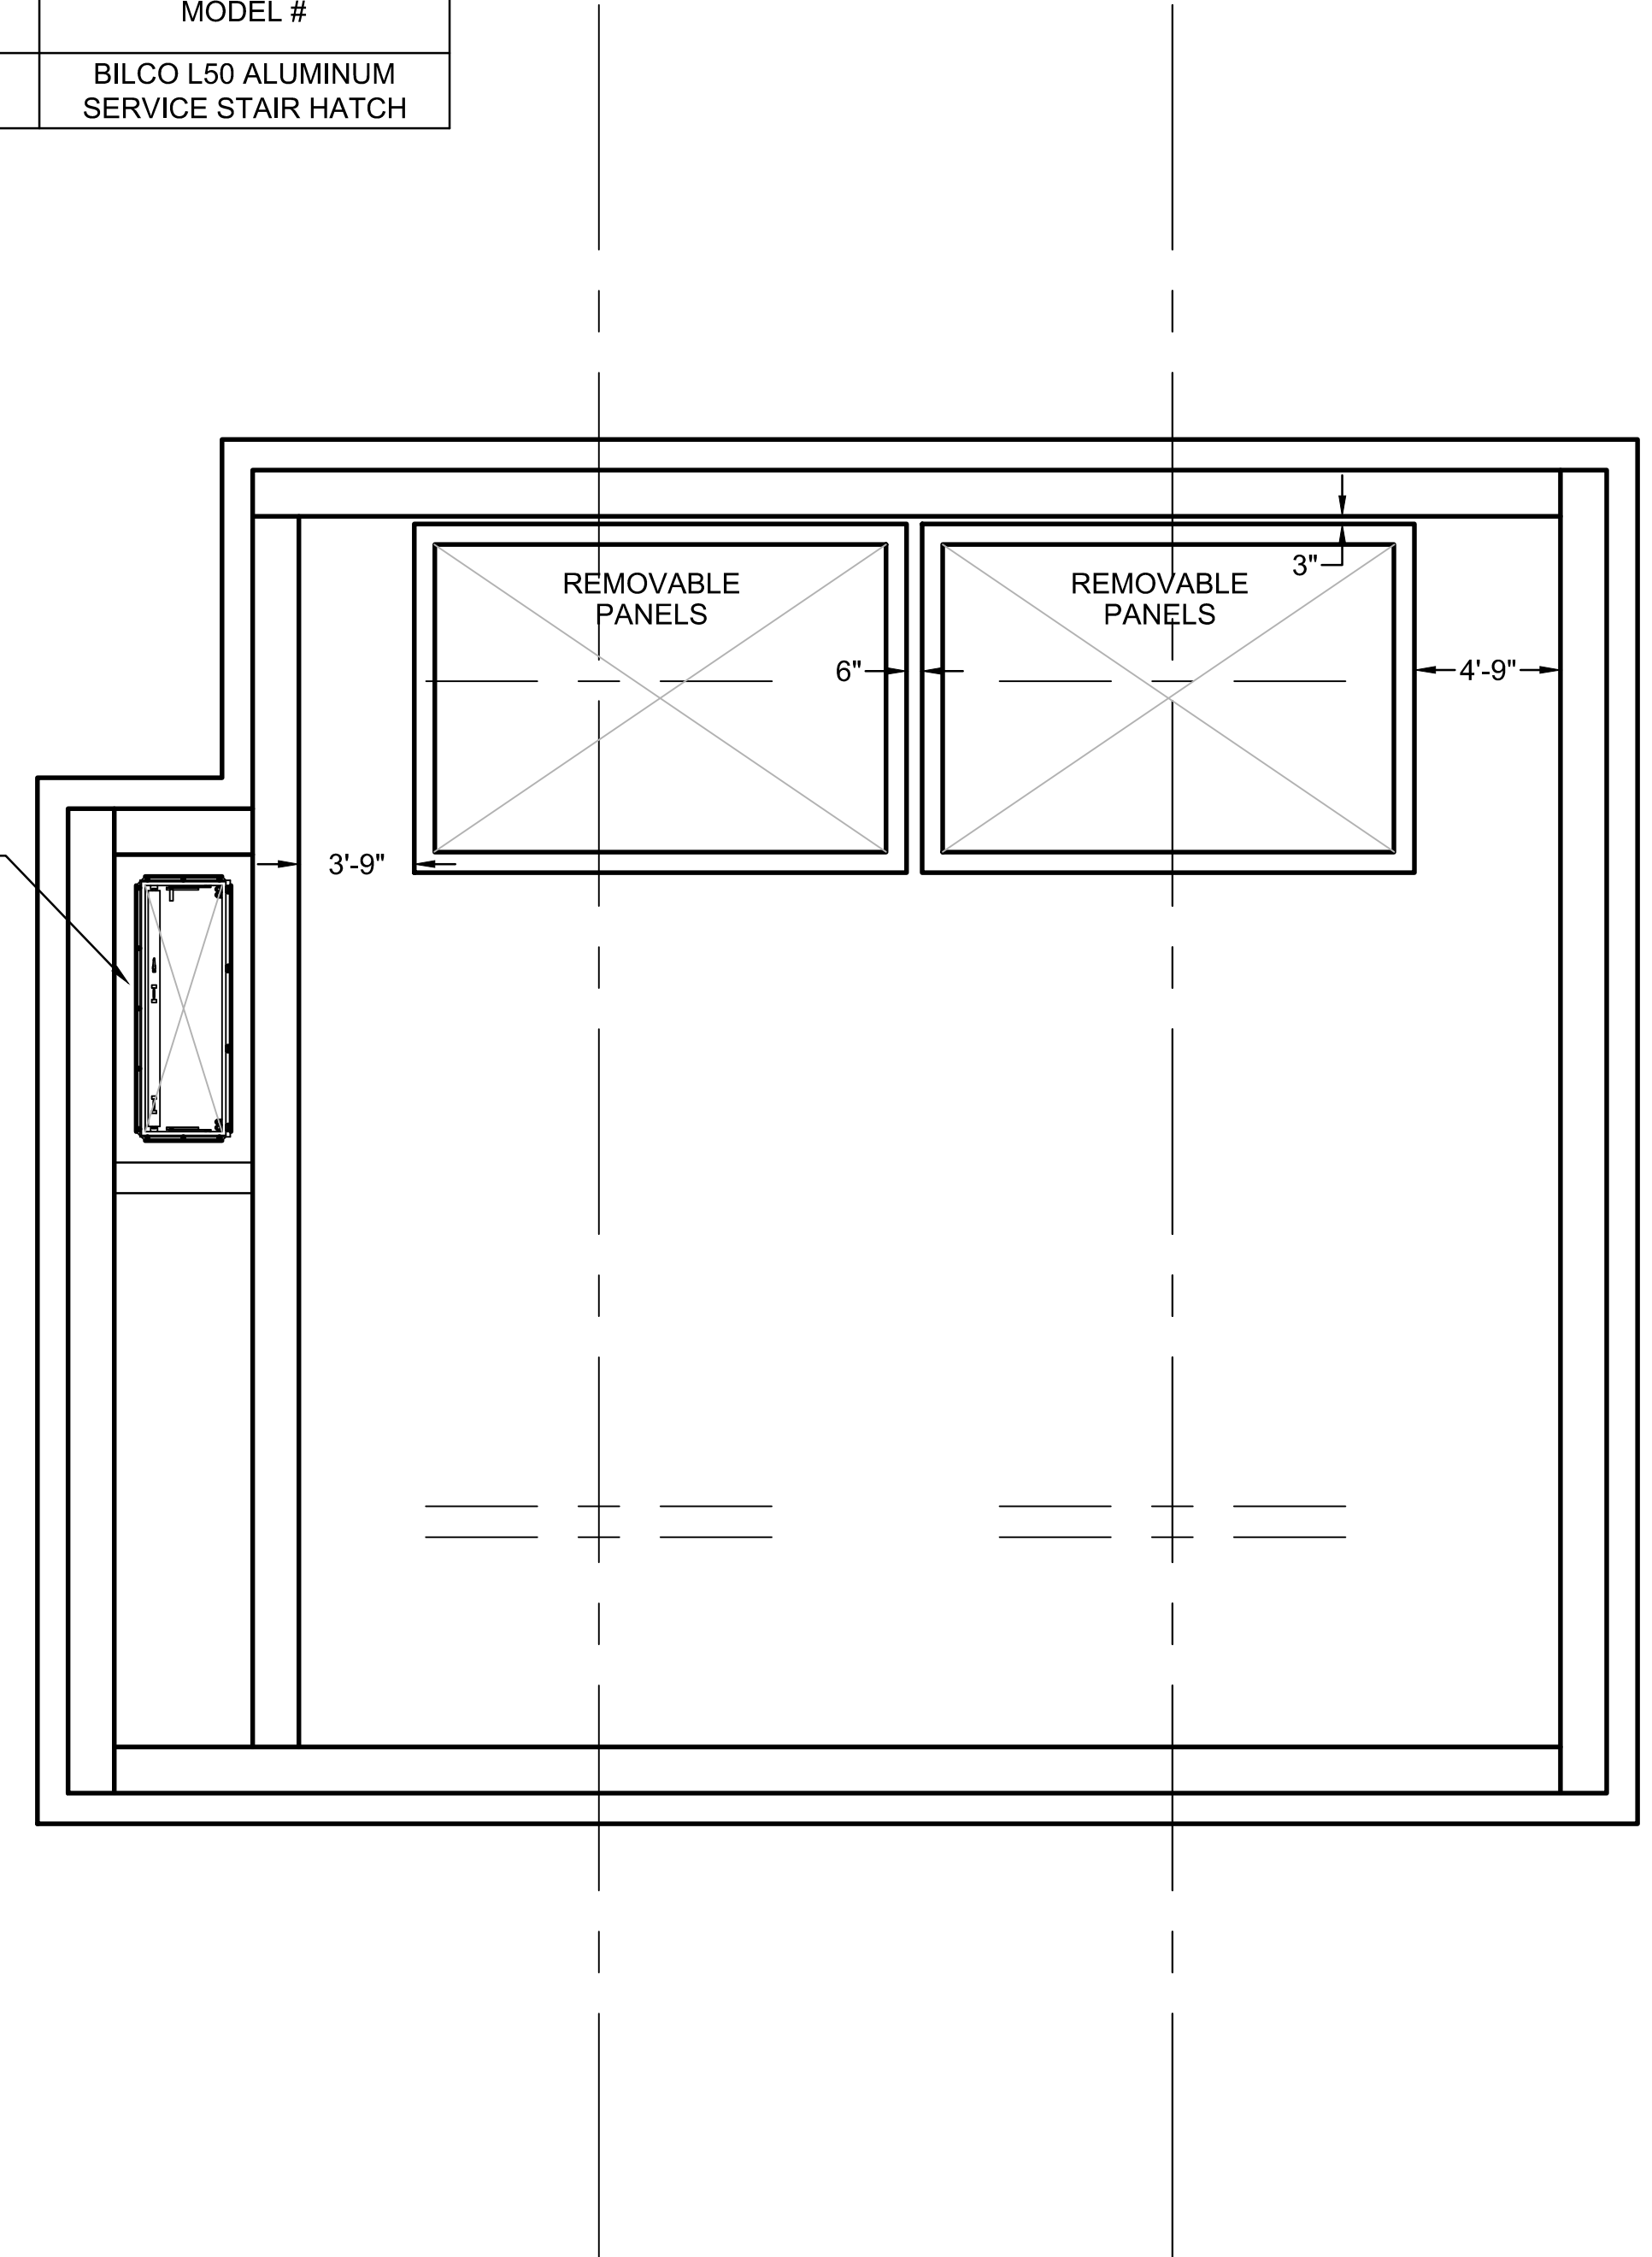


PLAN
SCALE: 3/16" = 1'-0"

ROOF PLAN
SCALE: 3/16" = 1'-0"

P:\City of Atlanta - Water Supply Program Phase 1\CD Drawings\PROCESS\B-P5 DS1-005.dwg, PRINTED BY: Hody Barnes ON Thu, Dec 05, 2019 AT 10:01 AM



No.	Description	Date

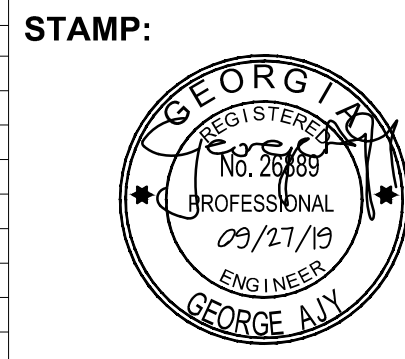

ADDRESS:
BGR2-JV
6 CONCOURSE PARKWAY
SUITE 1600
ATLANTA, GA 30328
(770) 569-7038 x101
FAX: (770) 993-5082


PROJECT NO:	TASK_13
DESIGNED BY:	A.T.
DRAWN BY:	H.B.
CHECKED BY:	G.A.
DATE:	09/27/19
SCALE:	AS NOTED

CITY OF ATLANTA DEPT. OF WATERSHED MANAGEMENT
WATER SUPPLY PROGRAM
RIVER INTAKE PUMP STATION
METER VAULT
PLAN

DRAWING NO.
RI-PS
DS1-005
SHEET OF

ISSUED FOR BIDDING

ABBREVIATIONS
 W1: POTABLE WATER (FROM CITY)
 W2: POTABLE WATER BACKFLOW PREVENTER
 W3: NON-POTABLE WATER (RAW WATER)

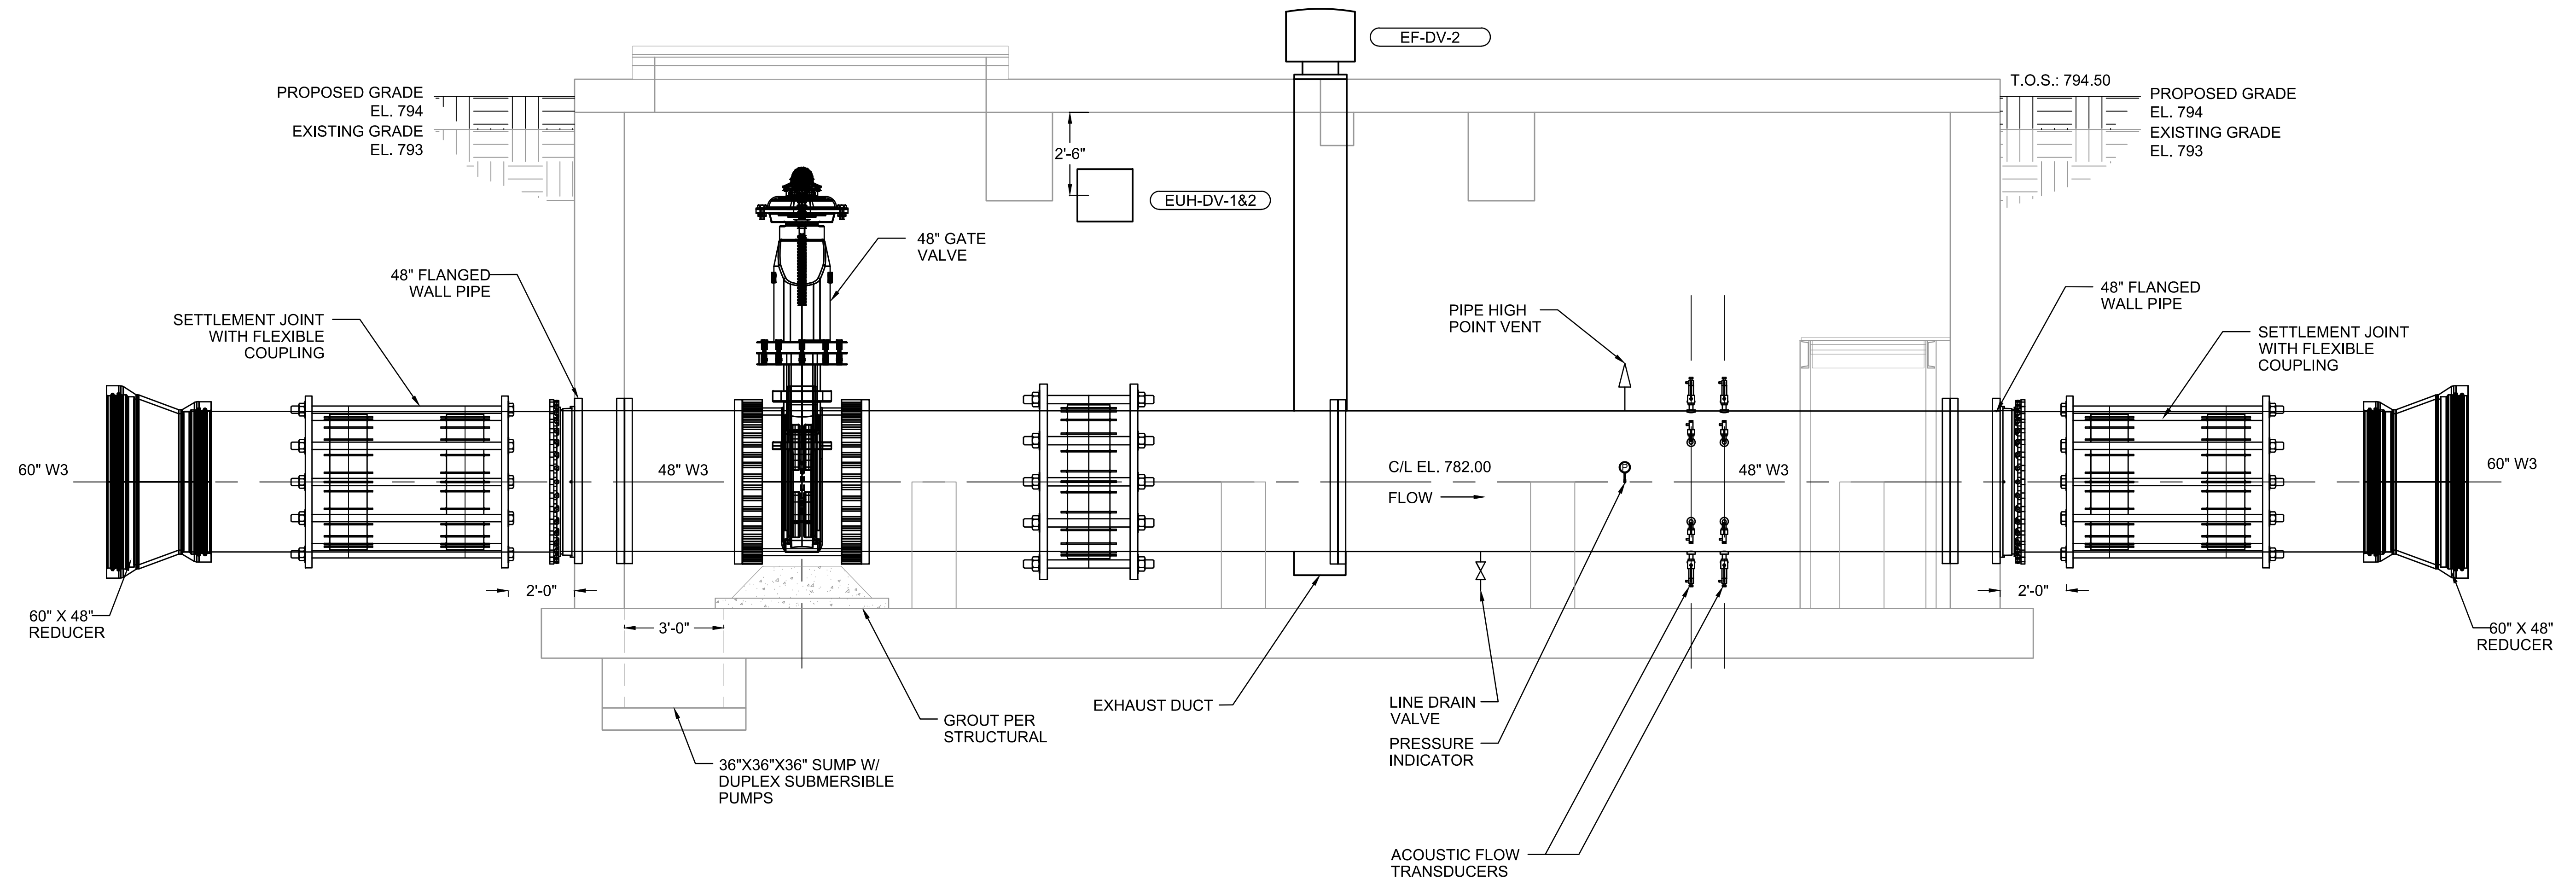


SECTION A
 3/8"=1'-0" DS1-004

P:\City of Atlanta - Water Supply Program Phase 1\CD Drawings\PROCESS\RI-PS DS1-006.dwg, PRINTED BY: hody.barnes ON Thu, Dec 05, 2019 AT 9:19 AM



No.	Description	Date

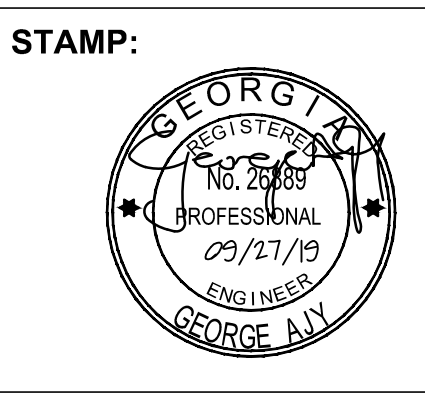

ADDRESS:
 BGR2-JV
 6 CONCOURSE PARKWAY
 SUITE 1600
 ATLANTA, GA 30328
 (770) 569-7038 x101
 FAX: (770) 993-5082


PROJECT NO:	TASK_13
DESIGNED BY:	A.T.
DRAWN BY:	H.B.
CHECKED BY:	G.A.
DATE:	09/27/19
SCALE:	AS NOTED

CITY OF ATLANTA DEPT. OF WATERSHED MANAGEMENT
WATER SUPPLY PROGRAM
RIVER INTAKE PUMP STATION
 METER VAULT SECTION


DRAWING NO.
RI-PS
DS1-006
 SHEET OF

ISSUED FOR BIDDING

ABBREVIATIONS
W1: POTABLE WATER (FROM CITY)
W2: POTABLE WATER BACKFLOW PREVENTER
W3: NON-POTABLE WATER (RAW WATER)

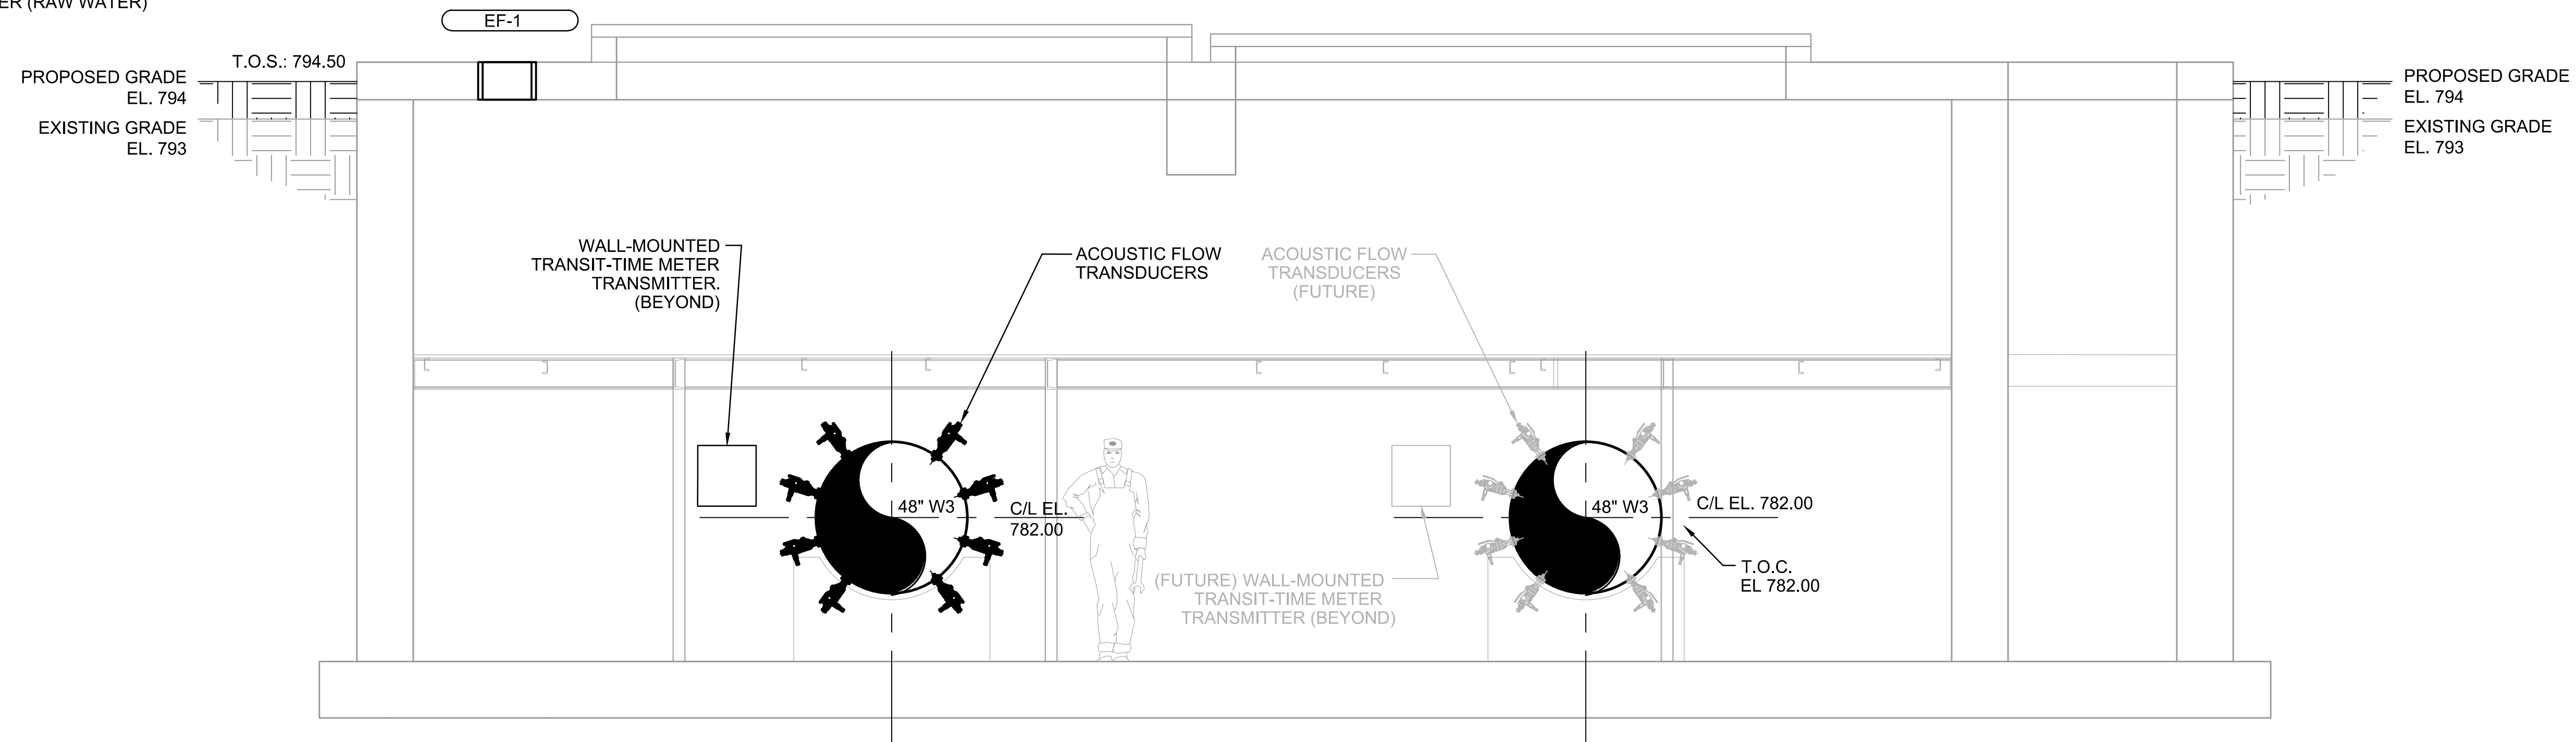

SECTION B
3/8"=1'-0" DS1-004

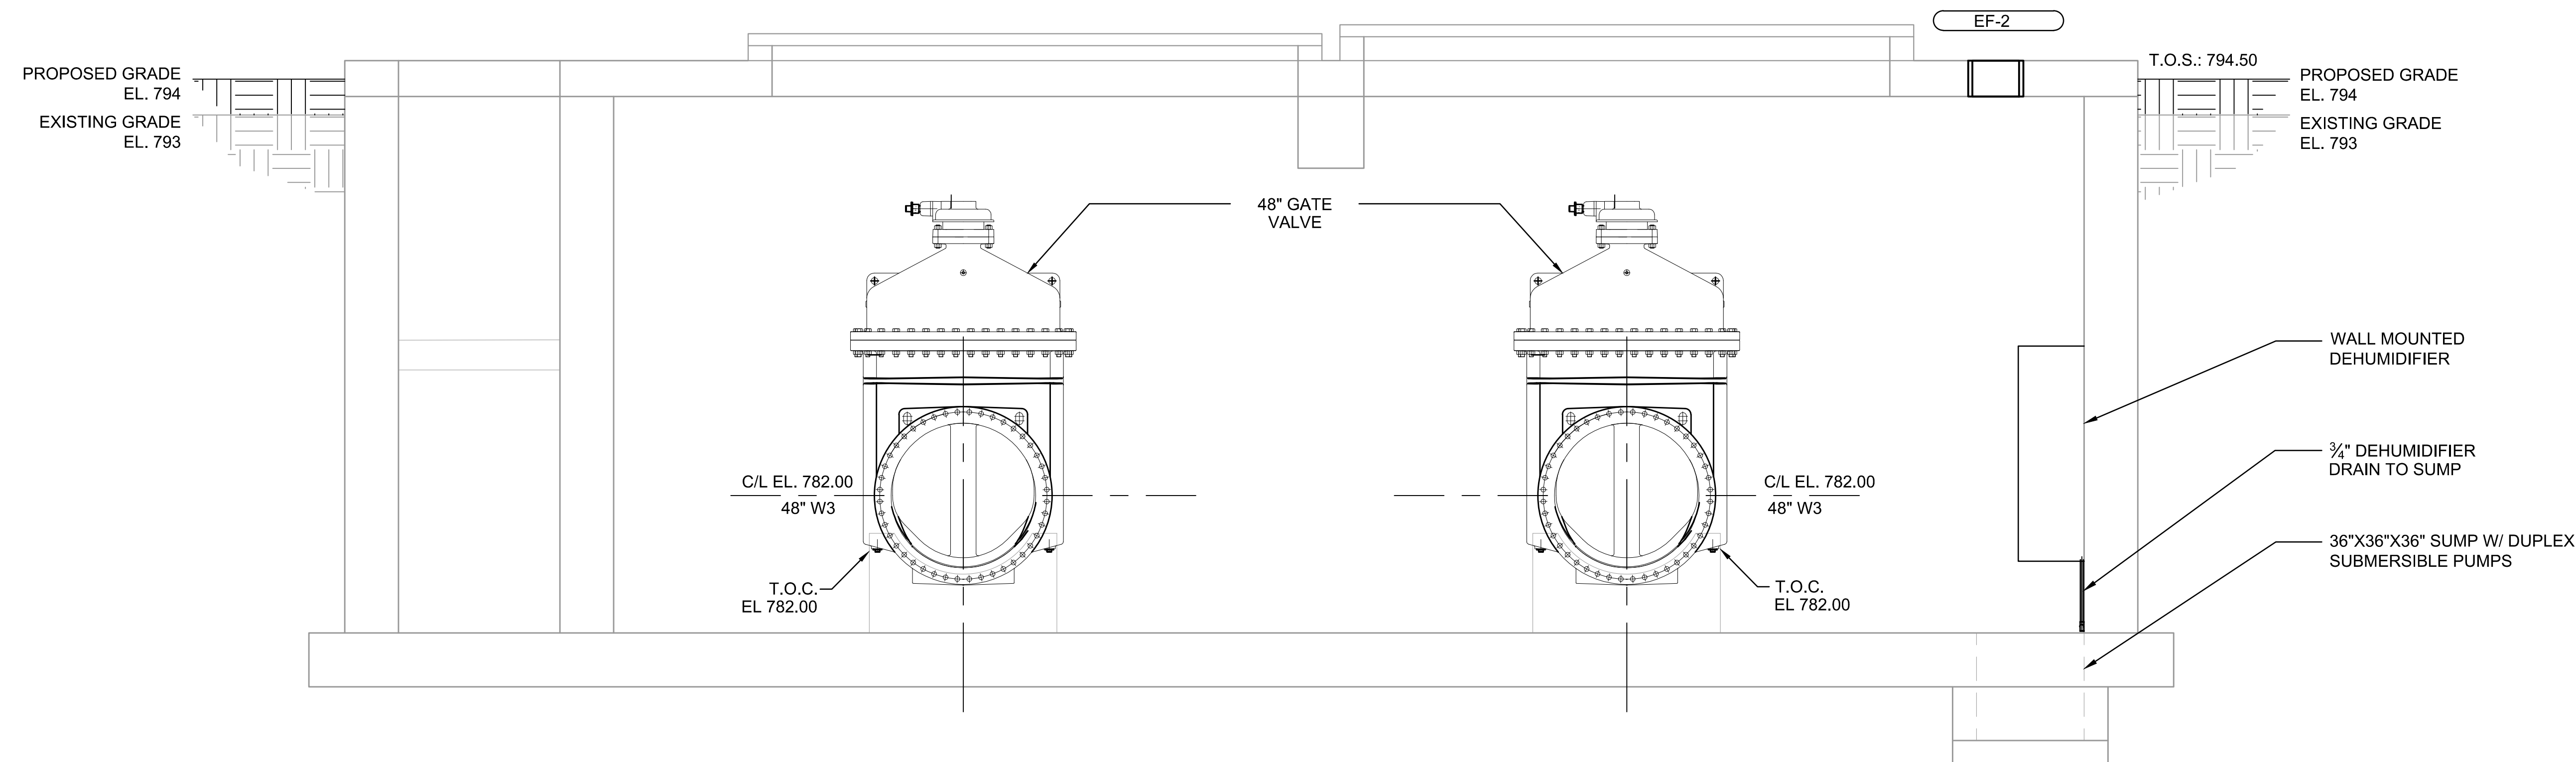


SECTION C
3/8"=1'-0" DS1-004

P:\City of Atlanta - Water Supply Program Phase 1\CD Drawings\PROCESS\RI-PS DS1-007.dwg, PRINTED BY: Holly Barnes ON Thu, Dec 05, 2019 AT 9:19 AM



No.	Description	Date

STAMP:

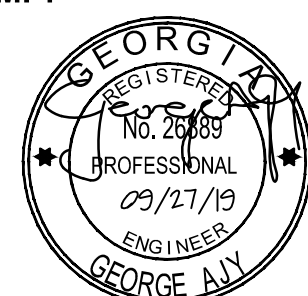

ADDRESS:

BGR2-JV
6 CONCOURSE PARKWAY
SUITE 1600
ATLANTA, GA 30328
(770) 569-7038 x101
FAX: (770) 993-5082

PROJECT NO:	TASK_13
DESIGNED BY:	A.T.
DRAWN BY:	H.B.
CHECKED BY:	G.A.
DATE:	09/27/19
SCALE:	AS NOTED

CITY OF ATLANTA DEPT. OF WATERSHED MANAGEMENT
WATER SUPPLY PROGRAM

RIVER INTAKE PUMP STATION
METER VAULT SECTION


DRAWING NO.

RI-PS

DS1-007



SHEET OF

ISSUED FOR BIDDING

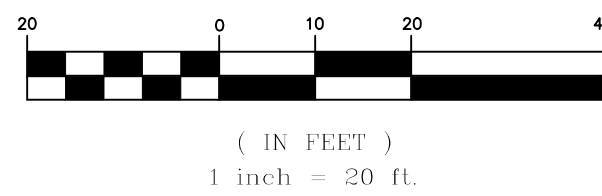

NOTES:


1. FINAL ALIGNMENT OF THE PROPOSED 60-INCH RAW WATER MAIN MAY ALTER PENDING VERTICAL UTILITY DATA.
2. SURVEY IS SUPPLEMENTED BY ADDITIONAL INFORMATION AS RECEIVED FROM CITY OF ATLANTA GIS AND AS-BUILTS. CONTRACTOR TO VERIFY THE LOCATION OF ALL EXISTING UTILITIES.
3. CONNECTIONS TO EXISTING TEES AND SERVICE CONNECTIONS MAY REQUIRE ADDITIONAL FITTINGS NOT SPECIFIED HEREON. ADDITIONAL INTERCONNECTIONS MAY BE PRESENT, THOUGH NOT DEPICTED HERE, AND SHALL BE RE-ESTABLISHED.
4. THE CONTRACTOR SHALL COMPLY WITH ALL OSHA REGULATIONS WHEN WORKING WITHIN THE IMMEDIATE VICINITY OF POWER POLES, POWER LINES, ETC.
5. YARD PIPING SHALL MAINTAIN EIGHTEEN (18) INCHES VERTICAL CLEARANCE FROM NON-POTABLE PIPELINES, TWENTY-FOUR (24) INCHES FROM ANY EXISTING GAS MAIN GREATER THAN TWO (2) INCHES, AND THIRTY-SIX (36) INCHES FROM ANY EXISTING PERPENDICULAR CROSSING OF GRAVITY AND FORCE MAINS. (MEASURED FROM OUTSIDE OF PIPE TO OUTSIDE OF PIPE.)
6. SEE SEQUENCING NOTES, G-004, NOTE 3.G.GA FOR SEQUENCING RESTRICTIONS AT THE P-PS DROP/CONSTRUCTION SHAFT SITE.

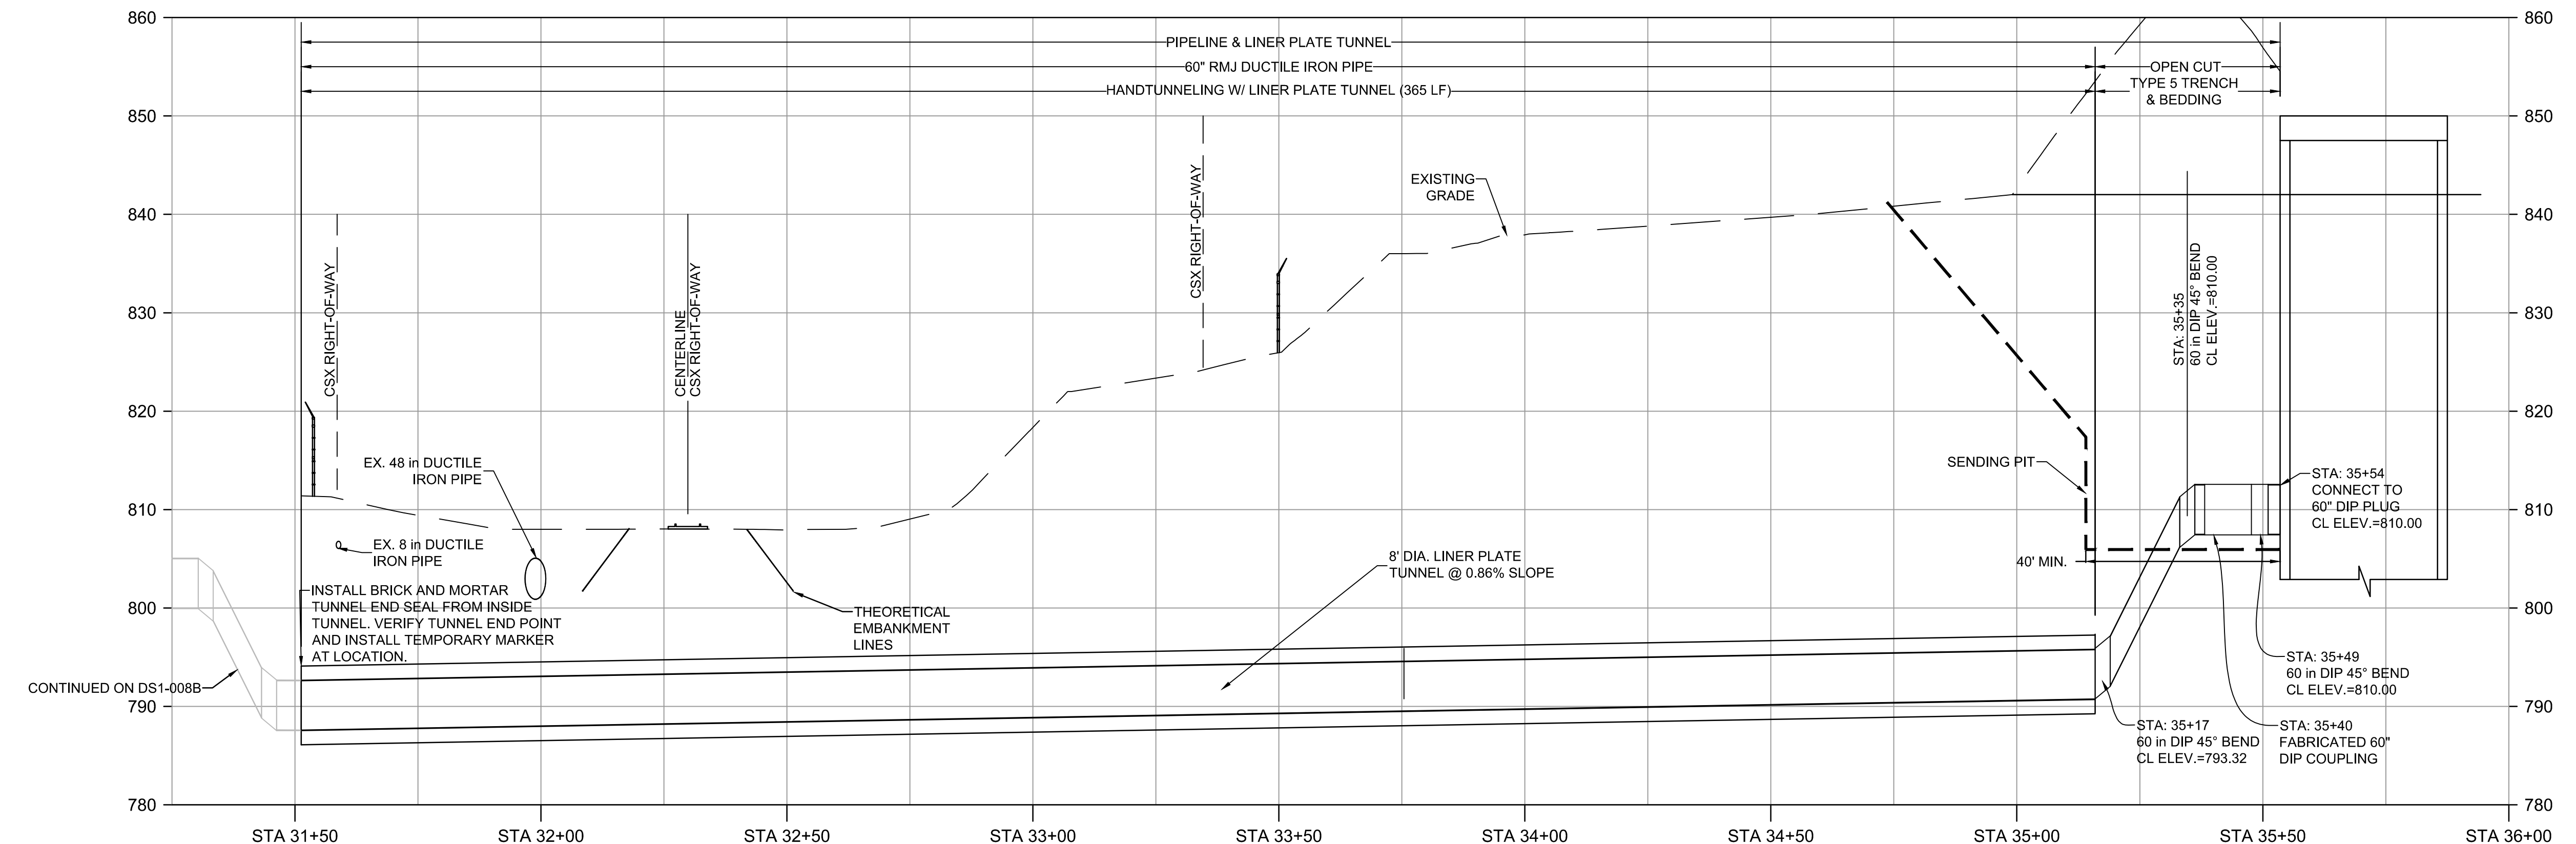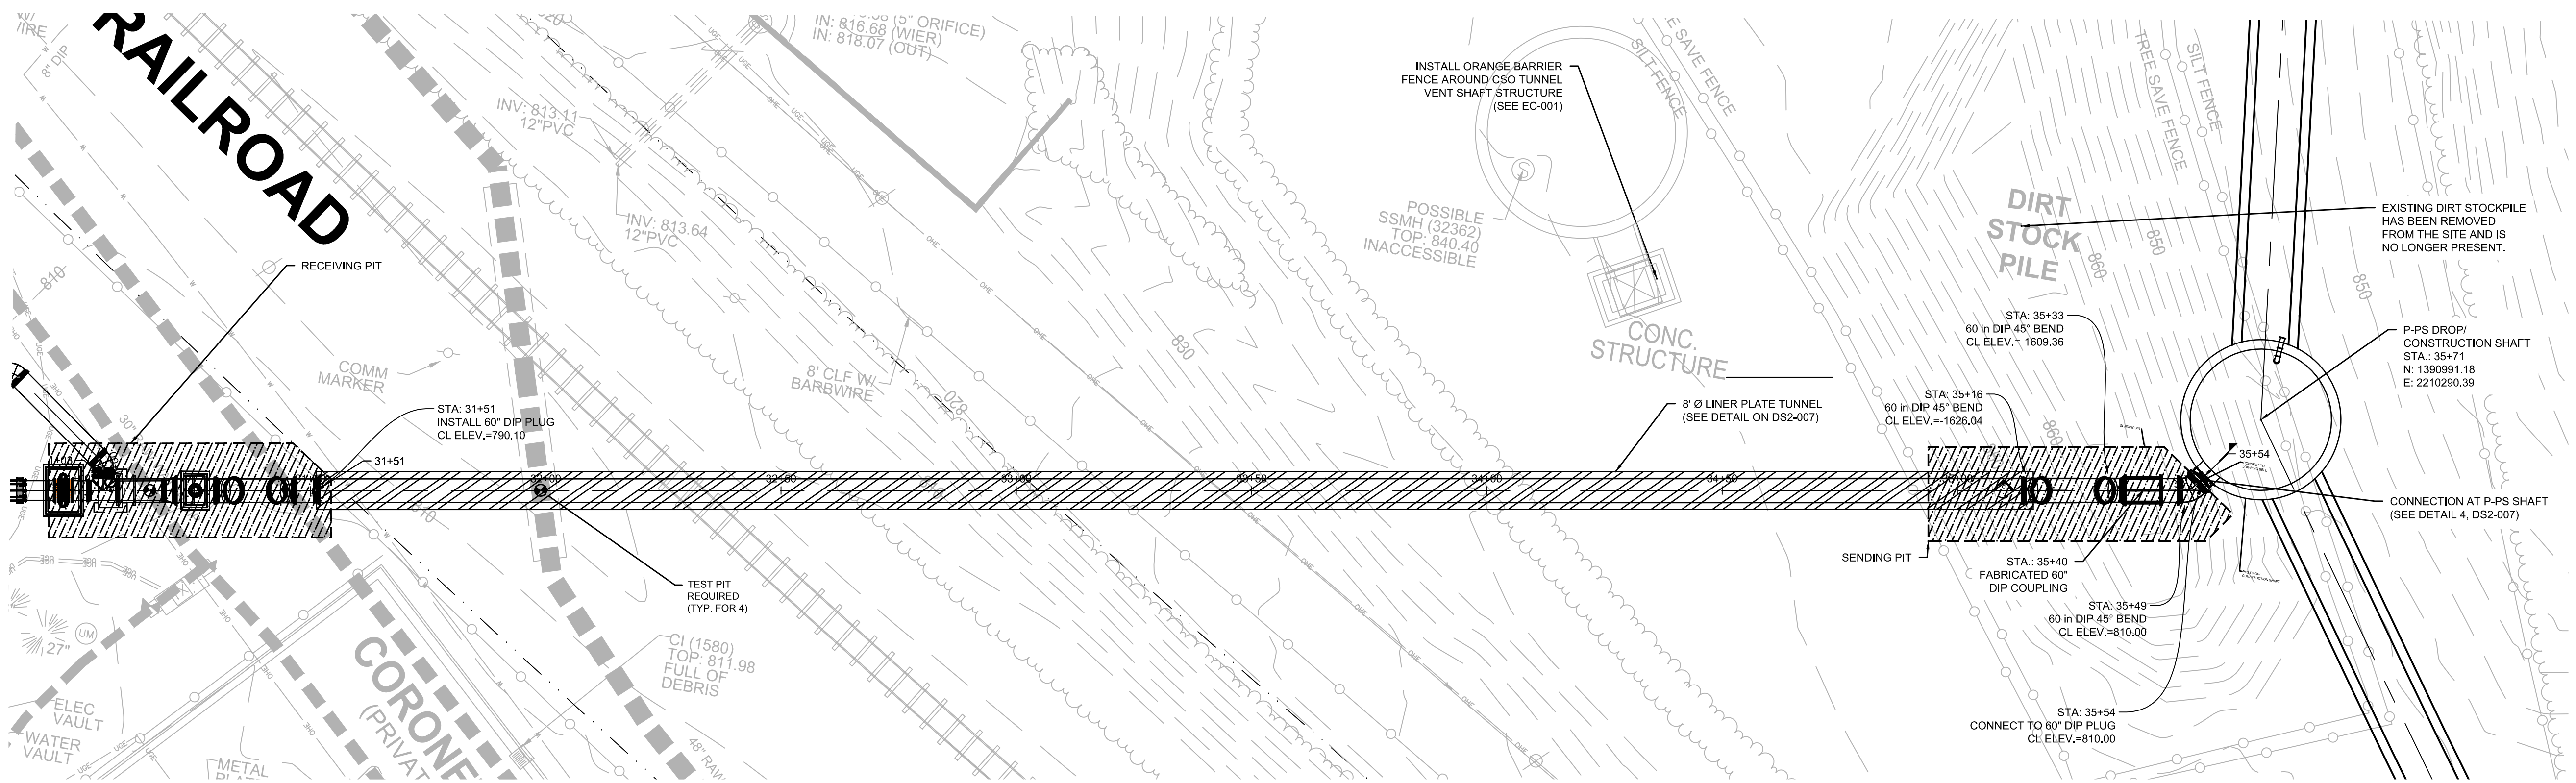

P:\City of Atlanta - Water Supply Program Phase \ACD Drawings\PROCESS\RI-PS DS1-008A.dwg, PRINTED BY: Hadyr Borneo ON Thu, Dec 05 2019 AT 9:33 AM



No.	Description	Date

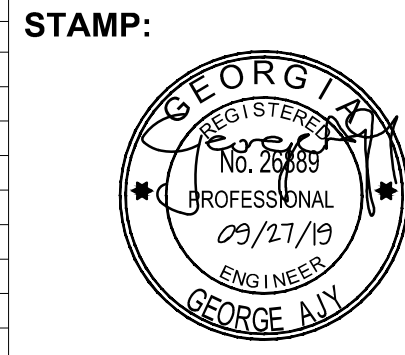

ADDRESS:
 BGR2-JV
 6 CONCOURSE PARKWAY
 SUITE 1600
 ATLANTA, GA 30328
 (770) 569-7038 x101
 FAX: (770) 993-5082

PROJECT NO:	TASK_13
DESIGNED BY:	J.J.
DRAWN BY:	J.J.
CHECKED BY:	G.A.
DATE:	09/27/19
SCALE:	AS NOTED





**CITY OF ATLANTA DEPT. OF WATERSHED MANAGEMENT
 WATER SUPPLY PROGRAM**
**RIVER INTAKE PUMP STATION
 YARD PIPING
 PLAN & PROFILE**

DRAWING NO.
RI-PS
DS1-008A
 SHEET OF

ISSUED FOR BIDDING

NOTES:


1. FINAL ALIGNMENT OF THE PROPOSED 60-INCH RAW WATER MAIN MAY ALTER PENDING VERTICAL UTILITY DATA.
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P:\City of Atlanta - Water Supply Program Phase \ACD Drawings\PROCESS\RI-PS DS1-008B-009.dwg, PRINTED BY: Hodgyn Barnes ON Thu, Dec 05 2019 AT 9:24 AM

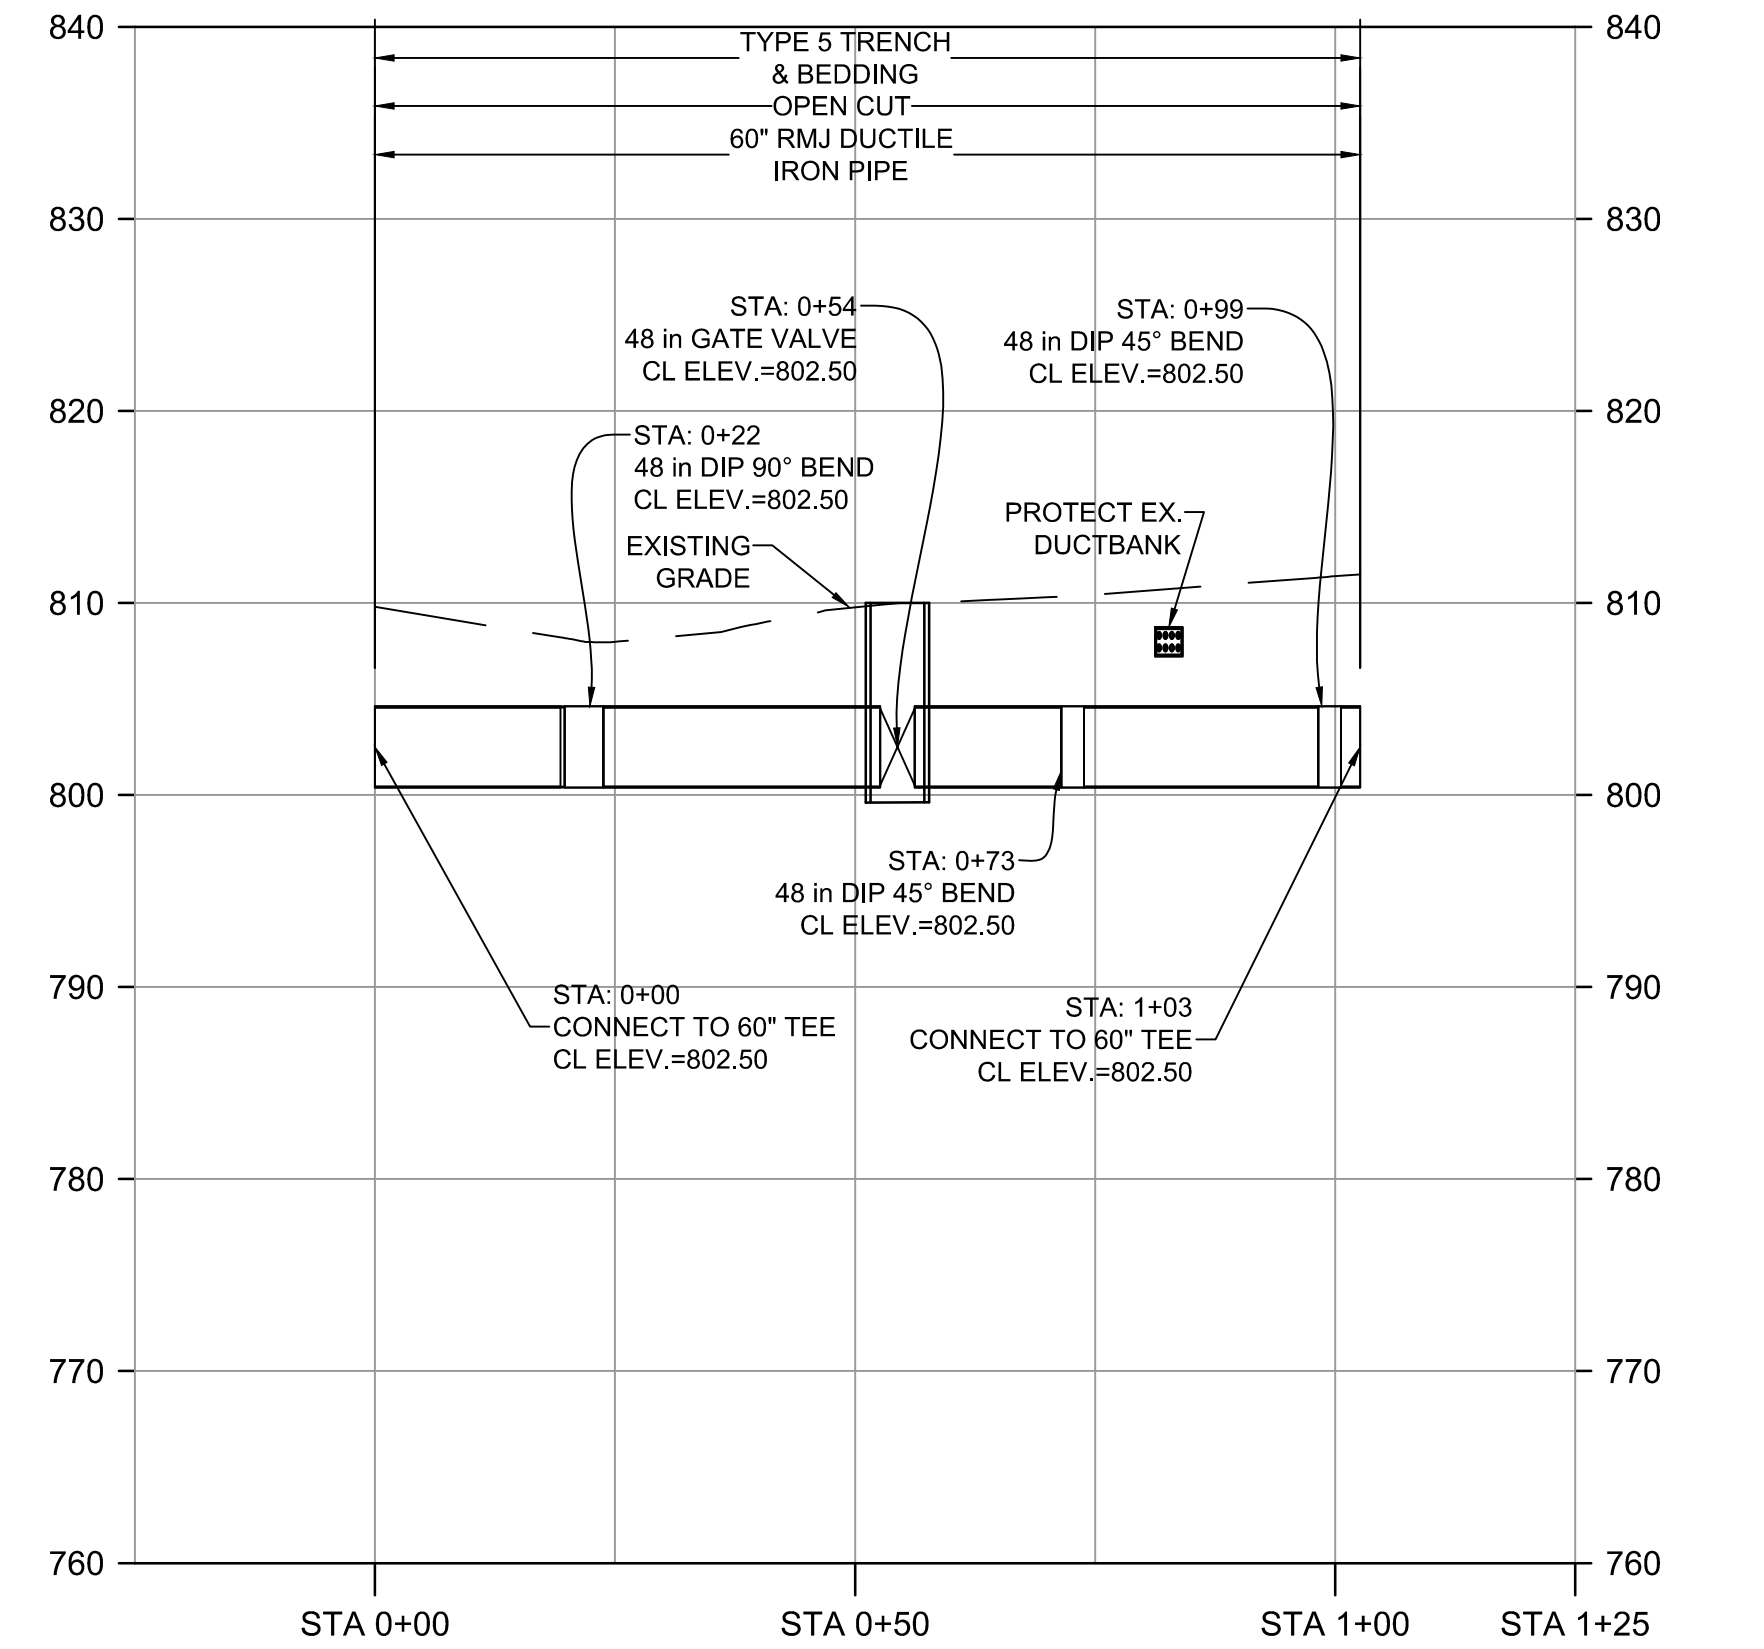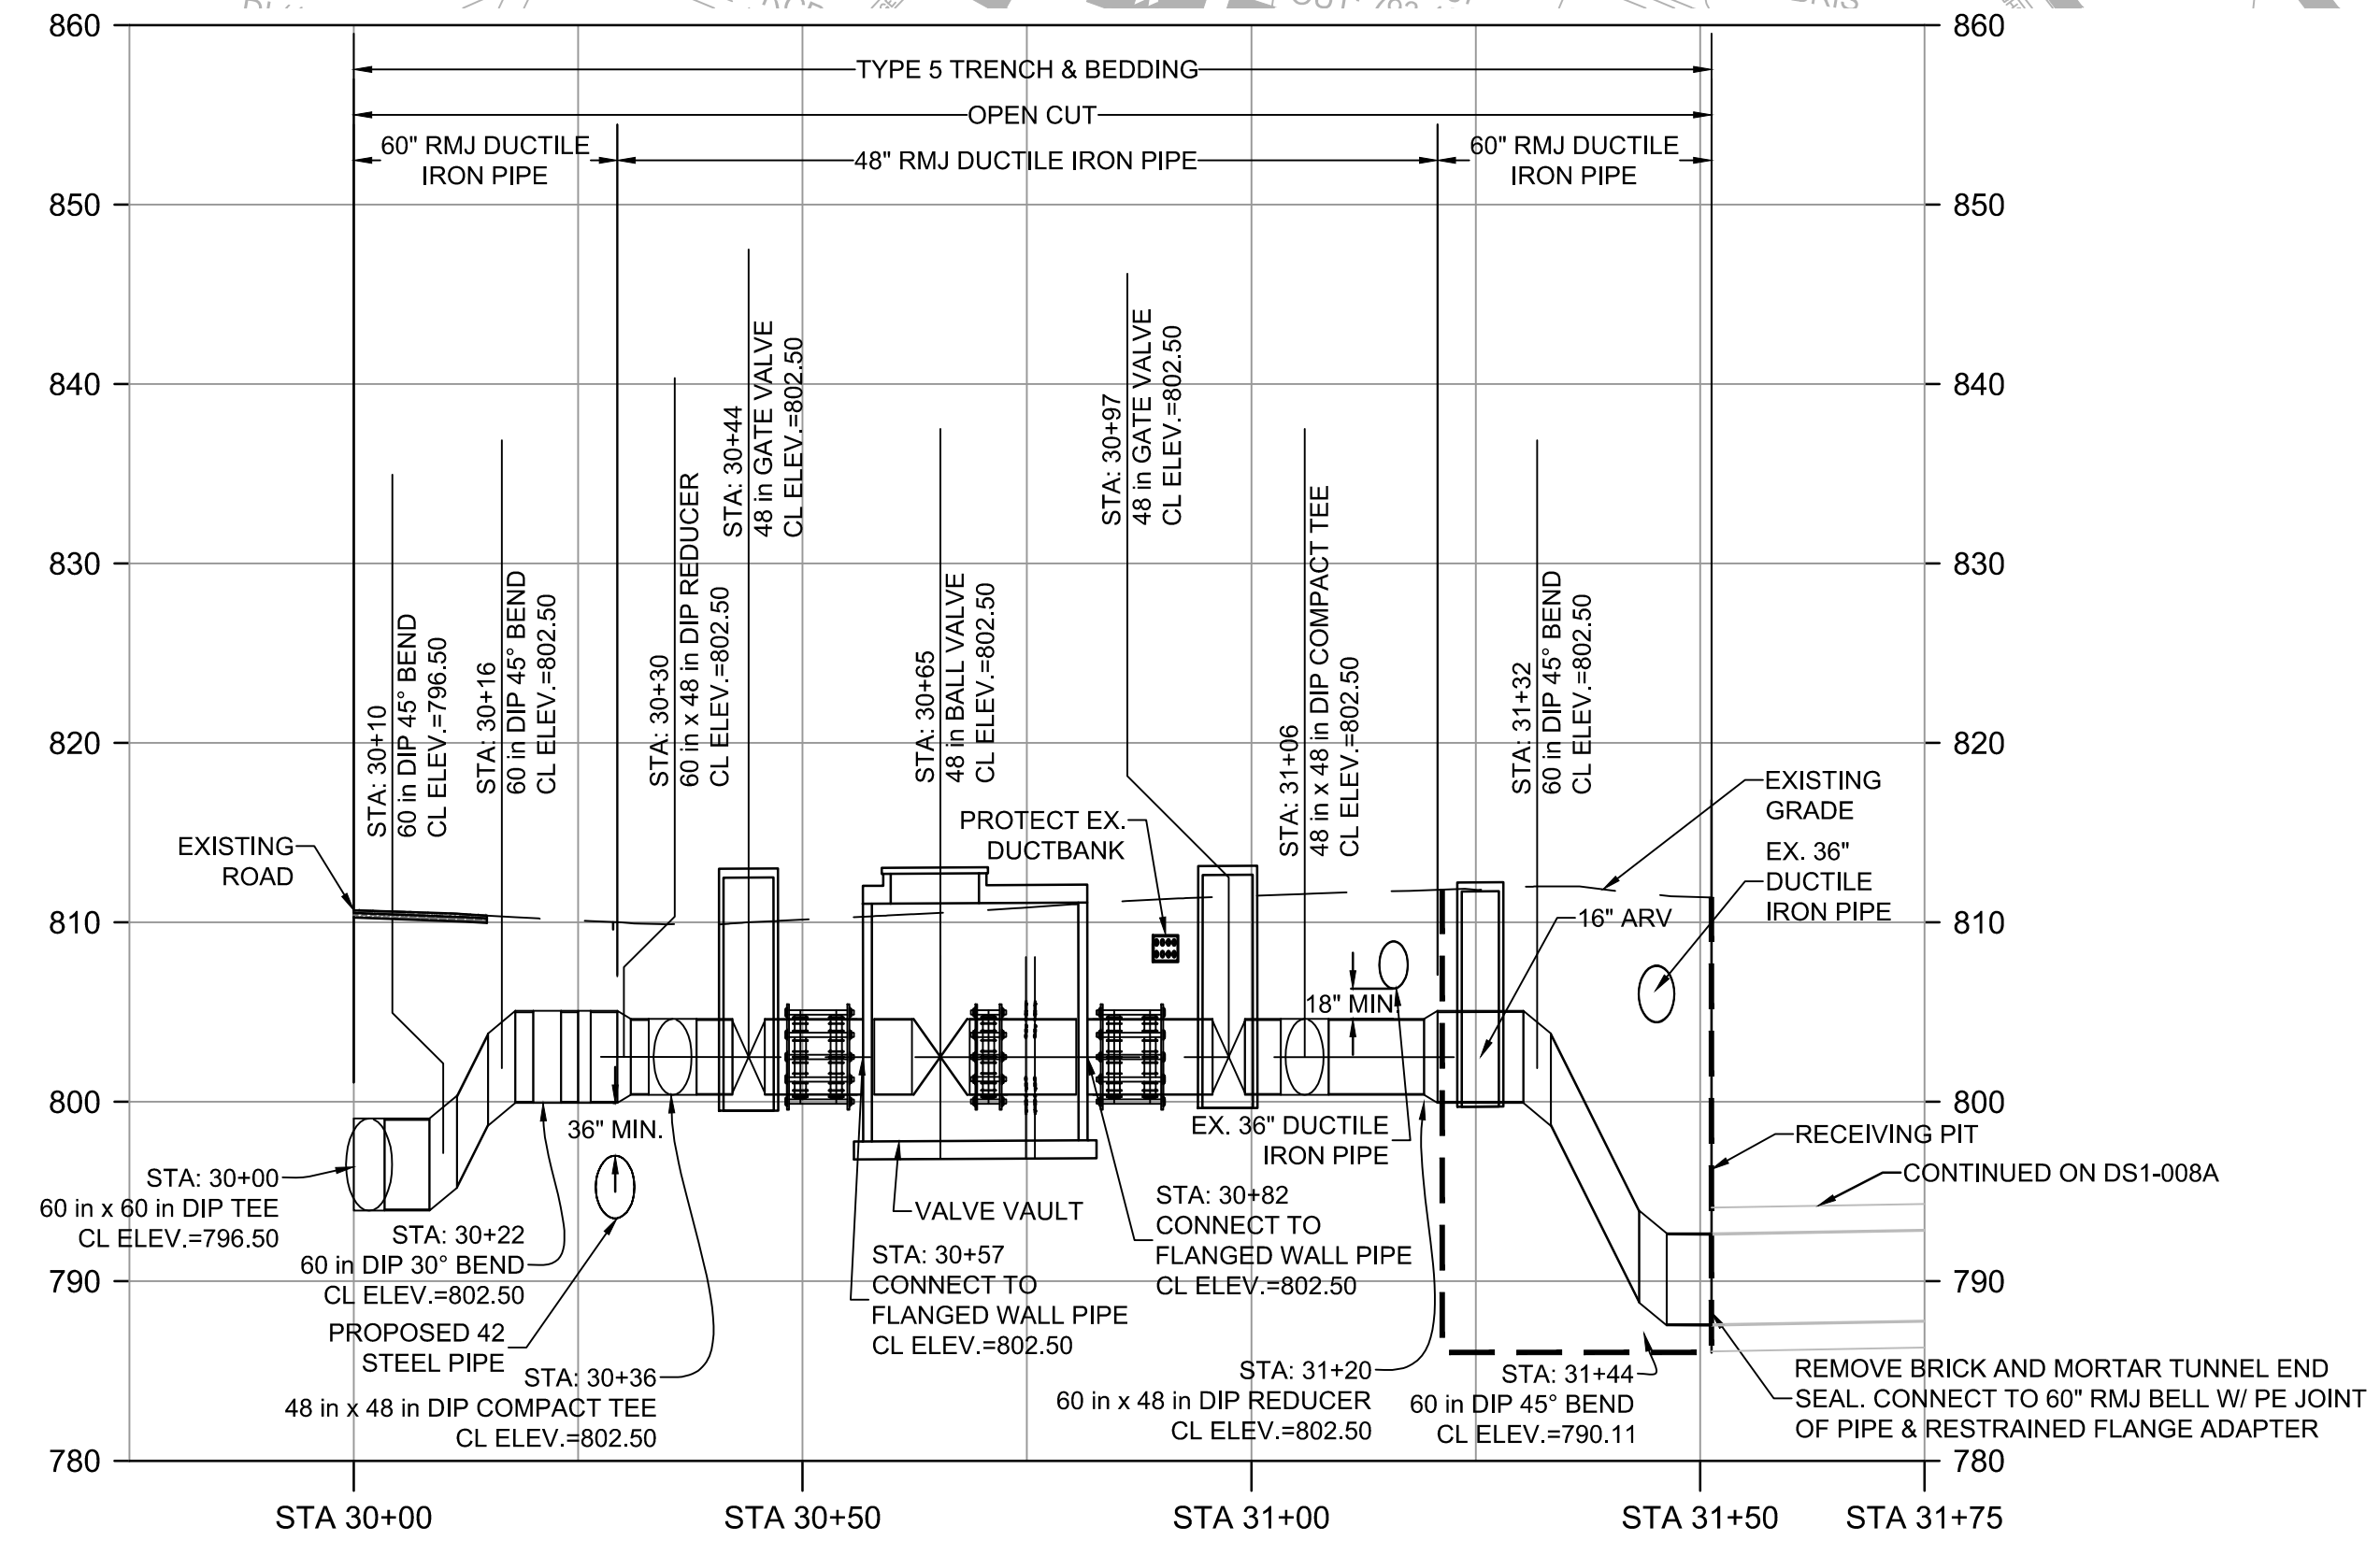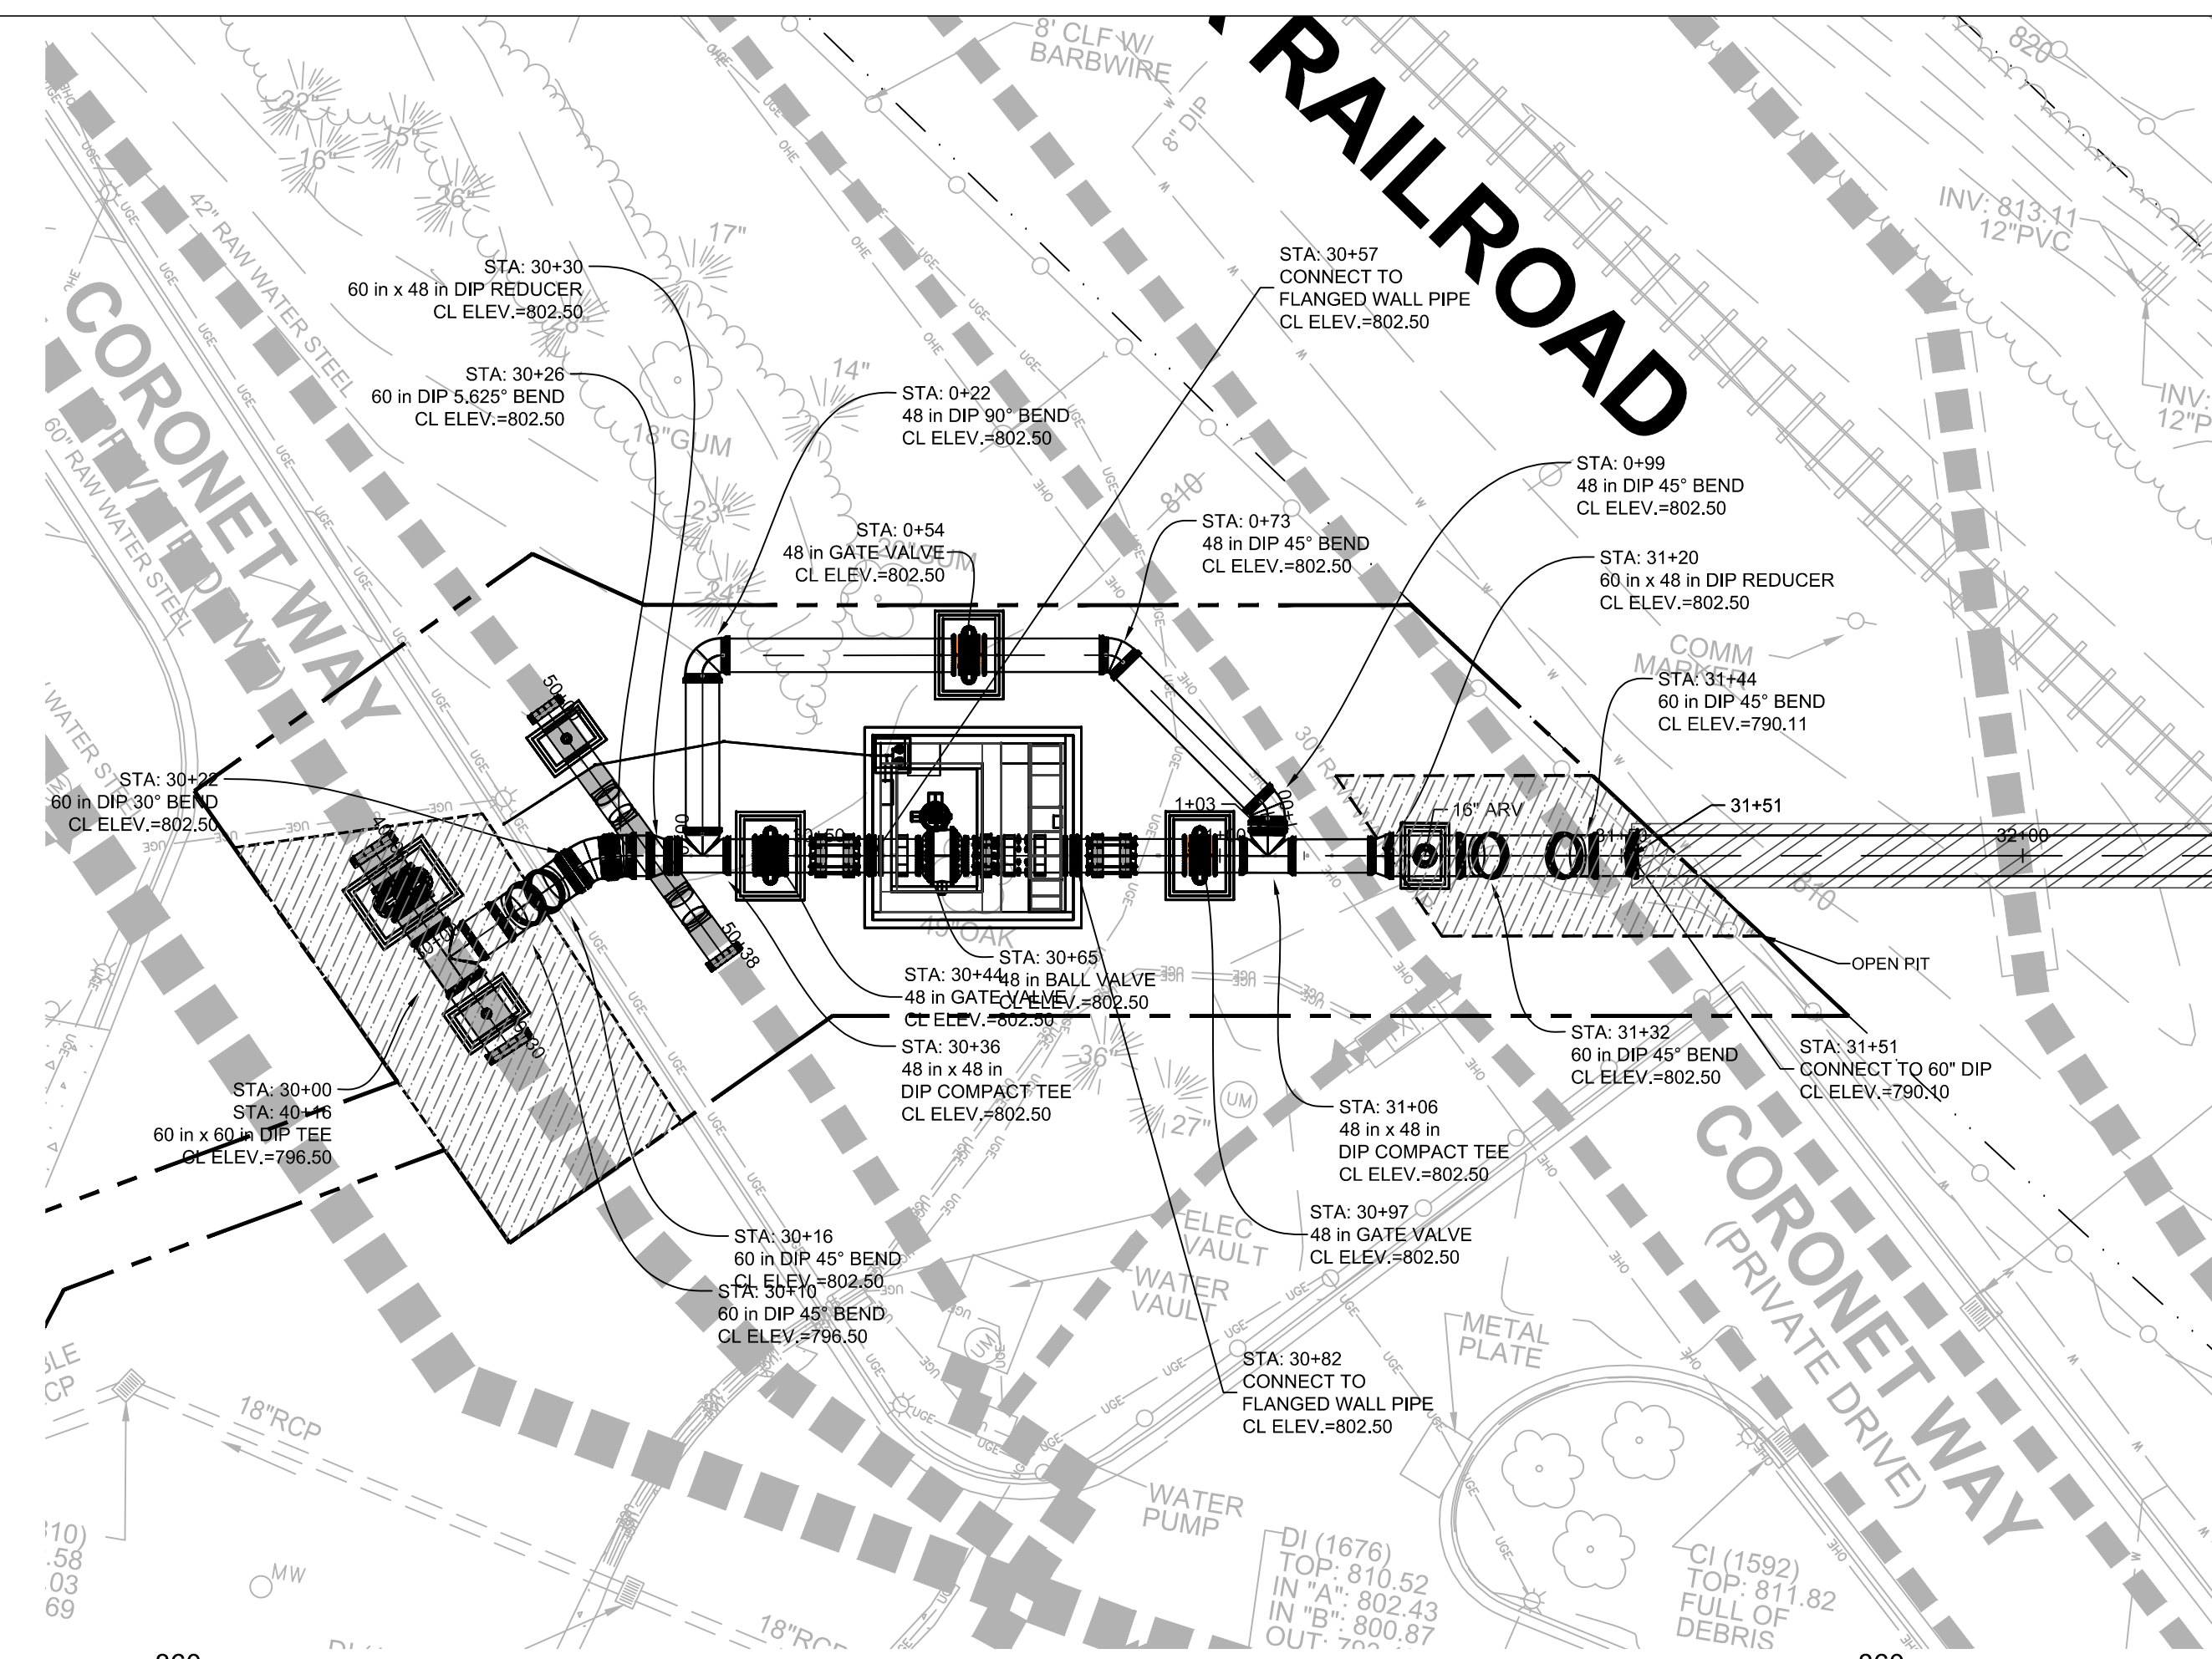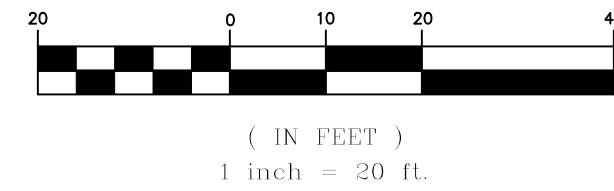

No.	Description	Date



ADDRESS:
 BGR2-JV
 6 CONCOURSE PARKWAY
 SUITE 1600
 ATLANTA, GA 30328
 (770) 569-7038 x101
 FAX: (770) 993-5082

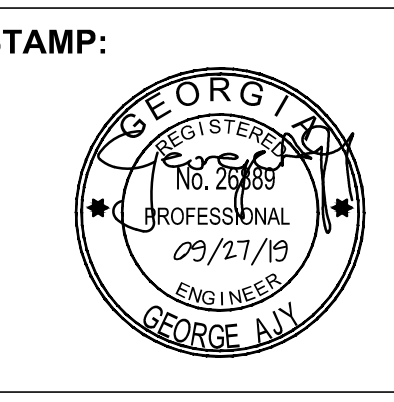PROJECT NO:	TASK_13
DESIGNED BY:	A.T.
DRAWN BY:	J.J.
CHECKED BY:	G.A.
DATE:	09/27/19
SCALE:	AS NOTED



**CITY OF ATLANTA DEPT. OF WATERSHED MANAGEMENT
 WATER SUPPLY PROGRAM**
**RIVER INTAKE PUMP STATION
 YARD PIPING
 PLAN & PROFILE**

DRAWING NO.
RI-PS
DS1-008B
 SHEET OF

ISSUED FOR BIDDING

NOTES:



1. FINAL ALIGNMENT OF THE PROPOSED 60-INCH RAW WATER MAIN MAY ALTER PENDING VERTICAL UTILITY DATA.
2. SURVEY IS SUPPLEMENTED BY ADDITIONAL INFORMATION AS RECEIVED FROM CITY OF ATLANTA GIS AND AS-BUILTS. CONTRACTOR TO VERIFY THE LOCATION OF ALL EXISTING UTILITIES.
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CONNECTION AT CHATTAHOOCHEE COMPLEX

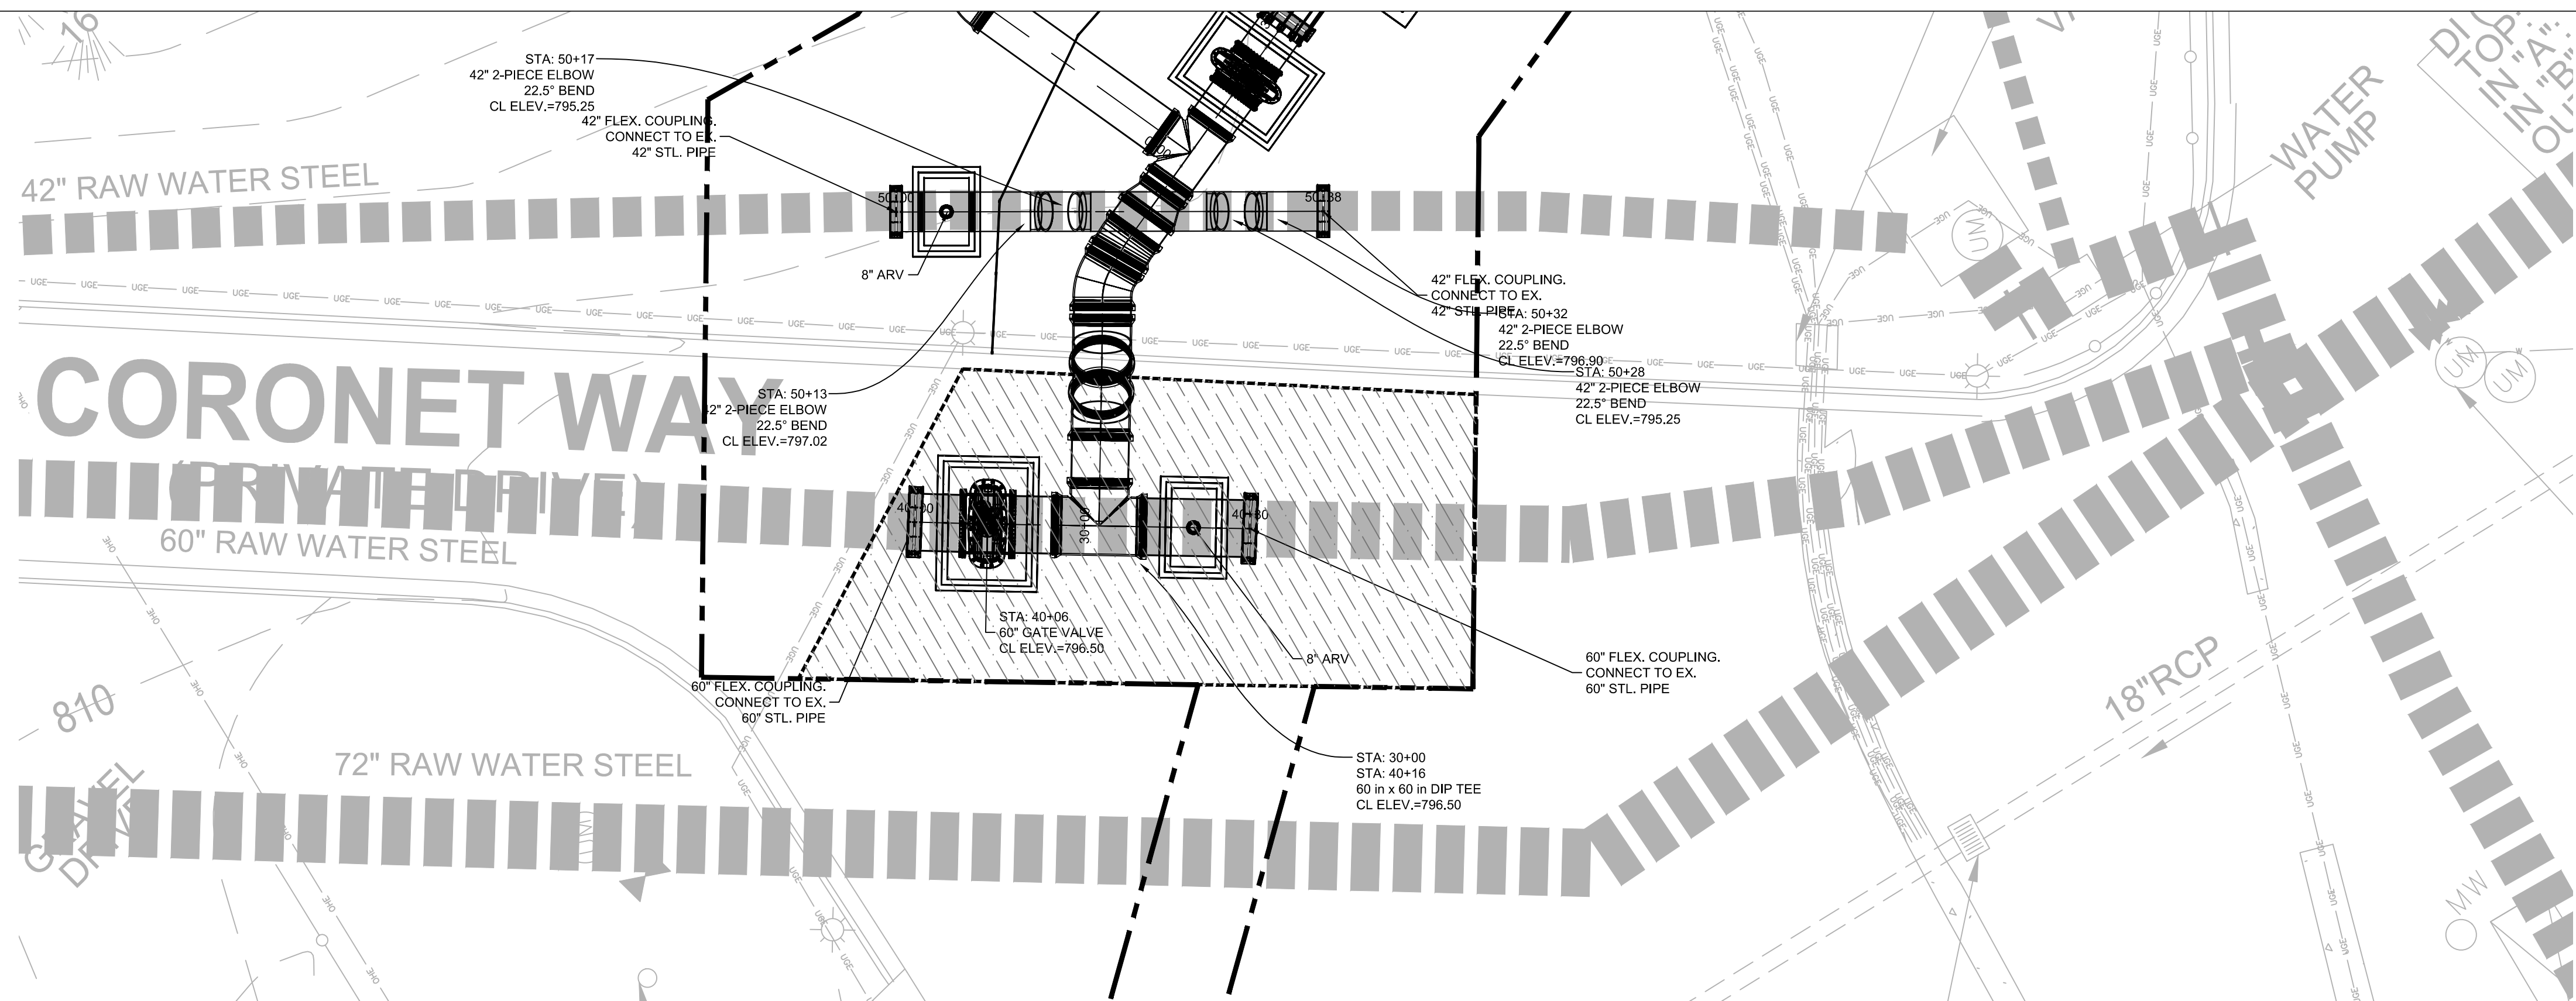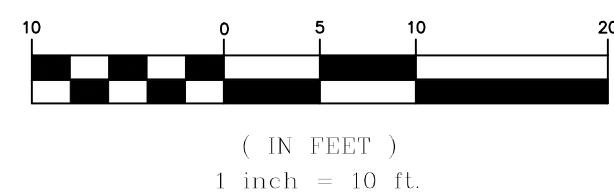SCALE: 1" = 10'-0"


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P:\City of Atlanta - Water Supply Program Phase \CD Drawings\PROCESS\PS DS1-008-009.dwg, PRINTED BY: hogan.barnes ON Thu, Dec 05 2019 AT 9:26 AM



No.	Description	Date

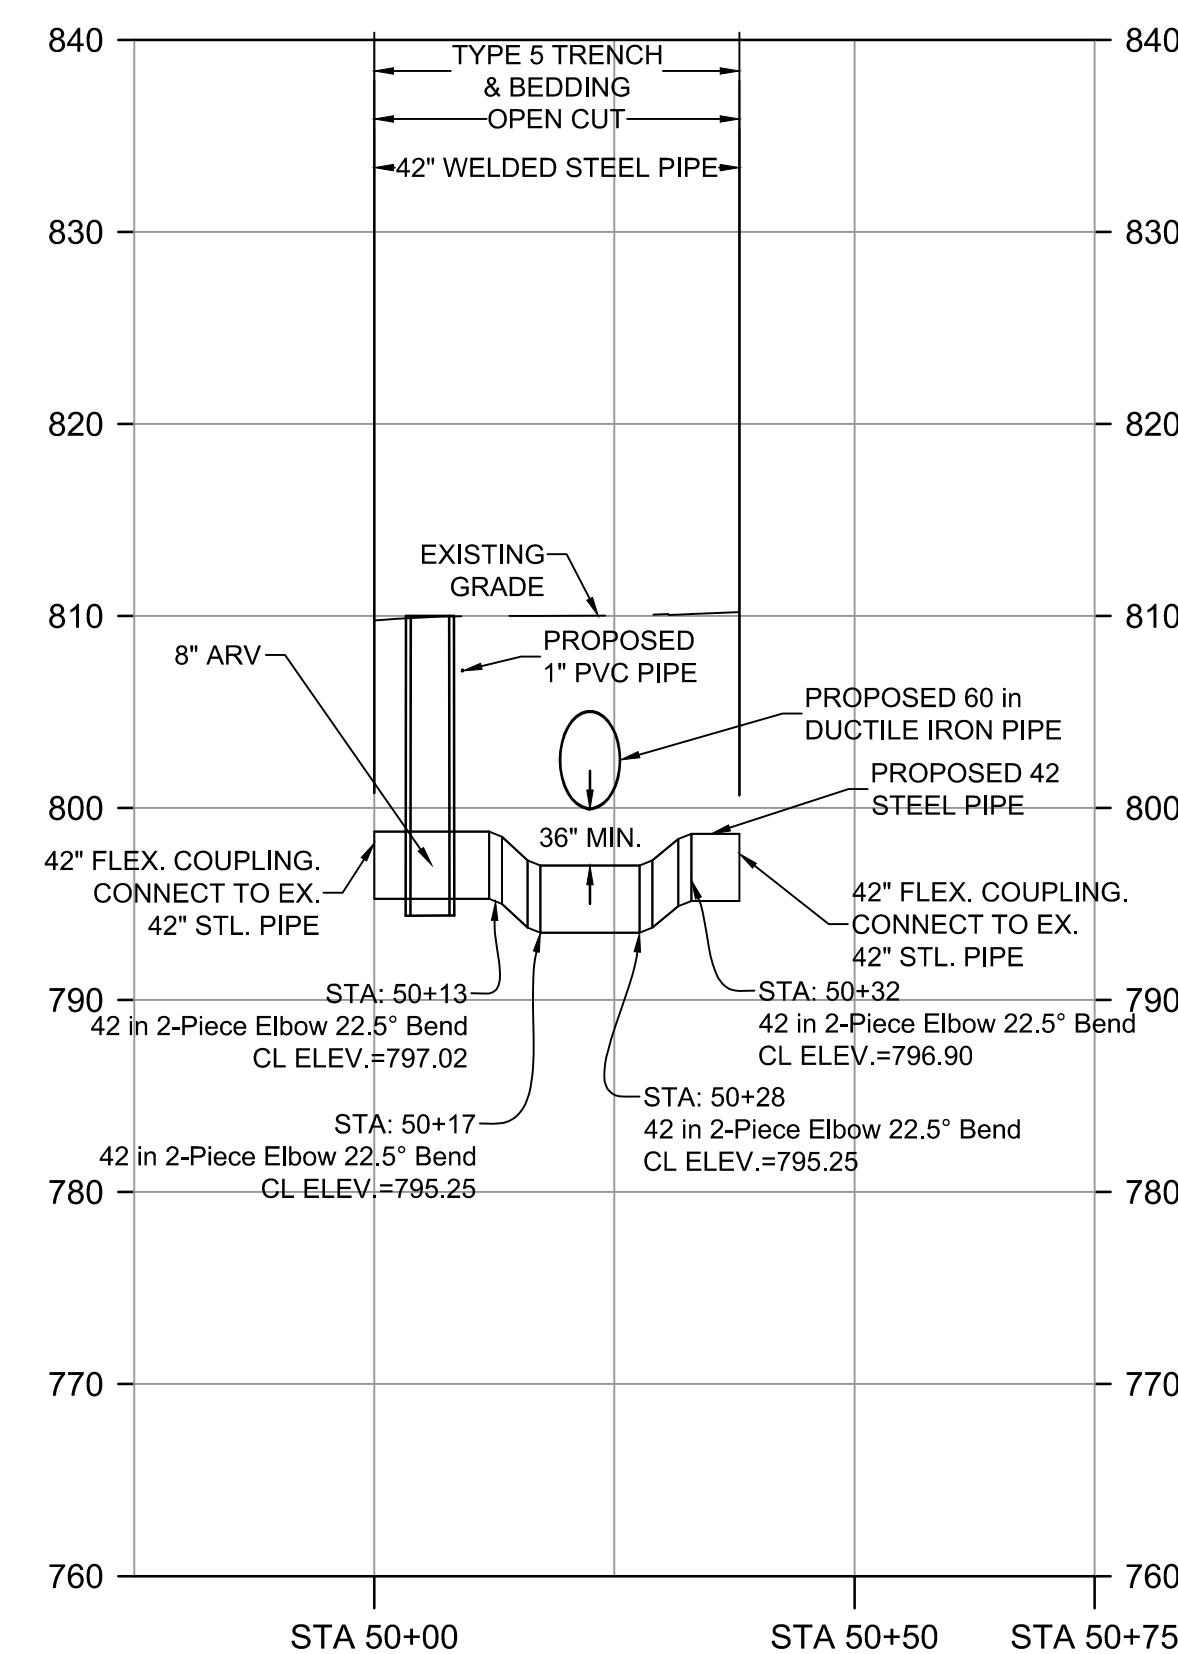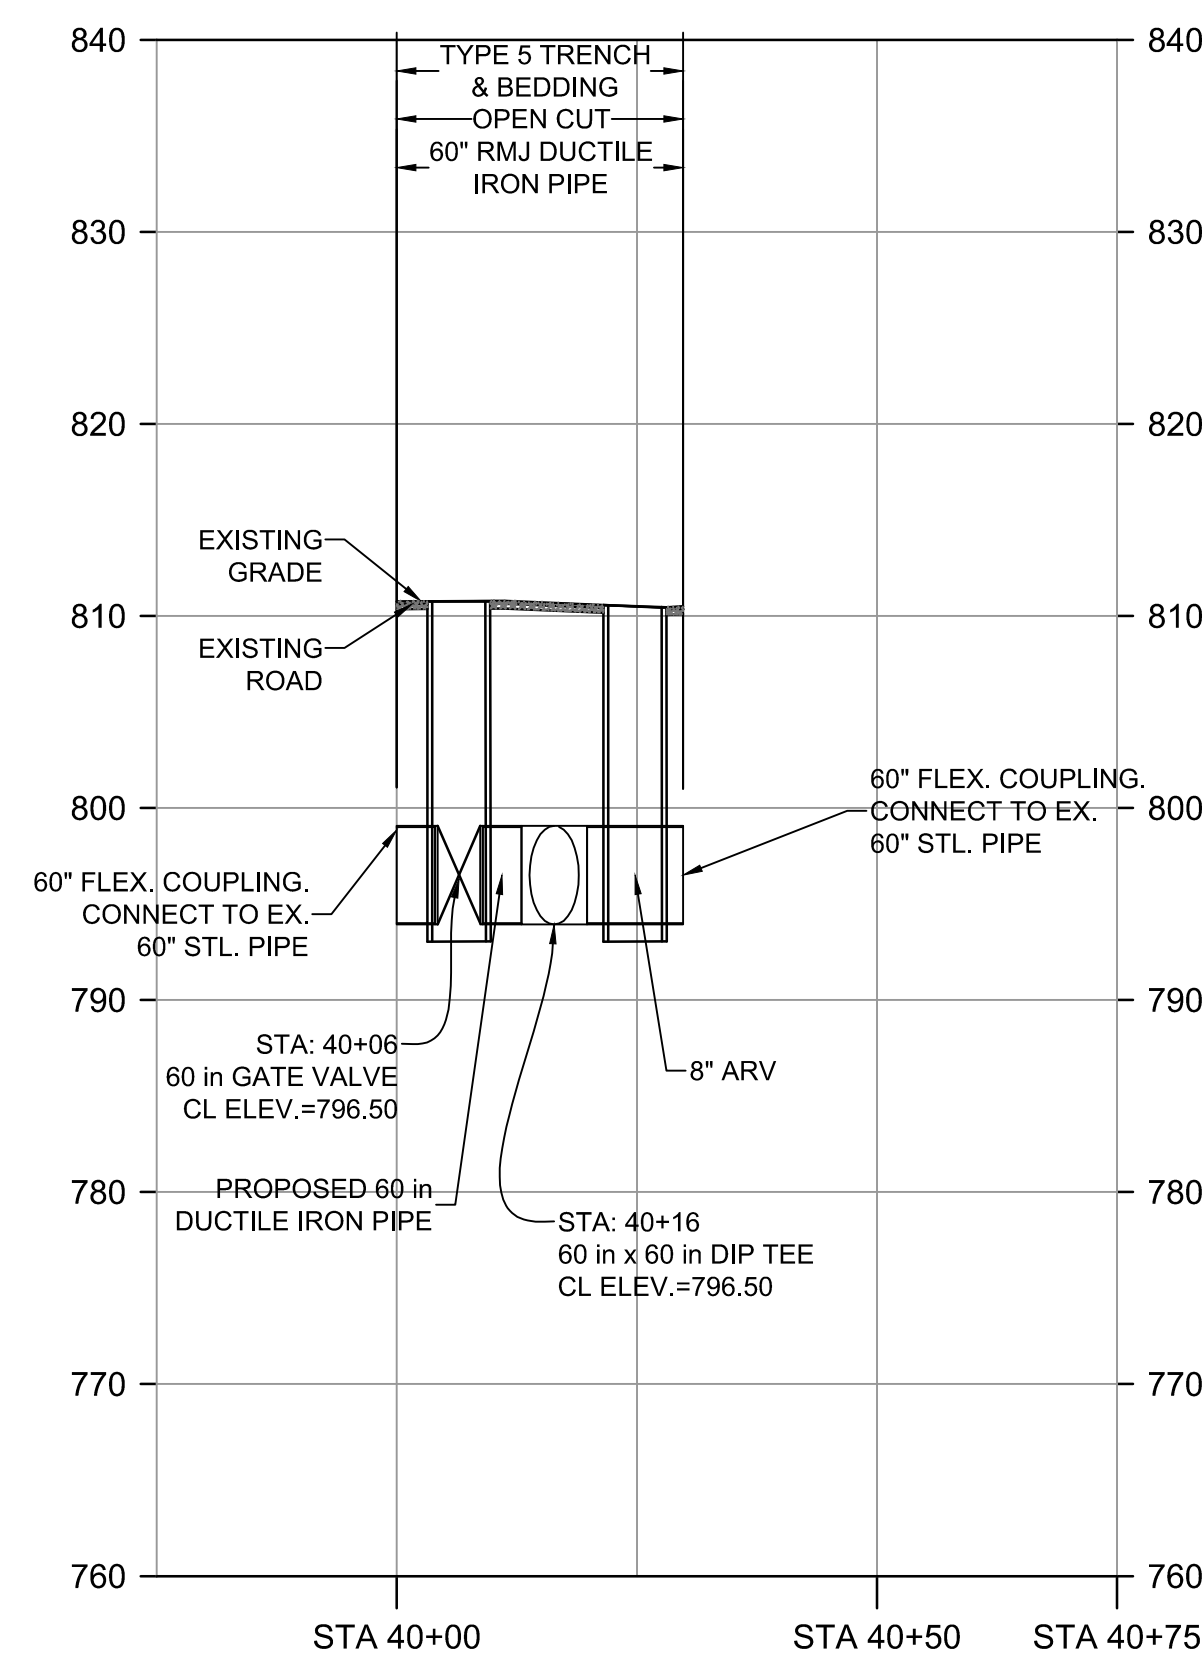

ADDRESS:
BGR2-JV
6 CONCOURSE PARKWAY
SUITE 1600
ATLANTA, GA 30328
(770) 569-7038 x101
FAX: (770) 993-5082

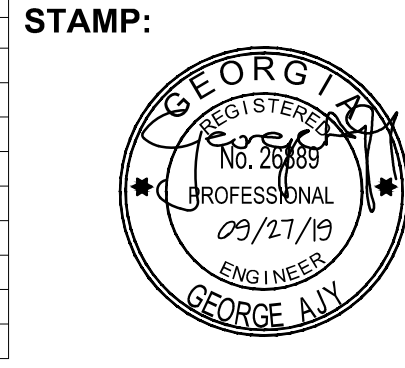PROJECT NO:	TASK_13
DESIGNED BY:	A.T.
DRAWN BY:	J.J.
CHECKED BY:	G.A.
DATE:	09/27/19
SCALE:	AS NOTED

**CITY OF ATLANTA DEPT. OF WATERSHED MANAGEMENT
WATER SUPPLY PROGRAM**

**RIVER INTAKE PUMP STATION
YARD PIPING
PLAN & PROFILE**


DRAWING NO.
RI-PS
DS1-009
SHEET OF

ISSUED FOR BIDDING

ABBREVIATIONS
 W1: POTABLE WATER (FROM CITY)
 W2: POTABLE WATER BACKFLOW PREVENTER
 W3: NON-POTABLE WATER (RAW WATER)

NOTES:

1. TRANSDUCERS SHALL BE TAPPED ONTO THE PIPE SPOOL PIECE PER MANUFACTURER'S RECOMMENDATIONS.
2. STAIRS AND LADDERS BY STAIR MFR.

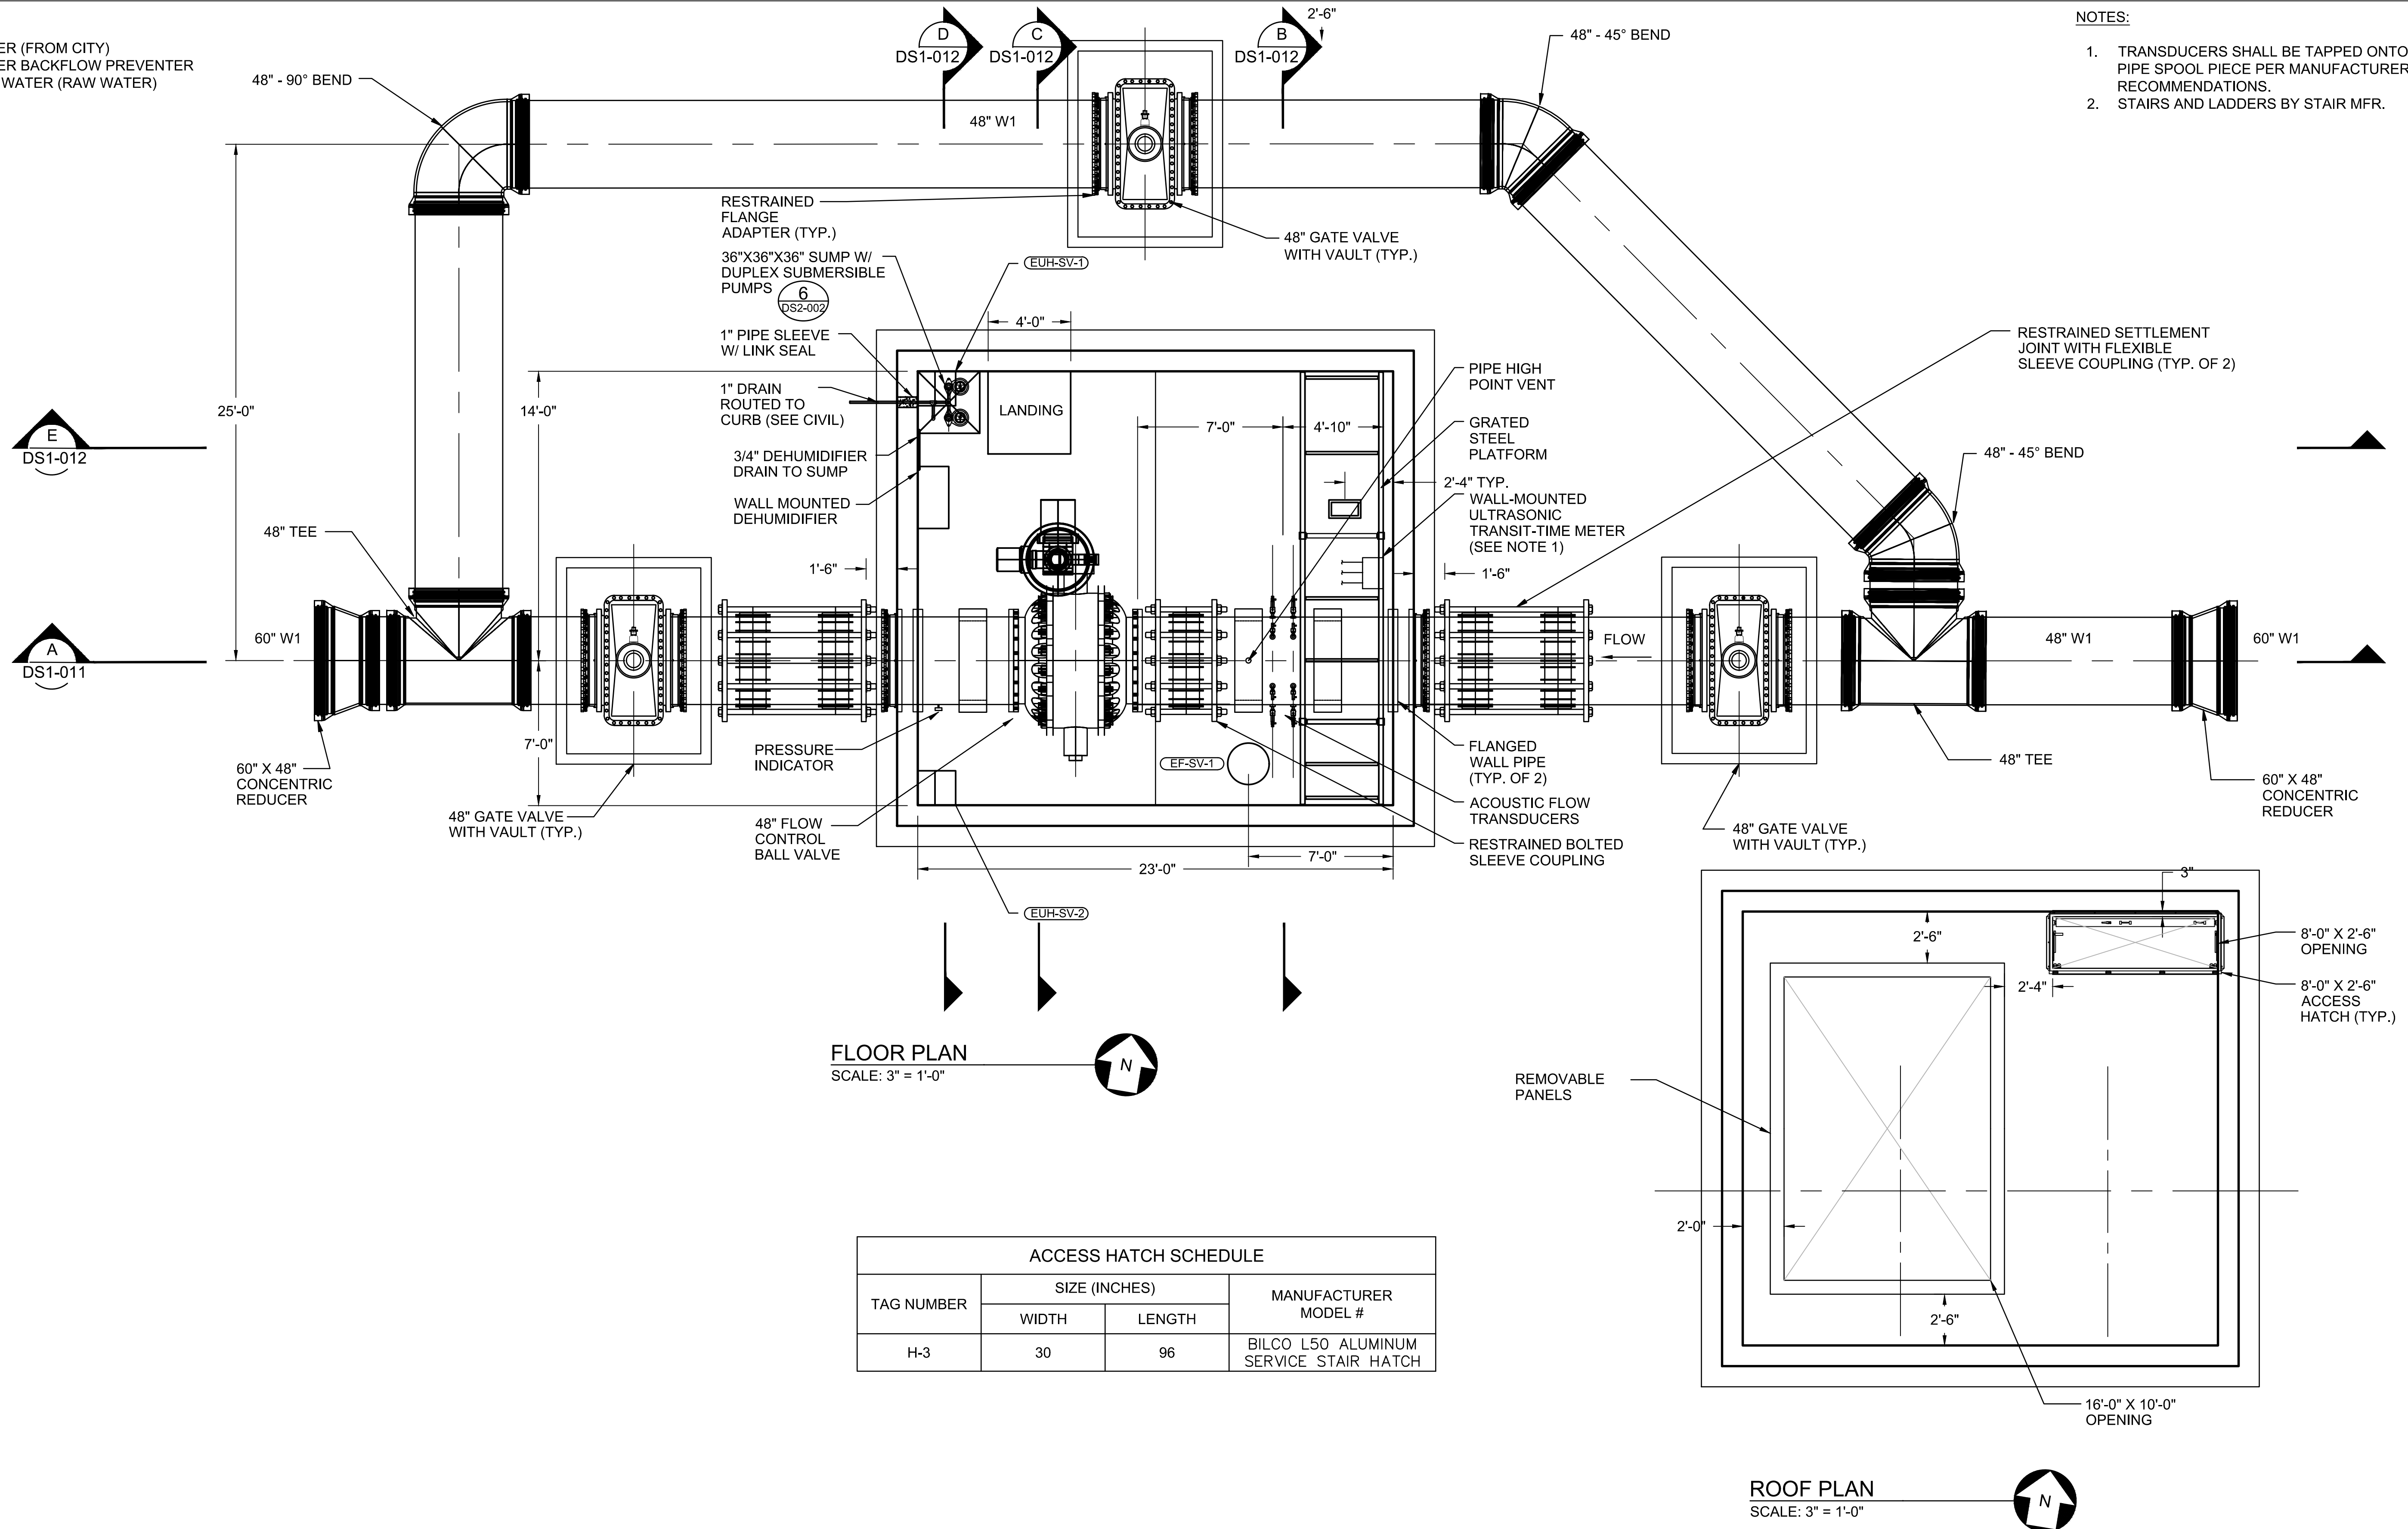

FLOOR PLAN
 SCALE: 3" = 1'-0"

ROOF PLAN
 SCALE: 3" = 1'-0"


ACCESS HATCH SCHEDULE			
TAG NUMBER	SIZE (INCHES)		MANUFACTURER MODEL #
	WIDTH	LENGTH	
H-3	30	96	BILCO L50 ALUMINUM SERVICE STAIR HATCH

P:\City of Atlanta - Water Supply Program Phase 1\CD Drawings\PROCESS\B-P\DS1-010-012.dwg, PRINTED BY: Hoop/Barnes ON Thu, Dec 05 2019 AT 9:35 AM



No.	Description	Date

STAMP:

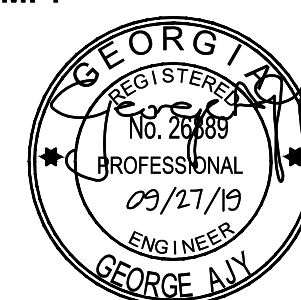

ADDRESS:

BGR2-JV
 6 CONCOURSE PARKWAY
 SUITE 1600
 ATLANTA, GA 30328
 (770) 569-7038 x101
 FAX: (770) 993-5082

PROJECT NO:	TASK_13
DESIGNED BY:	A.T.
DRAWN BY:	H.B.
CHECKED BY:	G.A.
DATE:	09/27/19
SCALE:	AS NOTED

CITY OF ATLANTA DEPT. OF WATERSHED MANAGEMENT
 WATER SUPPLY PROGRAM

RIVER INTAKE PUMP STATION
 VALVE VAULT
 PLAN

DRAWING NO.

RI-PS


DS1-010

SHEET OF

ISSUED FOR BIDDING

ABBREVIATIONS
 W1: POTABLE WATER (FROM CITY)
 W2: POTABLE WATER BACKFLOW PREVENTER
 W3: NON-POTABLE WATER (RAW WATER)

- NOTES:
1. TRANSDUCERS SHALL BE TAPPED ONTO THE PIPE SPOOL PIECE PER MANUFACTURER'S RECOMMENDATIONS.
 2. STAIRS AND LADDERS BY STAIR MFR.

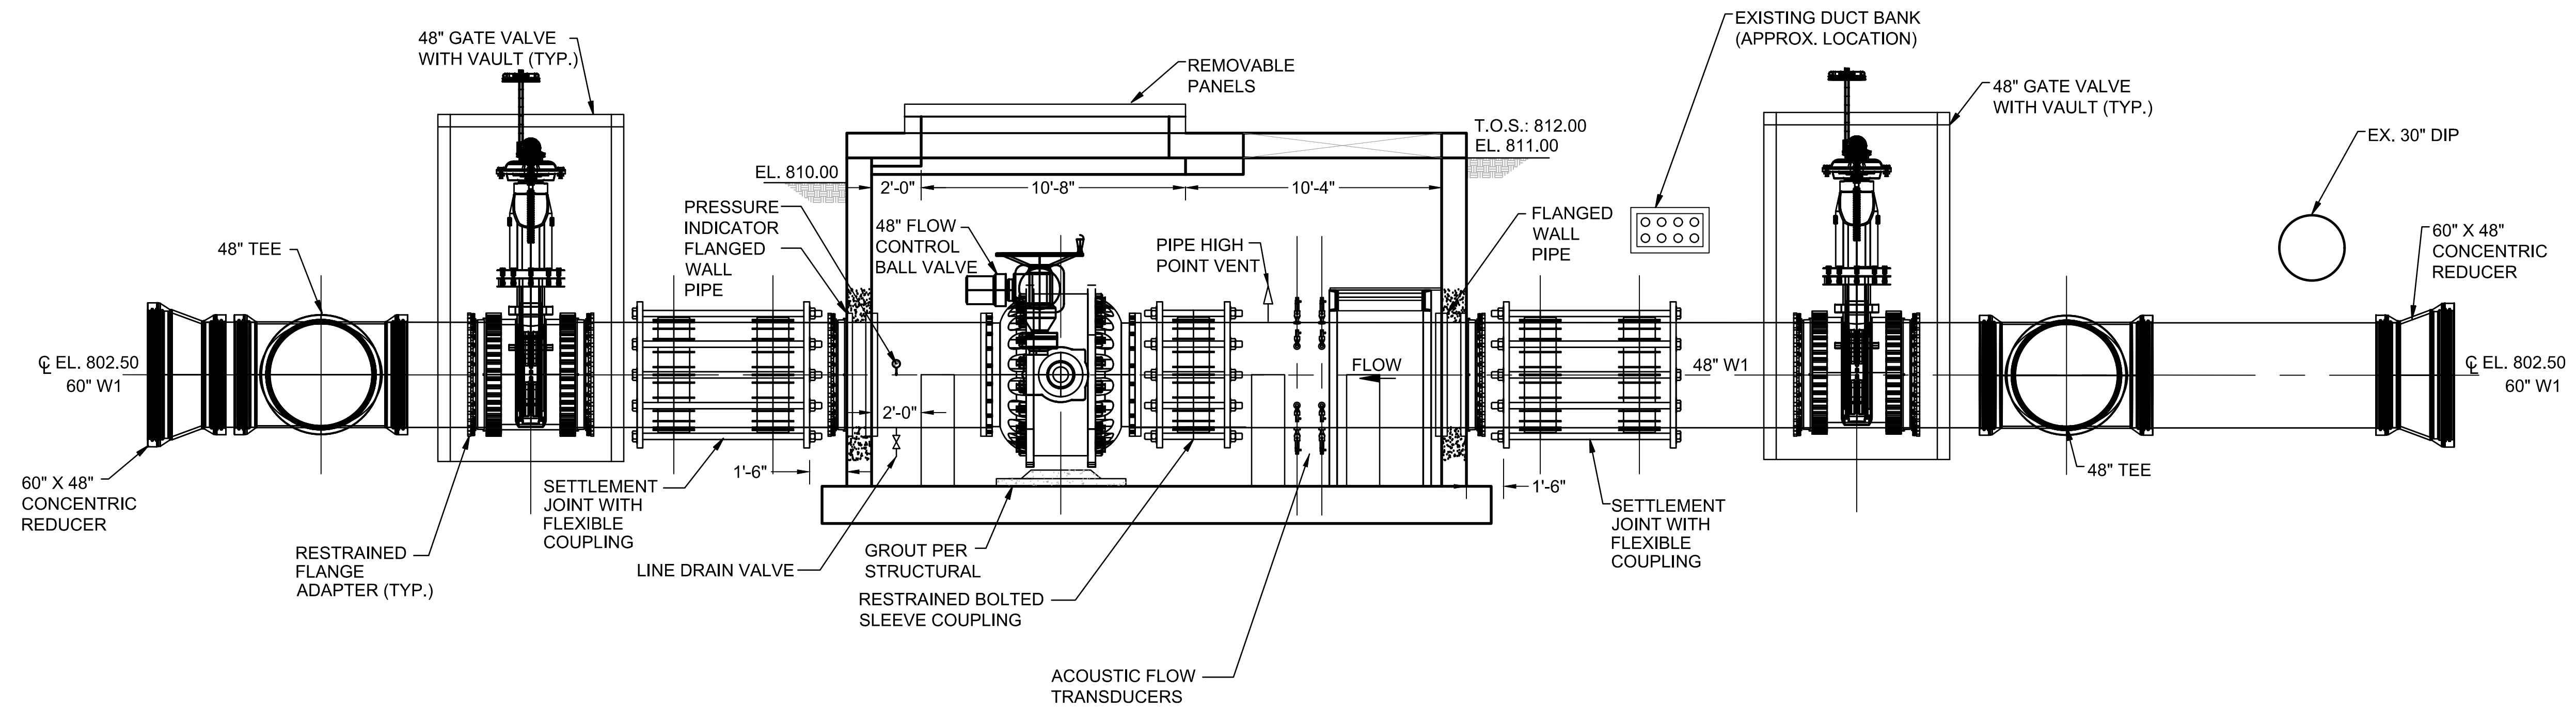


Vault Section A-A
 SCALE: 3" = 1'-0"

P:\City of Atlanta - Water Supply Program Phase 1\CD Drawings\PROCESS\RI-PS DS1-011.dwg, PRINTED BY: Healy, Barnes ON Thu, Dec 05 2019 AT 9:35 AM



No.	Description	Date

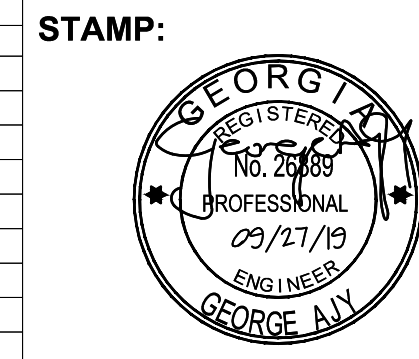

ADDRESS:
 BGR2-JV
 6 CONCOURSE PARKWAY
 SUITE 1600
 ATLANTA, GA 30328
 (770) 569-7038 x101
 FAX: (770) 993-5082

PROJECT NO:	TASK_13
DESIGNED BY:	A.T.
DRAWN BY:	H.B.
CHECKED BY:	G.A.
DATE:	09/27/19
SCALE:	AS NOTED

CITY OF ATLANTA DEPT. OF WATERSHED MANAGEMENT
WATER SUPPLY PROGRAM
RIVER INTAKE PUMP STATION
 VALVE VAULT
 SECTIONS


DRAWING NO.
RI-PS
DS1-011
 SHEET OF

ISSUED FOR BIDDING


ABBREVIATIONS
W1: POTABLE WATER (FROM CITY)
W2: POTABLE WATER BACKFLOW PREVENTER
W3: NON-POTABLE WATER (RAW WATER)

NOTES:


1. TRANSDUCERS SHALL BE TAPPED ONTO THE PIPE SPOOL PIECE PER MANUFACTURER'S RECOMMENDATIONS.
2. STAIRS AND LADDERS BY STAIR MFR.

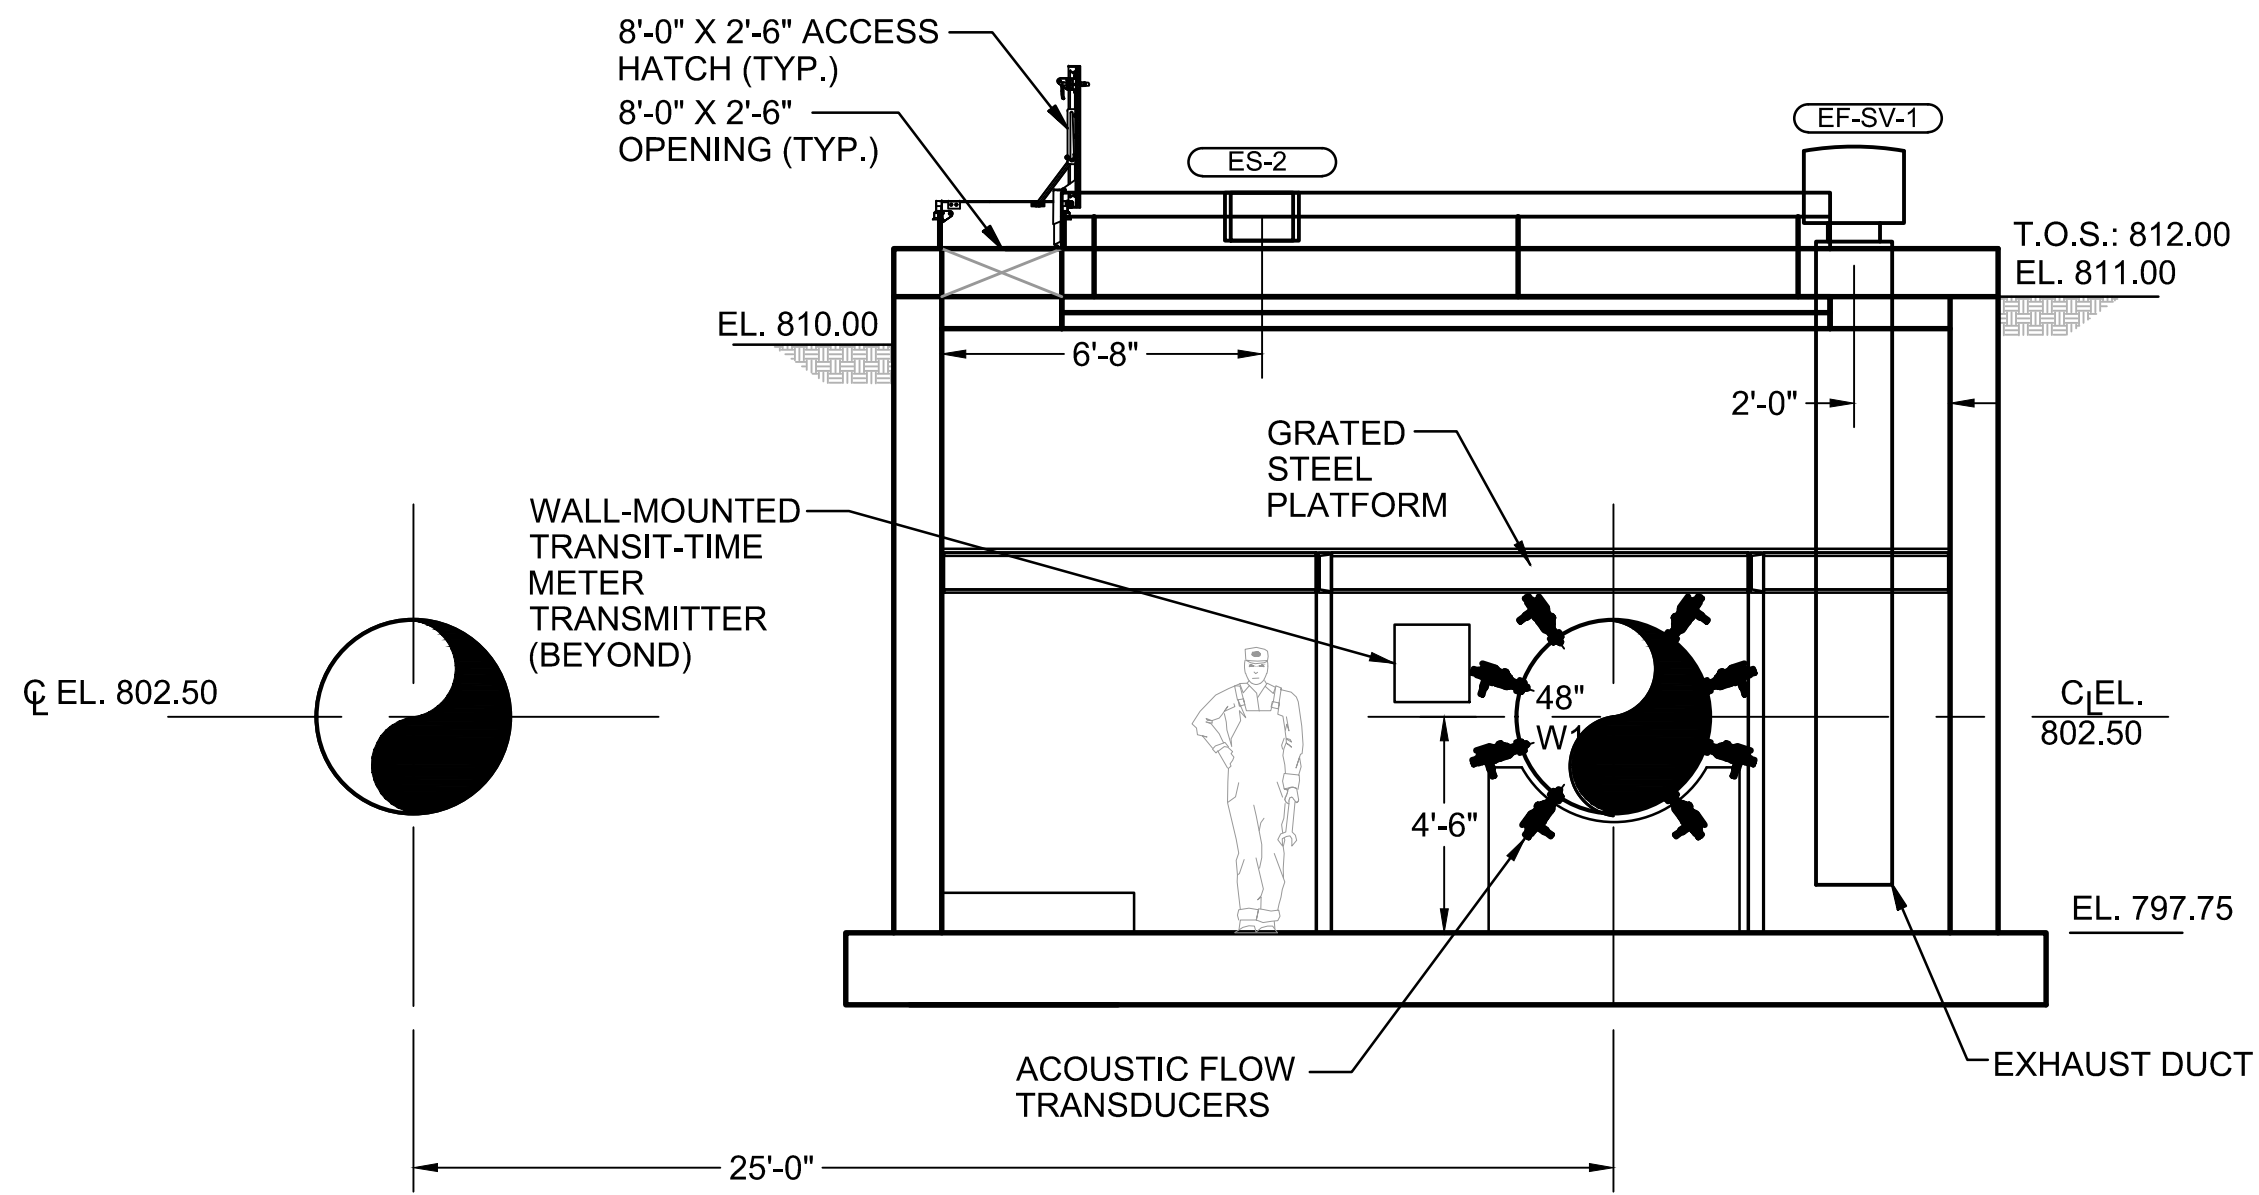


VAULT SECTION B-B
SCALE: 3" = 1'-0"

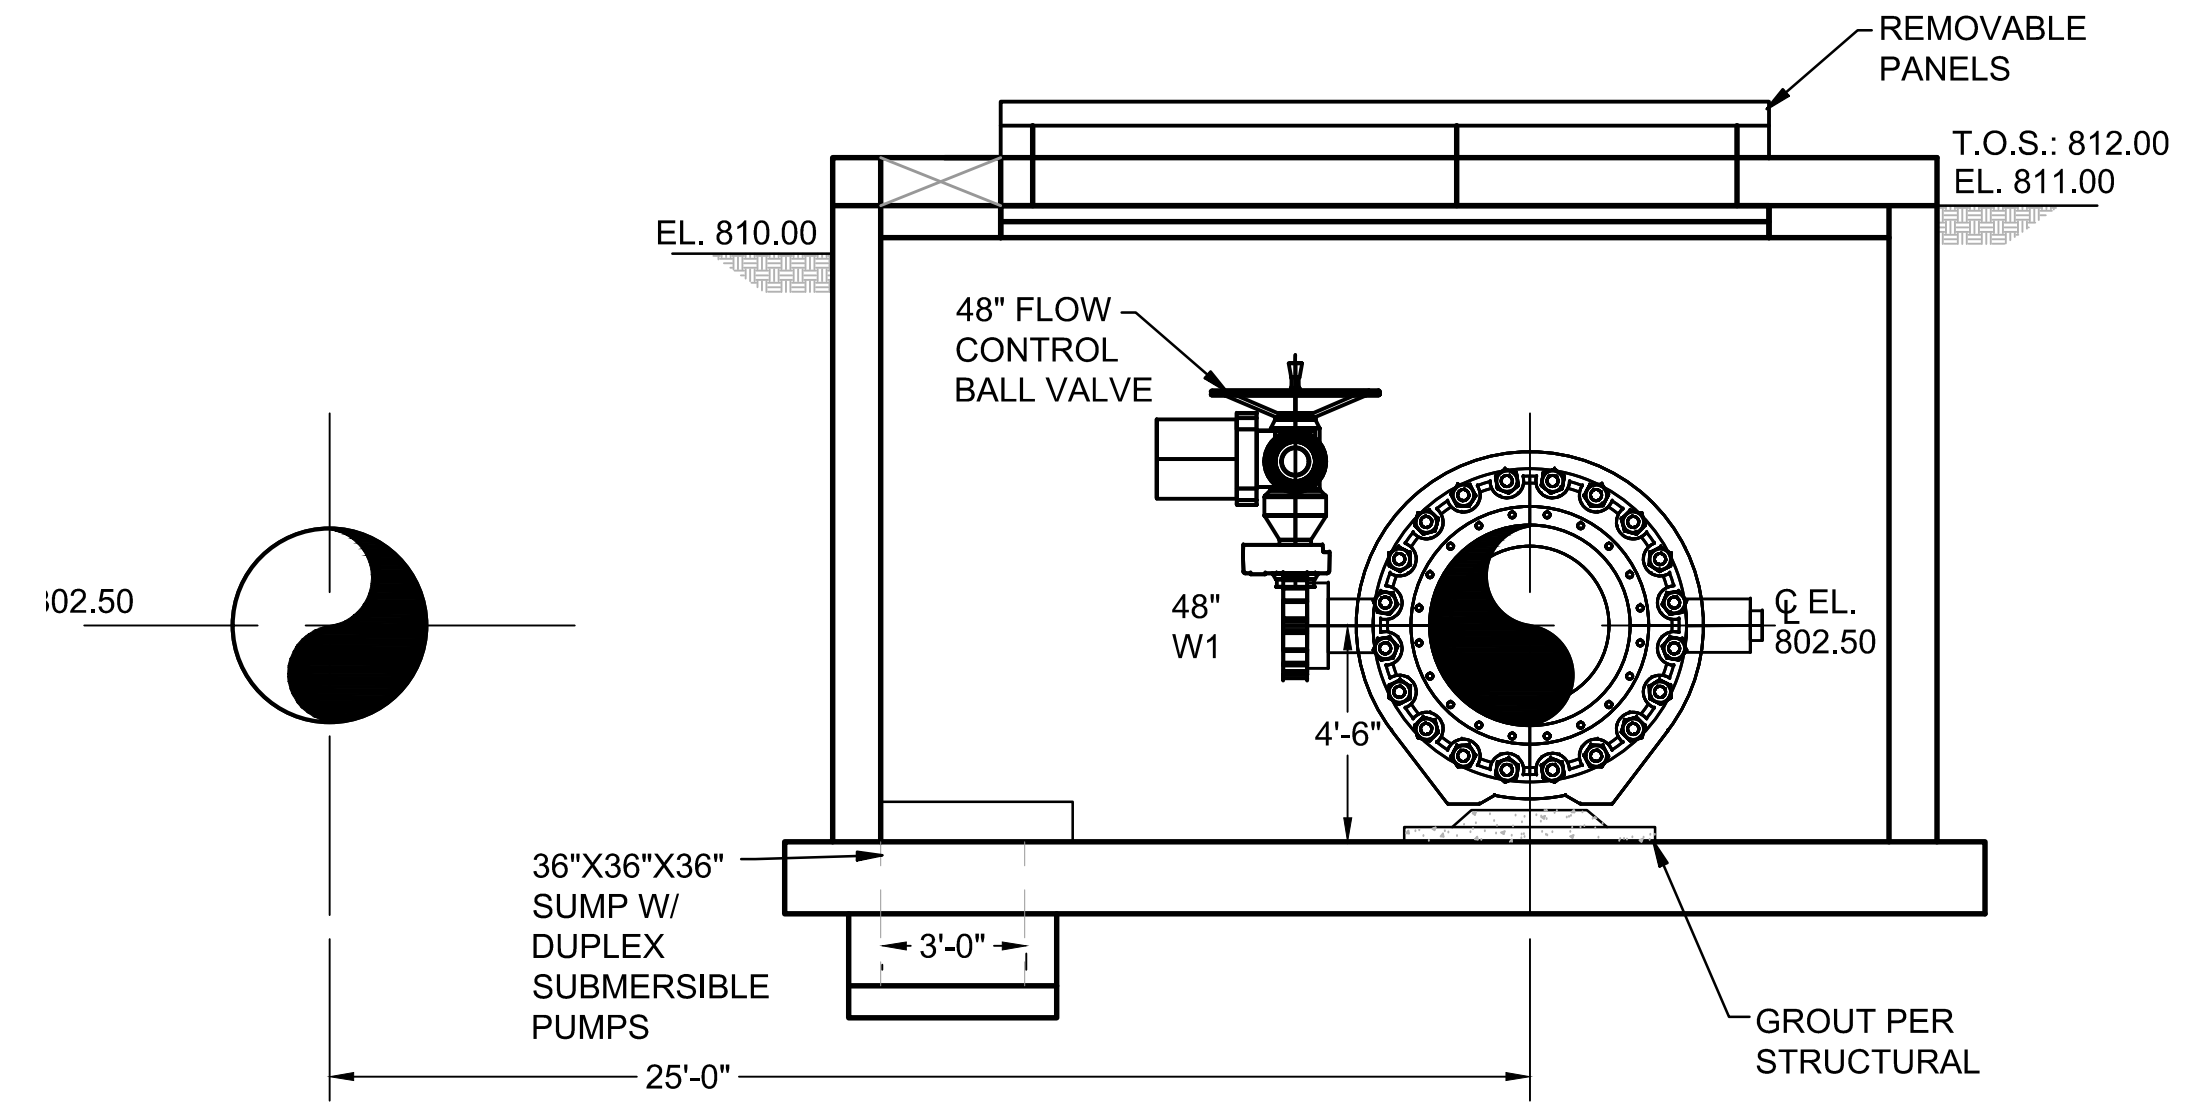

VAULT SECTION C-C
SCALE: 3" = 1'-0"

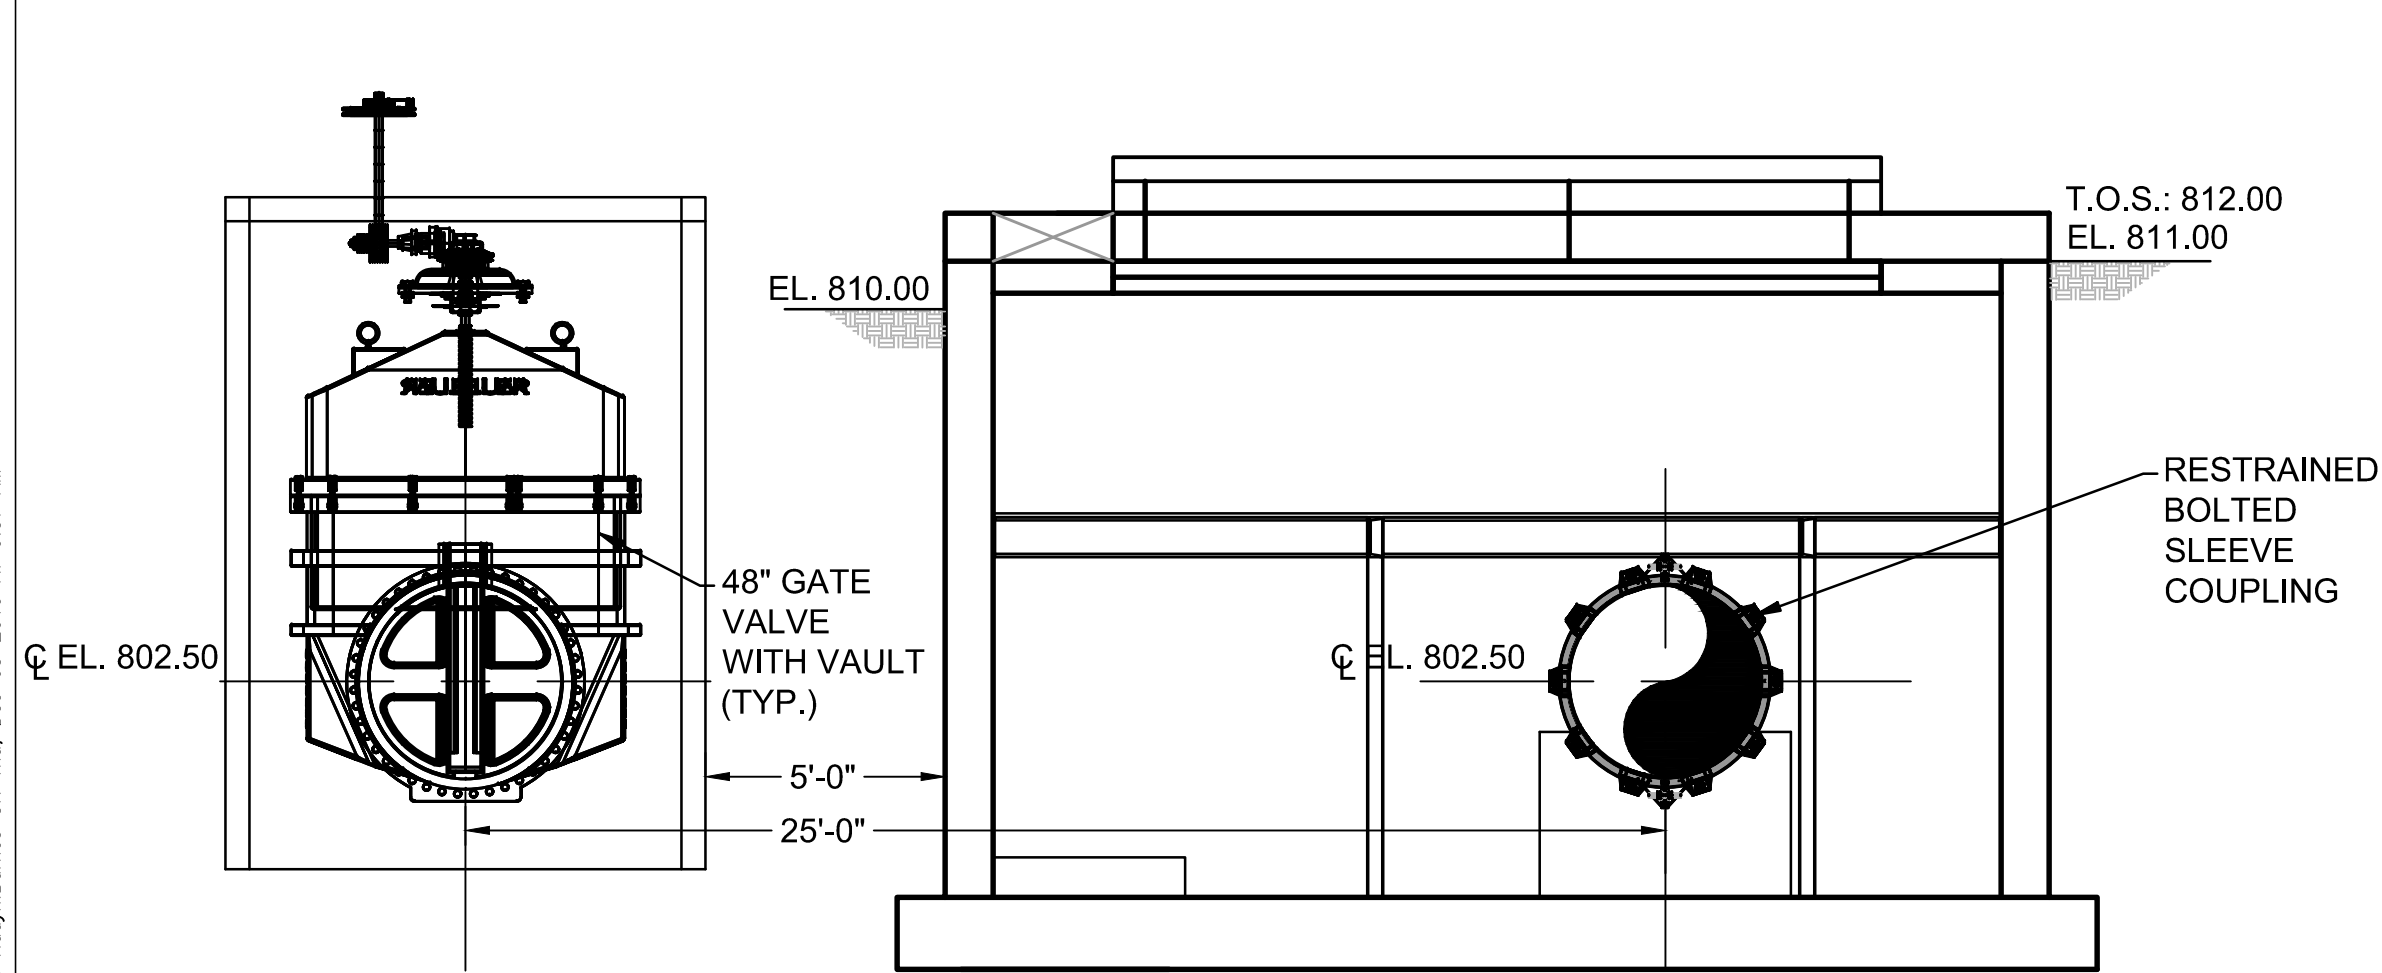

VAULT SECTION D-D
SCALE: 3" = 1'-0"

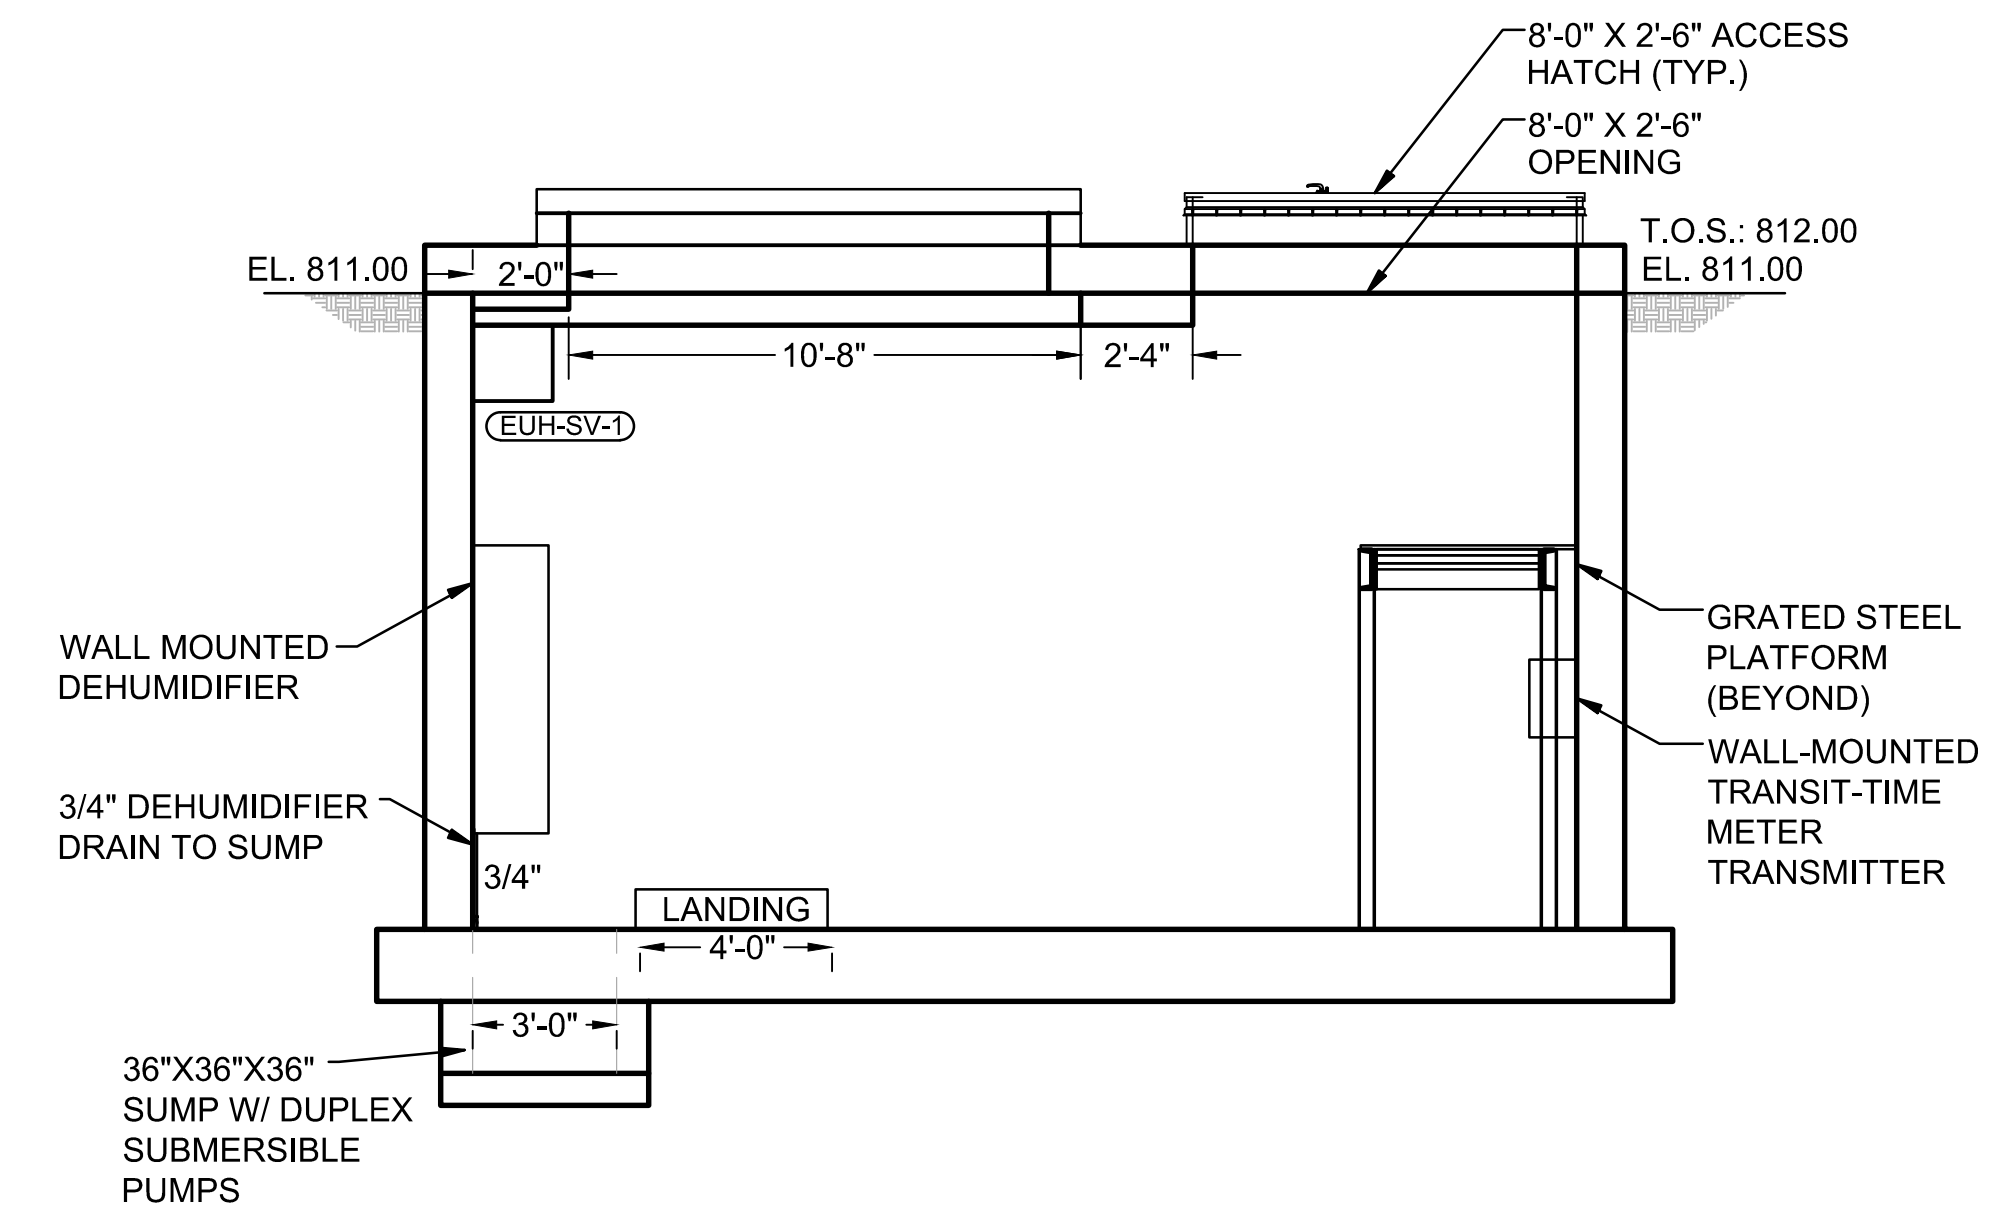


VAULT SECTION E-E
SCALE: 3" = 1'-0"

P:\City of Atlanta - Water Supply Program Phase \ACD Drawings\PROCESS\B-P5 DS1-012.dwg, PRINTED BY: Hoop/Burns ON Thu, Dec 05, 2019 AT 9:37 AM



No.	Description	Date

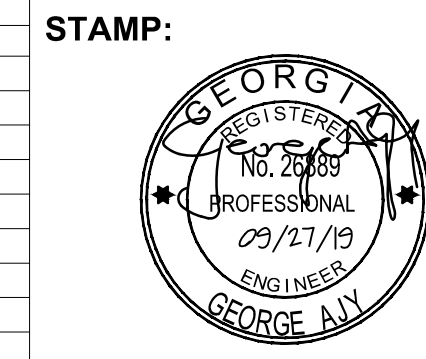


ADDRESS:
BGR2-JV
6 CONCOURSE PARKWAY
SUITE 1600
ATLANTA, GA 30328
(770) 569-7038 x101
FAX: (770) 993-5082

PROJECT NO:	TASK_13
DESIGNED BY:	A.T.
DRAWN BY:	H.B.
CHECKED BY:	G.A.
DATE:	09/27/19
SCALE:	AS NOTED


CITY OF ATLANTA DEPT. OF WATERSHED MANAGEMENT
WATER SUPPLY PROGRAM
RIVER INTAKE PUMP STATION
VALVE VAULT SECTION

DRAWING NO.
RI-PS
DS1-012
SHEET OF


ISSUED FOR BIDDING

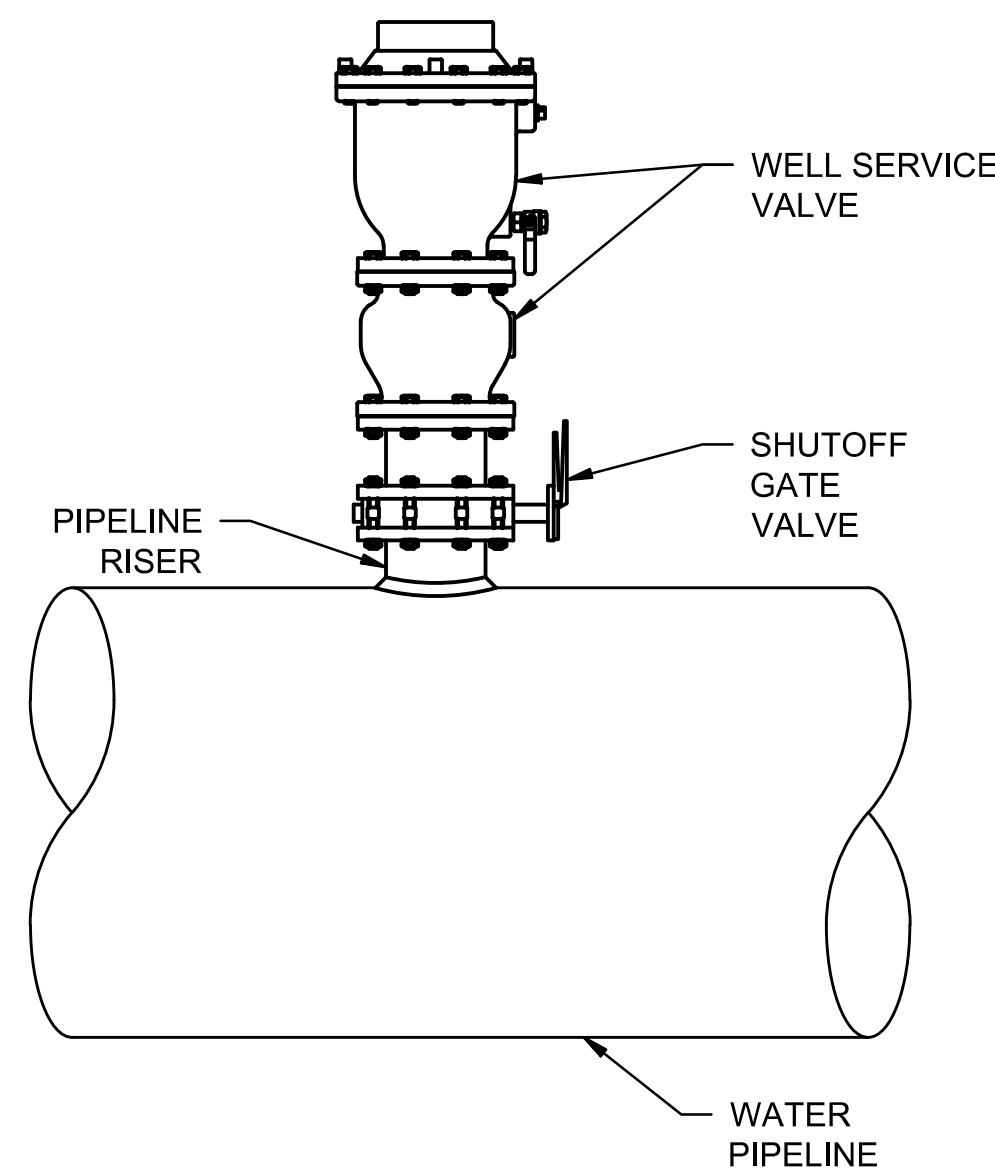


1 WELL SERVICE AIR VALVE
- NTS

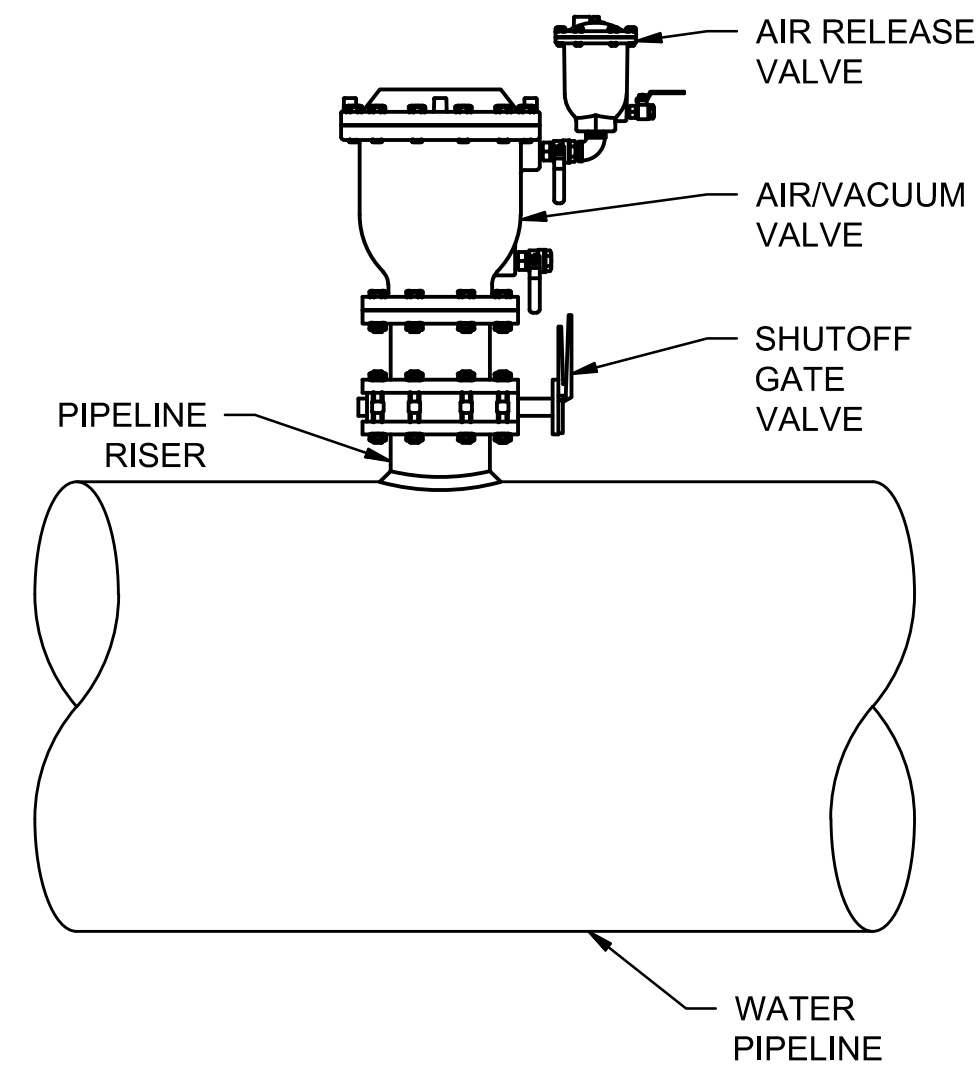

2 DUAL BODY COMBO. AIR VALVE
- NTS

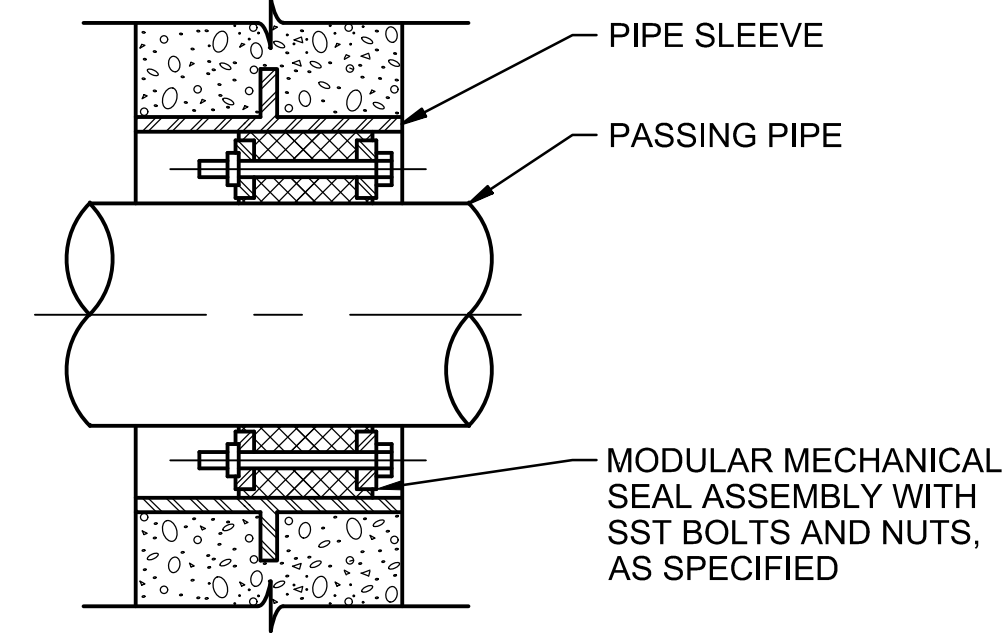


3 WALL PIPE PENETRATION SEAL
- NTS

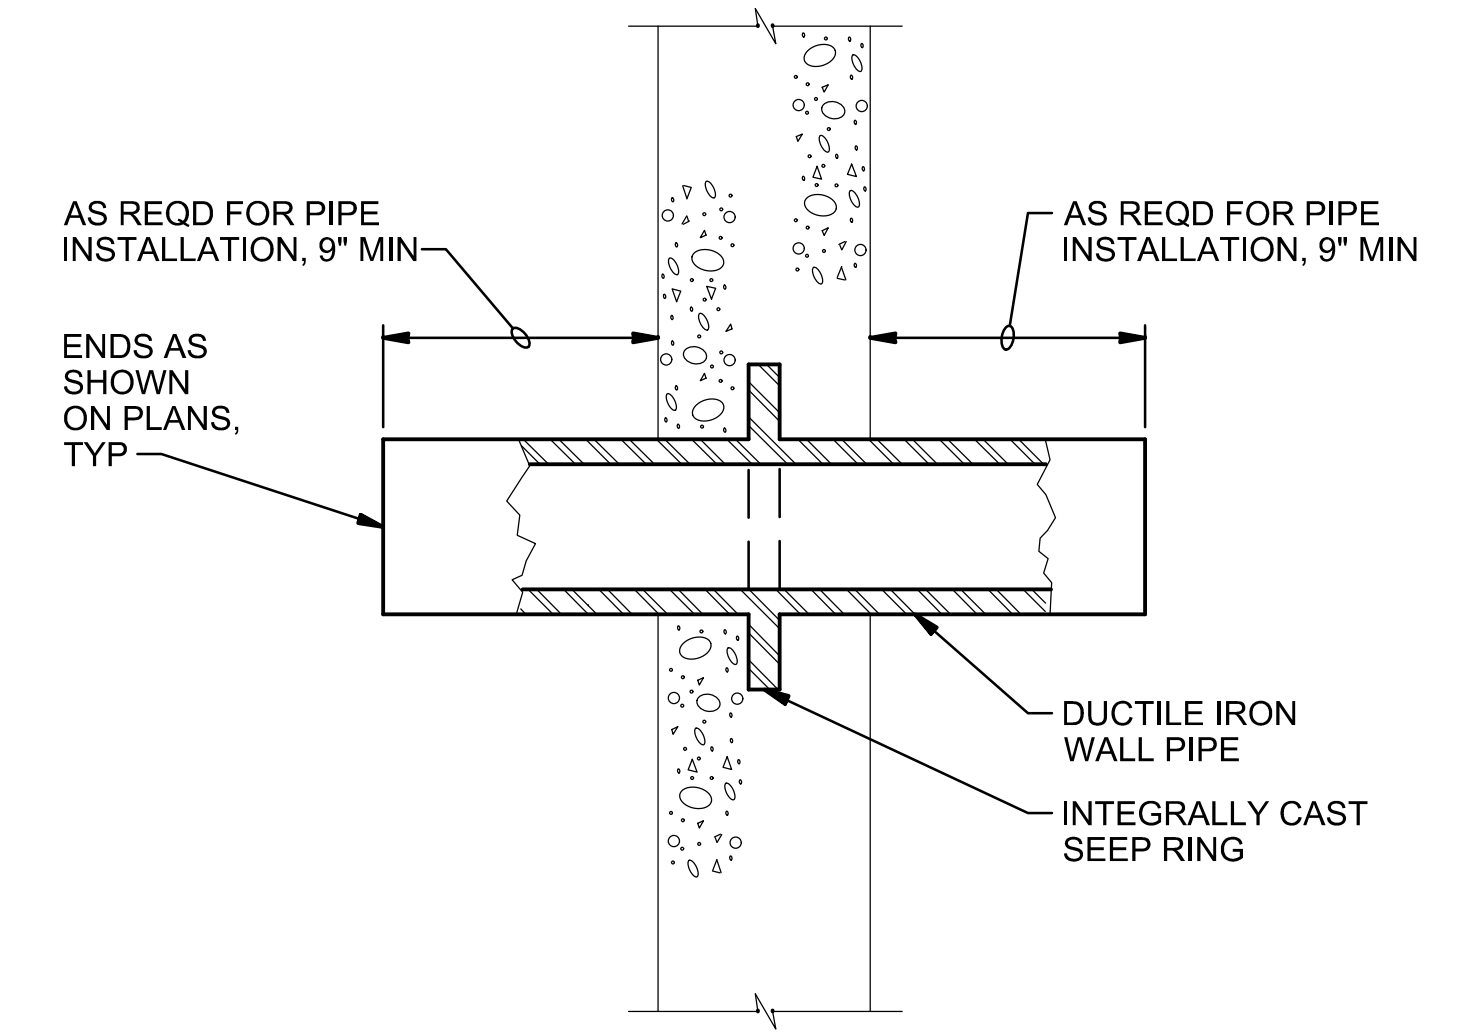


NOTES:
1. COAT WALL PIPE WITH SPECIFIED PAINT SYSTEM PRIOR TO CONCRETE PLACEMENT.

4 DUCTILE IRON WALL PIPE
- NTS

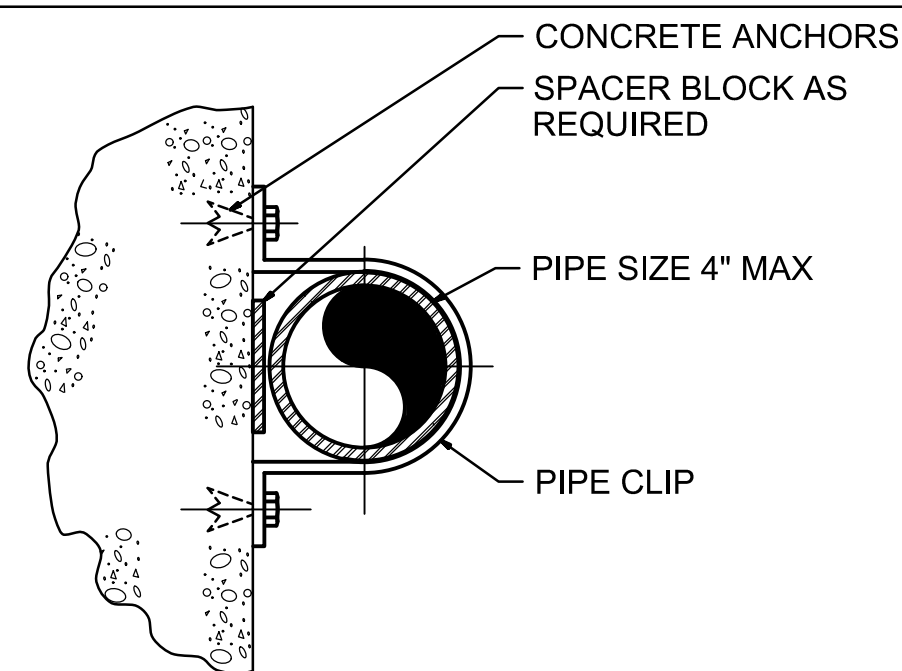


NOTES:
1. FOR VERTICAL PIPES ONLY.
2. PROVIDE PIPE PROTECTION BARRIER AS SPECIFIED. FABRICATE OVERSIZE STRAP WHERE REQUIRED.
3. STAINLESS STEEL WEDGE ANCHORS REQ'D OCCASIONALLY.
4. CATALOG STANDARD PRODUCTS ARE AVAILABLE IN LIMITED MATERIALS AND SIZES. SPECIAL MATERIALS AND SIZES REQUIRE FABRICATION TO CONFORM TO SPECIFICATION.
5. PIPE PROTECTION BARRIER MAY BE APPLIED FOR ELECTRICAL ISOLATION OF DISSIMILAR METALLIC PIPING FROM HANGER OR SUPPORT AND FOR PROTECTION OF PLASTIC PIPING FROM CLAMPING STRESSES.
6. PIPE SUPPORT PRODUCT CONFORMS TO SPECIFIED STANDARD MSS SP-58, PIPE HANGERS AND SUPPORTS - MATERIALS, DESIGN AND MANUFACTURE.

5 TYPICAL WALL MOUNT PIPE SUPPORT
- NTS

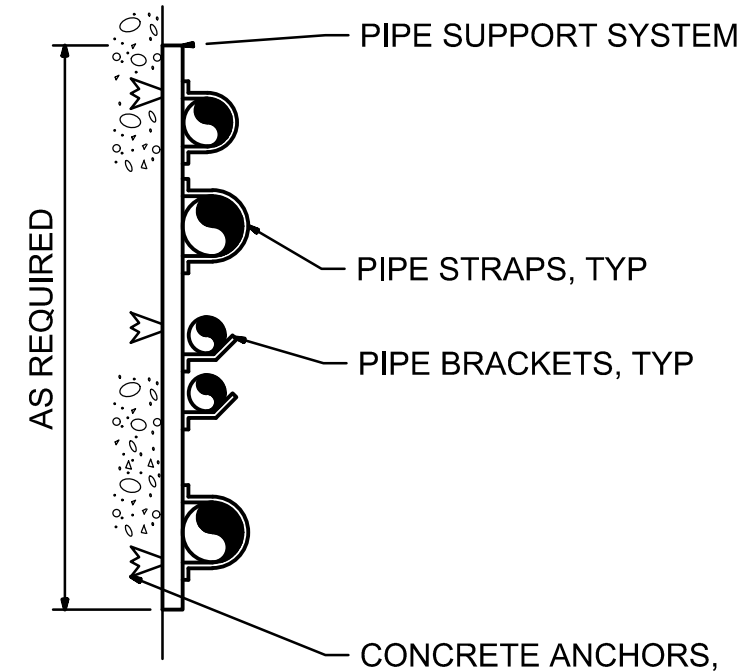

NOTES:
1. PROVIDE PIPE PROTECTION BARRIER AS SPECIFIED.
2. STAINLESS STEEL EXPANSION ANCHORS SOMETIMES REQUIRED. FILL IN ANCHOR SPACING.
3. CATALOG STANDARD PRODUCTS ARE AVAILABLE IN LIMITED MATERIALS AND SIZES. SPECIAL MATERIALS AND SIZES REQUIRE FABRICATION TO CONFORM TO SPECIFICATION.
4. PIPE PROTECTION BARRIER MAY BE APPLIED FOR ELECTRICAL ISOLATION OF DISSIMILAR METALLIC PIPING FROM HANGER OR SUPPORT AND FOR PROTECTION OF PLASTIC PIPING FROM CLAMPING STRESSES.


6 TYPICAL STACKED PIPE WALL SYSTEM
- NTS

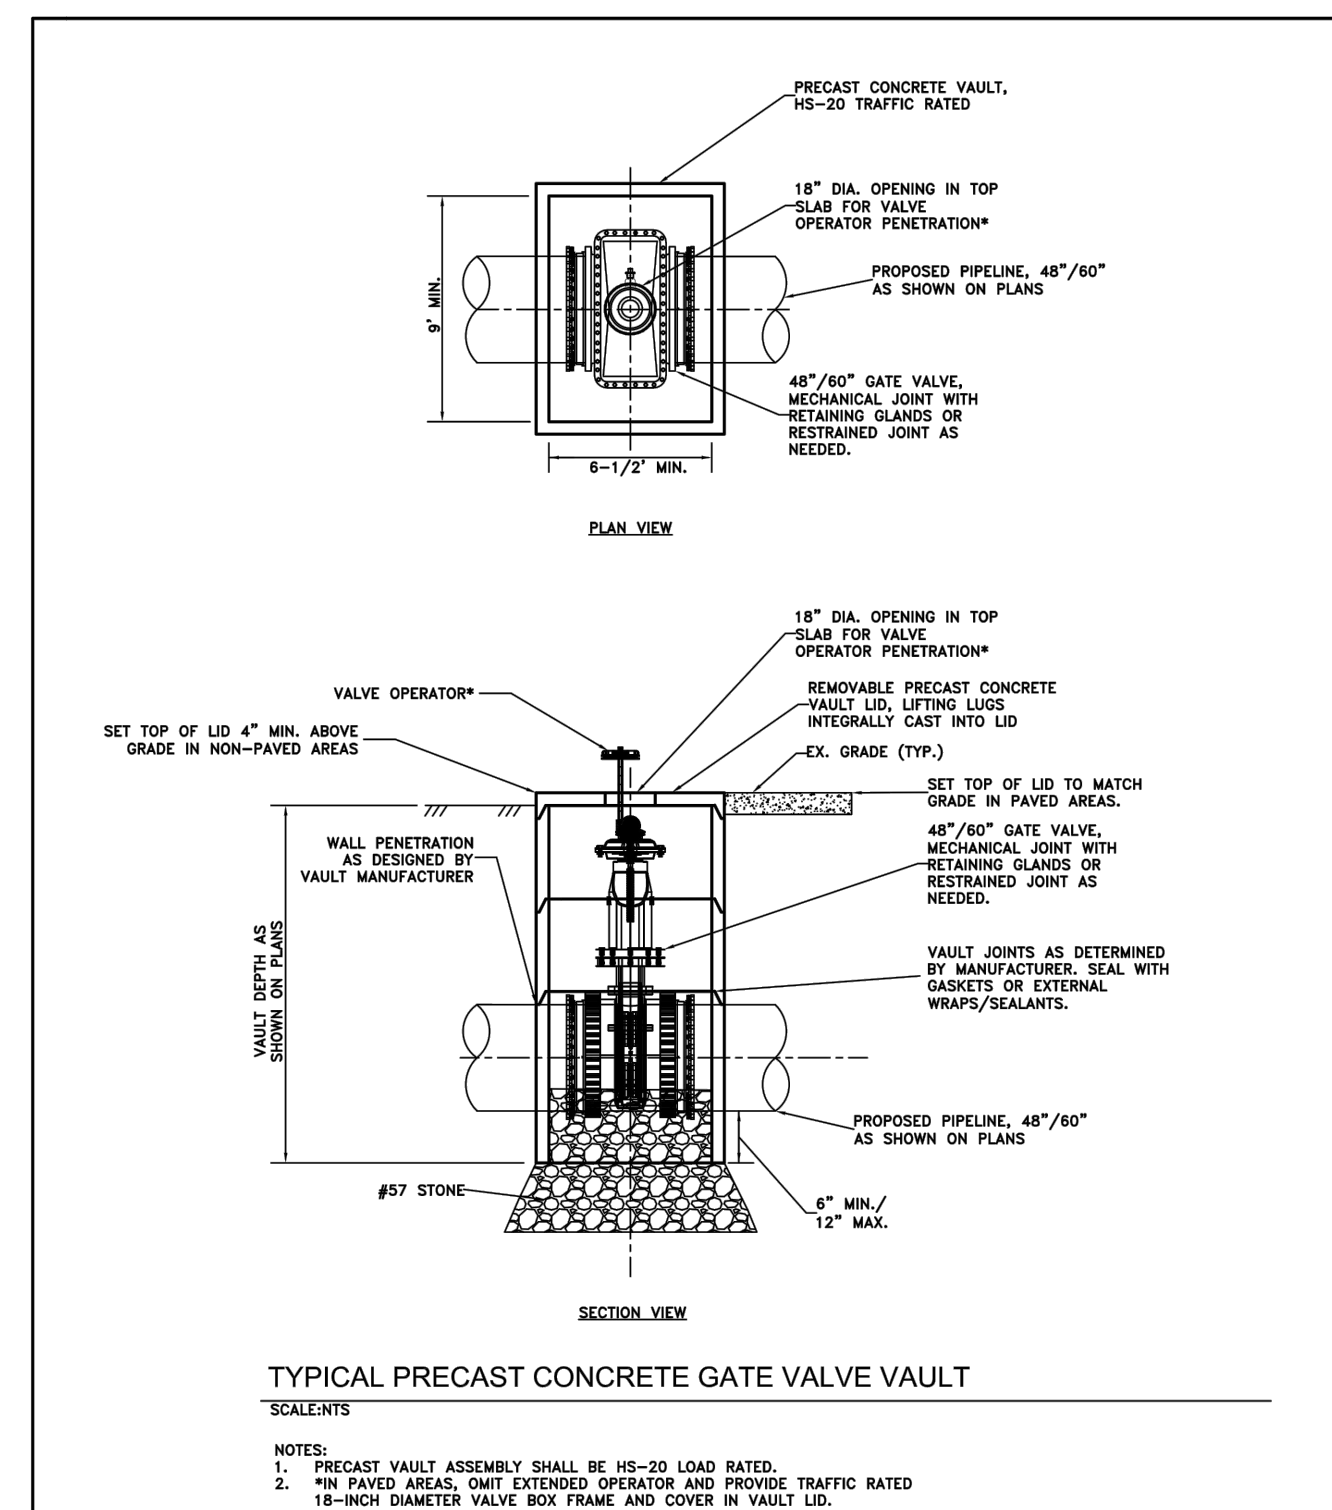

CITY OF ATANTA DEPARTMENT OF WATERSHED MANAGEMENT
MARCH 22, 2019

WATER SUPPLY PROGRAM RIVER INTAKE PUMP STATION FC-1190004 ATTACHMENT TO ADDENDUM NO. 2

PREPARED BY: R2T, INC.

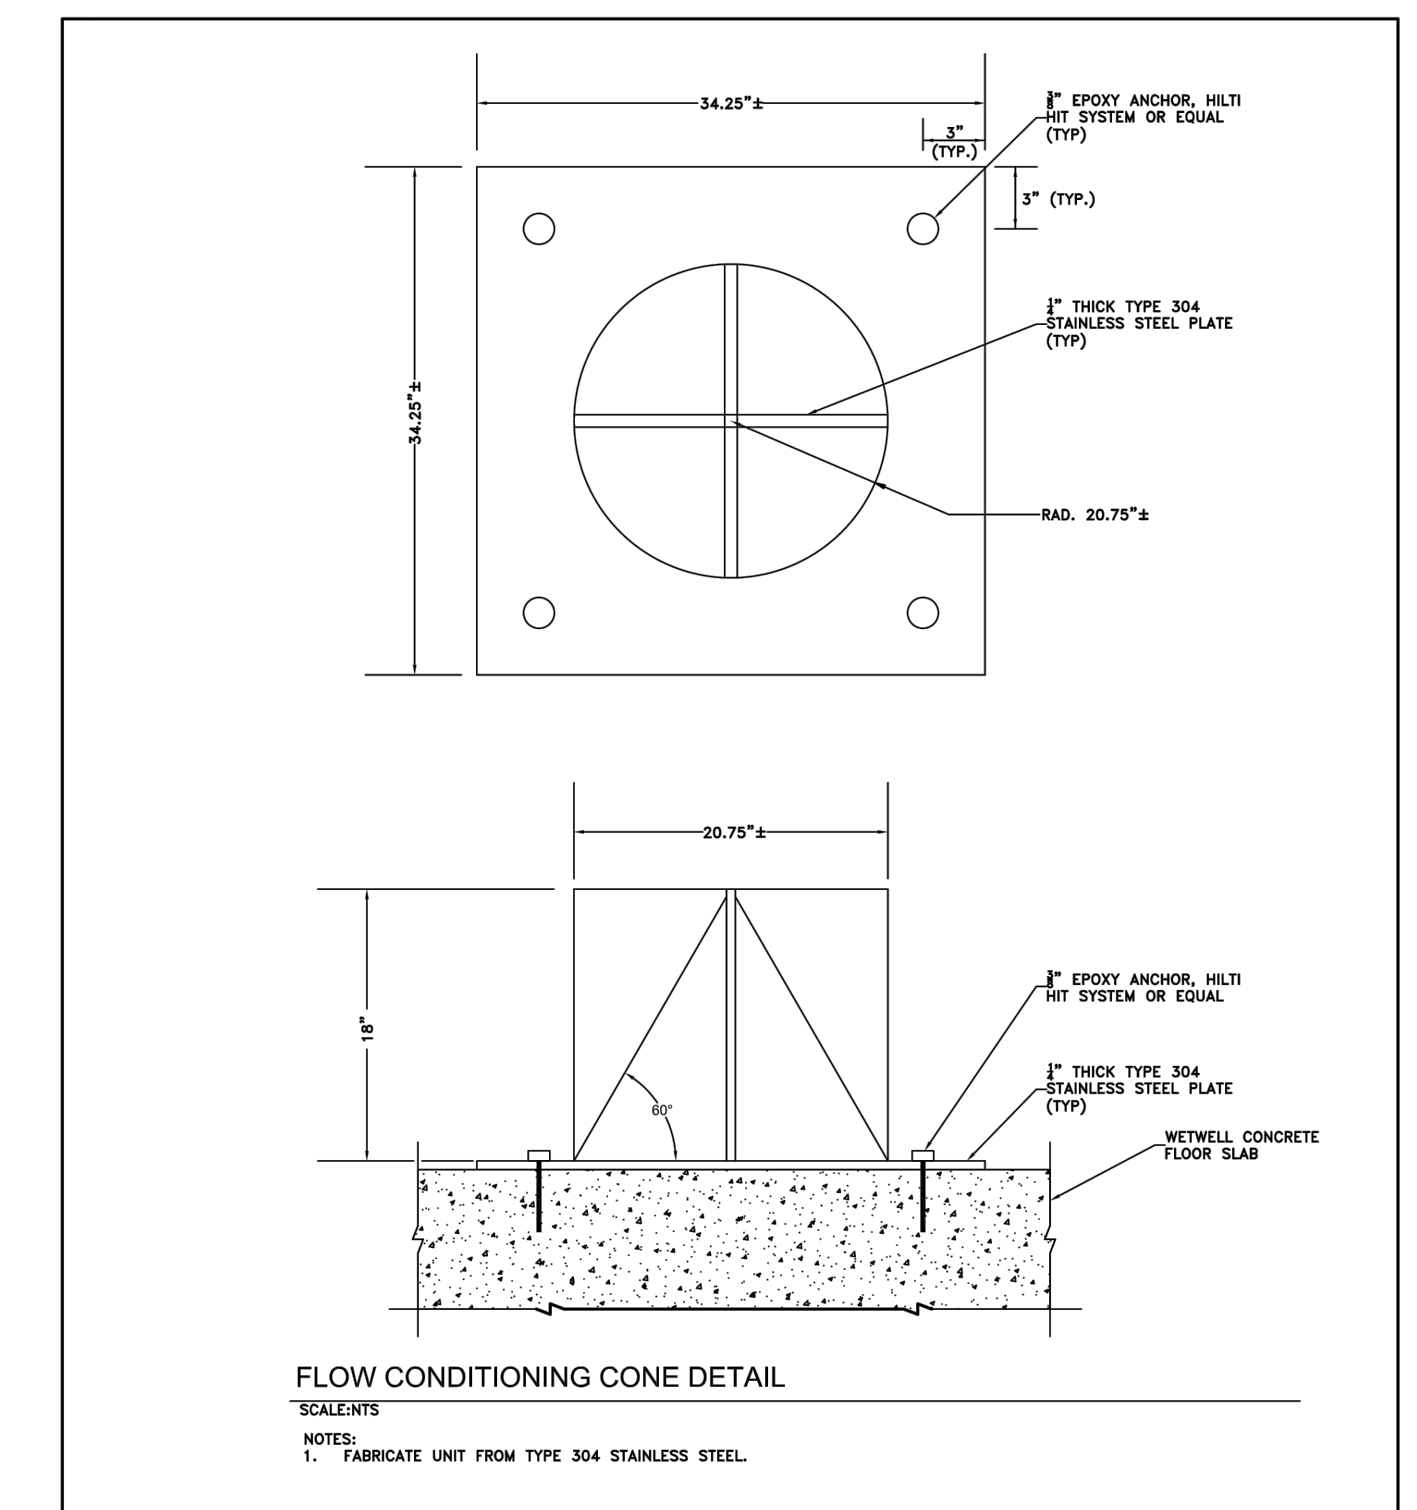

CITY OF ATANTA DEPARTMENT OF WATERSHED MANAGEMENT
MARCH 22, 2019


WATER SUPPLY PROGRAM RIVER INTAKE PUMP STATION FC-1190004 ATTACHMENT TO ADDENDUM NO. 2

PREPARED BY: R2T, INC.

P:\City of Atlanta - Water Supply Program Phase 1\CD Drawings\PROCESS\RI-PS DS2-001.dwg, PRINTED BY: hody.barnes ON Thu, Dec 05, 2019 AT 9:44 AM



No.	Description	Date

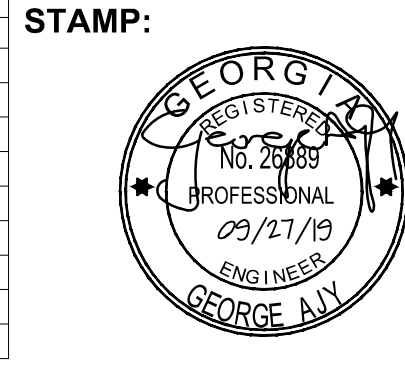


ADDRESS:
BGR2-JV
6 CONCOURSE PARKWAY
SUITE 1600
ATLANTA, GA 30328
(770) 569-7038 x101
FAX: (770) 993-5082

PROJECT NO:	TASK_13
DESIGNED BY:	A.T.
DRAWN BY:	H.B.
CHECKED BY:	G.A.
DATE:	09/27/19
SCALE:	AS NOTED


CITY OF ATLANTA DEPT. OF WATERSHED MANAGEMENT
WATER SUPPLY PROGRAM
RIVER INTAKE PUMP STATION
PROCESS
DETAILS

DRAWING NO.
RI-PS
DS2-001
SHEET OF


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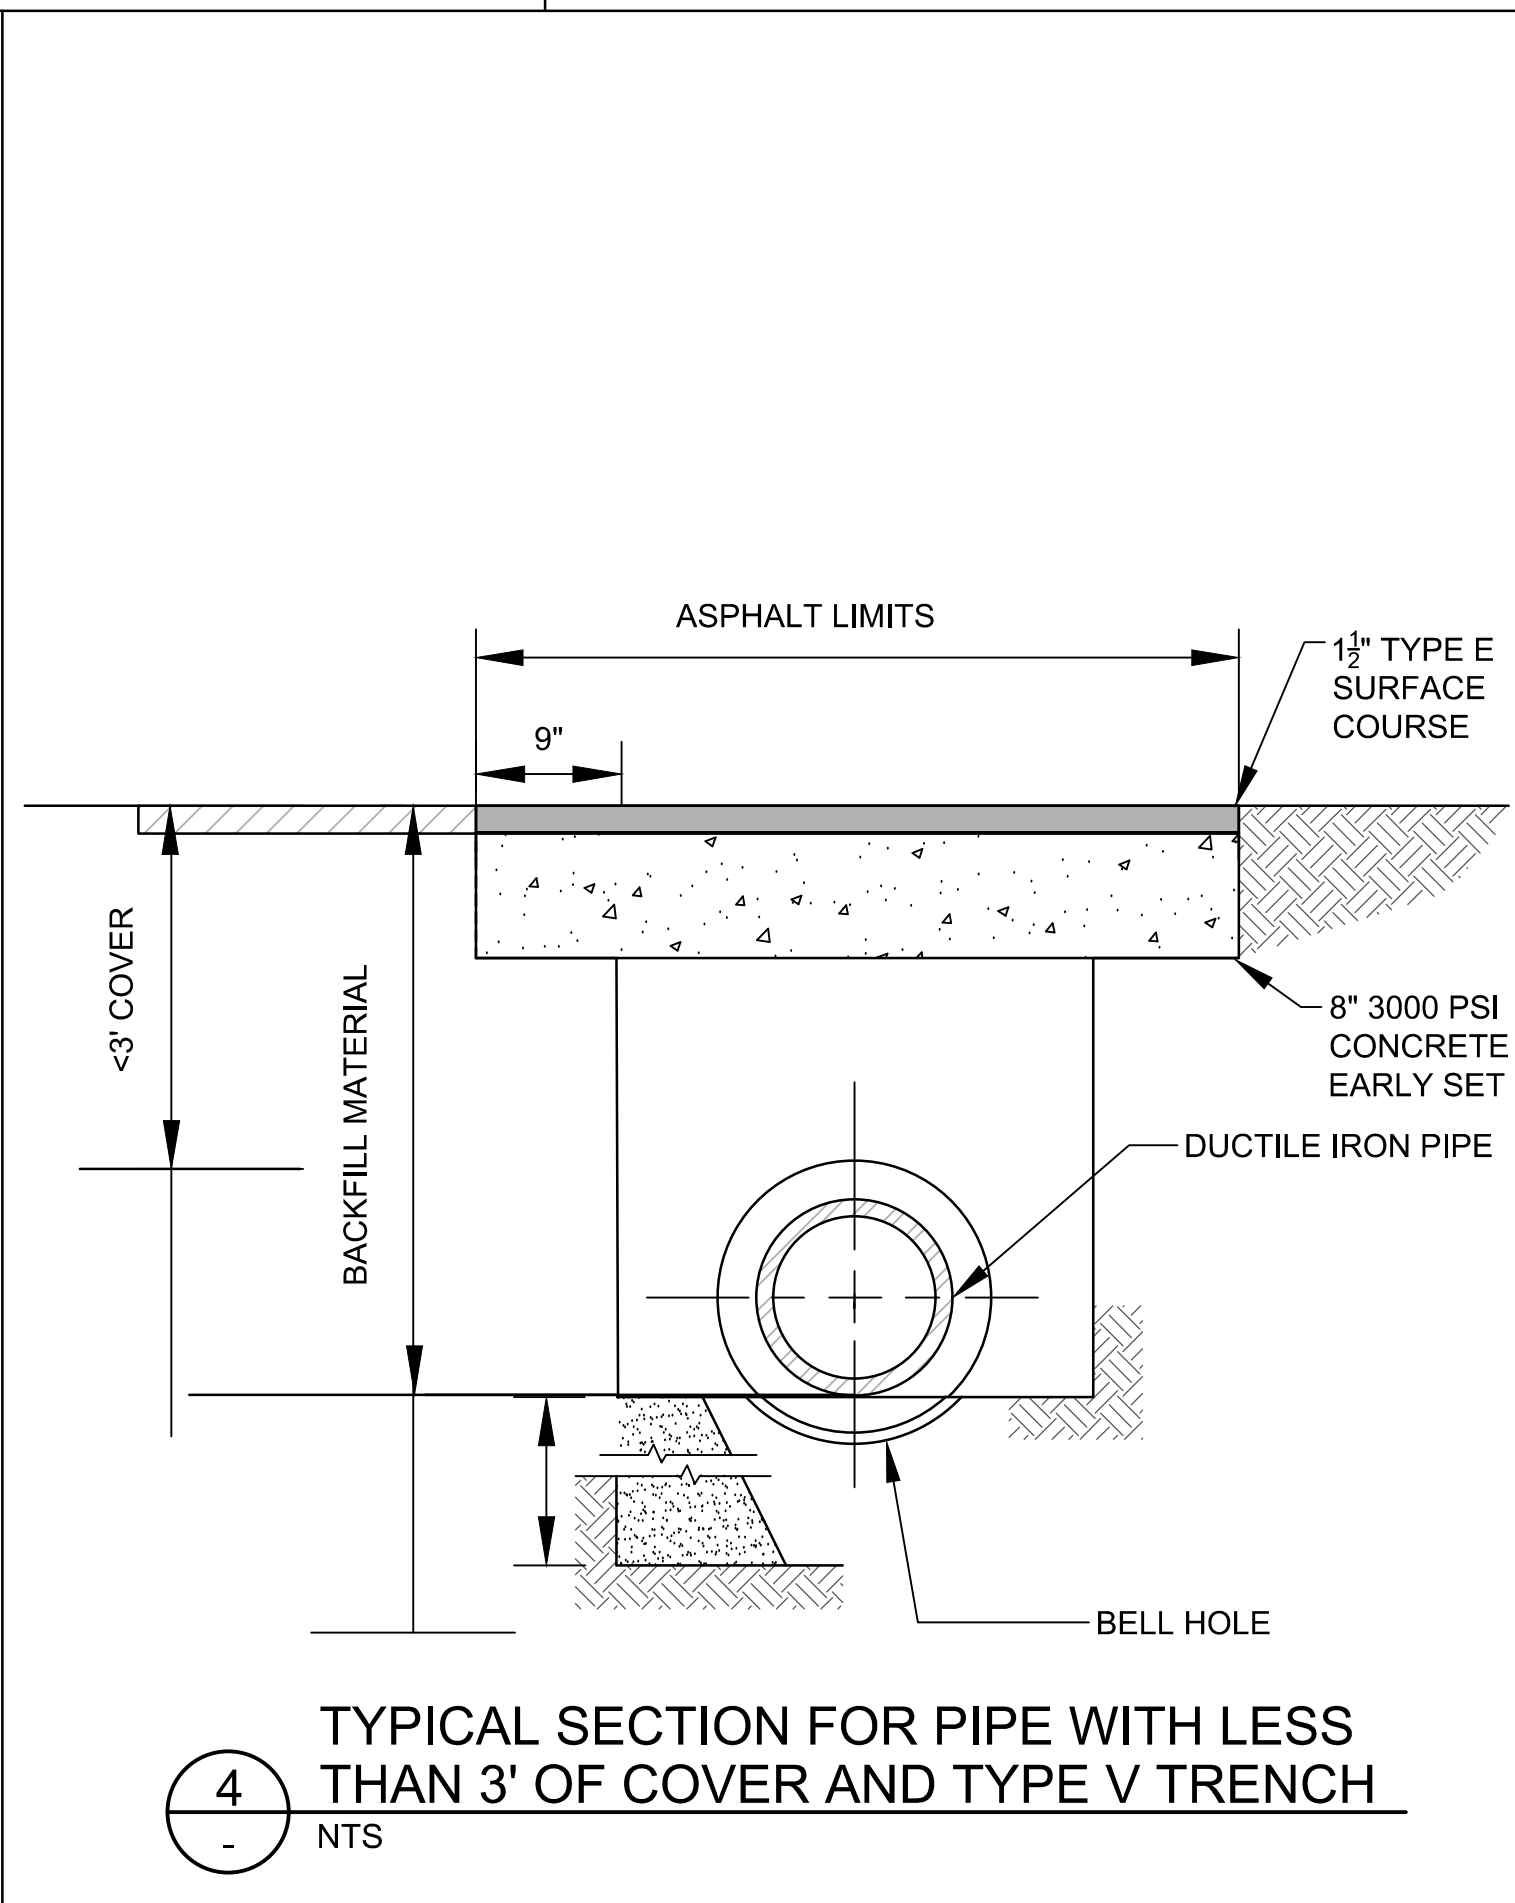
1 SEAL WATER CONNECTION
NTS

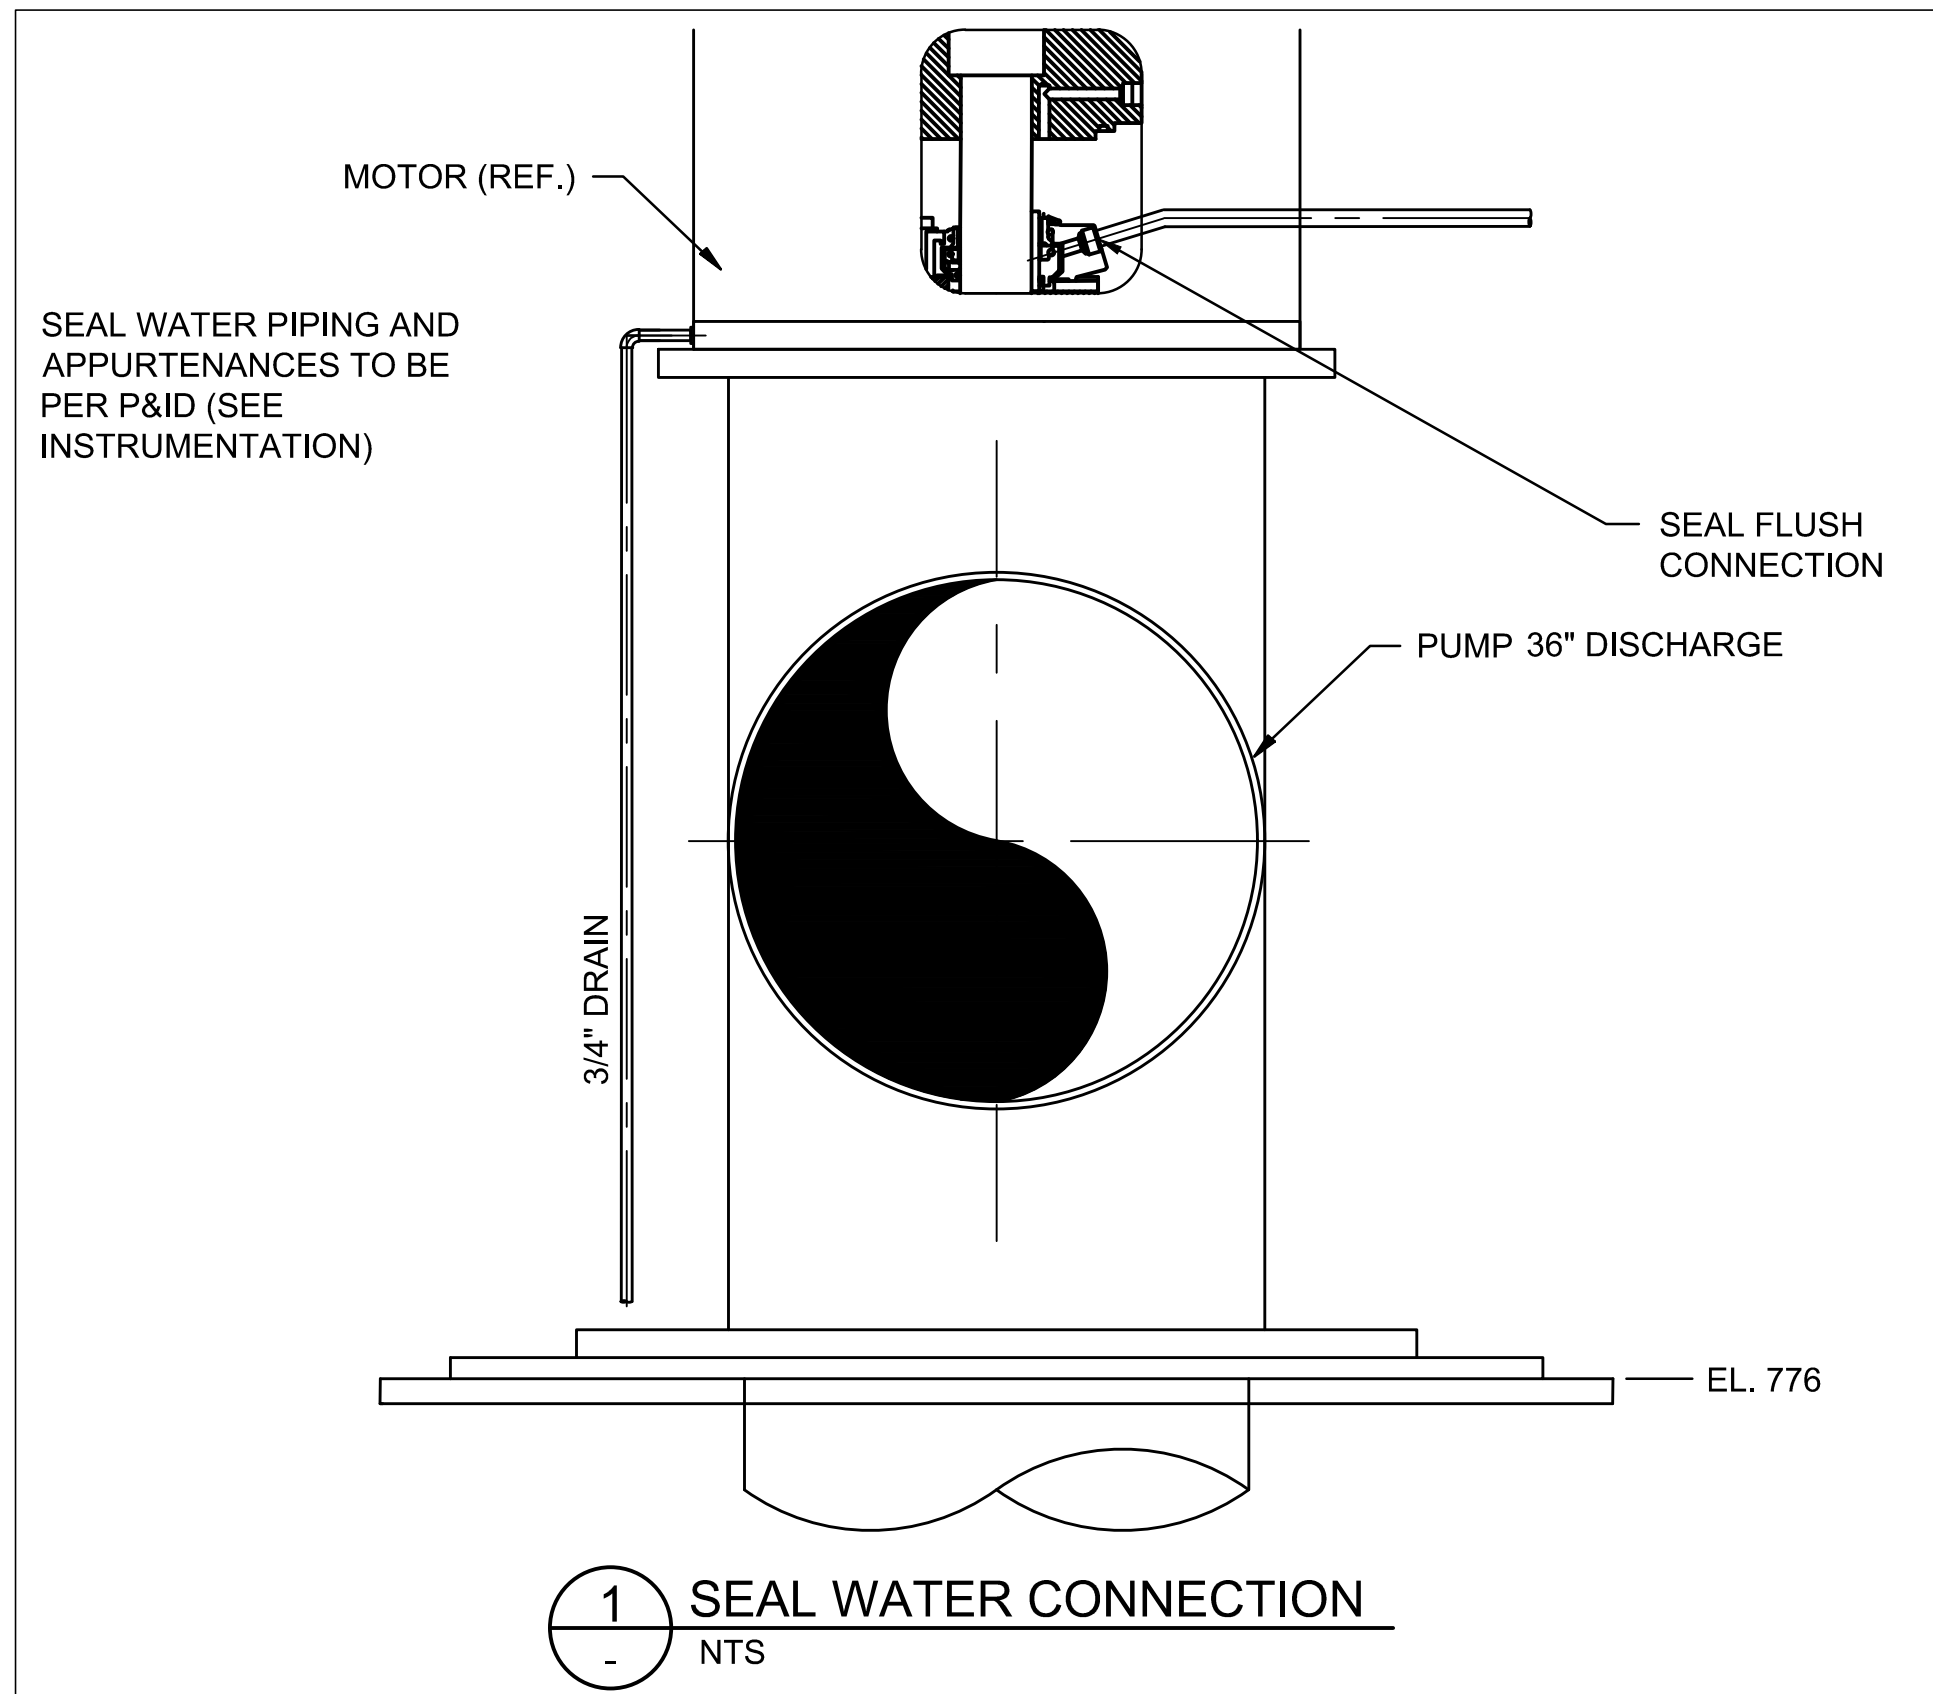


2 PIPE SUPPORT AND HOLD DOWN STRAP
NTS

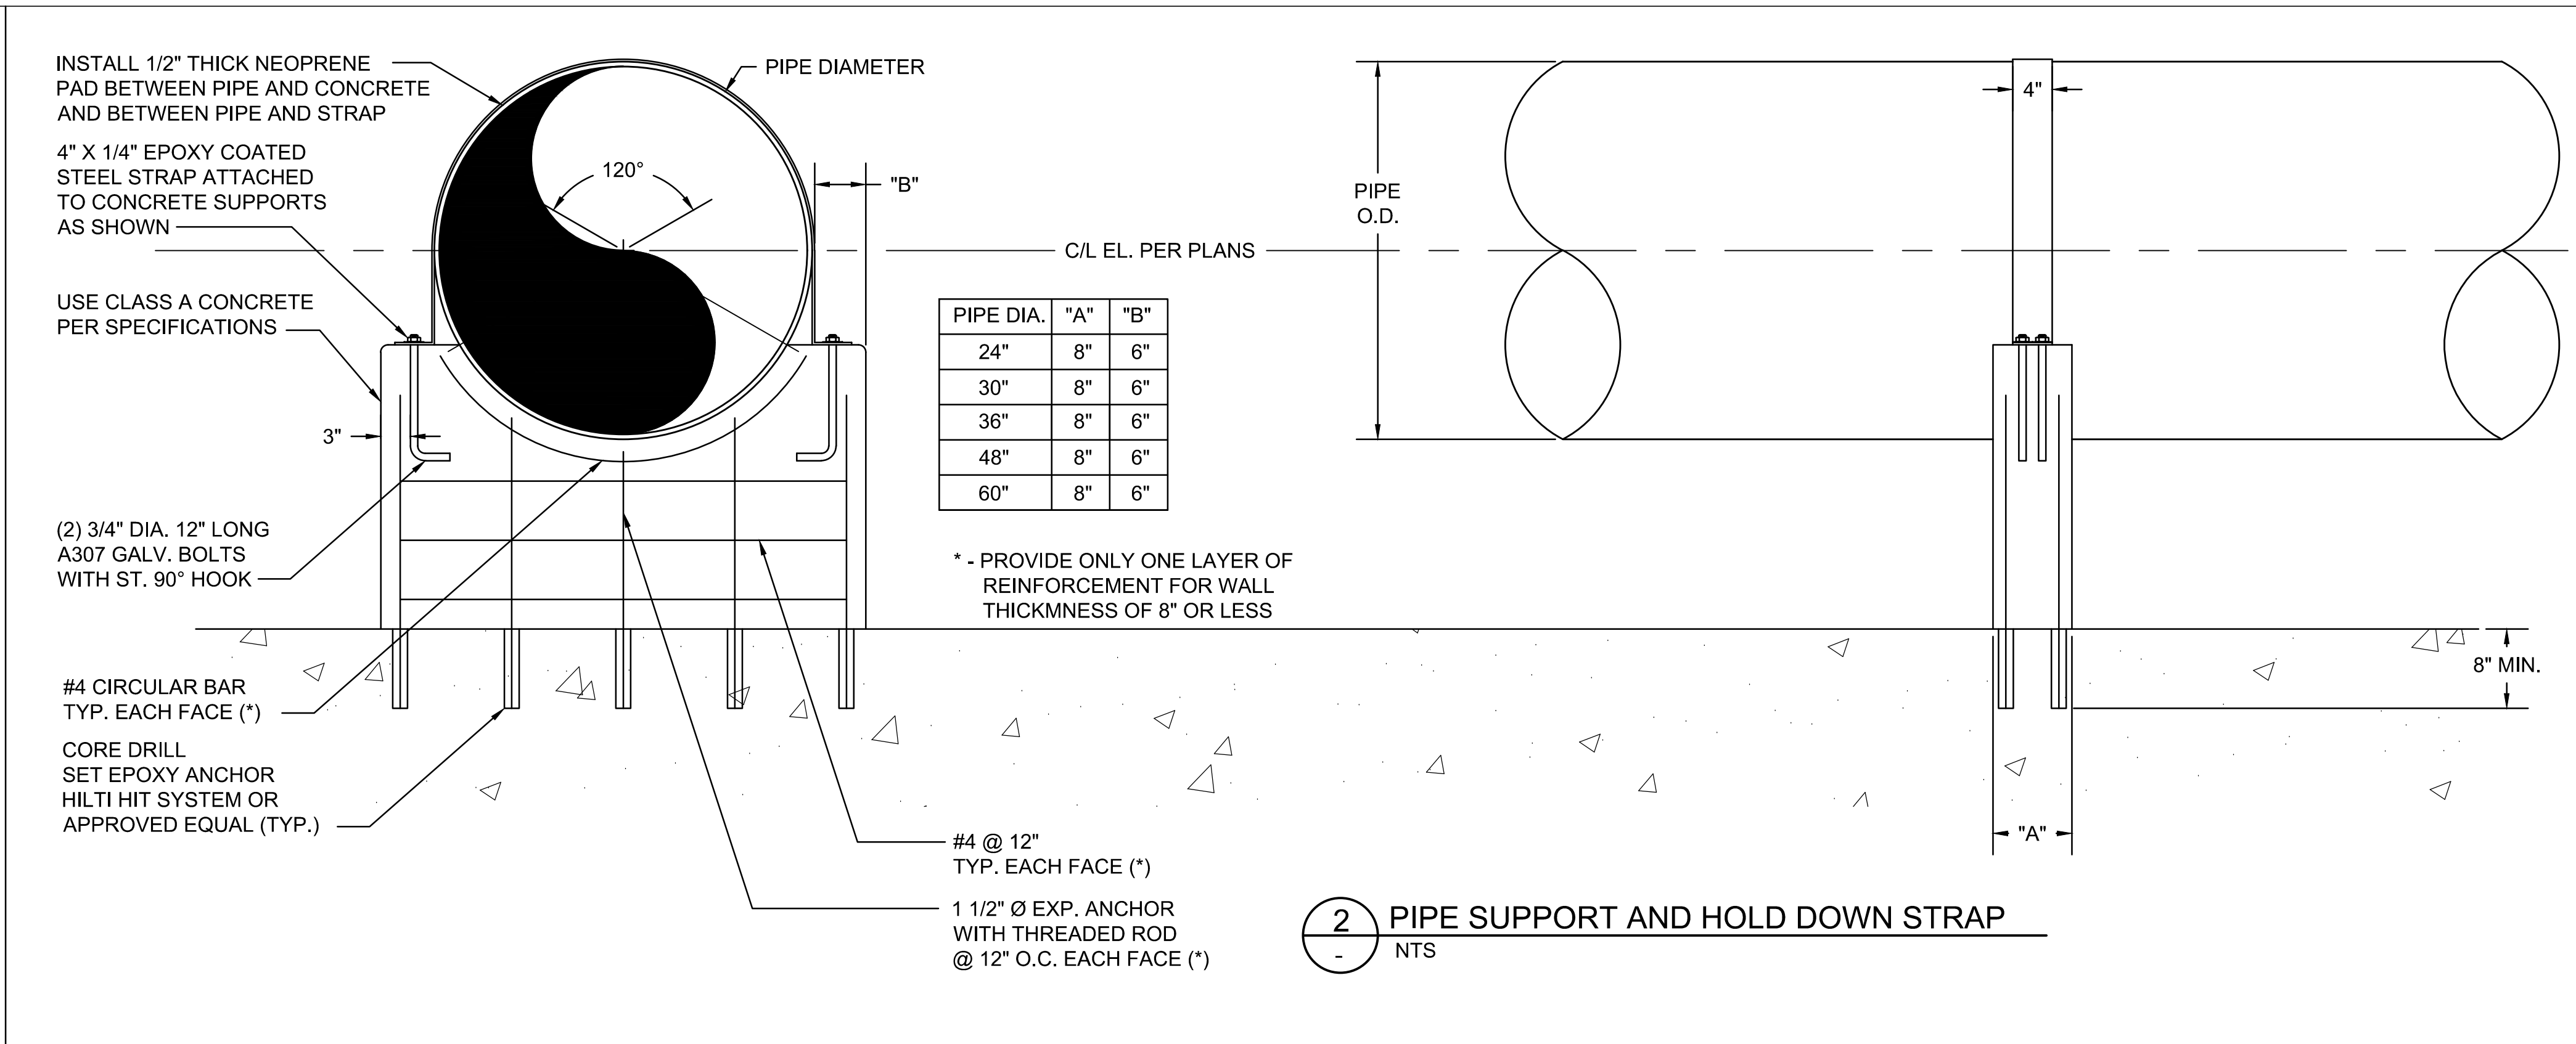


3 AIR RELEASE VAULT
NTS

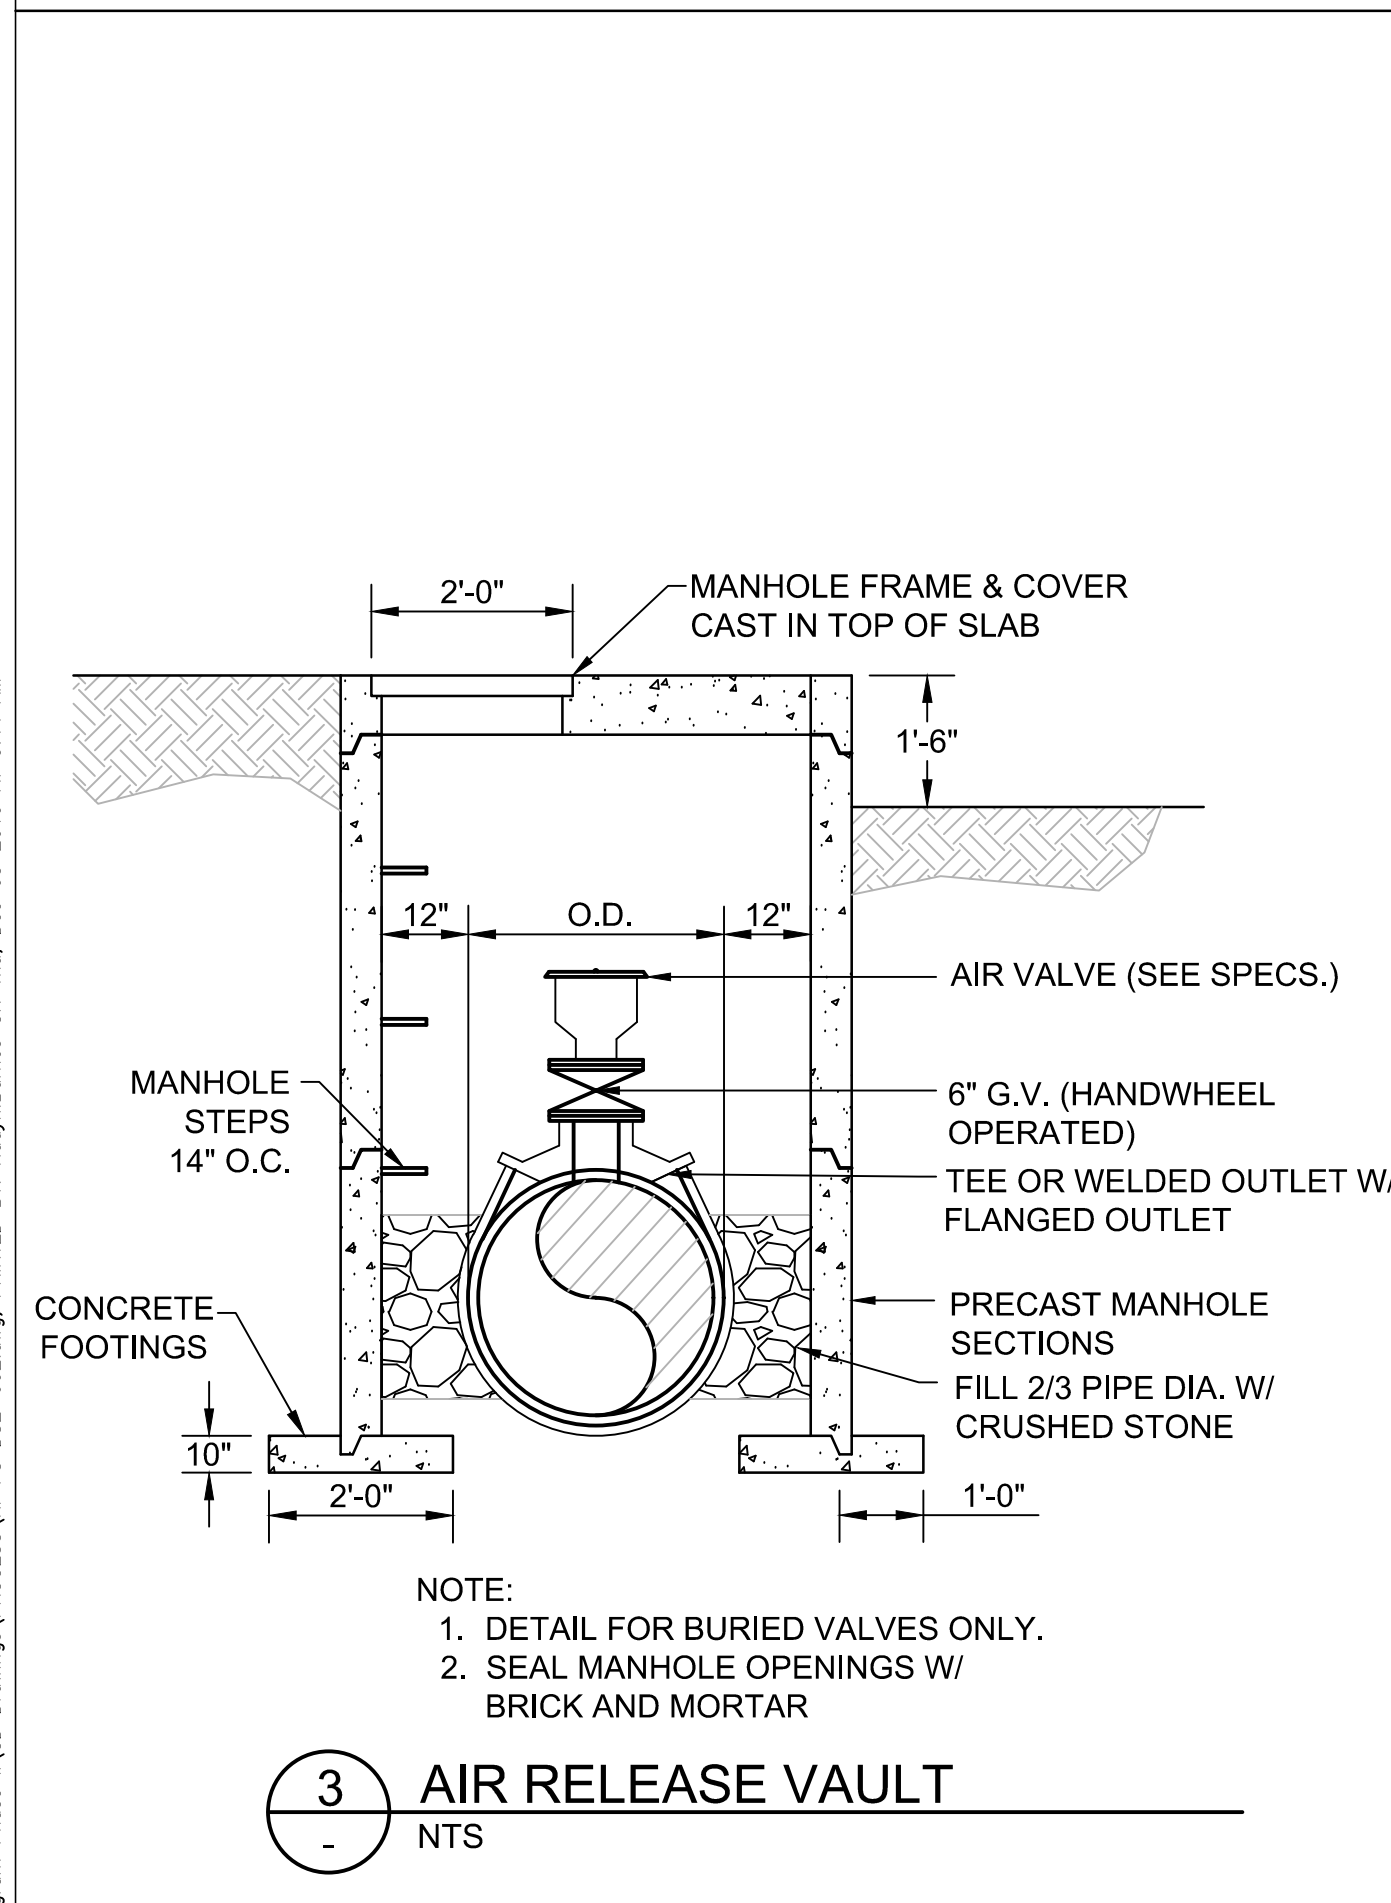

4 TYPICAL SECTION FOR PIPE WITH LESS THAN 3' OF COVER AND TYPE V TRENCH
NTS

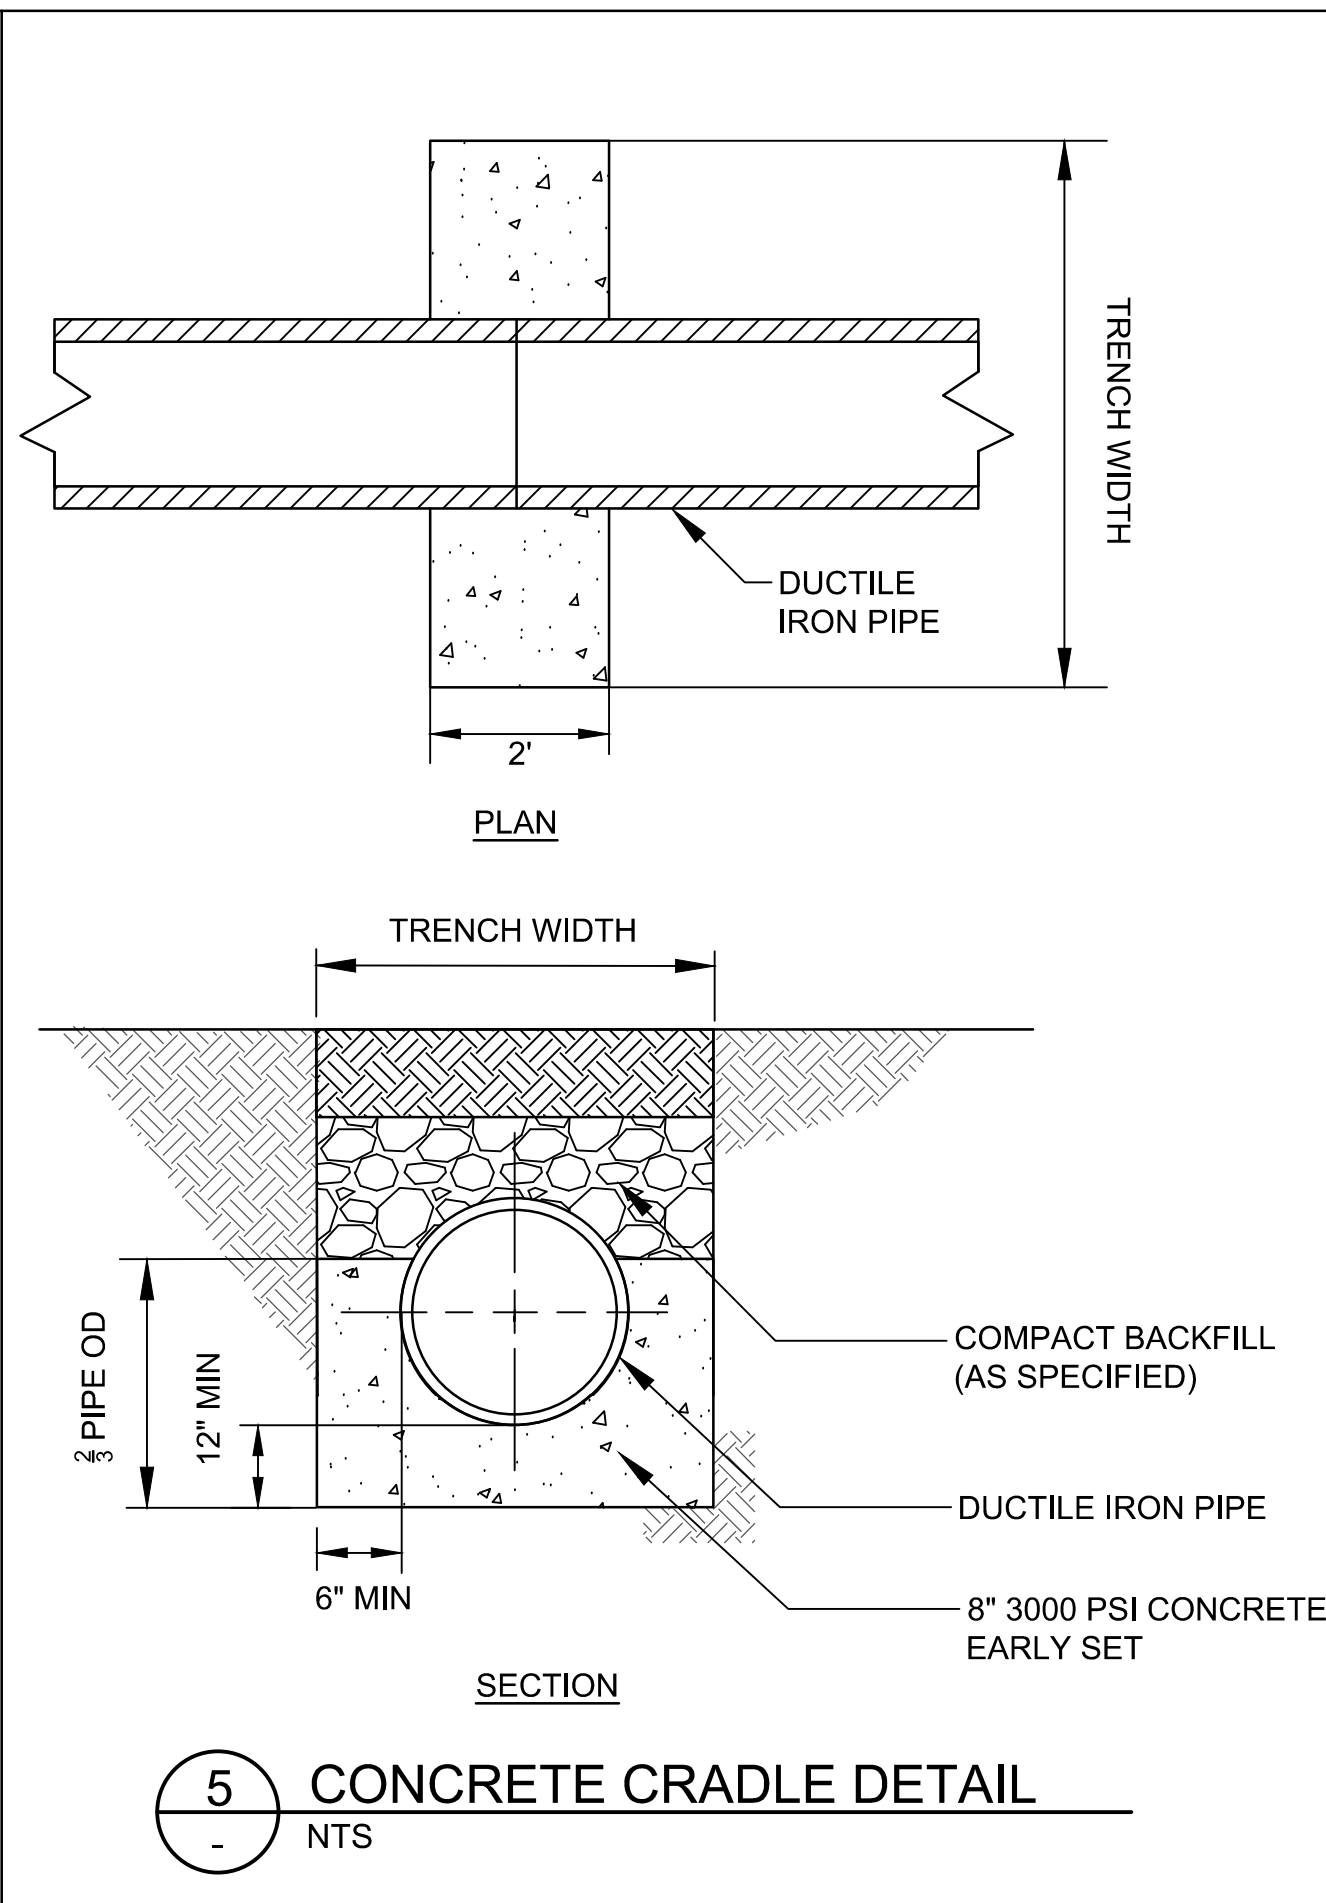

5 CONCRETE CRADLE DETAIL
NTS

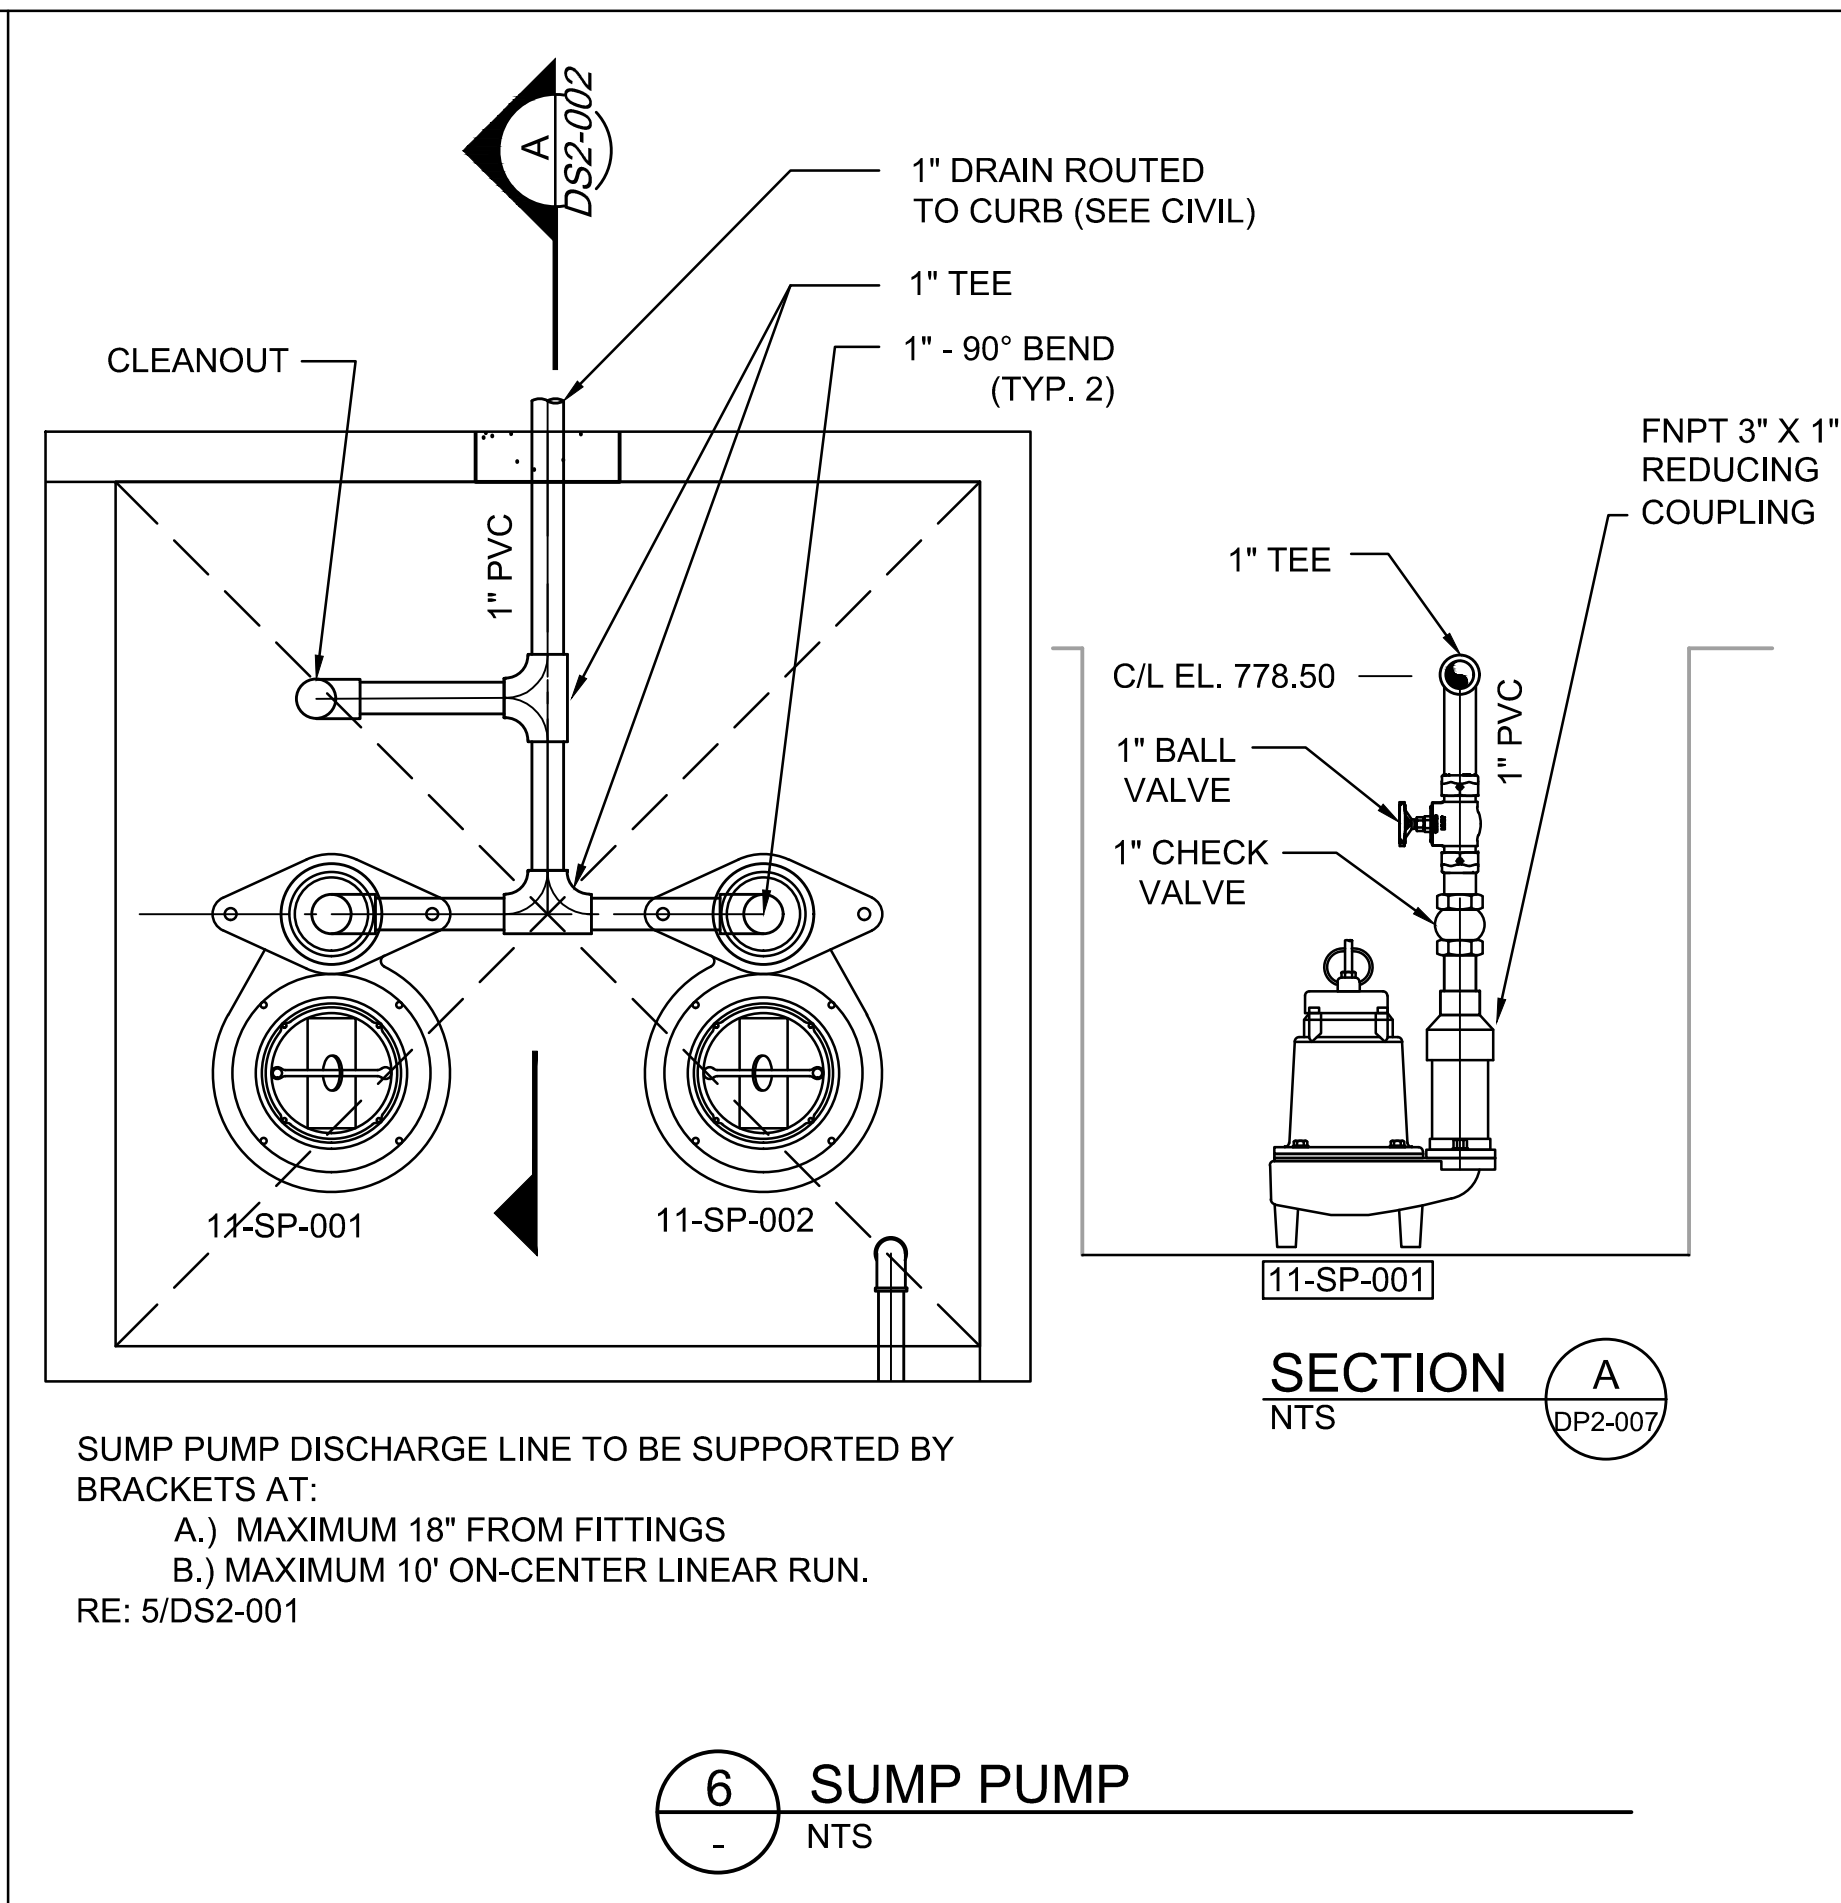


6 SUMP PUMP
NTS

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No.	Description	Date




ADDRESS:
BGR2-JV
6 CONCOURSE PARKWAY
SUITE 1600
ATLANTA, GA 30328
(770) 569-7038 x101
FAX: (770) 993-5082

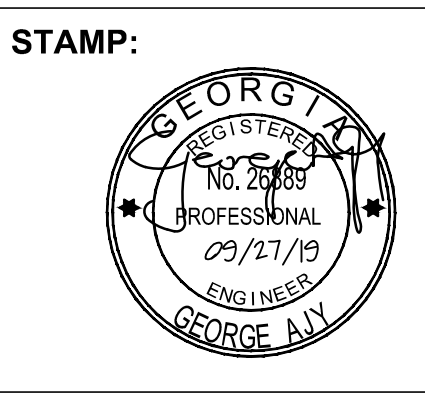PROJECT NO:	TASK_13
DESIGNED BY:	A.T.
DRAWN BY:	H.B.
CHECKED BY:	G.A.
DATE:	09/27/19
SCALE:	AS NOTED

**CITY OF ATLANTA DEPT. OF WATERSHED MANAGEMENT
WATER SUPPLY PROGRAM**
RIVER INTAKE PUMP STATION
PROCESS
DETAILS

DRAWING NO.
RI-PS
DS2-002
SHEET OF

ISSUED FOR BIDDING

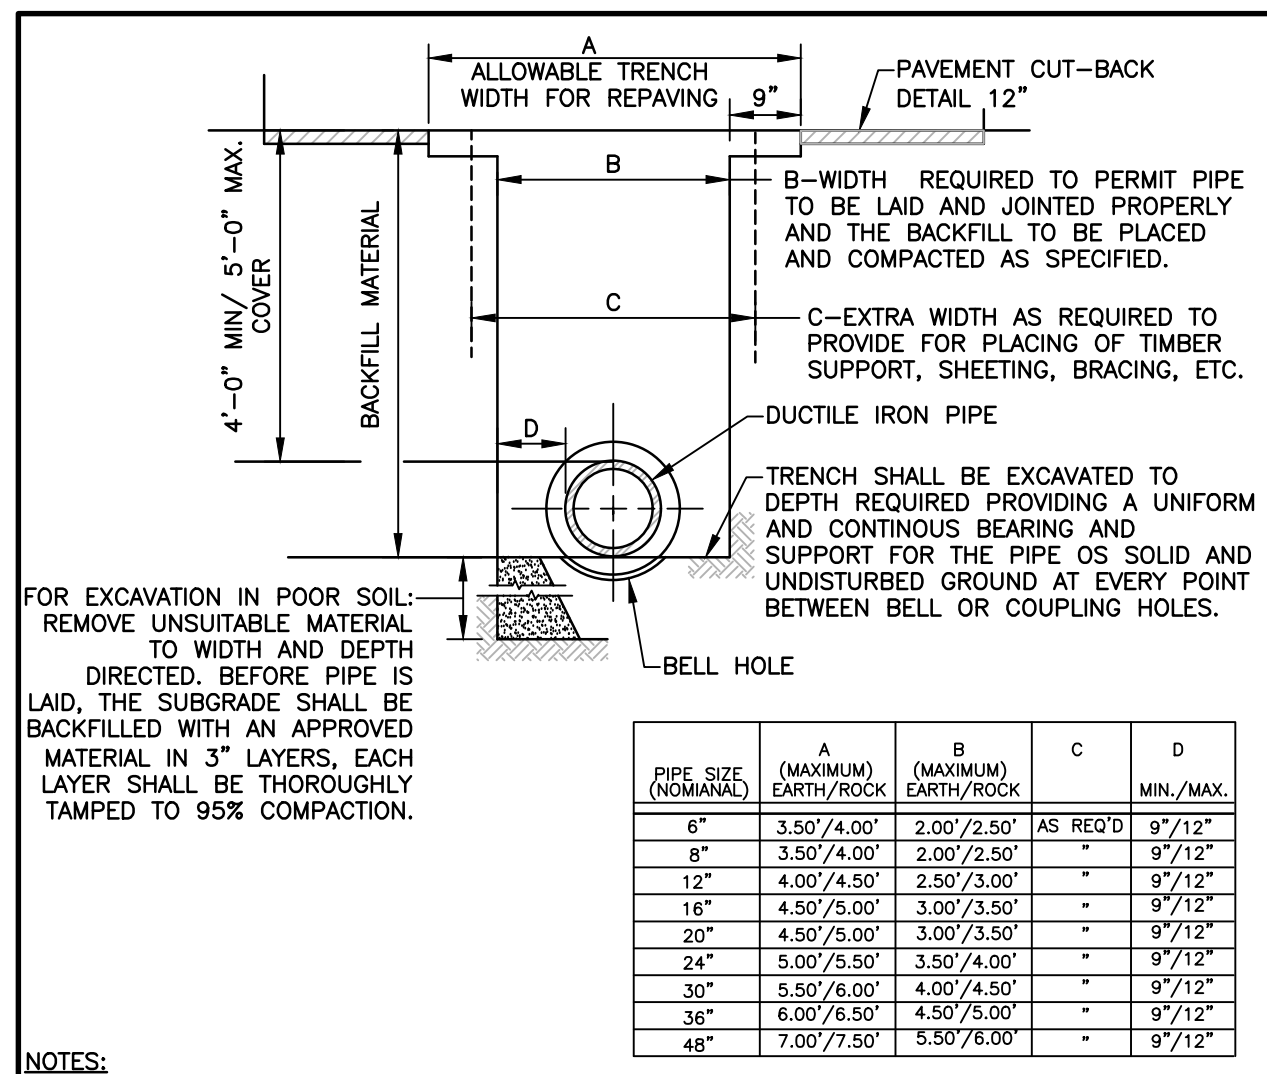



PIPE SIZE (NOMINAL)	A (MAXIMUM) EARTH/ROCK	B (MAXIMUM) EARTH/ROCK	C	D
6"	3.50'/4.00'	2.00'/2.50'	AS REQ'D	9"/12"
8"	3.50'/4.00'	2.00'/2.50'	-	9"/12"
12"	4.00'/4.50'	2.50'/3.00'	-	9"/12"
18"	4.50'/5.00'	3.00'/3.50'	-	9"/12"
20"	4.50'/5.00'	3.00'/3.50'	-	9"/12"
24"	5.00'/5.50'	3.50'/4.00'	-	9"/12"
30"	5.50'/6.00'	4.00'/4.50'	-	9"/12"
36"	6.00'/6.50'	4.50'/5.00'	-	9"/12"
48"	7.00'/7.50'	5.50'/6.00'	-	9"/12"

NOTES:

1. COMPACTION: BACKFILLS SHALL BE BUILT UP IN LAYERS AND EACH LAYER SHALL BE THOROUGHLY COMPACTED BEFORE BEGINNING ANOTHER LAYER. LAYERS SHALL BE NO MORE THAN 12-INCHES IN DEPTH, PUDDLING WILL NOT BE PERMITTED, NOR WILL FROZEN OR WET MATERIAL BE PLACED IN TRENCHES.
2. COMPACTION STANDARDS: ALL BACKFILL MATERIALS USED SHALL CONTAIN A SUFFICIENT AMOUNT OF MOISTURE FOR PROPER COMPACTION, AND THESE MATERIALS SHALL BE COMPACTED AT NOT LESS THAN 98% OF THEIR OPTIMUM COMPACTION FOR ANY SPECIFIC SOIL CLASSIFICATION, AS DETERMINED BY THE STANDARD PROCTOR TEST, ASTM D698.
3. COMPACTION TEST: COMPACTION TEST WILL BE REQUIRED IN EXISTING OR PROPOSED STREETS, SIDEWALKS, DRIVES AND OTHER EXISTING OR PROPOSED PAVED AREAS AT VARYING DEPTHS AND AT INTERVALS AS DETERMINED BY THE ENGINEER WITH A MINIMUM OF ONE TEST ON EACH JOB, AND A MAXIMUM OF ONE REQUIRED TEST FOR 400 FEET OF LESS OF WATER MAIN CONSTRUCTION, UNLESS SOIL CONDITIONS OR CONSTRUCTION PRACTICES, IN THE OPINION OF THE ENGINEER, WARRANT THE NEED FOR ADDITIONAL TESTS.


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City of Atlanta
STANDARD DETAILS
 TYPICAL WATERLINE TRENCH SECTION
 REV. DATE: OCT. 2011
 ORIG. DATE: OCT. 2004
 SCALE: N.T.S.
 DETAIL NO. WR-G_TR001

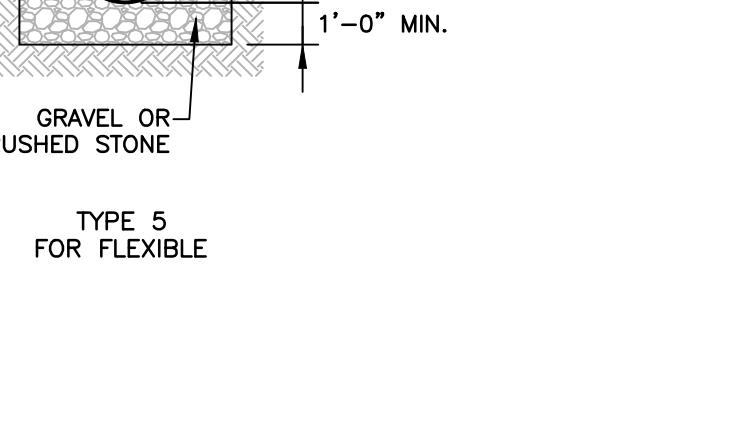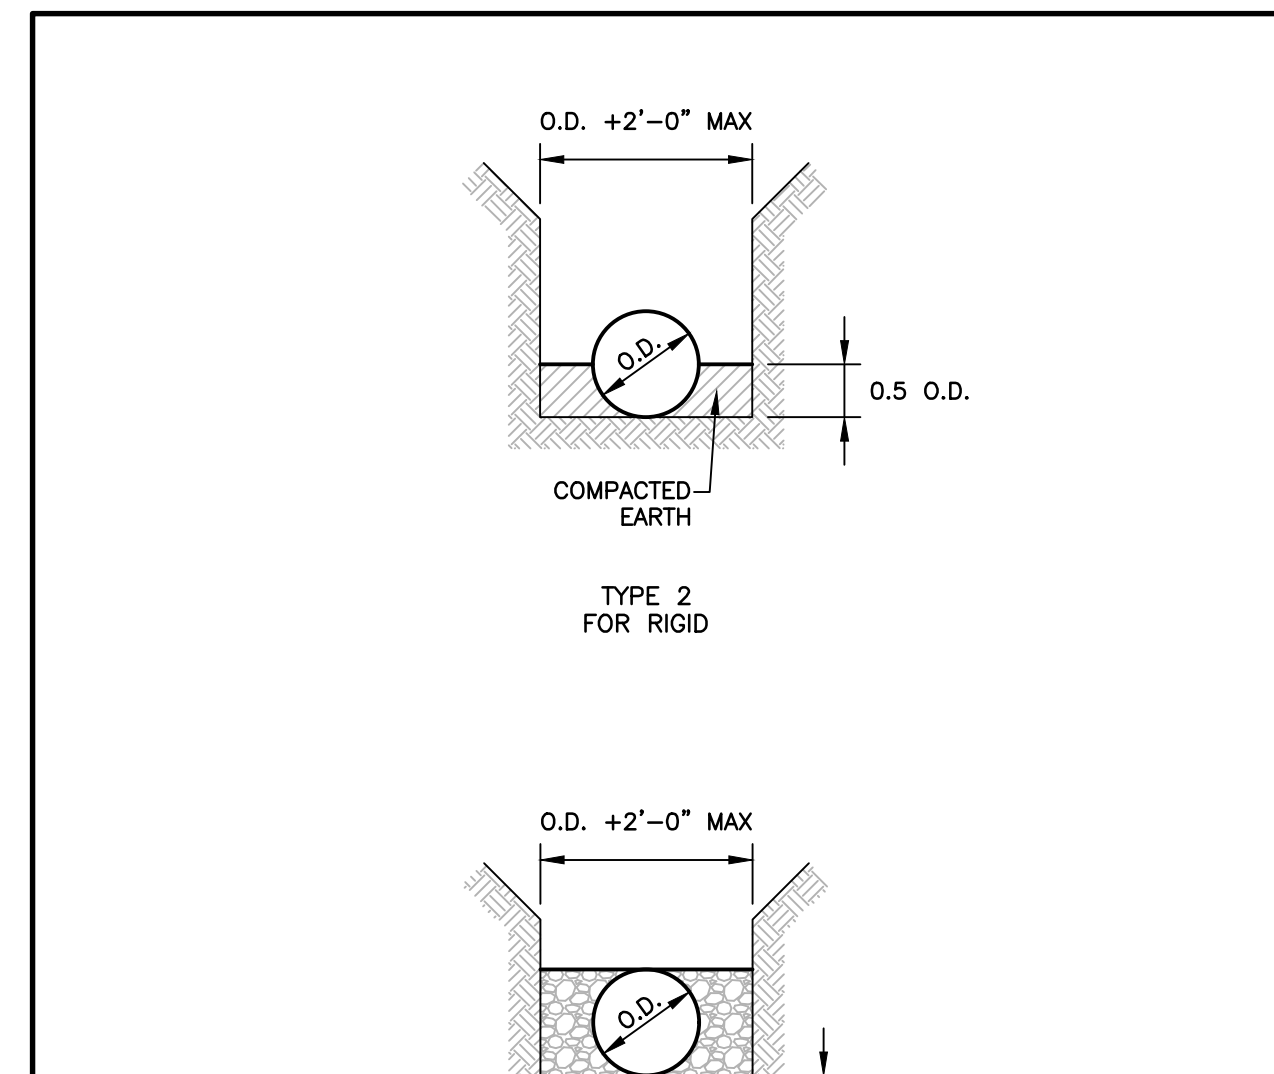

THIS DETAIL WAS TAKEN FROM THE CITY OF ATLANTA'S WEBSITE. IT MAY HAVE BEEN MODIFIED AND SHOULD BE REVIEWED THOROUGHLY.

City of Atlanta
STANDARD DETAILS
 TYPICAL WATER MAIN BEDDING & HAUNCHING
 REV. DATE: OCT. 2011
 ORIG. DATE: OCT. 2004
 SCALE: N.T.S.
 DETAIL NO. WR-G_TR002

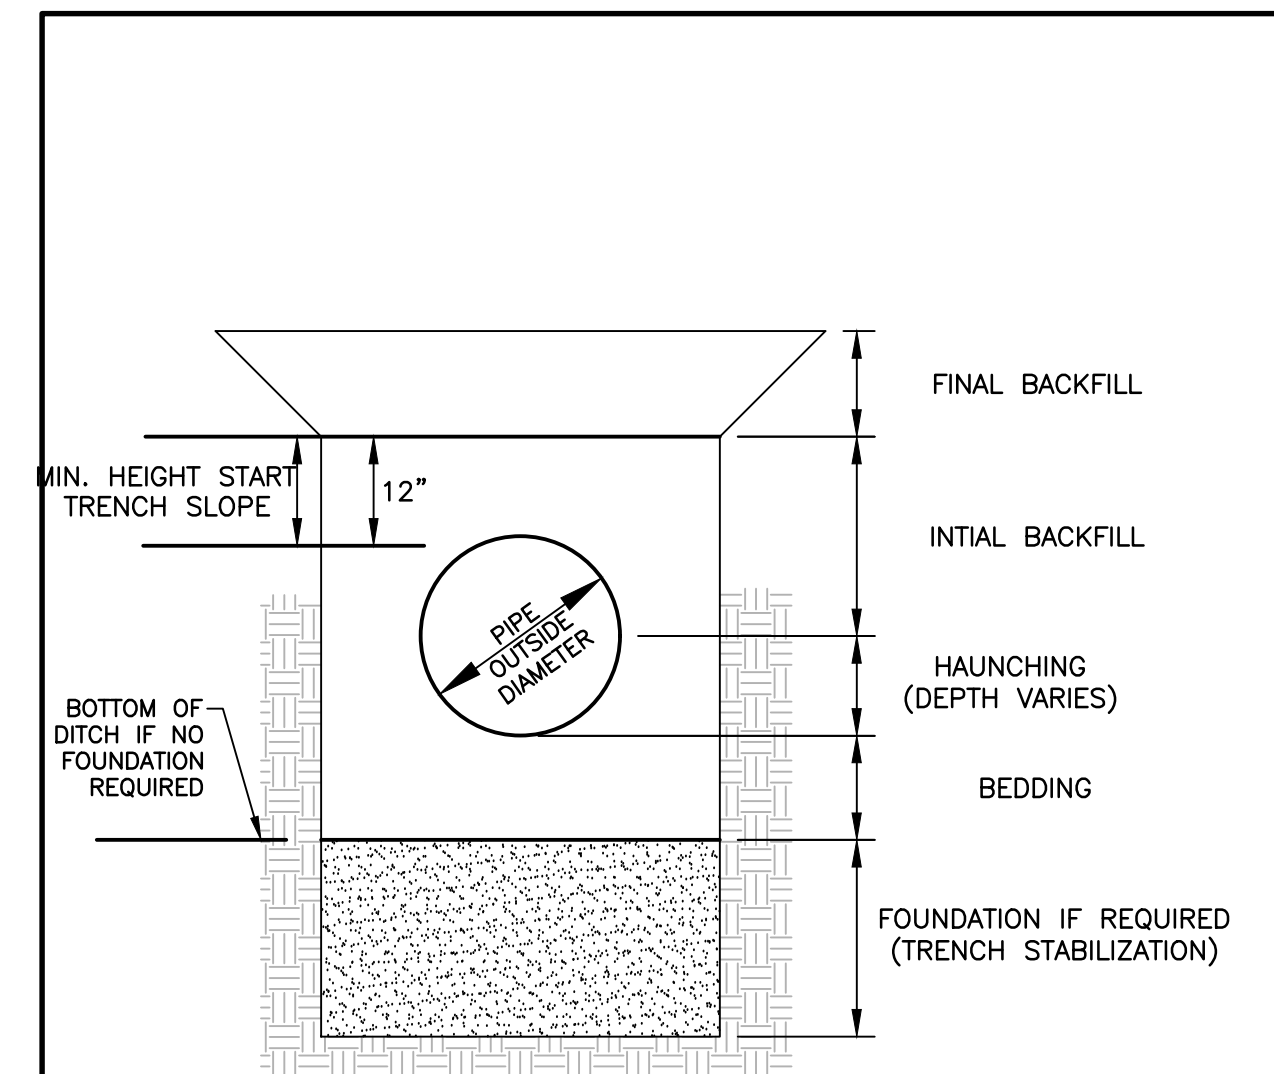

THIS DETAIL WAS TAKEN FROM THE CITY OF ATLANTA'S WEBSITE. IT MAY HAVE BEEN MODIFIED AND SHOULD BE REVIEWED THOROUGHLY.

City of Atlanta
STANDARD DETAILS
 TRENCH TERMINOLOGY
 REV. DATE: OCT. 2011
 ORIG. DATE: OCT. 2004
 SCALE: N.T.S.
 DETAIL NO. WR-G_TR003

NOM. PIPE DIA.	BELL DEPTH	BOLTS				REC. TORQUE FT.-Lbs.	JOINTS ACCESSORY WEIGHT-Lbs.
		DIAMETER	LENGTH	NUMBER PER JOINT			
4	2"	3/4"	3"	4	75-90	10	
6	2"	3/4"	3"	6	75-90	16	
8	2"	3/4"	4"	6	75-90	25	
10	2"	3/4"	4"	8	75-90	30	
12	2"	3/4"	4"	8	75-90	40	
14	3 1/2"	3/4"	4"	10	75-90	45	
16	3 1/2"	3/4"	4"	12	75-90	55	
18	3 1/2"	3/4"	4"	12	75-90	65	
20	3 1/2"	3/4"	4"	14	75-90	85	
24	3 1/2"	3/4"	5"	16	75-90	105	
30	4"	1"	6"	20	100-120	220	
36	4"	1"	6"	24	100-120	285	
42	4"	1 1/4"	6"	28	120-150.	400	
48	4"	1 1/4"	6"	32	120-150.	475	

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City of Atlanta
STANDARD DETAILS
 MECHANICAL JOINT BOLT USAGE CHART
 REV. DATE: OCT. 2011
 ORIG. DATE: NOV. 2004
 SCALE: N.T.S.
 DETAIL NO. WR-G_MJ002


SIZE (NOM)	PUSH-ON-JOINT (18 FT. JOINTS) (20 FT. JOINTS)		MECHANICAL JOINT (18 FT. JOINTS) (20 FT. JOINTS)	
	DEGREE	MAX. OFFSET	DEGREE	MAX. OFFSET
3"	4.0	15"	4.5	17"
4"	4.0	15"	4.5	17"
6"	4.0	15"	4.5	17"
8"	4.0	15"	4.5	17"
10"	4.0	15"	4.5	17"
12"	4.0	15"	4.5	17"
14"	2.5	9.4"	3.0	11"
16"	2.0	7.5"	3.0	11"
20"	2.0	7.5"	2.0	7.5"
24"	2.0	7.5"	2.0	7.5"
30"	1.5	5.5"	2.0	7.5"
36"	1.5	5.5"	2.0	7.5"
42"	1.5	5.5"	1.5	5.5"
48"	1.5	5.5"	1.5	5.5"

NOTES:


1. WHEN A PIPE IS DEFLECTED, THE PIPE SHALL FIRST BE ASSEMBLED IN A STRAIGHT LINE, BOTH HORIZONALLY AND VERTICALLY BEFORE THE DEFLECTION IS MADE.
2. FOR MECHANICAL JOINT PIPE, THE BOLTS SHALL BE PARTIALLY TIGHTENED BEFORE THE LENGTH OF PIPE IS DEFLECTED. ANY SUPPORTED PIPE, SHALL BE SO SUPPORTED THAT THERE IS ZERO DEFLECTION EXCEPT WHERE EITHER A HORIZONTAL OR VERTICAL CURVE ON A BRIDGE OR OTHER STRUCTURE IS INVOLVED.
3. THRUST RESTRAINTS MAY BE REQUIRED ON THE DEFLECTED JOINTS.

THIS DETAIL WAS TAKEN FROM THE CITY OF ATLANTA'S WEBSITE. IT MAY HAVE BEEN MODIFIED AND SHOULD BE REVIEWED THOROUGHLY.


City of Atlanta
STANDARD DETAILS
 MAXIMUM PERMISSIBLE JOINT DEFLECTIONS
 REV. DATE: OCT. 2011
 ORIG. DATE: NOV. 2004
 SCALE: N.T.S.
 DETAIL NO. WR-G_DF001

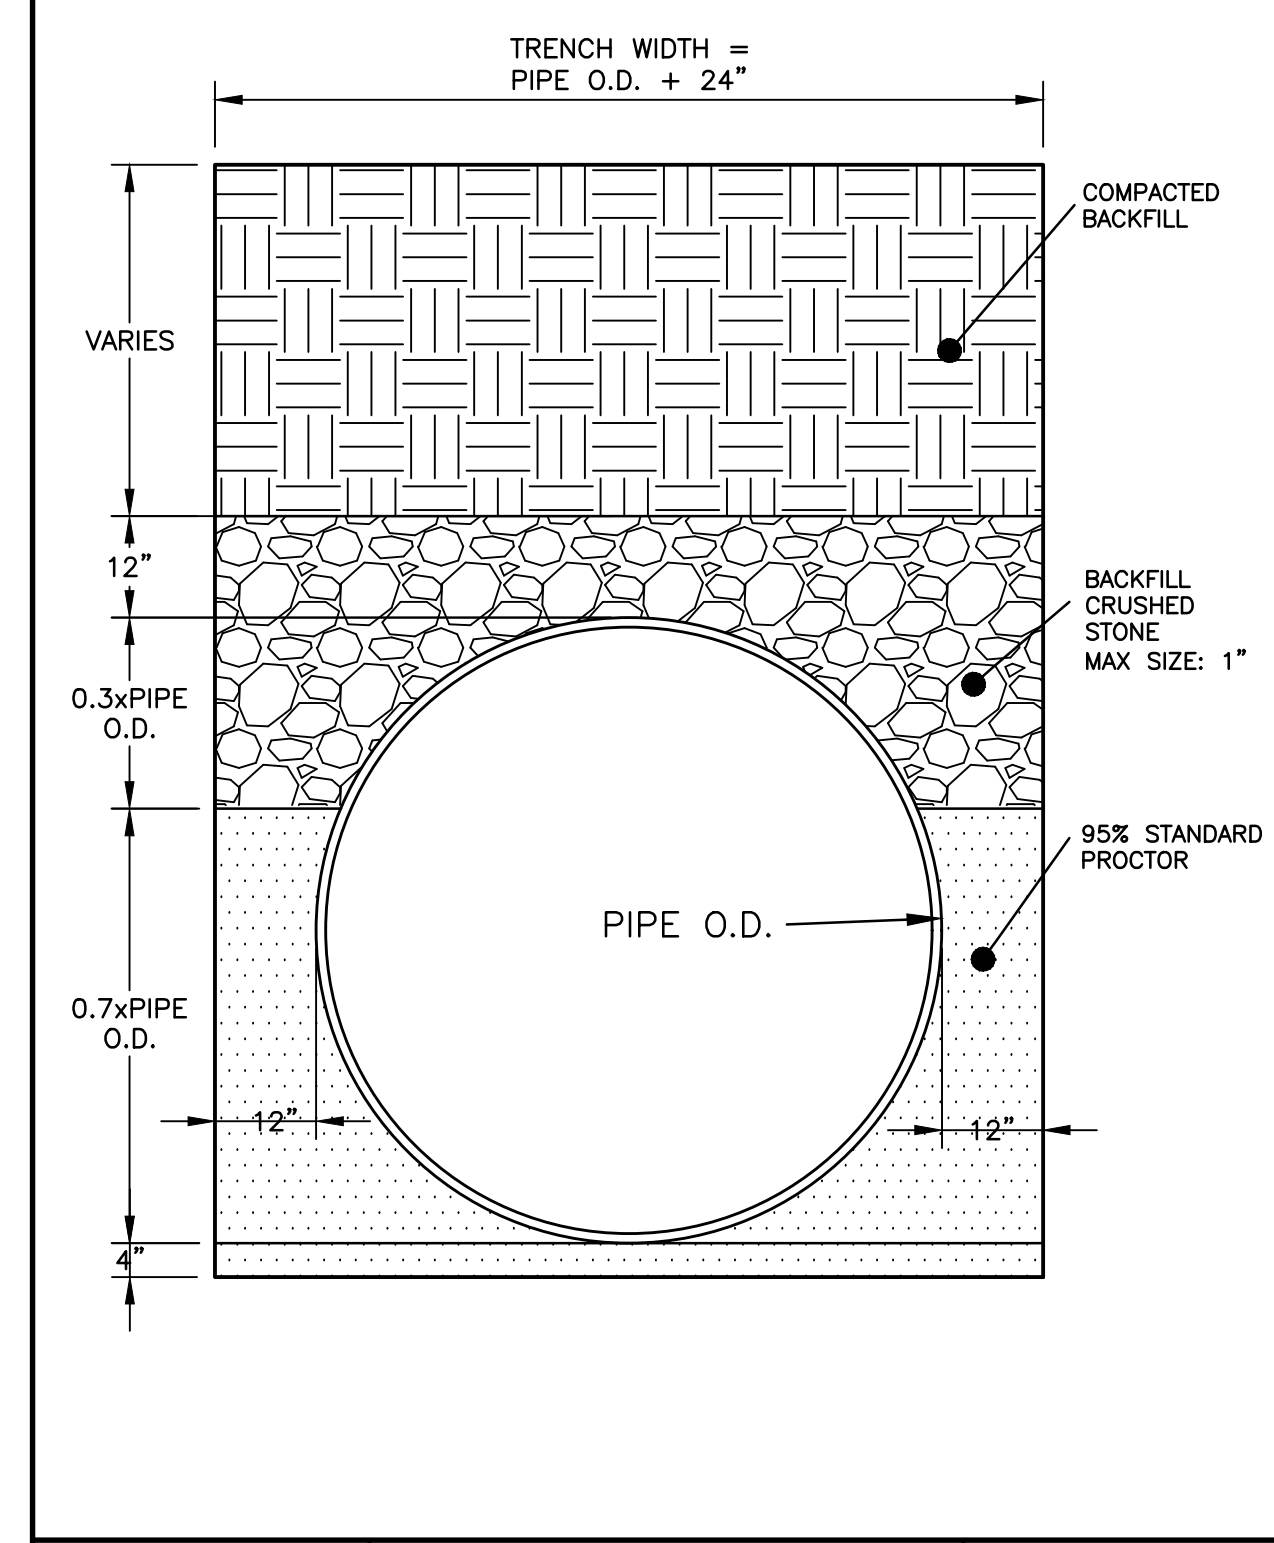

City of Atlanta
STANDARD DETAILS
 LARGE DIAMETER STEEL PIPE TRENCH

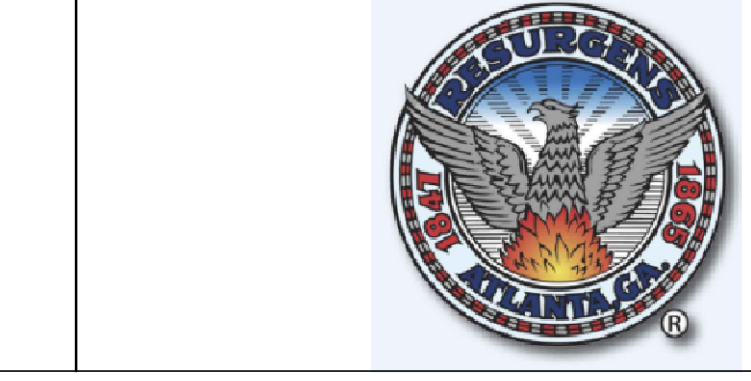

No.	Description	Date

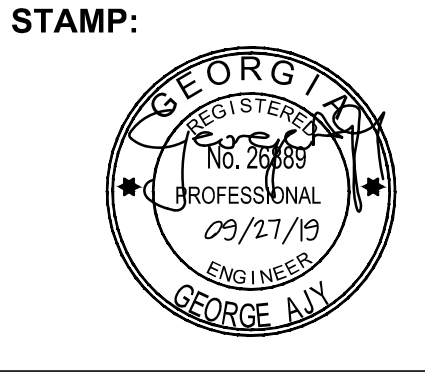







ADDRESS:
 BGR2-JV
 6 CONCOURSE PARKWAY
 SUITE 1600
 ATLANTA, GA 30328
 (770) 569-7038 x101
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PROJECT NO:	TASK_13
DESIGNED BY:	A.T.
DRAWN BY:	H.B.
CHECKED BY:	G.A.
DATE:	09/27/19
SCALE:	AS NOTED

CITY OF ATLANTA DEPT. OF WATERSHED MANAGEMENT
WATER SUPPLY PROGRAM
RIVER INTAKE PUMP STATION
YARD PIPING
DETAILS

DRAWING NO.
RI-PS
DS2-003
 SHEET OF

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NOTES:

1. THE MIDDLE RING LENGTH OF THE FLEXIBLE COUPLING SHALL BE AS SPECIFIED.
2. THE CONTRACTOR SHALL DETERMINE THE LENGTH "J" (COUPLING BOLT LENGTH) FROM MANUFACTURER'S CATALOGS USING THE SPECIFIED MIDDLE RING LENGTH.
3. "G" = MANUFACTURER'S RECOMMENDED SPACE BETWEEN ENDS OF PIPE.
4. "C" = J+Z+1 INCH, (ROUND THIS VALUE UP TO NEXT EVEN INCH), MINIMUM. (FOR Z DIMENSIONS, SEE LUG SCHEDULE.)
5. TIE ROD LENGTH = 2L+2C+G.

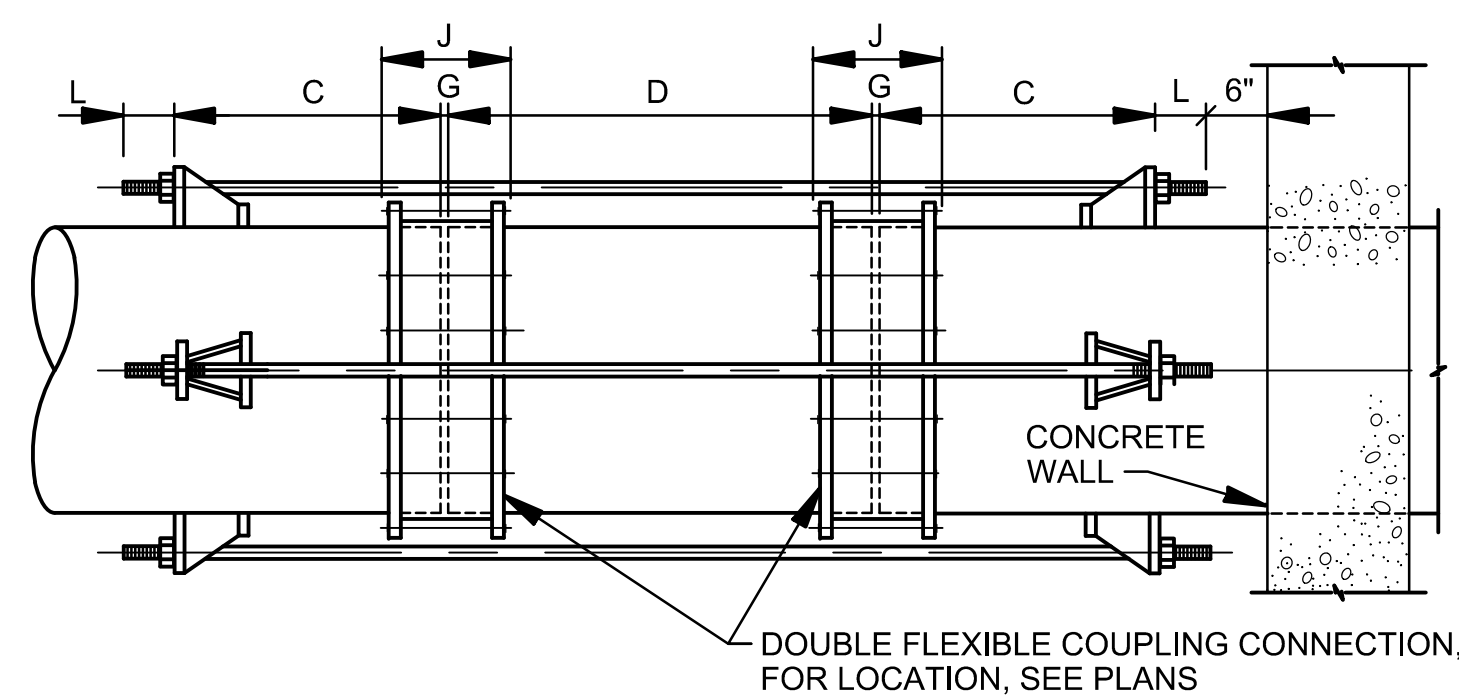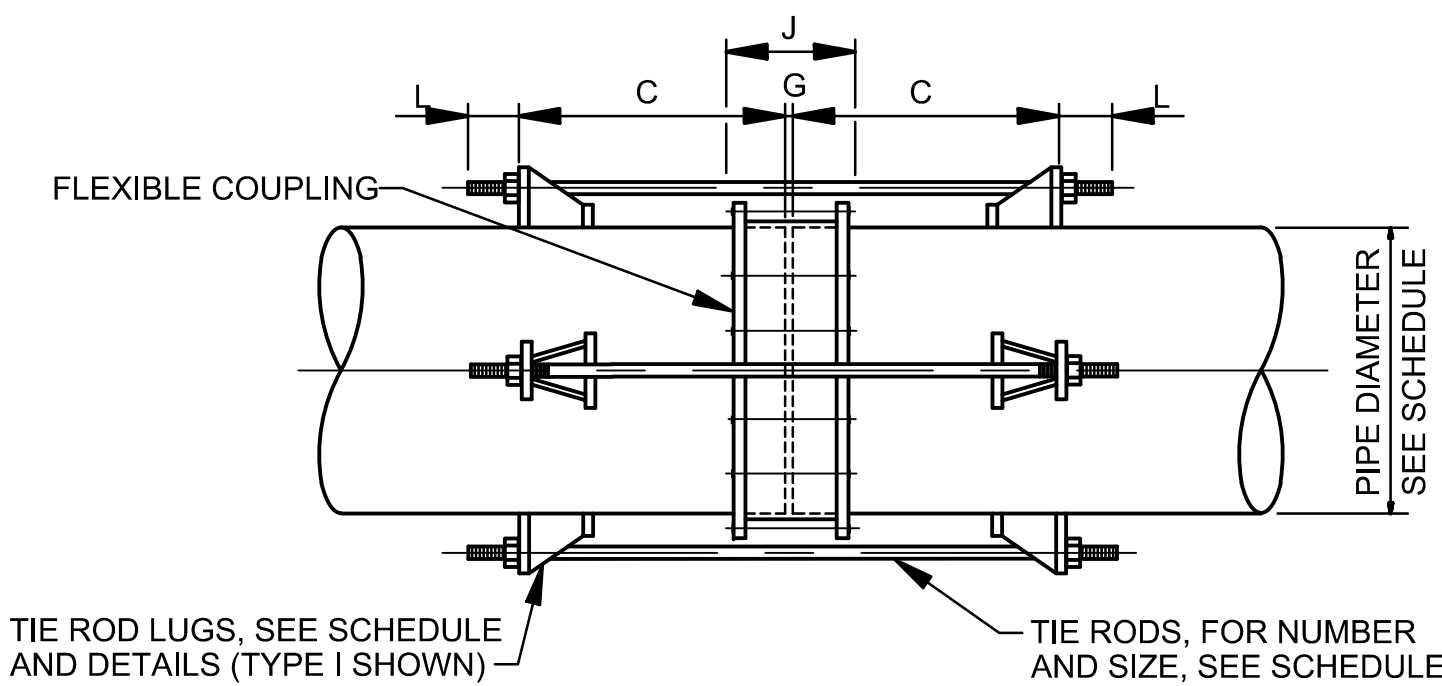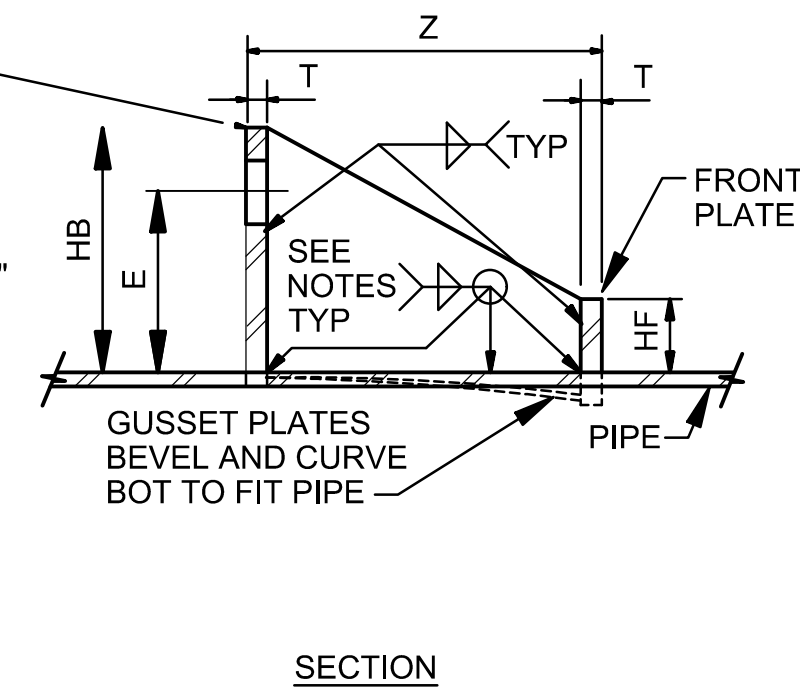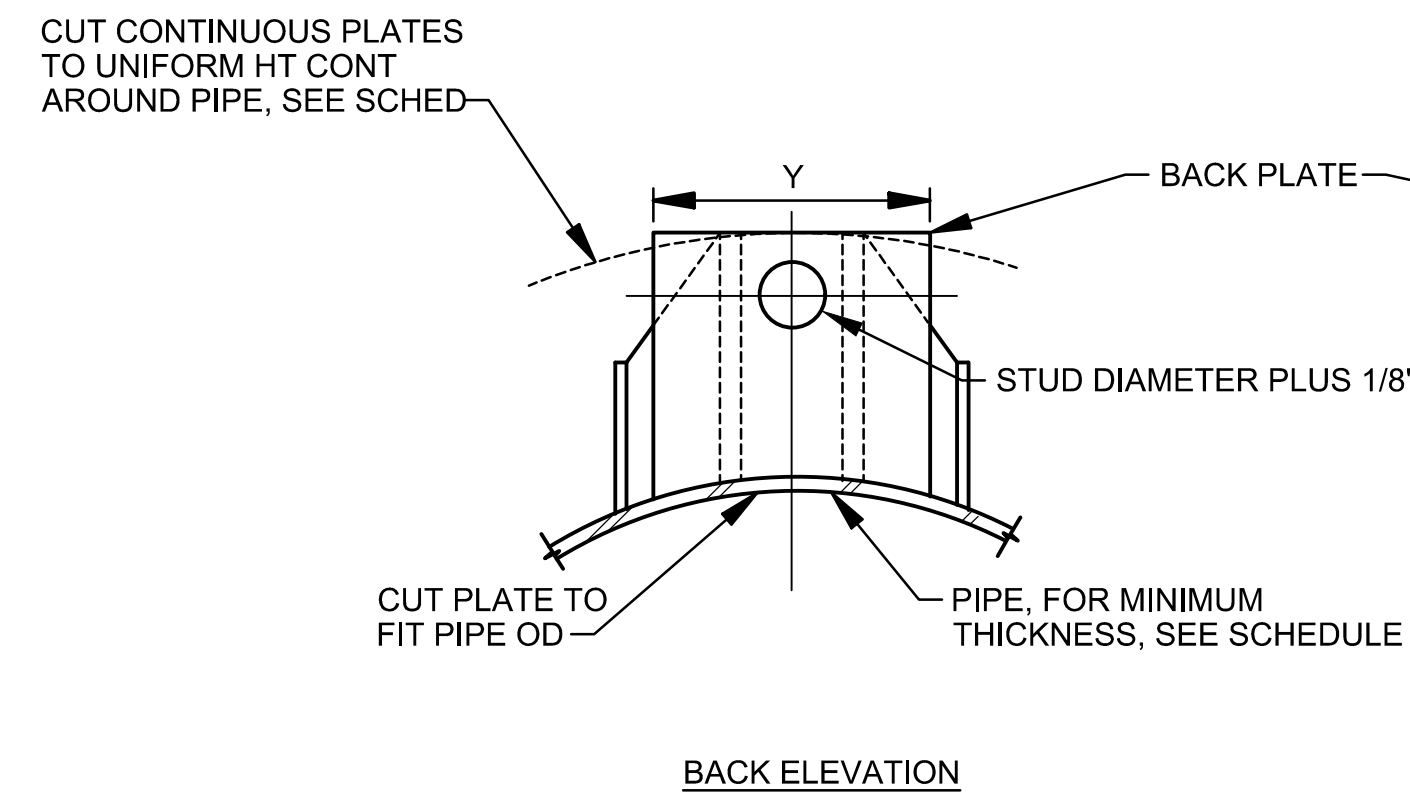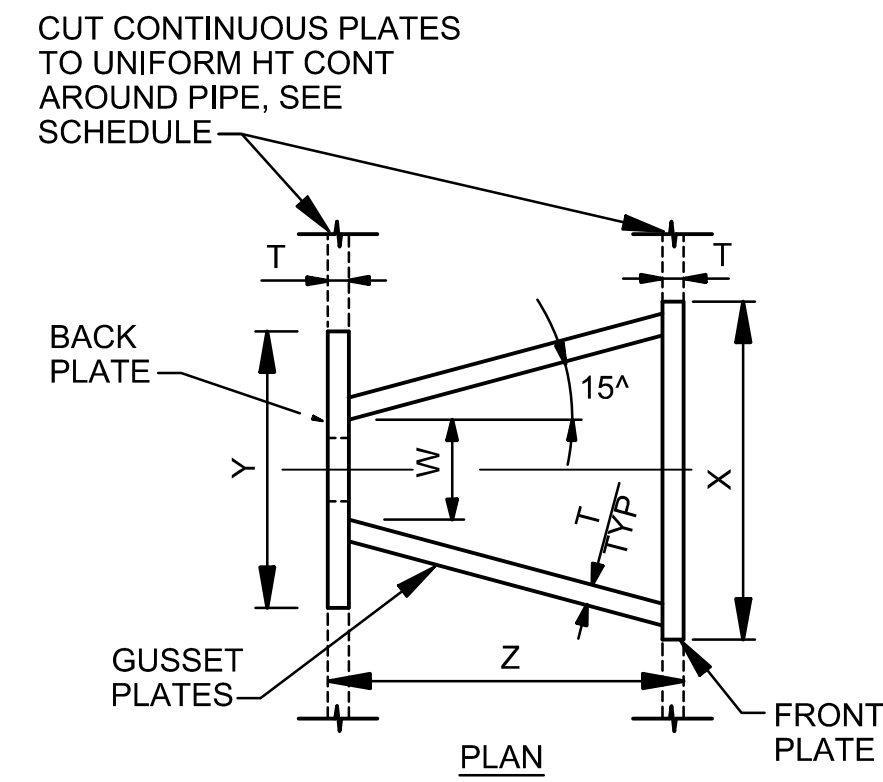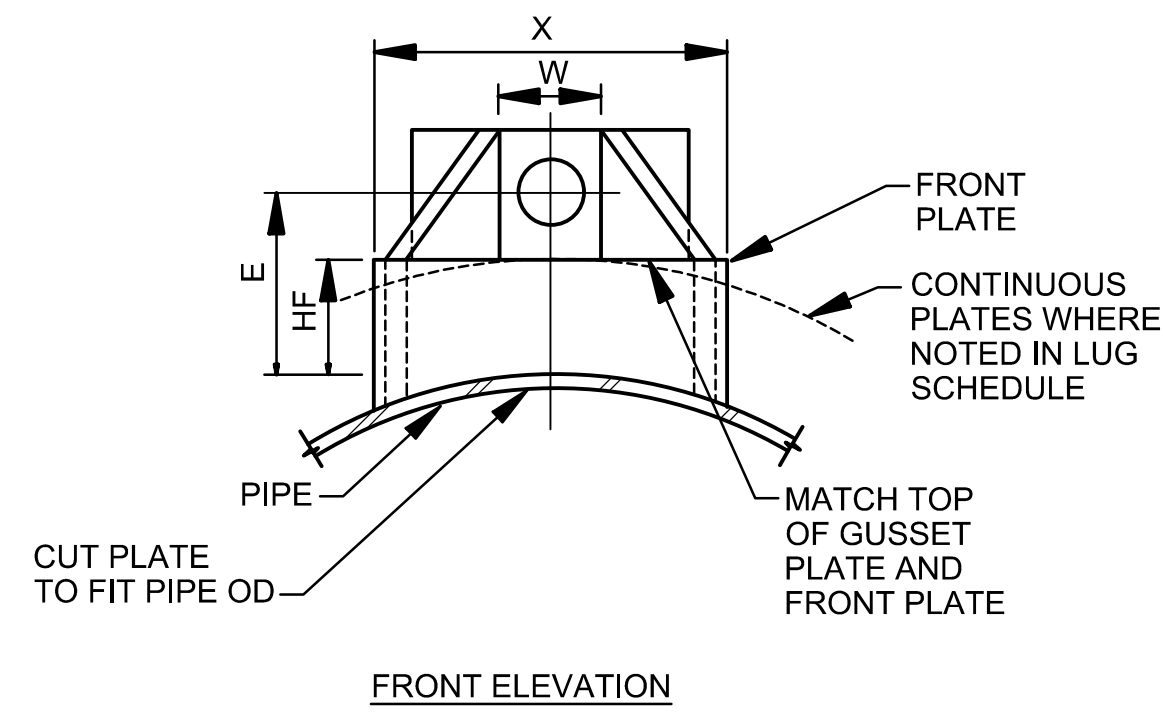NOTES:

1. THE MIDDLE RING LENGTH OF THE FLEXIBLE COUPLING SHALL BE AS SPECIFIED.
2. THE CONTRACTOR SHALL DETERMINE THE LENGTH "J" (COUPLING BOLT LENGTH) FROM MANUFACTURER'S CATALOGS USING THE SPECIFIED MIDDLE RING LENGTH.
3. G = MANUFACTURER'S RECOMMENDED SPACE BETWEEN ENDS OF PIPE.
4. C = J+Z+1 INCH, (ROUND THIS VALUE UP TO NEXT EVEN INCH), MINIMUM. (FOR Z DIMENSIONS, SEE LUG SCHEDULE.)
5. D = 2C+6 INCHES.
6. TIE ROD LENGTH = 2L+2C+2G+D.
7. SIMILAR, TO TYPICAL THRUST TIE DETAIL EXCEPT AS NOTED.

1 THRUST TIE

LUG SCHEDULE										
ROD DIA	LUG TYPE	T	W	X	Y	Z	HB	E	HF	L
5/8	I	3/8	1-3/8	4-1/16	4-1/2	3-3/8	3-7/8	3	1-3/4	3
3/4	I	3/8	1-1/2	5	4-1/2	5	4-1/8	3-1/8	1-3/4	3
7/8	I	1/2	1-5/8	5-1/2	4-1/2	5-1/8	4-1/4	3-1/8	1-3/4	4
1	II	1/2	1-3/4	5-3/4	CONT	6	4-1/2	3-1/4	2	4
1-1/4	II	5/8	2	7-1/4	CONT	7-5/8	5	3-3/4	2	4
1-1/2	II	3/4	2-1/4	9	CONT	10-1/8	5-1/2	3-7/8	2	4
1-3/4	III	1	2-1/2	CONT	CONT	11-7/8	5-7/8	4	2-1/4	4
2	III	1	2-3/4	CONT	CONT	13-7/8	6-1/4	4-1/4	2-1/2	4

TIE ROD SCHEDULE													
TEST PRESSURE		25 PSI TIE RODS		50 PSI TIE RODS		100 PSI TIE RODS		150 PSI TIE RODS		225 PSI TIE RODS		375 PSI TIE RODS	
PIPE DIA (IN.)	MIN PIPE WALL THKS (IN.)*	DIA (IN.)	NO. REQD	DIA (IN.)	NO. REQD	DIA (IN.)	NO. REQD	DIA (IN.)	NO. REQD	DIA (IN.)	NO. REQD	DIA (IN.)	NO. REQD
6	3/16	—	—	—	—	5/8	2	5/8	2	5/8	2	5/8	2
8	3/16	—	—	—	—	5/8	2	5/8	2	5/8	2	3/4	2
10	3/16	—	—	—	—	5/8	2	5/8	2	3/4	2	7/8	2
12	3/16	5/8	2	5/8	2	5/8	2	5/8	2	3/4	2	7/8	4
14	3/16	5/8	2	5/8	2	3/4	2	3/4	2	3/4	4	1	4
16	3/16	5/8	2	5/8	2	3/4	2	7/8	2	7/8	4	1	4
18	1/4	5/8	2	5/8	2	7/8	2	1	2	1	4	1-1/4	4
20	1/4	5/8	2	3/4	2	7/8	2	7/8	4	1	4	1-1/4	4
22	1/4	5/8	2	3/4	2	3/4	4	7/8	4	1	4	1-1/2	4
24	1/4	5/8	2	3/4	2	7/8	4	1	4	1	6	1-1/2	6
30	1/4	5/8	4	3/4	4	7/8	6	1	6	1	8	1-1/2	8
36	1/4	3/4	4	7/8	4	1	6	1	8	1-1/4	8	1-1/2	10
42	1/4	3/4	4	1	4	1	8	1-1/4	8	1-1/2	8	1-3/4	10
48	5/16	7/8	4	7/8	8	1	10	1-1/4	10	1-1/2	10	1-3/4	12
54	5/16	3/4	6	7/8	8	1	12	1-1/4	12	1-1/2	12	1-3/4	14
60	11/32	7/8	6	1	8	1-1/4	10	1-1/4	14	1-1/2	14	1-3/4	16
72	3/8	7/8	8	1	10	1-1/4	12	1-1/2	14	1-3/4	14	2	18
78	13/32	7/8	8	1	12	1-1/4	14	1-1/2	16	1-3/4	16	2	20
84	7/16	7/8	10	1-1/4	10	1-1/2	14	1-3/4	14	1-3/4	18	2	22
96	7/16	1	10	1-1/4	12	1-1/2	16	1-3/4	16	2	16	—	—
108	1/2	1	12	1-1/4	12	1-3/4	12	2	14	2	22	—	—
120	5/8	1-1/4	8	1-1/2	10	1-3/4	16	2	18	—	—	—	—
132	23/32	1-1/4	6	1-3/4	10	1-3/4	18	2	22	—	—	—	—

NOTES:

1. LUG SCHEDULE DIMENSIONS IN INCHES.
2. TIE RODS SHALL CONFORM TO ASTM A193 GRADE B7.
3. NUTS SHALL CONFORM TO ASTM A194 GRADE 2H.
4. PLATE SHALL CONFORM TO ASTM A283 GRADE D.
5. TIE ROD NUTS SHALL BE TIGHTENED GRADUALLY AND EQUALLY IN STAGES TO PREVENT UNEVEN ALIGNMENT AND TO ALLOW EQUAL STRESS ON ALL TIE RODS UNDER PRESSURE. TIGHTEN UNTIL SNUG. THREADS SHALL PROTRUDE FROM NUTS. PEEN THREADS AFTER TIGHTENING NUTS.
6. TIE ROD LUGS SHALL BE SPACED EQUALLY AROUND PIPE.
7. FILLET WELDS SHALL MEET THE MINIMUM REQUIREMENTS OF THE AISC SPECIFICATIONS EXCEPT AS FOLLOWS: FILLET WELDS SHALL BE 1/4-INCH MINIMUM EXCEPT WHEN WELDING 3/16-INCH PLATE WHERE THEY SHALL BE 3/16-INCH.
8. CATHODIC PROTECTION FOR FLEXIBLE COUPLINGS REQUIRED WHERE NOTED ON DWGS OR IN THE SPECIFICATIONS.
9. CONTRACTOR SHALL USE DATA FOR ONLY THOSE PIPE SIZES AND TEST PRESSURES SPECIFIED IN THIS CONTRACT.
10. LUG TYPE I IS AS SHOWN IN DETAIL. LUG TYPE II HAS CONTINUOUS FRONT AND BACK PLATES AROUND PIPE.
11. TIE RODS SHALL NOT BE ATTACHED TO A PIPE WHEN THE WALL THICKNESS IS LESS THAN THE MINIMUM SHOWN ON THE TIE ROD SCHEDULE.
12. THE MINIMUM PIPE WALL THICKNESSES SHOWN ARE TO ENSURE PROPER PERFORMANCE OF THE THRUST TIE LUG. PIPE WALL THICKNESSES GREATER THAN SHOWN IN THE TABLE MAY BE REQUIRED AND MAY BE SHOWN ELSEWHERE OR SPECIFIED ELSEWHERE TO RESIST INTERNAL PRESSURES.



No.	Description	Date

STAMP:



ADDRESS:

BGR2-JV
6 CONCOURSE PARKWAY
SUITE 1600
ATLANTA, GA 30328
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FAX: (770) 993-5082

PROJECT NO:	TASK_13
DESIGNED BY:	A.T.
DRAWN BY:	H.B.
CHECKED BY:	G.A.
DATE:	09/27/19
SCALE:	NONE

CITY OF ATLANTA DEPT. OF WATERSHED MANAGEMENT
WATER SUPPLY PROGRAM

RIVER INTAKE PUMP STATION
PROCESS
DETAILS



DRAWING NO.

RI-PS

DS2-004


SHEET OF

P:\City of Atlanta - Water Supply Program Phase \ACD Drawings\PROCESS\RI-PS DS2-005-006.dwg, PRINTED BY: Hoop/Barnes ON Thu, Dec 05 2019 AT 8:47 AM

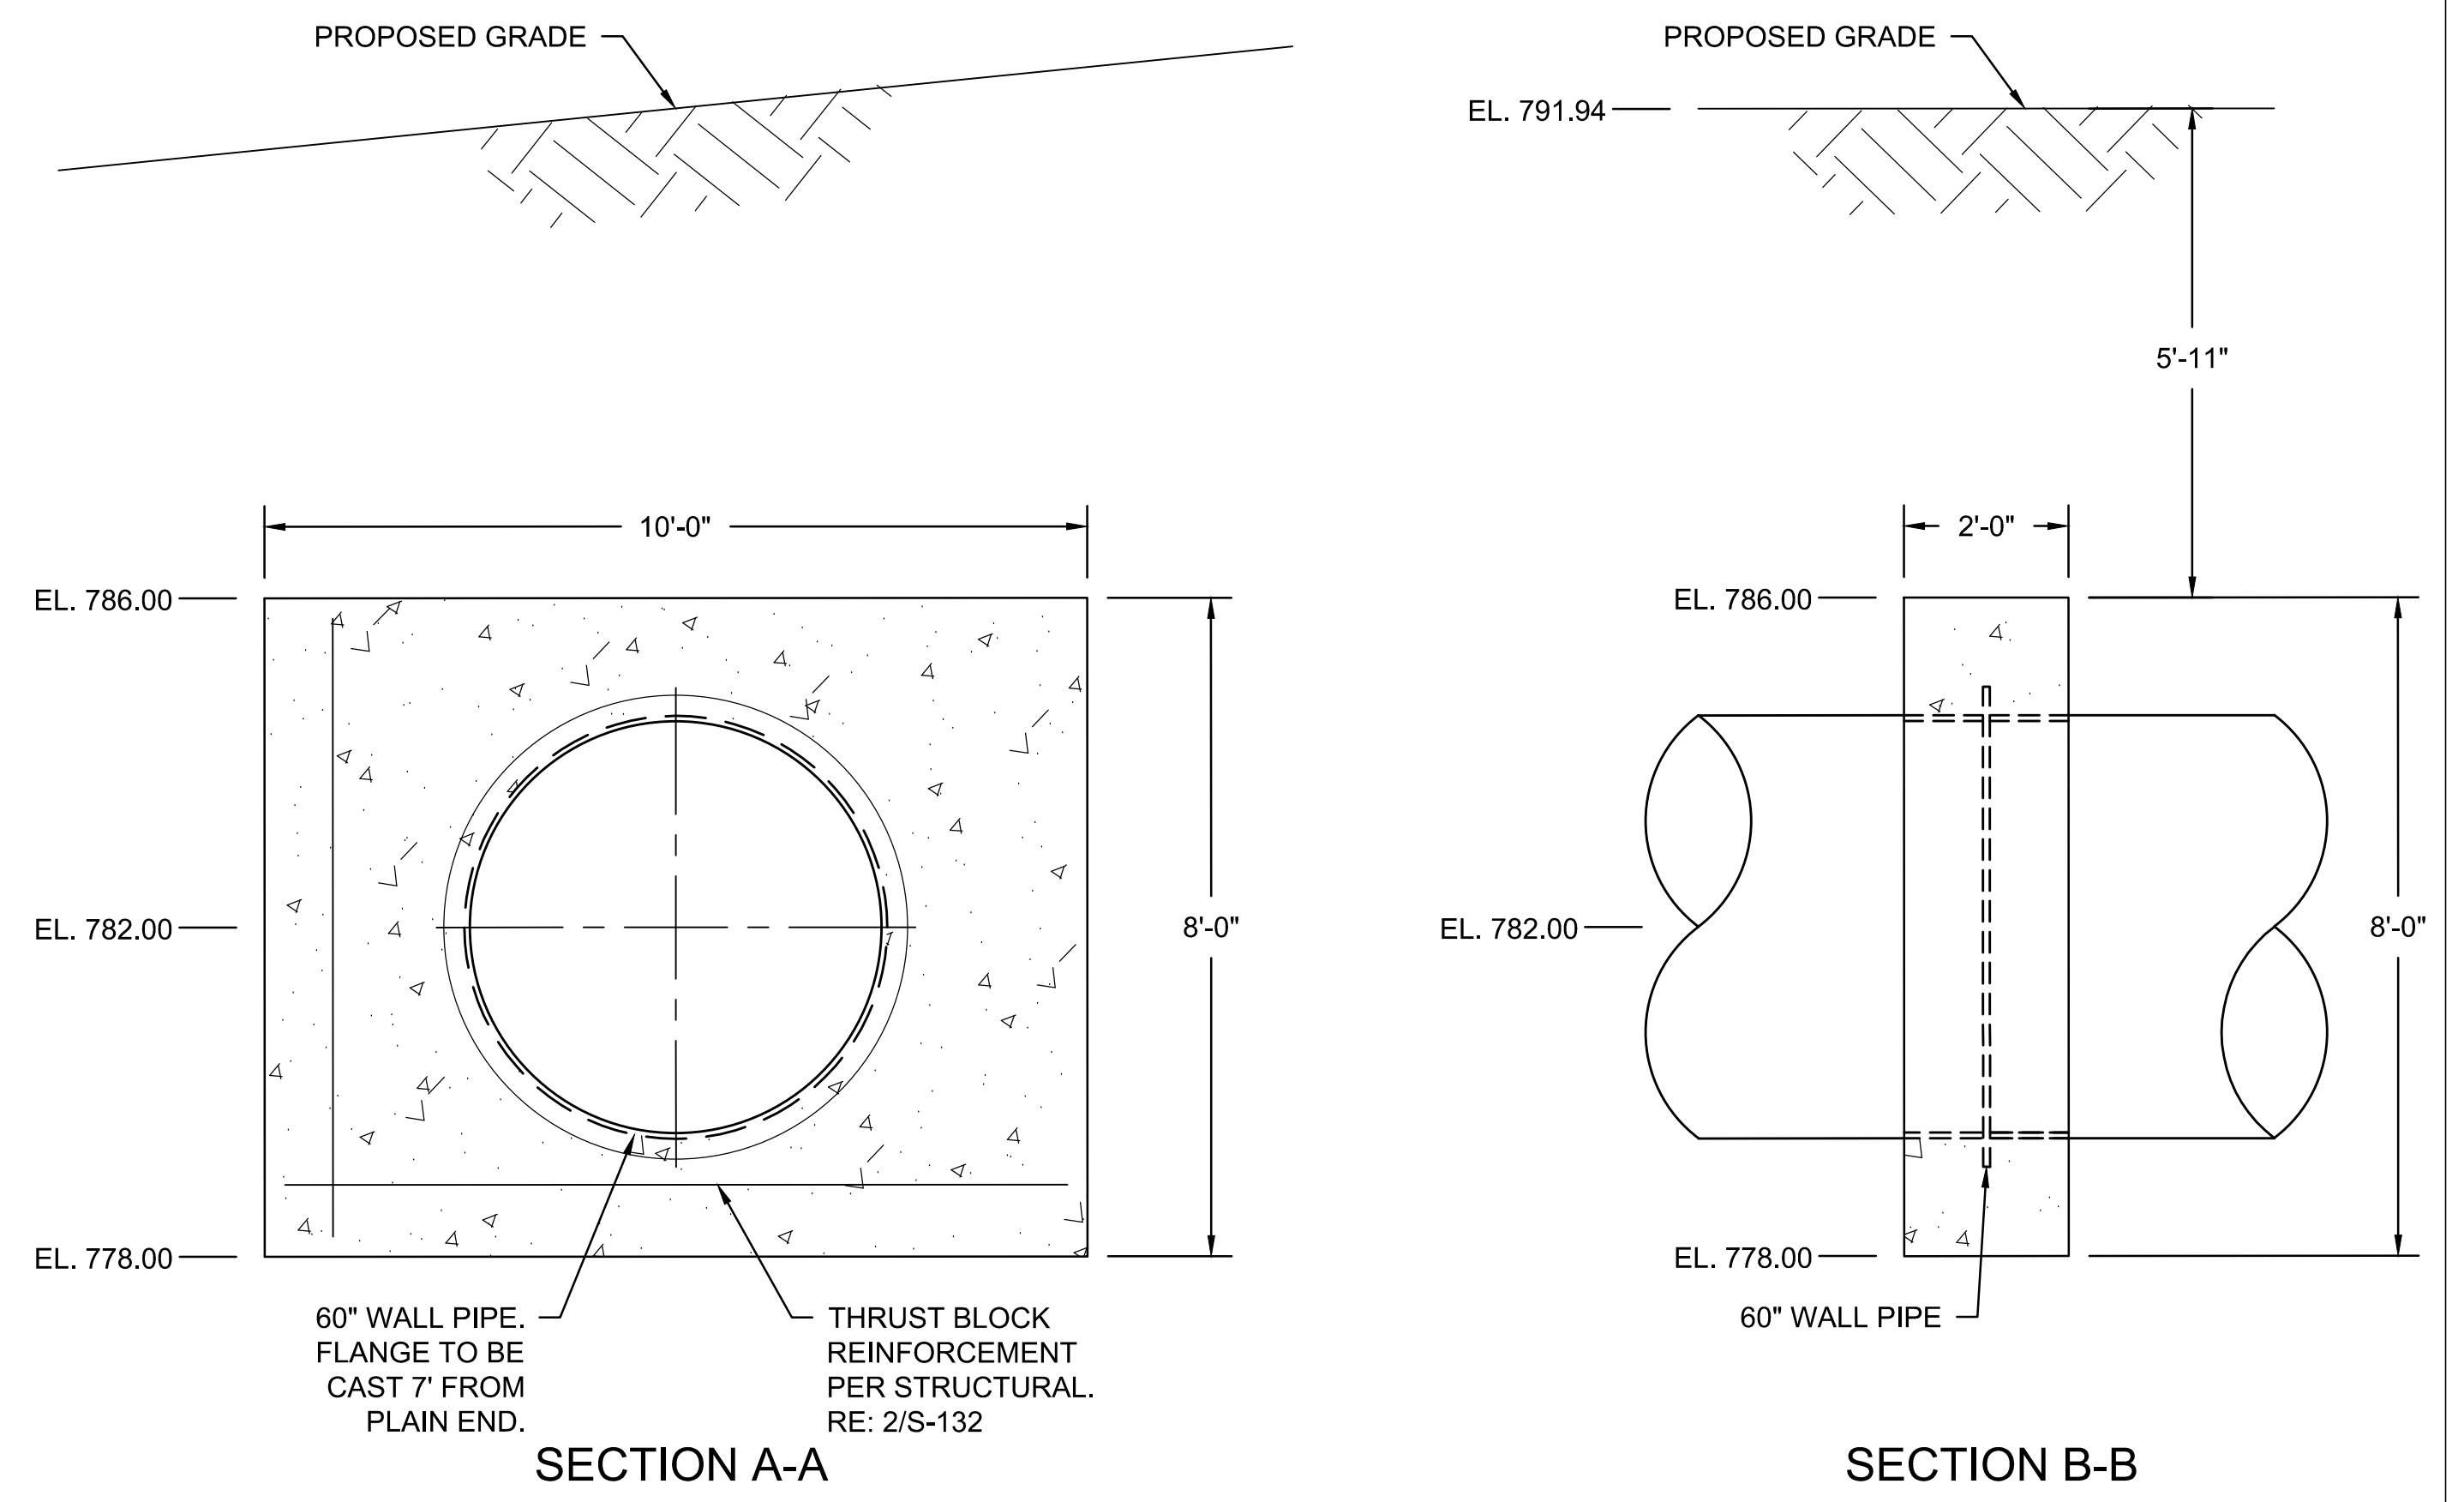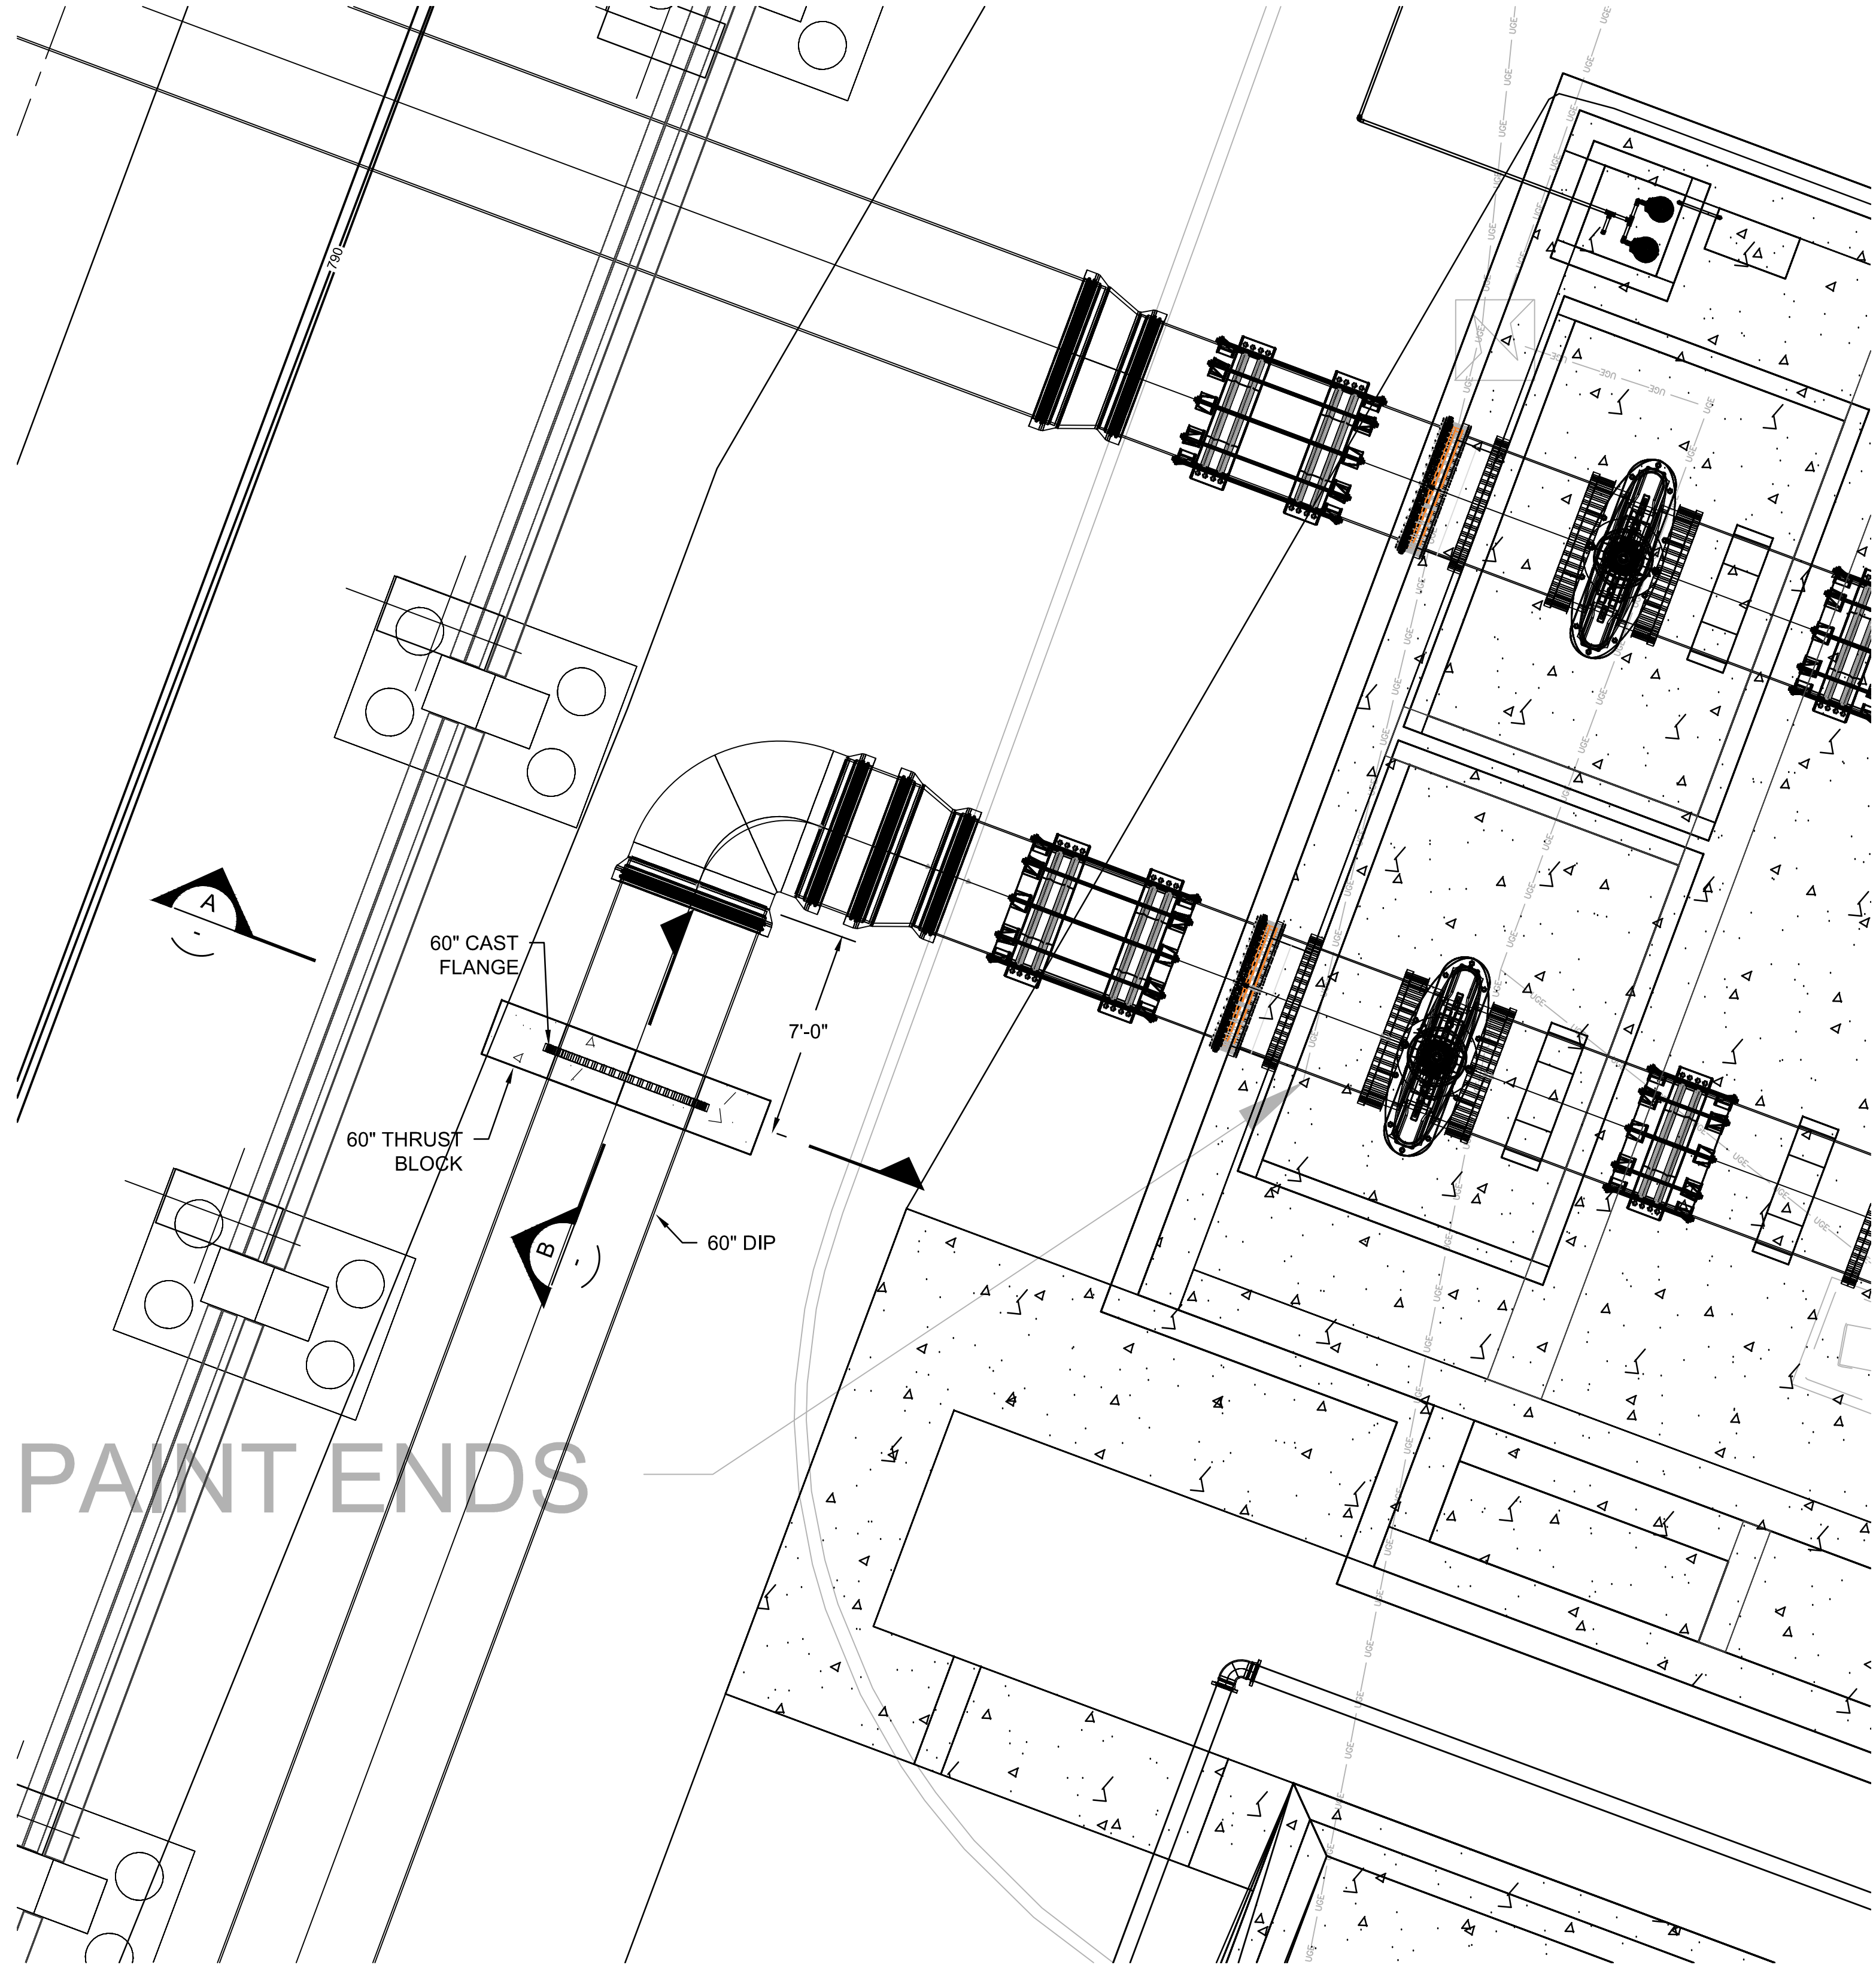


CONCRETE THRUST BLOCK
SCALE: 3/4" = 1'-0"

THRUST BLOCK DETAIL
SCALE: 1" = 5'-0"

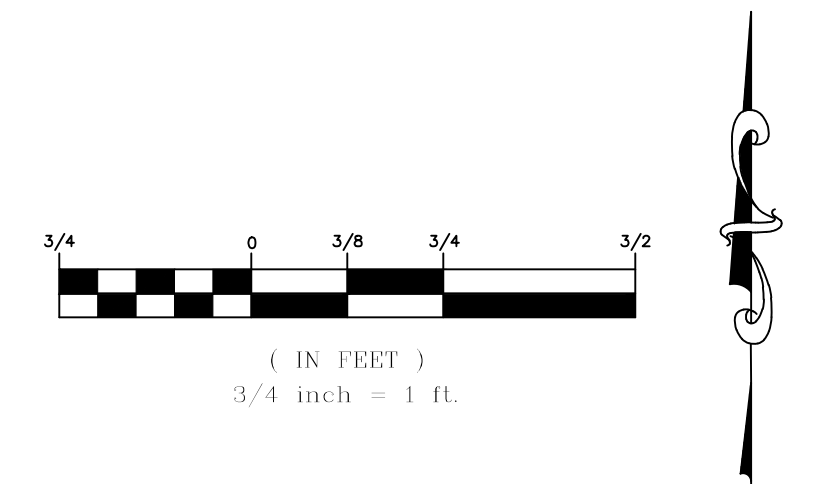

No.	Description	Date

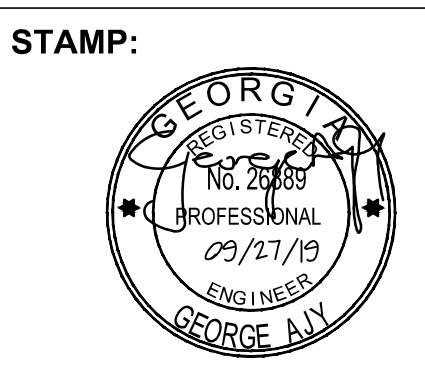

ADDRESS:
BGR2-JV
6 CONCOURSE PARKWAY
SUITE 1600
ATLANTA, GA 30328
(770) 569-7038 x101
FAX: (770) 993-5082


PROJECT NO:	TASK_13
DESIGNED BY:	A.T.
DRAWN BY:	J.J.
CHECKED BY:	G.A.
DATE:	09/27/19
SCALE:	AS NOTED

**CITY OF ATLANTA DEPT. OF WATERSHED MANAGEMENT
WATER SUPPLY PROGRAM**
**RIVER INTAKE PUMP STATION
CONCRETE THRUST BLOCK
DETAILS**

DRAWING NO.
RI-PS
DS2-005
SHEET OF

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SAMPLE LINE ROUTING
SCALE: 3/4" = 1'-0"

1

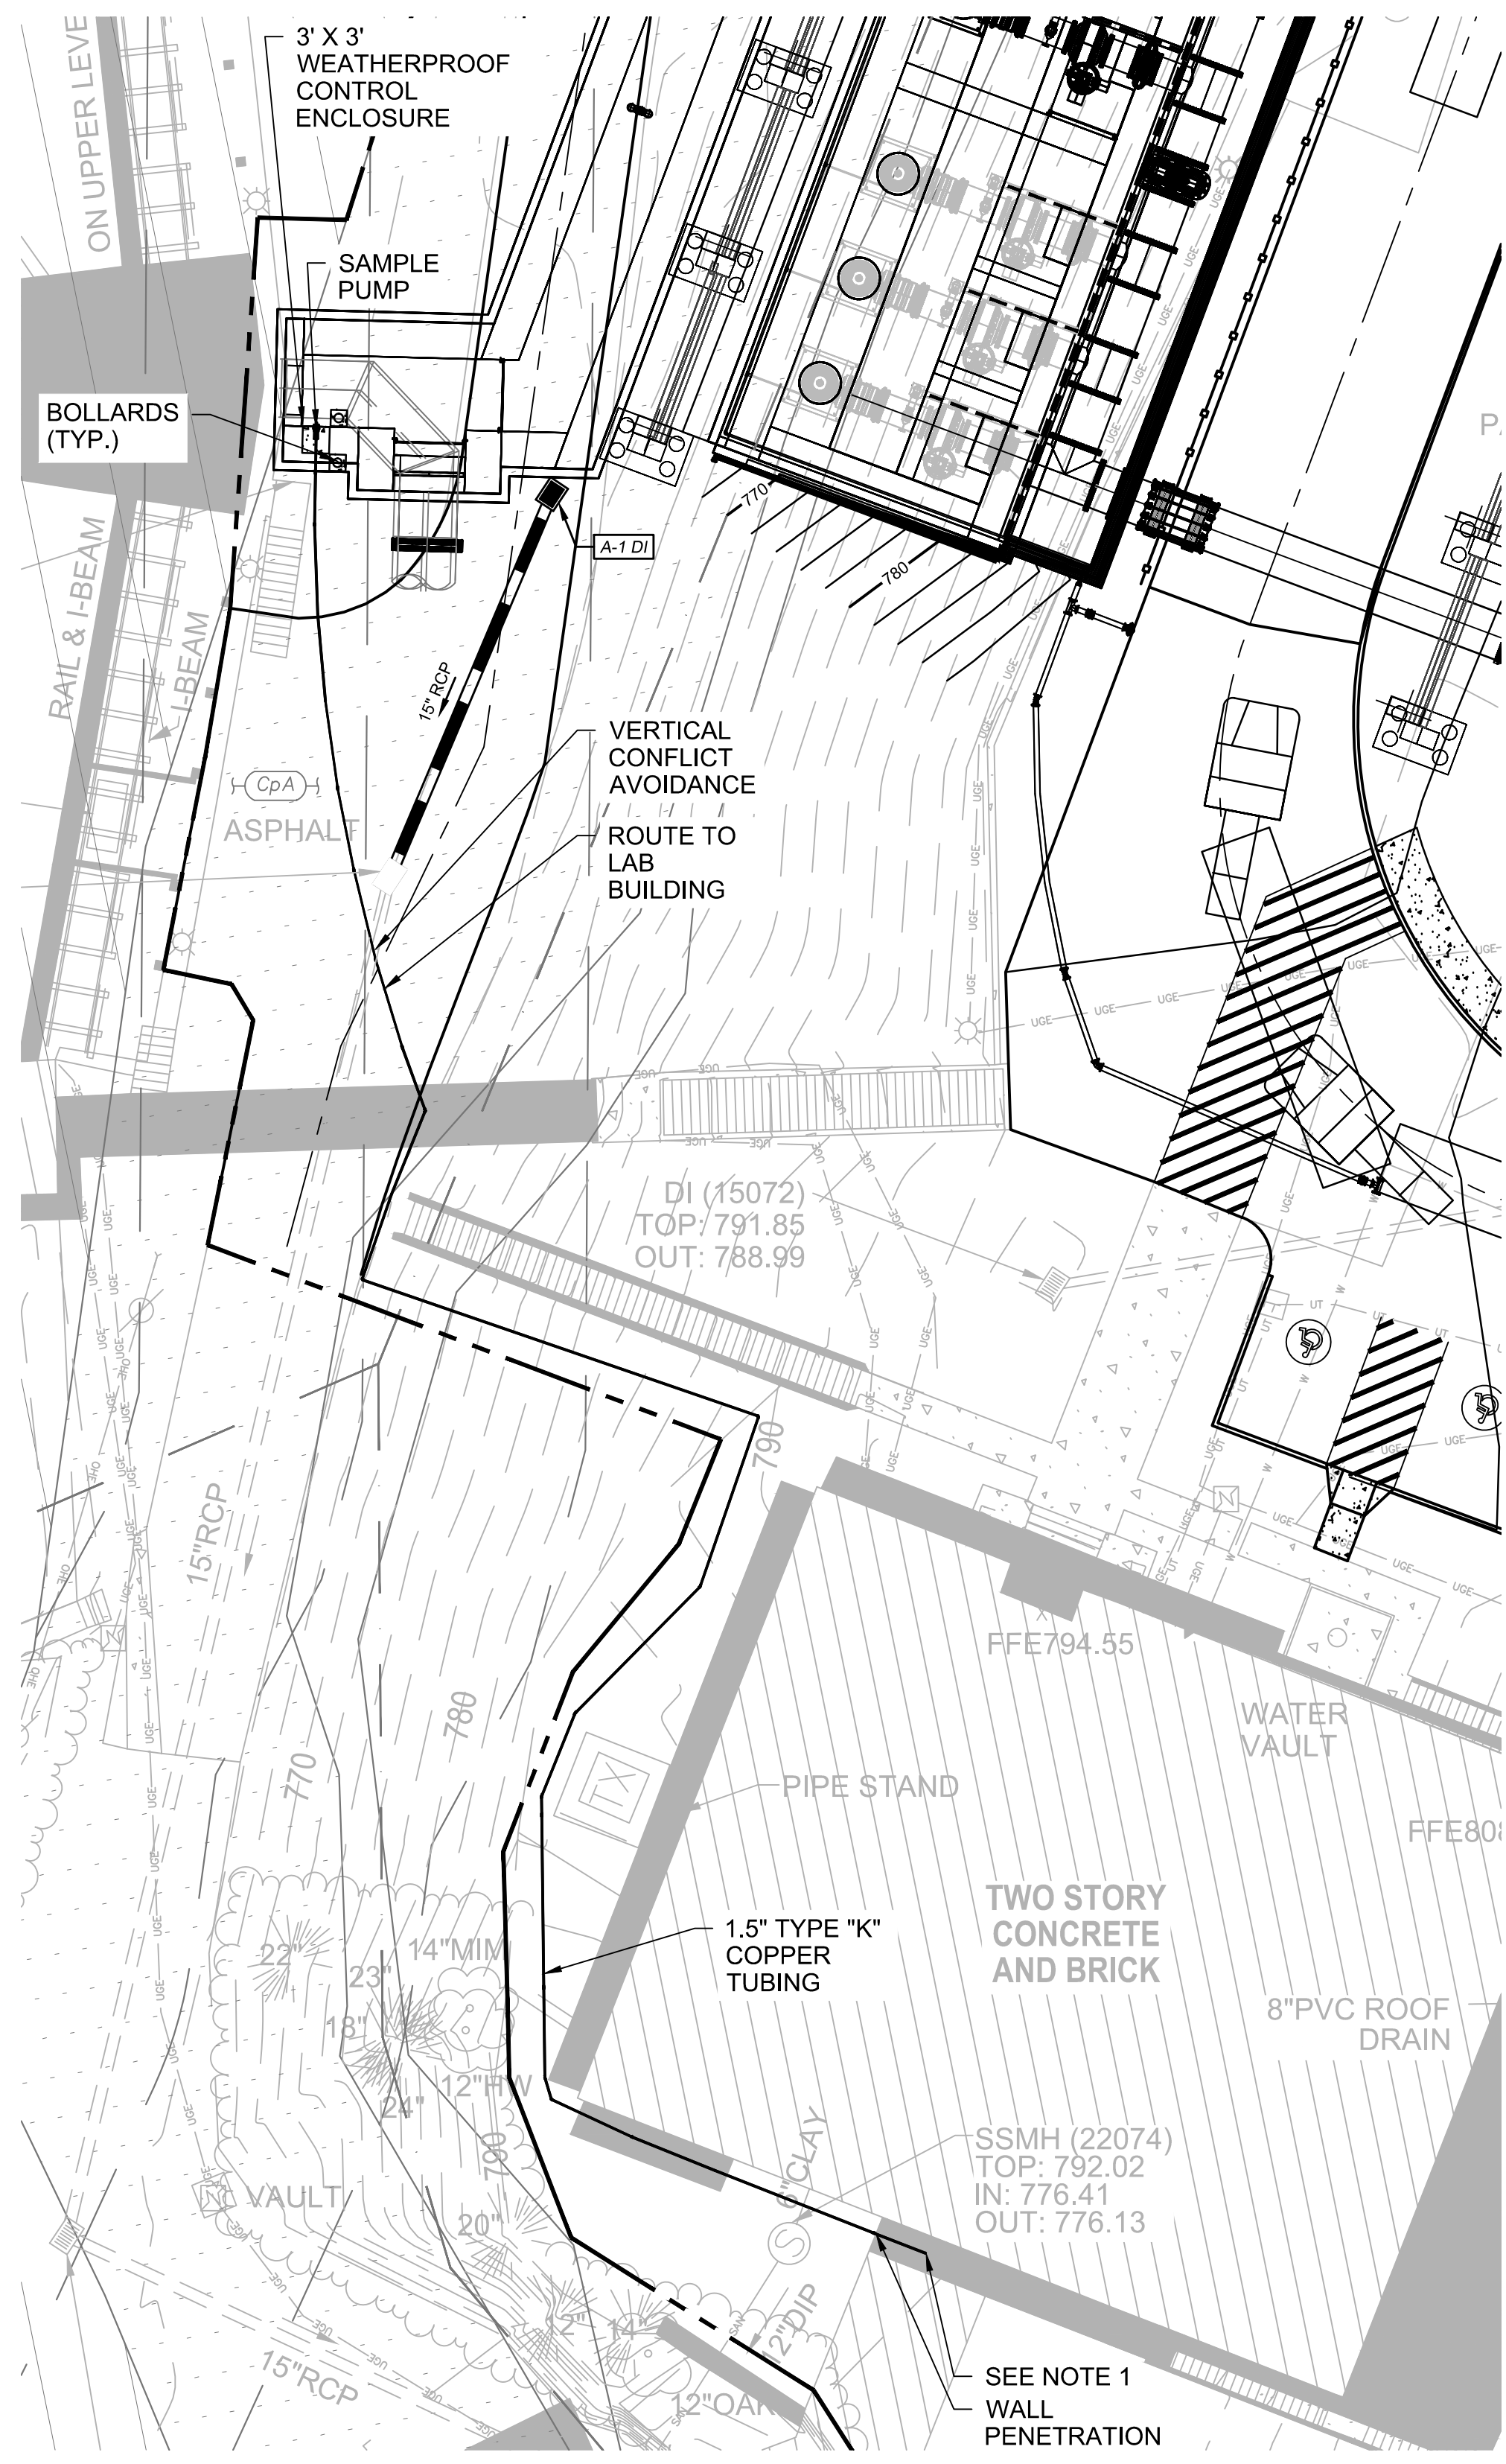

WALL PENETRATION.
SEE NOTE 2 & 3.

OUTSIDE WALL PENETRATION
SCALE: NTS

2




EXISTING SAMPLE LINE
SEE NOTE 1

WALL PENETRATION.
SEE NOTE 2 & 3.

INSIDE WALL PENETRATION
SCALE: NTS

3

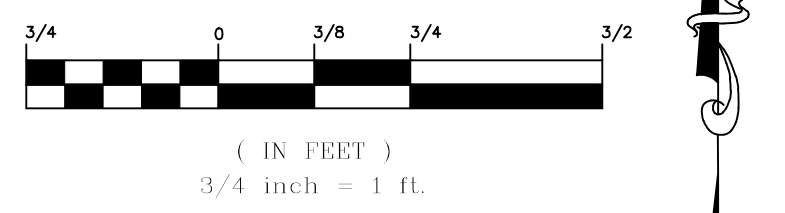


NOTES:

1. CONTRACTOR TO CUT EXISTING SAMPLE LINE, CAP UPSTREAM END OF EXISTING SAMPLE LINE, TRANSITION SIZE OF NEW SAMPLE LINE TO MATCH SIZE OF EXISTING SAMPLE LINE, AND INSTALL NEW ELBOW TO CONNECT NEW SAMPLE LINE TO DOWNSTREAM EXISTING SAMPLE LINE. CONTRACTOR TO COORDINATE WITH LABORATORY STAFF TO ENSURE EXISTING SAMPLING ACTIVITIES ARE STOPPED.
2. CONTRACTOR TO VERIFY TIE-IN ELEVATION BEFORE WALL CORE.
3. USE LINK SEAL FOR WALL CORE PENETRATION.



No.	Description	Date

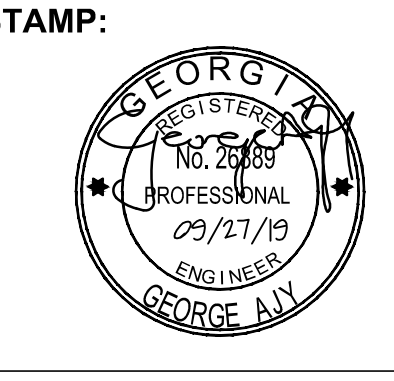



ADDRESS:
BGR2-JV
6 CONCOURSE PARKWAY
SUITE 1600
ATLANTA, GA 30328
(770) 569-7038 x101
FAX: (770) 993-5082

PROJECT NO:	TASK_13
DESIGNED BY:	A.T.
DRAWN BY:	J.J.
CHECKED BY:	G.A.
DATE:	09/27/19
SCALE:	AS NOTED


**CITY OF ATLANTA DEPT. OF WATERSHED MANAGEMENT
WATER SUPPLY PROGRAM**
RIVER INTAKE PUMP STATION
**SAMPLE LINE
DETAILS**

DRAWING NO.
RI-PS
DS2-006
SHEET OF


ISSUED FOR BIDDING

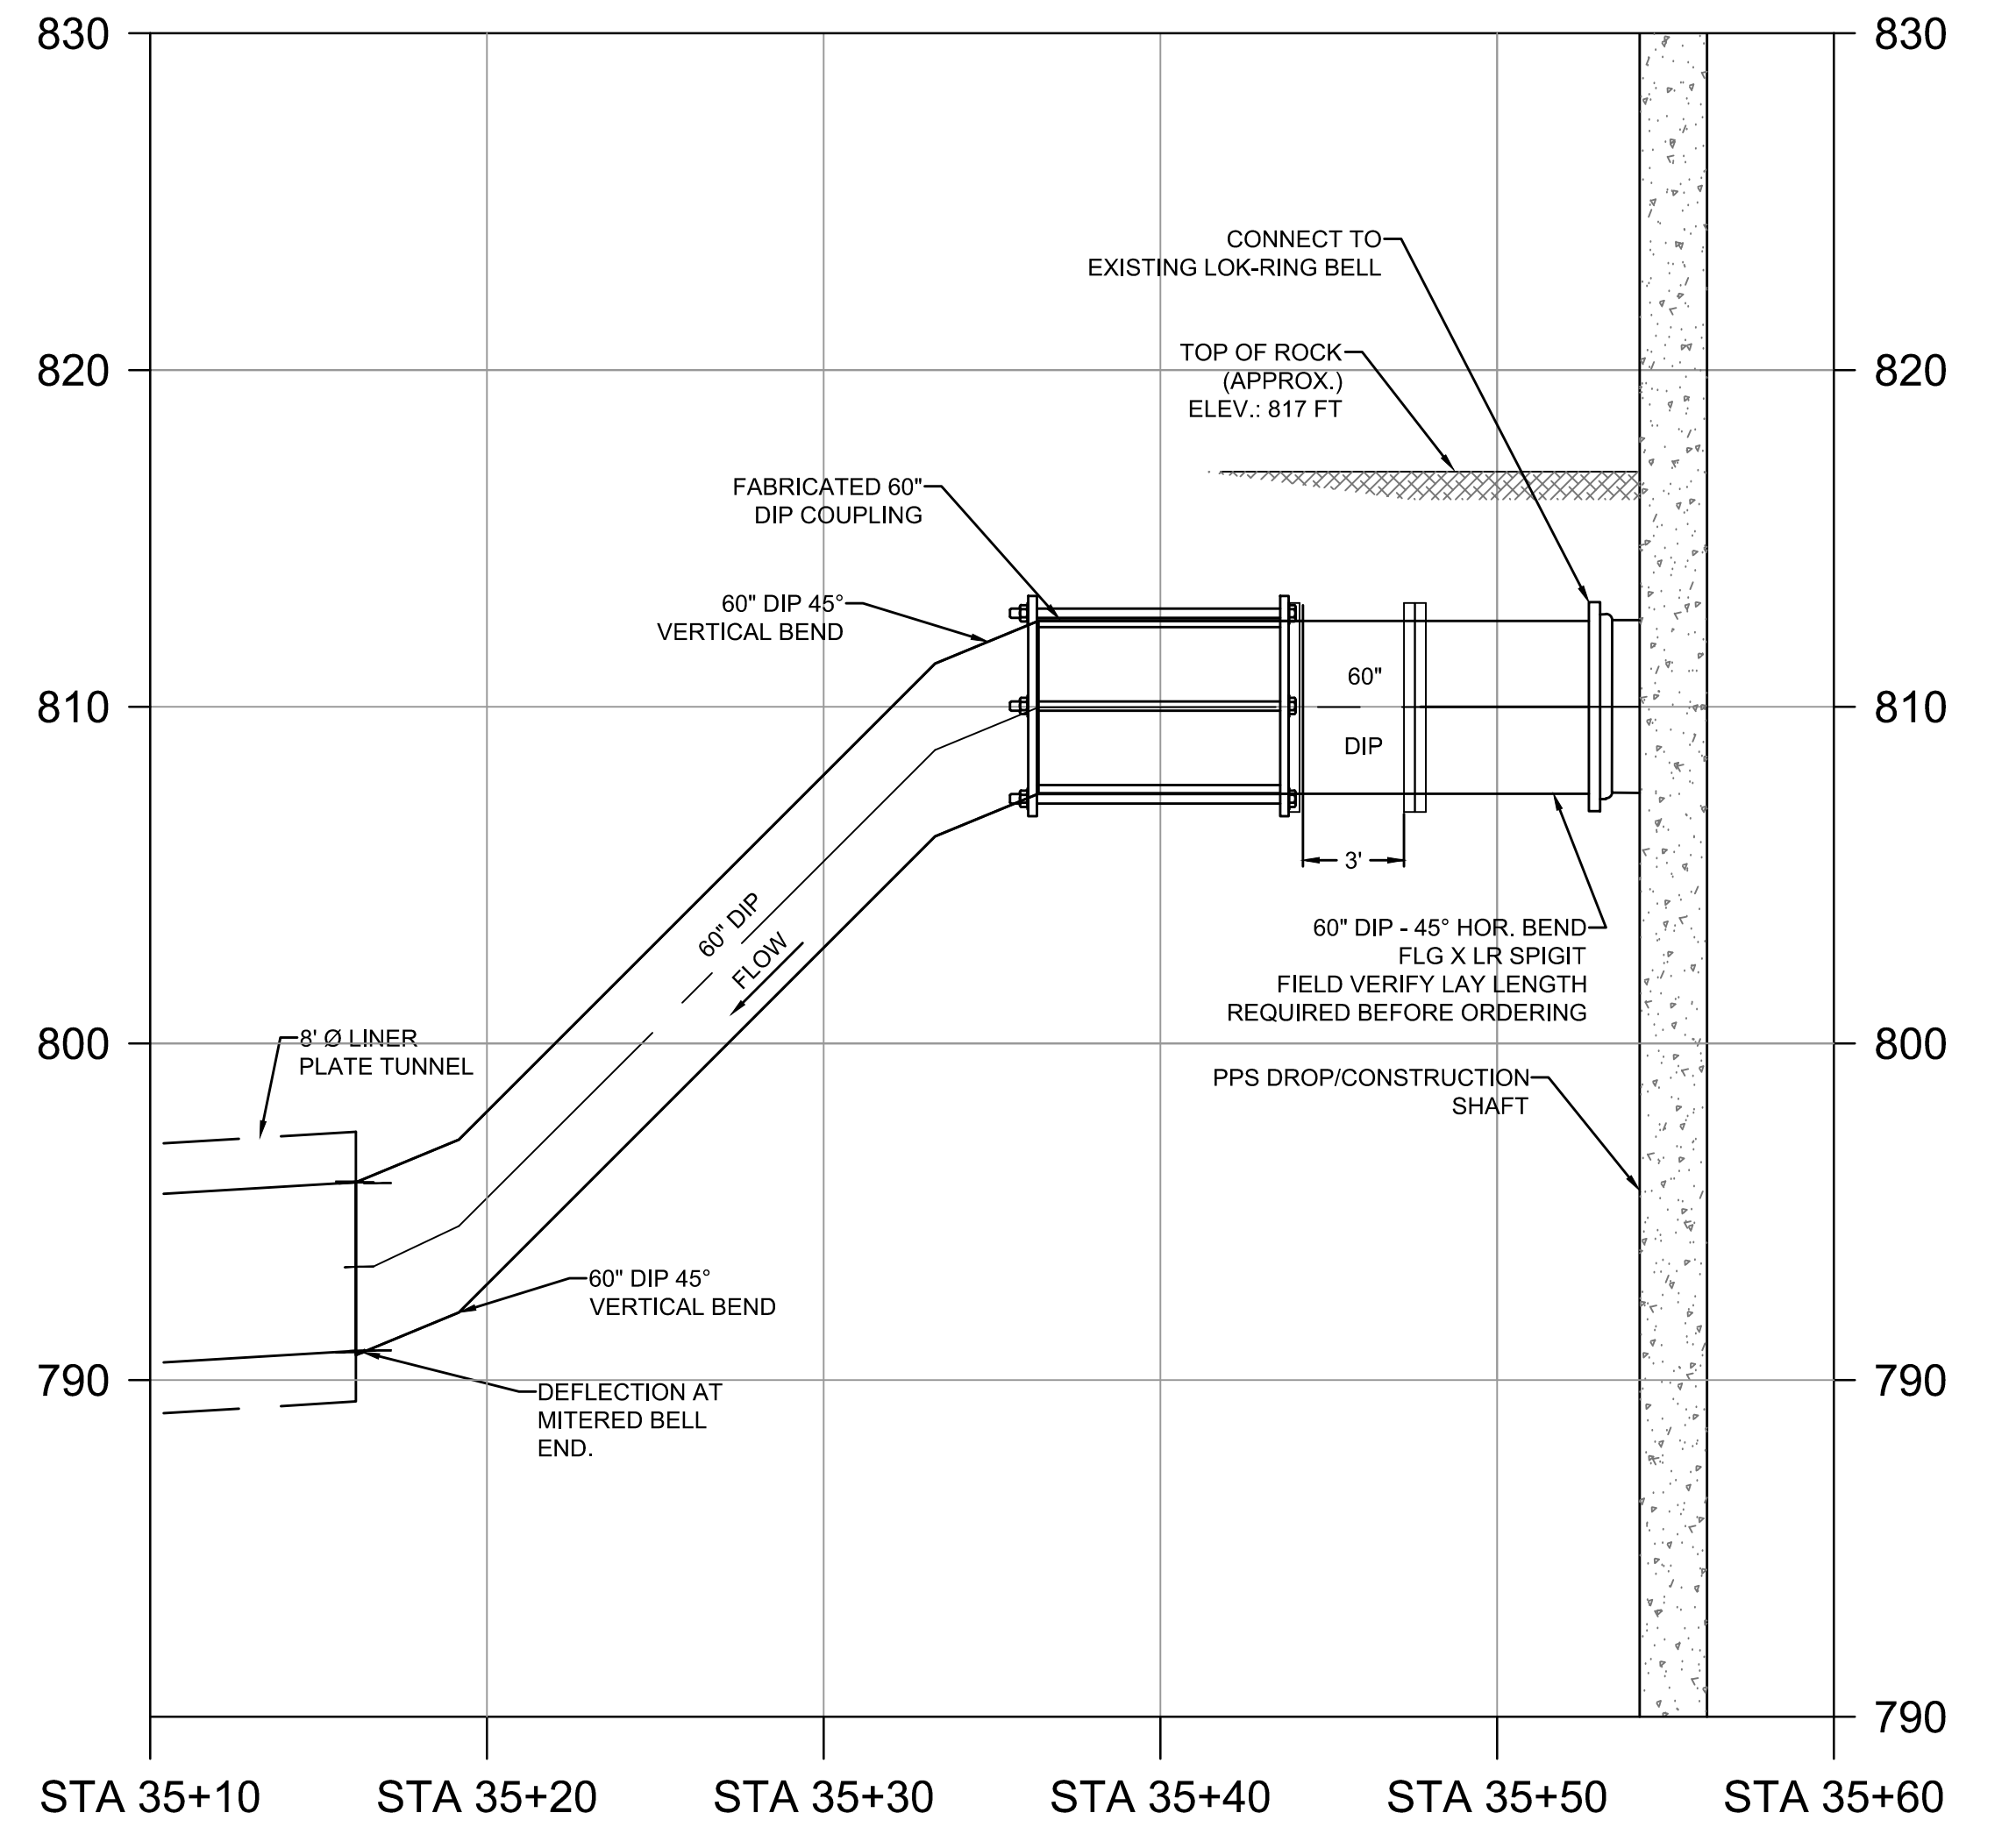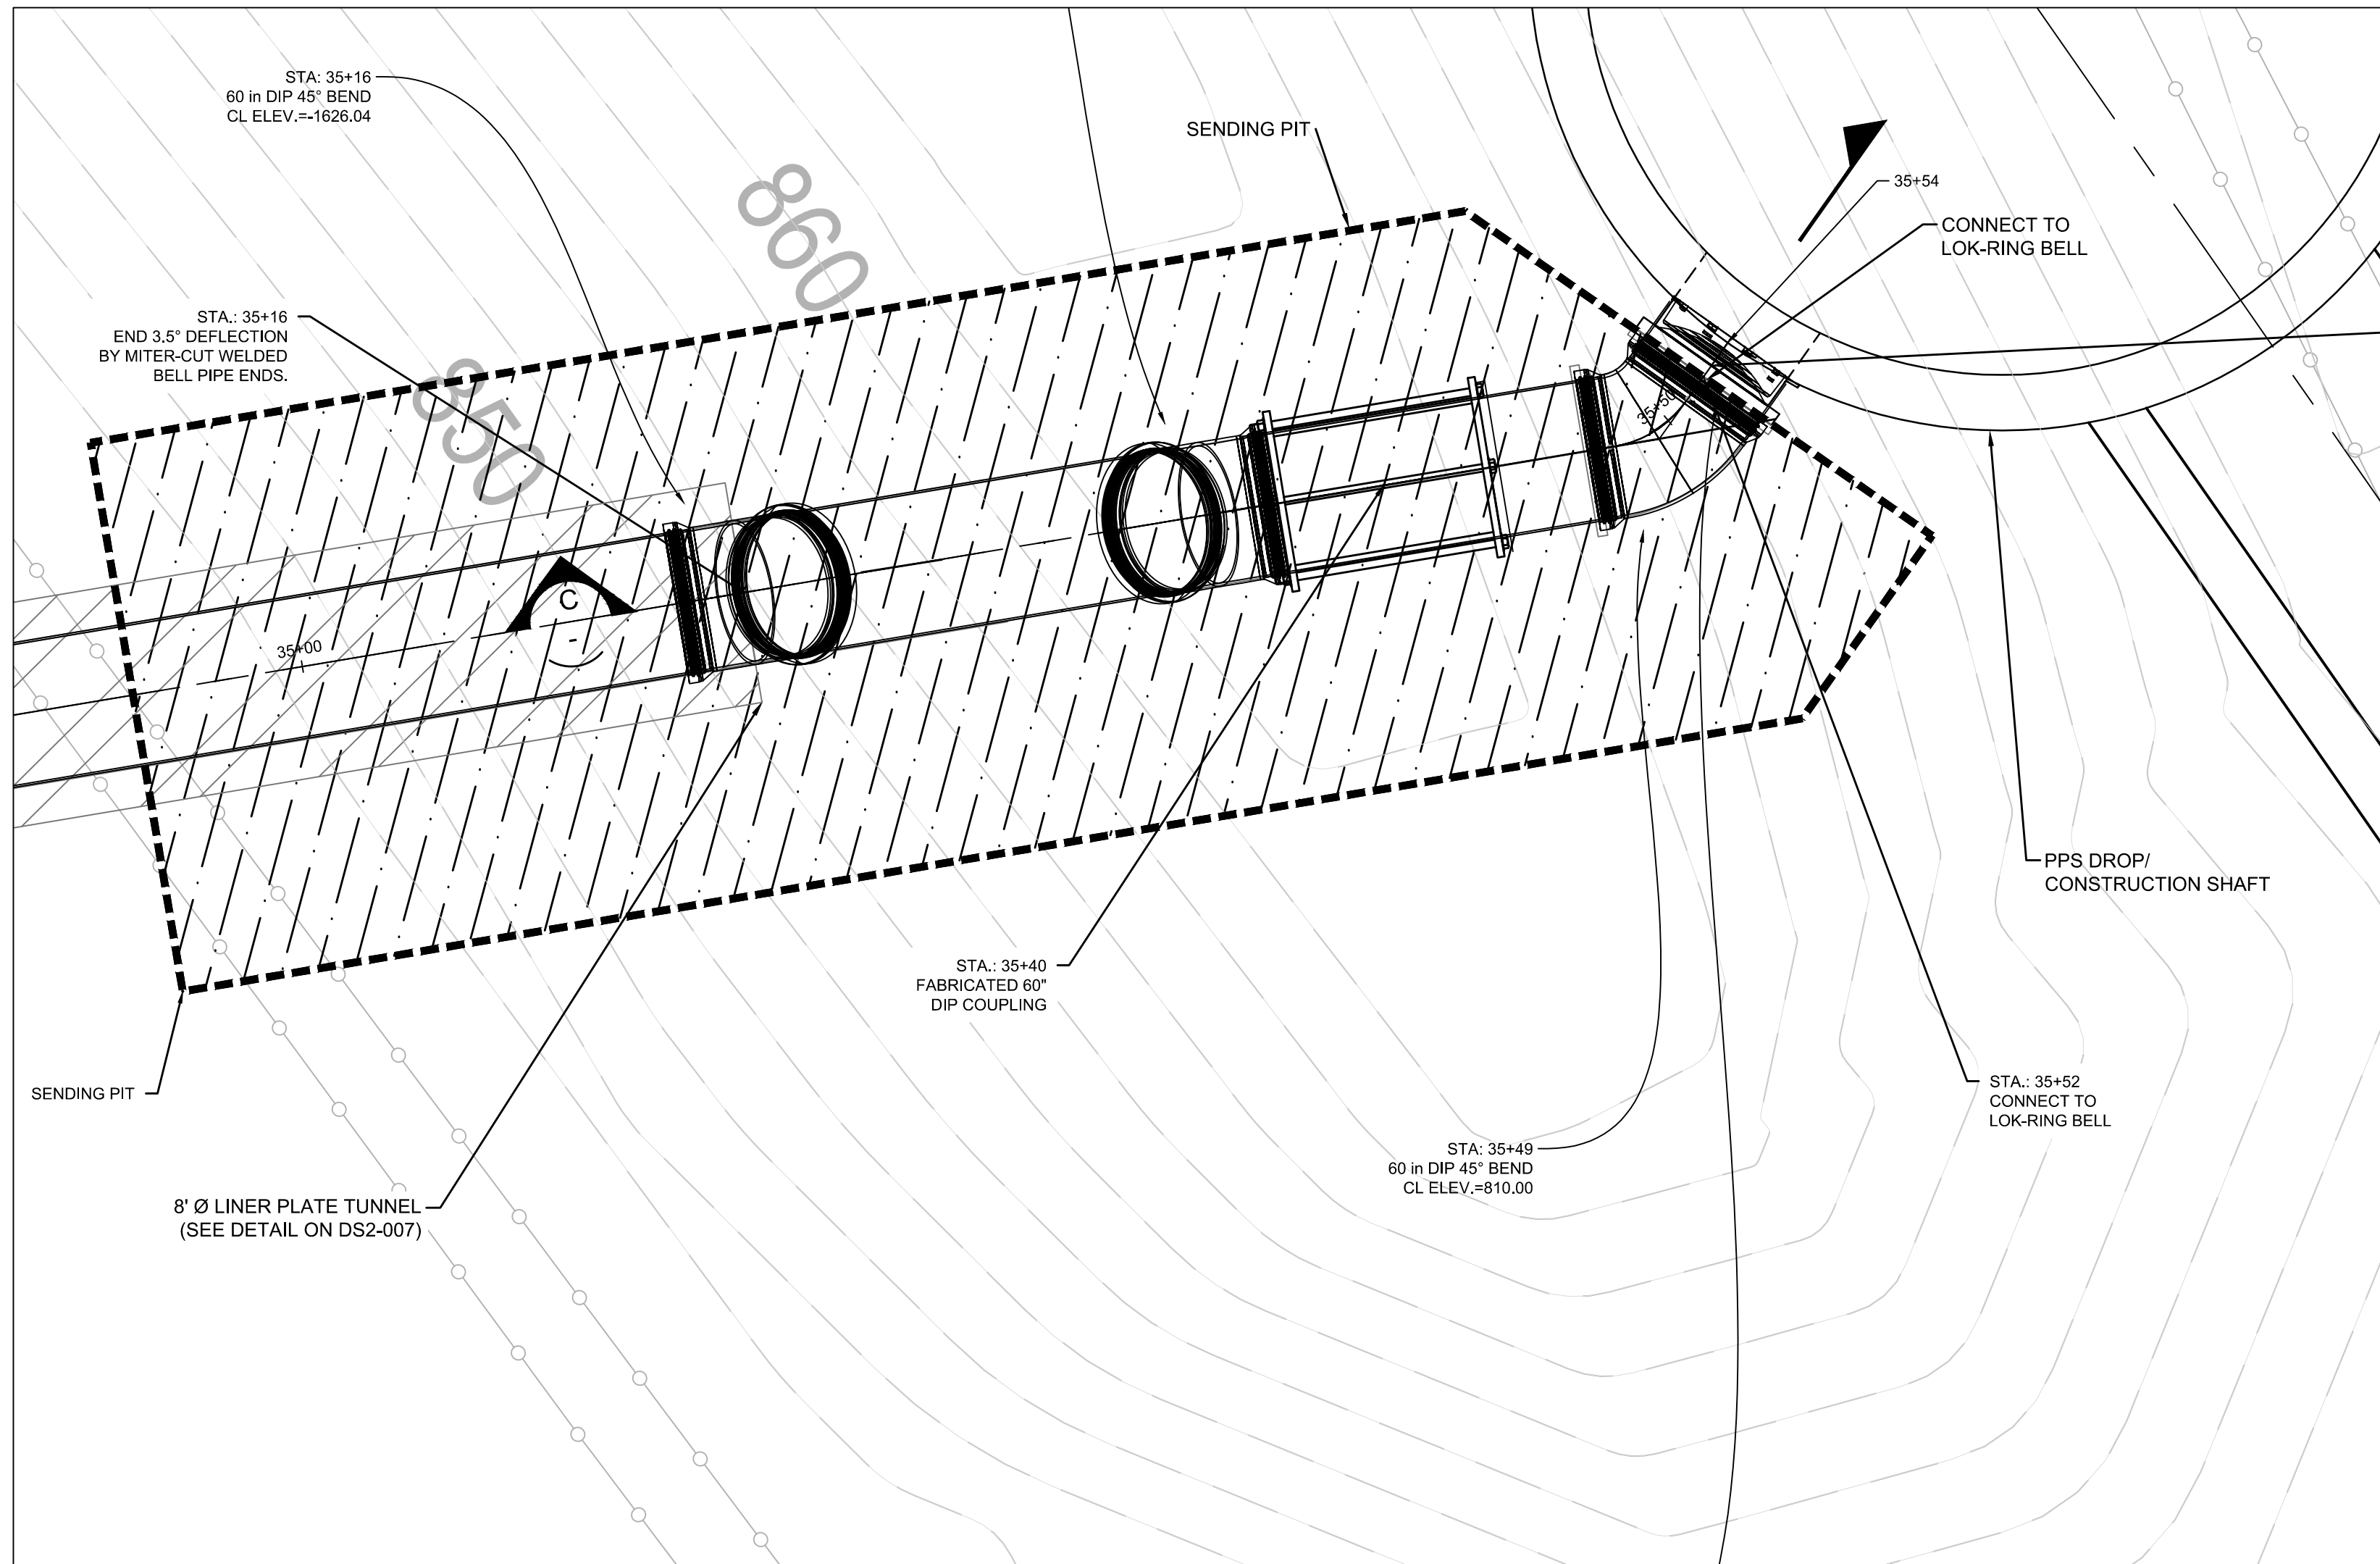

CONNECTION AT P-PS SHAFT
SCALE: 1" = 5'-0"

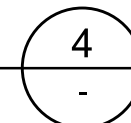

SECTION C
HOR: 1" = 5'-0"
VERT: 1" = 5'-0"

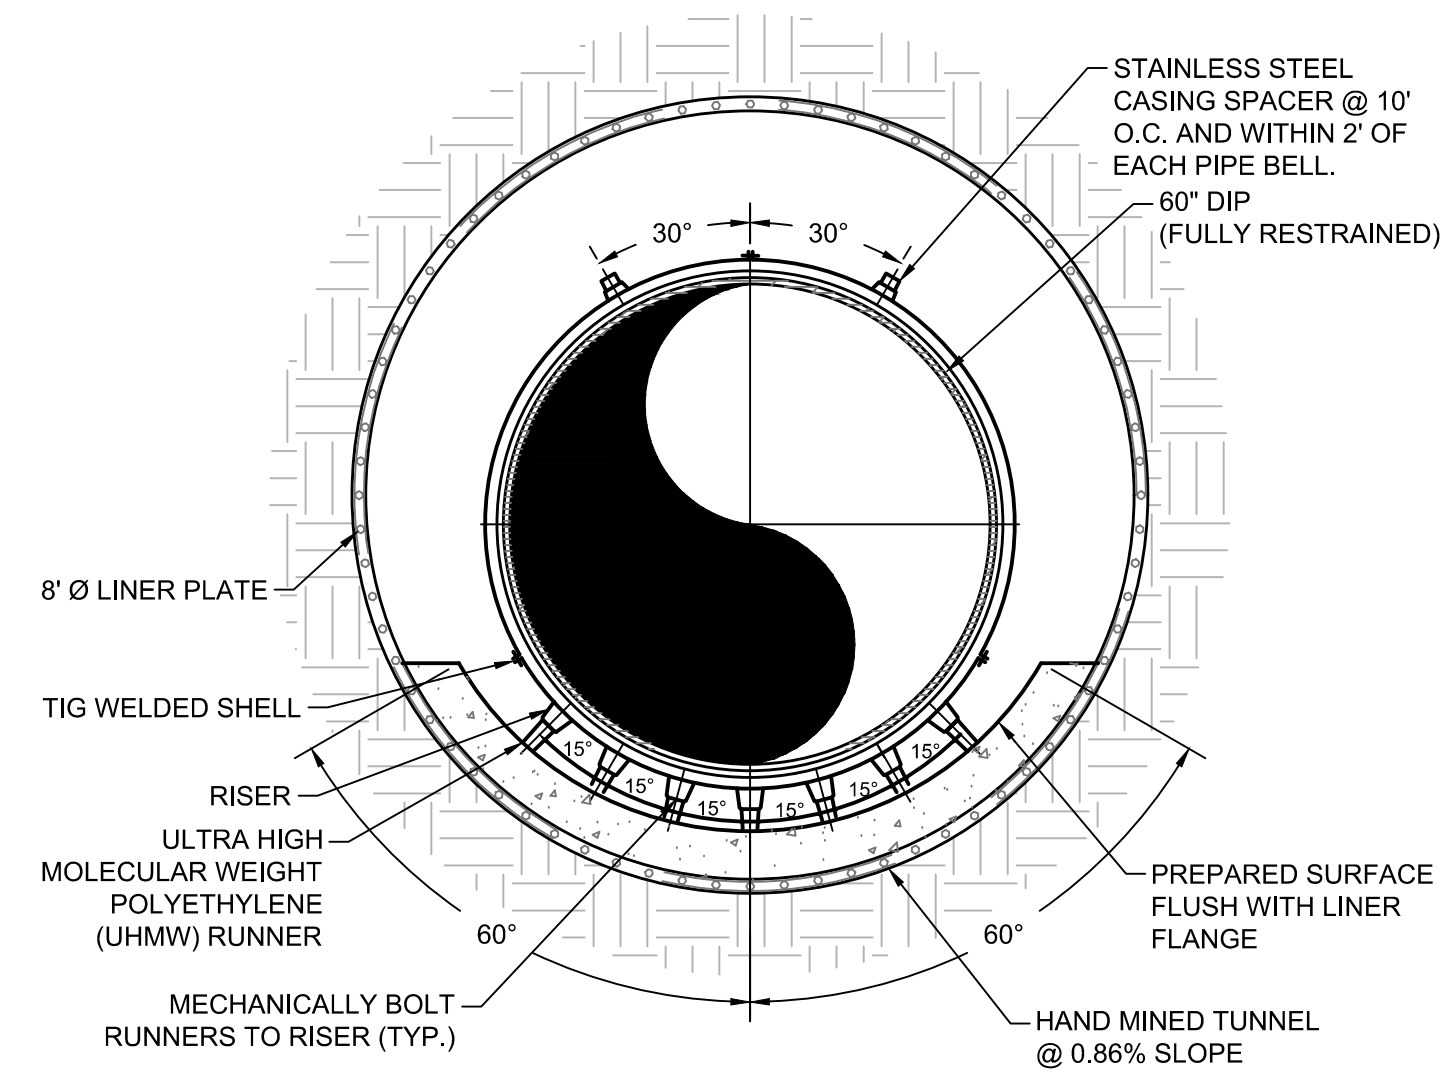

TUNNEL CROSS SECTION
SCALE 1" = 2'-0"

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No.	Description	Date

STAMP:



ADDRESS:

BGR2-JV
6 CONCOURSE PARKWAY
SUITE 1600
ATLANTA, GA 30328
(770) 569-7038 x101
FAX: (770) 993-5082

PROJECT NO:	TASK_13
DESIGNED BY:	J.J.
DRAWN BY:	J.J.
CHECKED BY:	G.A.
DATE:	09/27/19
SCALE:	AS NOTED

CITY OF ATLANTA DEPT. OF WATERSHED MANAGEMENT
WATER SUPPLY PROGRAM

RIVER INTAKE PUMP STATION
YARD PIPING
SECTIONS

DRAWING NO.

RI-PS

DS2-007

SHEET OF

ISSUED FOR BIDDING